


William S.P. (P) S.P. (P) S.P. (P)  
 Member Secretary B.P.A.C. Chairman B.P.A.C.  
 Ramesh A.P. (P) S.P. (P) S.P. (P)  
 Member Secretary B.P.A.C. Chairman B.P.A.C.  
 SANCHAYAN  
 TO BE REVIEWED BY THE OFFICE  
 OF THE CHIEF ENGINEER  
 DATED: 27/11/2025

GREEN AREA DETAILS		GREEN AREA
G1	AS PER P LINE	= 36.960
G2	1 X 3.265 X	= 82.03
G3	1 X 5.000 X	= 40.28
G4	1 X 2.500 X	= 16.93
G5	AS PER P LINE	= 22.60
G6	AS PER P LINE	= 2.81
G7	1 X 2.200 X	= 19.34
G8	AS PER P LINE	= 60.01
G9	1 X 33.575 X	= 212.03
G10	AS PER P LINE	= 60.01
G11	1 X 1.300 X	= 12.15
G12	AS PER P LINE	= 1.08
G13	1 X 10.215 X	= 19.36
G14	AS PER P LINE	= 6.22
G15	1 X 2.235 X	= 42.71
G16	1 X 4.985 X	= 32.13
G17	AS PER P LINE	= 6.00
G18	1 X 2.000 X	= 5.32
G19	1 X 10.980 X	= 20.70
G20	AS PER P LINE	= 7.53
G21	1 X 3.135 X	= 41.71
G22	AS PER P LINE	= 35.06
G23	1 X 9.220 X	= 60.11
G24	1 X 17.015 X	= 153.39
G25	1 X 6.235 X	= 16.15
G26	AS PER P LINE	= 5.84
G27	1 X 10.215 X	= 19.36
G28	AS PER P LINE	= 6.22
G29	1 X 2.235 X	= 29.28
G30	1 X 2.235 X	= 3.75
G31	1 X 1.040 X	= 7.53
G32	0.5 X 1.040 X	= 0.30
G33	0.5 X 8.065 X	= 19.17
G34	0.5 X 2.805 X	= 6.67
G35	1 X 6.700 X	= 98.69
G36	0.5 X 6.700 X	= 13.79
G37	1 X 10.980 X	= 20.81
G38	1 X 4.290 X	= 26.17
G39	AS PER P LINE	= 12.02
G40	1 X 5.000 X	= 16.43
G41	1 X 4.240 X	= 42.40
G42	1 X 9.180 X	= 14.50
G43	1 X 1.320 X	= 13.27
G44	1 X 1.320 X	= 16.25
G45	1 X 4.250 X	= 7.37
G46	0.5 X 4.250 X	= 5.65
G47	1 X 7.555 X	= 26.33
G48	0.5 X 7.555 X	= 18.23
G49	1 X 6.500 X	= 4.16
G50	0.5 X 6.500 X	= 12.72
G51	1 X 6.685 X	= 23.56
G52	AS PER P LINE	= 96.20
<b>GREEN AREA</b>		<b>= 1581.28</b>

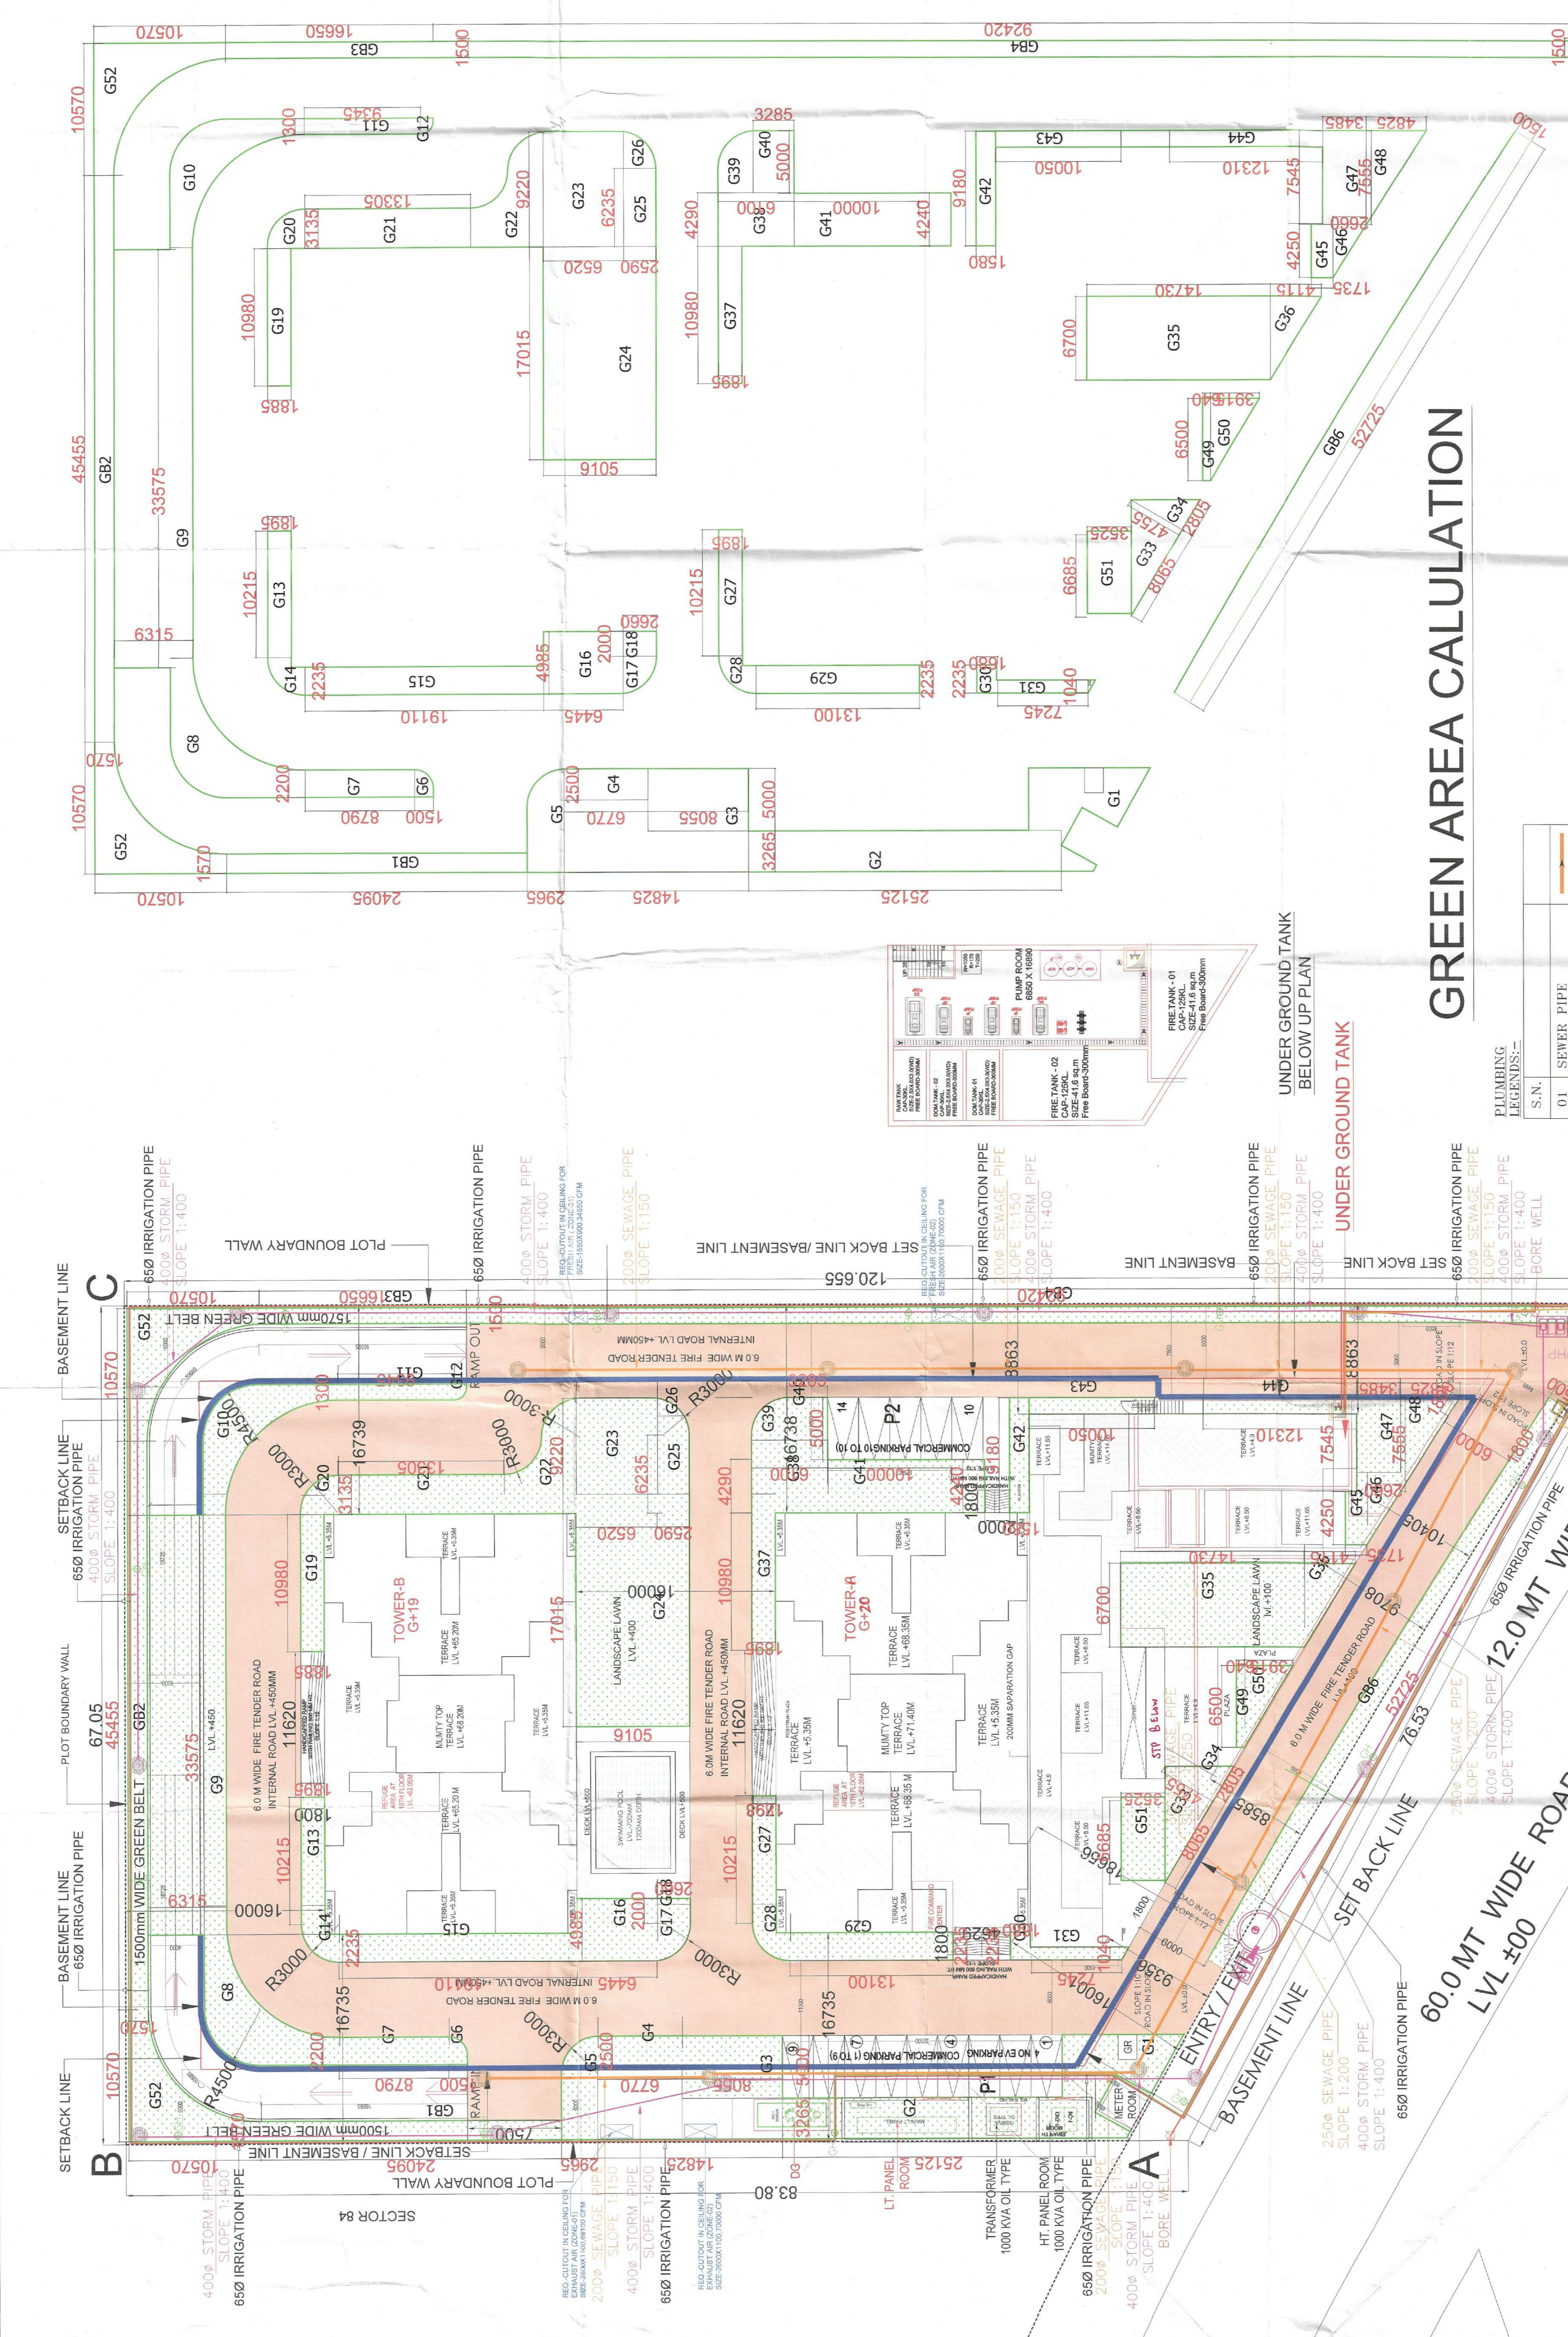

# GREEN AREA CALCULATION

GREEN BELT DETAIL		
GB1	1 X 1.570 X 24.095 = 37.83	
GB2	1 X 45.455 X 1.570 = 71.36	
GB3	1 X 1.500 X 92.420 = 138.63	
GB4	1 X 47.500 X 1.995 = 94.76	
GB5	0.5 X 1.500 X 0.825 = 0.62	
GB6	1 X 52.725 X 1.500 = 79.09	
<b>TOTAL GREEN BELT AREA</b>		<b>422.29</b>
<b>TOTAL GREEN AREA (INCLUDE GREEN BELT)</b>		<b>1851.20</b>

- PLUMBING LEGENDS:-**
- S.N. 01 SEWER PIPE
  - 02 SEWER MANHOLE
  - 03 300x300 GULLY TRAP
- PLUMBING LEGENDS:-**
- S.N. 01 STORM PIPE
  - 02 STORM MANHOLE
  - 03 DE-SILTING CHAMBER
  - 04 RECHARGE PIT
- WATER SUPPLY LEGEND:-**
- GARDEN HYDRANT
  - 65ø IRRIGATION PIPE

CLIENT: LAMOISE INFRA LLP  
 PROJECT: PROPOSED RETIREMENT HOUSING PROJECT ( UNDER RETIREMENT HOUSING POLICY DATED 04/11/2024). OVER AN AREA MEASURING REVENUE ESTATE OF VILLAGE SIKANDERPUR BADHA SECTOR 84 GURUGRAM MANESAR URBAN COMPLEX BEING DEVELOPED BY LAMOISE INFRA LLP.  
 SCALE: 1:200  
 DRAWING NAME: SITE PLAN  
 DRAWING NO: SUB-02

APPLICANT'S SIGN: [Signature]  
 ARCHITECT'S SIGN: [Signature]