



DOOR SCHEDULE STILT FLOOR (TOWER -1,2)

S.NO	TYPE	OPENING	LINTEL FROM SILL	SILL HEIGHT	LOCATION	
1	FD	1200	2400	50	2400	STILT FLR. FIRE DOOR
2	FD	1250	2450	50	2400	STILT FLR. FIRE DOOR
3	GD	2100	2450	50	2400	ENTRANCE LOBBY
4	DT	1200	2450	50	2400	HANDICAP TOILET
5	DS	500	2450	350	2100	ELEC. & LV. SHAFT

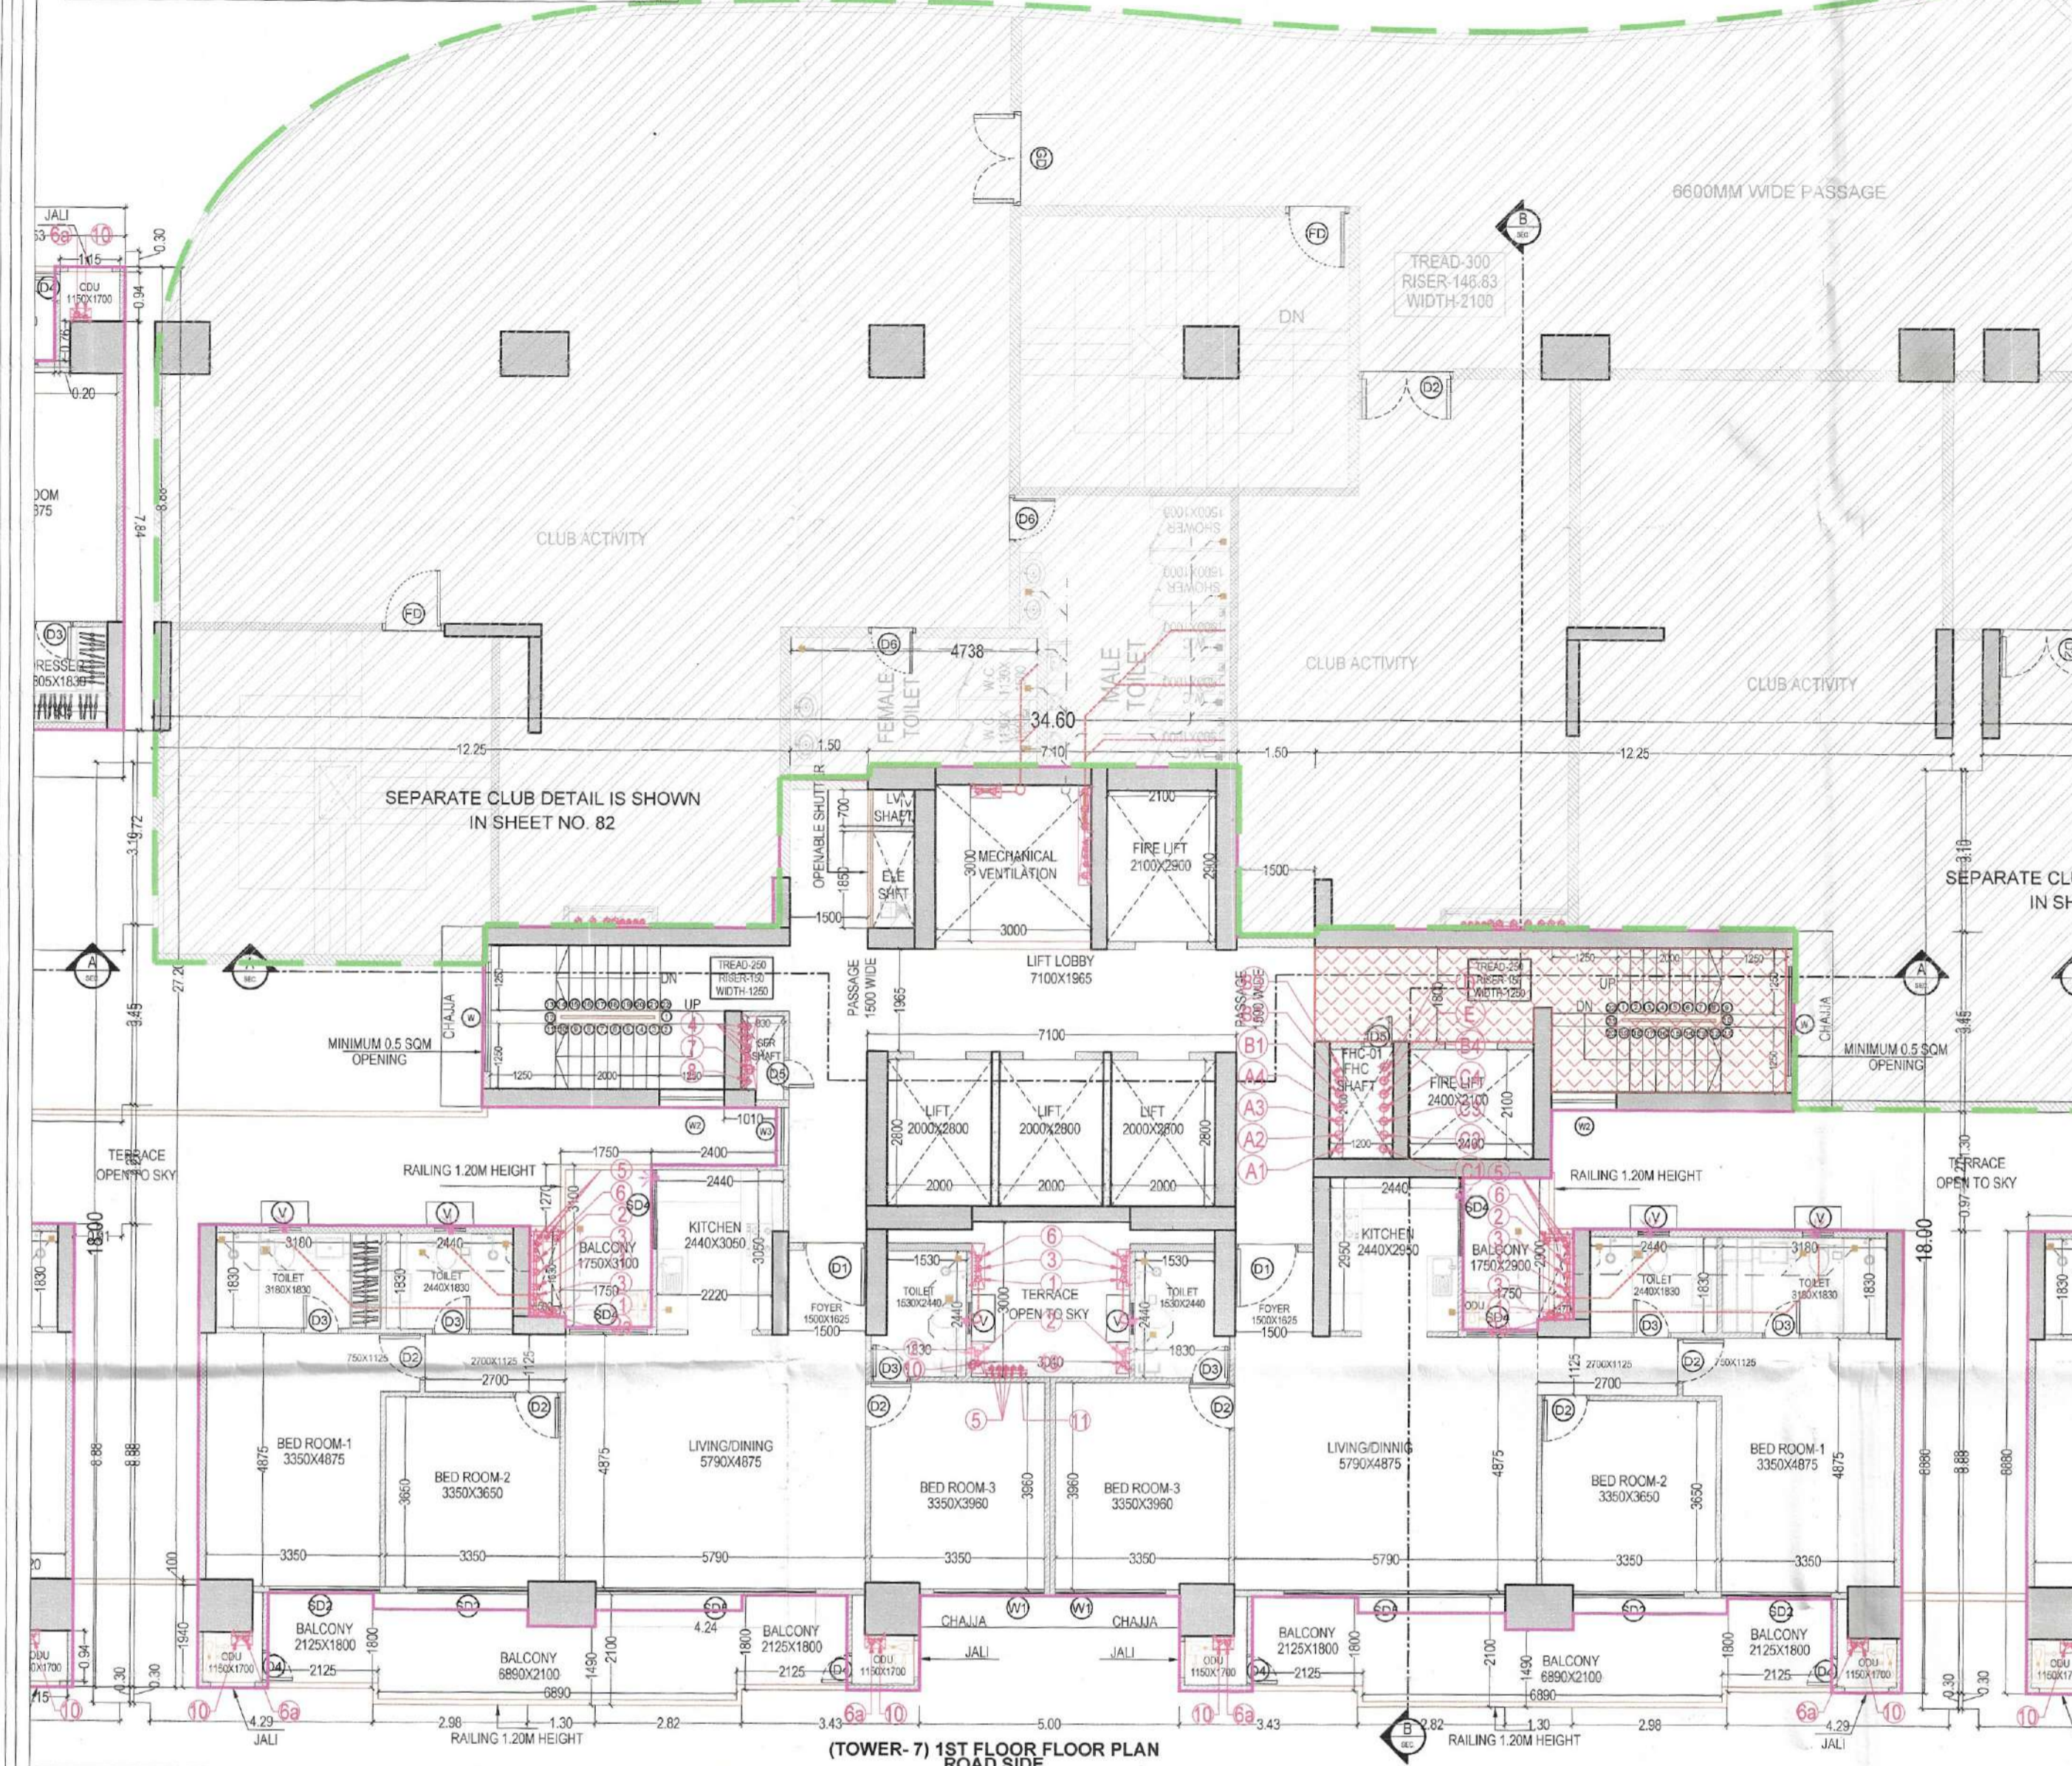

(TOWER-7) 1ST FLOOR PLAN ROAD SIDE

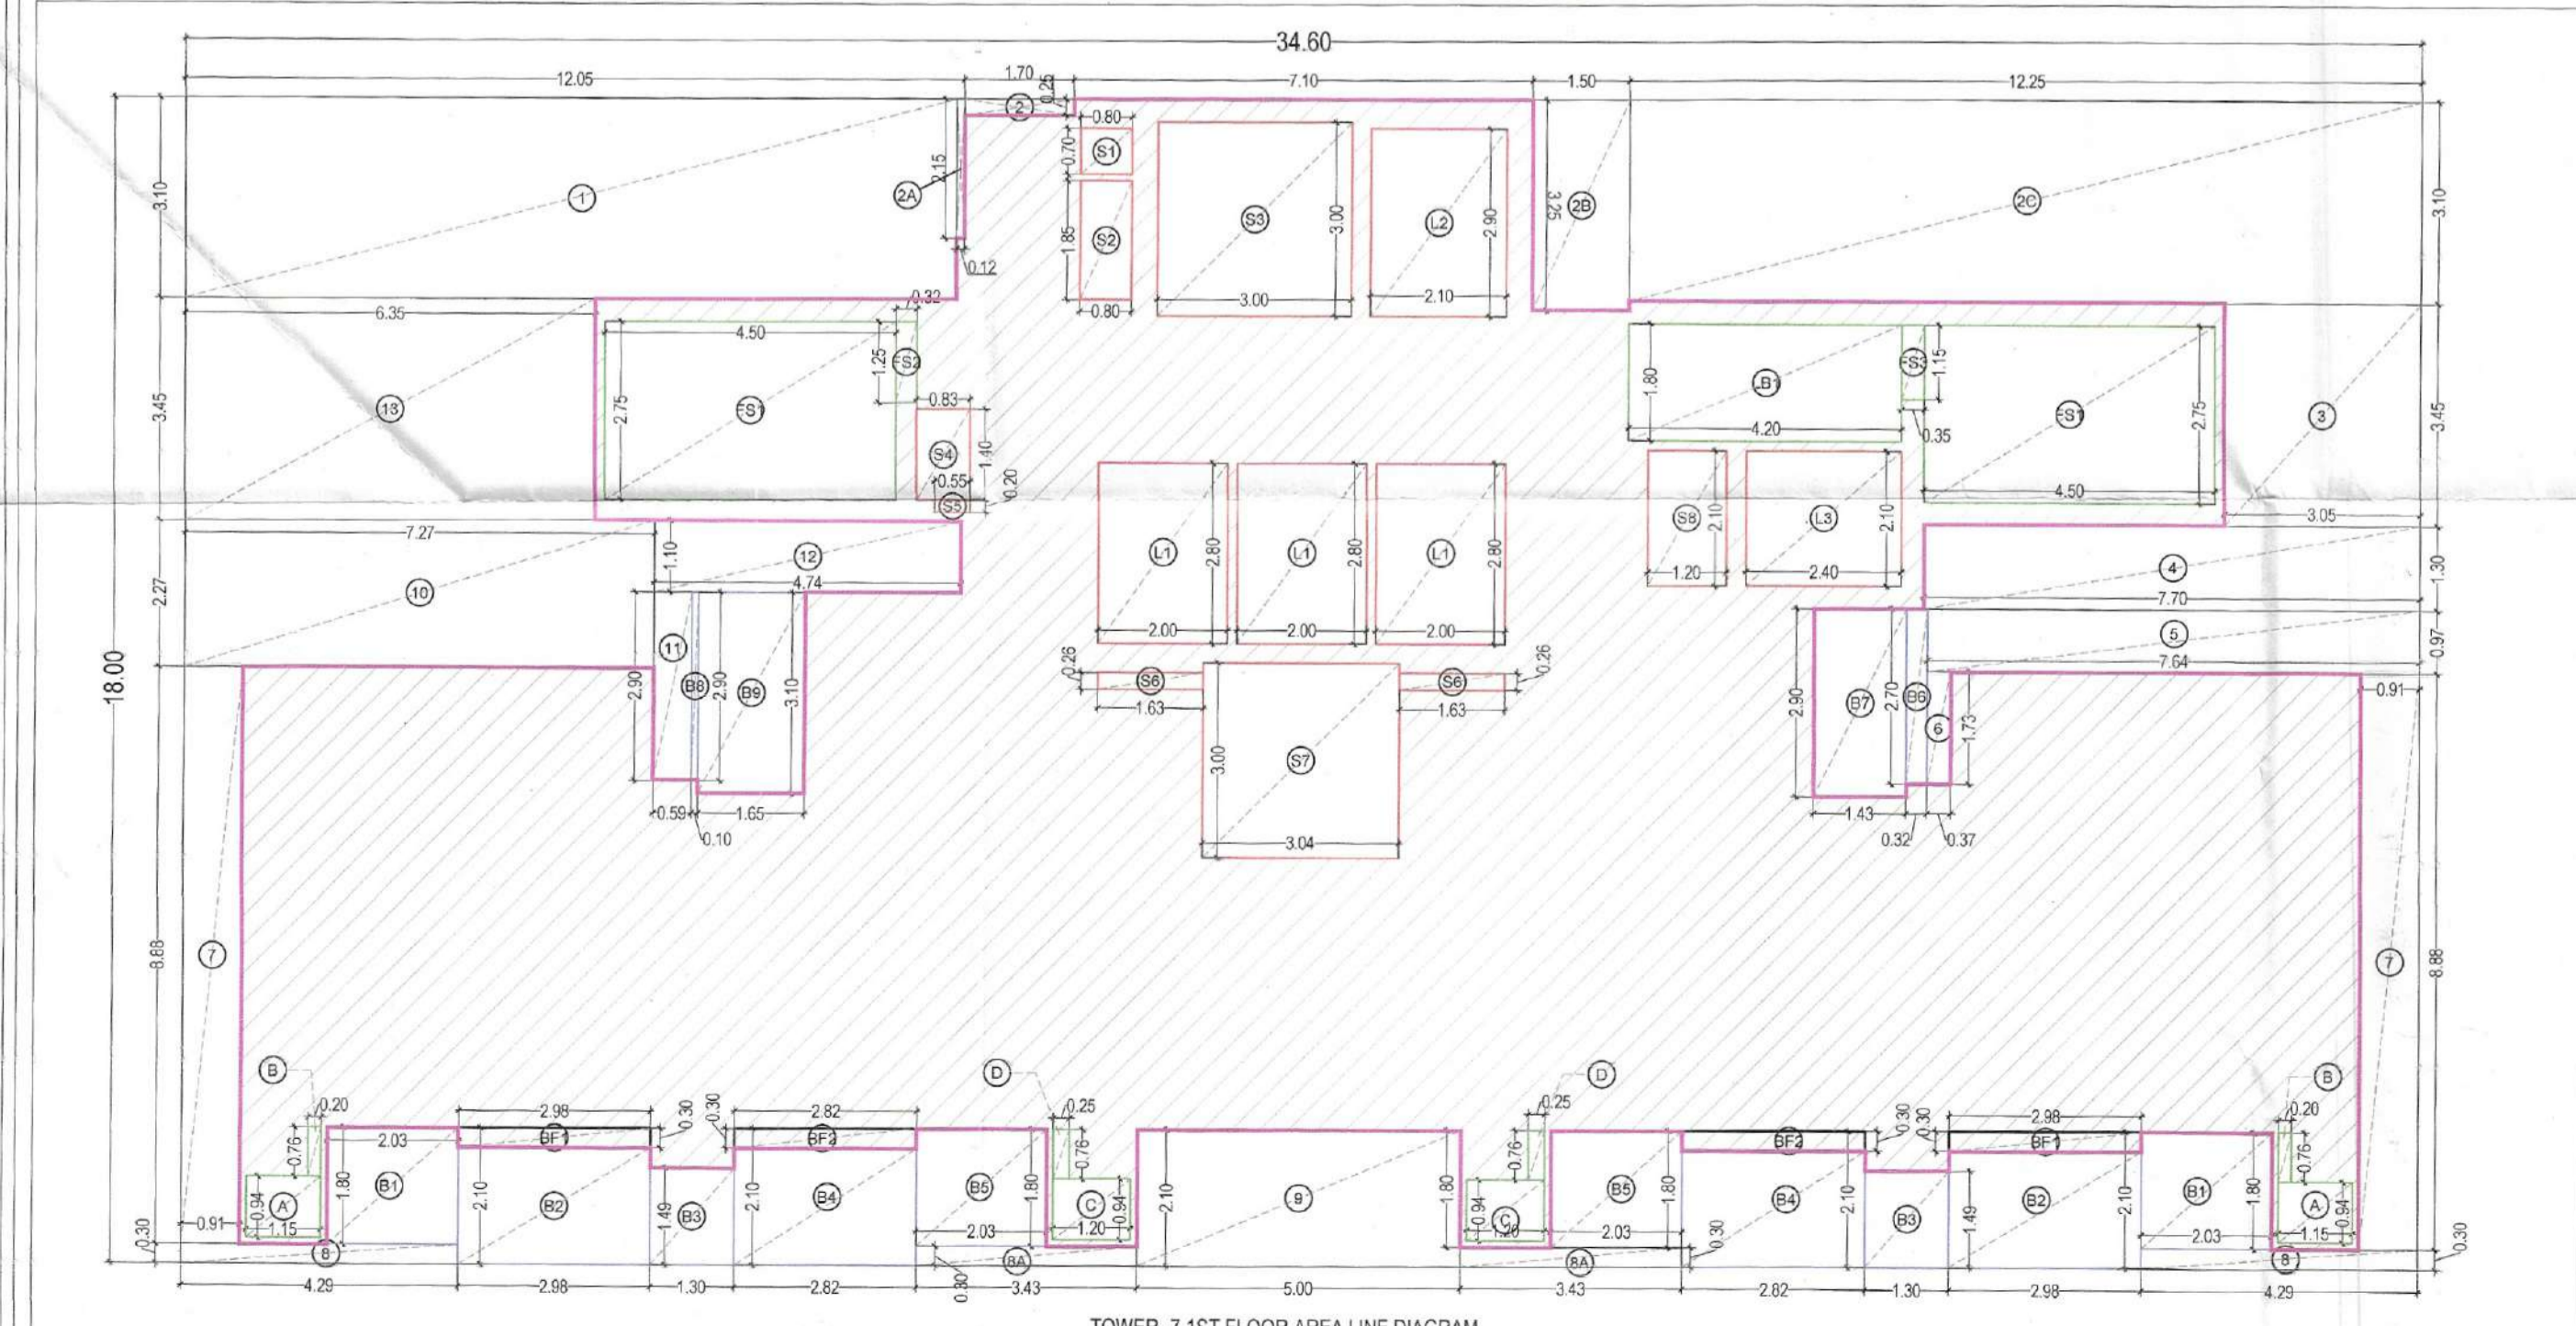


TOWER-7 1ST FLOOR AREA LINE DIAGRAM

PLUMBING LEGEND:

- 110 OD SOIL & VENT PIPE
- 110 OD WASTE & VENT PIPE
- 110 OD KITCHEN WASTE & VENT PIPE
- 100 OD ANTI-SYPHONAGE PIPE
- DOMESTIC WATER SUPPLY DOWN TAKE PIPE
- FLUSHING WATER SUPPLY DOWN TAKE PIPE
- 160 OD RAIN WATER PIPE FOR TERRACE
- DOMESTIC WATER RISER PIPE
- FLUSHING WATER RISER PIPE
- 110 OD CONDENSATE WATER DRAIN PIPE

AD ACCESS DOOR
RL ROAD LEVEL
LL INVERT LEVEL OF PIPE
CL CONNECTION LEVEL

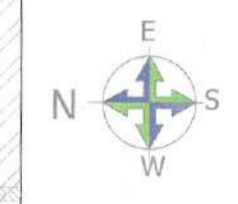

FAR AREA AT (TOWER-07) 1st to 15th & 17th to 24th & 26th to 33rd, 35th to 41st FLOOR
(All Distances are in Meter & Areas in Sqm)

ITEM	NO.S	SHAPE	FORMULA	WIDTH (MTR.)	LENGTH (MTR.)	AREA (SQ.MTR.)
A	1	RECTANGLE	L X B	34.60	27.00	961.880
TOTAL(A) =						961.880

BALCONY NON FAR AREA (B)

ITEM	NO.S	SHAPE	FORMULA	WIDTH (MTR.)	LENGTH (MTR.)	AREA (SQ.MTR.)
B1	2	RECTANGLE	L X B	2.150	1.800	7.848
B2	2	RECTANGLE	L X B	3.130	2.100	13.146
B3	4	RECTANGLE	L X B	1.300	1.490	7.748
B4	2	RECTANGLE	L X B	3.280	2.100	13.776
B5	2	RECTANGLE	L X B	2.180	1.800	7.848
B6	2	RECTANGLE	L X B	1.800	2.620	9.072
B7	1	RECTANGLE	L X B	0.320	2.700	0.864
B8	1	RECTANGLE	L X B	1.430	2.900	4.147
B9	1	RECTANGLE	L X B	1.650	3.100	5.115
B10	1	RECTANGLE	L X B	0.100	2.900	0.290
B11	2	RECTANGLE	L X B	2.030	1.800	7.308
B12	2	RECTANGLE	L X B	2.980	2.100	12.516
B13	2	RECTANGLE	L X B	2.820	2.100	11.844
B14	2	RECTANGLE	L X B	2.030	1.800	7.308
TOTAL(B) =						108.830

BALCONY IN FAR AREA (C)

ITEM	NO.S	SHAPE	FORMULA	WIDTH (MTR.)	LENGTH (MTR.)	AREA (SQ.MTR.)
BF1	2	RECTANGLE	L X B	0.300	0.300	1.878
BF2	2	RECTANGLE	L X B	3.280	0.300	1.968
BF3	2	RECTANGLE	L X B	2.980	0.300	1.788
BF4	2	RECTANGLE	L X B	2.820	0.300	1.692
TOTAL(C) =						7.326

NON FAR AREA (D)

ITEM	NO.S	SHAPE	FORMULA	WIDTH (MTR.)	LENGTH (MTR.)	AREA (SQ.MTR.)
A	4	RECTANGLE	L X B	1.150	0.340	4.324
B	4	RECTANGLE	L X B	0.200	0.760	0.608
C	4	RECTANGLE	L X B	1.200	0.940	4.512
D	4	RECTANGLE	L X B	0.250	0.760	0.760
TOTAL(D) =						10.204

CUT OUT AREA (E)

ITEM	NO.S	SHAPE	FORMULA	WIDTH (MTR.)	LENGTH (MTR.)	AREA (SQ.MTR.)
1	2	RECTANGLE	L X B	0.500	0.300	2.118
2	2	RECTANGLE	L X B	3.570	0.300	2.142
3	2	RECTANGLE	L X B	7.210	3.720	53.642
4	2	RECTANGLE	L X B	0.610	2.520	3.074
5	1	RECTANGLE	L X B	3.050	3.450	10.523
6	1	RECTANGLE	L X B	7.700	1.300	10.010
7	1	RECTANGLE	L X B	7.840	0.970	7.411
8	1	RECTANGLE	L X B	0.370	1.730	0.640
9	2	RECTANGLE	L X B	0.910	8.880	16.162
10	2	RECTANGLE	L X B	4.290	0.300	2.574
11	2	RECTANGLE	L X B	3.430	0.300	2.058
12	1	RECTANGLE	L X B	5.000	2.100	10.500
13	1	RECTANGLE	L X B	0.590	2.900	1.711
14	1	RECTANGLE	L X B	7.270	2.270	16.503
15	1	RECTANGLE	L X B	4.740	1.100	5.214
16	1	RECTANGLE	L X B	6.350	3.450	21.908
17	1	RECTANGLE	L X B	5.000	3.140	15.700
TOTAL CUT OUT AREA (E)						181.889

SERVICE SHAFT & LIFT (E)


ITEM	NO.S	SHAPE	FORMULA	WIDTH (MTR.)	LENGTH (MTR.)	AREA (SQ.MTR.)
L1	3	RECTANGLE	L X B	2.000	2.800	16.800
L2	1	RECTANGLE	L X B	2.100	2.900	6.090
L3	1	RECTANGLE	L X B	2.400	2.100	5.040
S2	2	RECTANGLE	L X B	2.170	1.830	7.942
S3	2	RECTANGLE	L X B	0.850	0.800	1.360
S4	1	RECTANGLE	L X B	0.800	0.700	0.560
S5	1	RECTANGLE	L X B	0.800	1.850	1.480
S6	1	RECTANGLE	L X B	3.000	3.000	9.000
S7	2	RECTANGLE	L X B	0.630	1.100	1.386
S8	1	RECTANGLE	L X B	0.630	1.400	1.162
S9	1	RECTANGLE	L X B	1.200	2.100	2.520
S9A	1	RECTANGLE	L X B	0.550	0.200	0.110
S10	2	RECTANGLE	L X B	1.630	0.260	0.848
S11	1	RECTANGLE	L X B	3.040	3.000	9.120
TOTAL SERVICES AREA (E)						63.418

NON FAR/ STAIRCASE (F)

ITEM	NO.S	SHAPE	FORMULA	WIDTH (MTR.)	LENGTH (MTR.)	AREA (SQ.MTR.)
FS1	2	RECTANGLE	L X B	4.500	2.750	24.750
FS2	1	RECTANGLE	L X B	0.320	1.250	0.400
FS3	1	RECTANGLE	L X B	0.350	1.150	0.403
LB1	1	RECTANGLE	L X B	4.200	1.800	7.560
TOTAL NON FAR AREA (F)						33.113

TOTAL FAR AREA AT TYP LVL = (A - B - C - D - E - F + G)

ITEM	NO.S	SHAPE	FORMULA	WIDTH (MTR.)	LENGTH (MTR.)	AREA (SQ.MTR.)
A	1	RECTANGLE	L X B	34.60	27.00	961.880
B	14	RECTANGLE	L X B	108.830		108.830
C	4	RECTANGLE	L X B	10.204		10.204
D	17	RECTANGLE	L X B	181.889		181.889
E	17	RECTANGLE	L X B	63.418		63.418
F	6	RECTANGLE	L X B	33.113		33.113
G	1	RECTANGLE	L X B	7.326		7.326
TOTAL FAR (H)						571.753
TOTAL BUILT UP AREA AT TYP LVL = (A - C - D - E)						571.753
TOTAL FAR						706.369

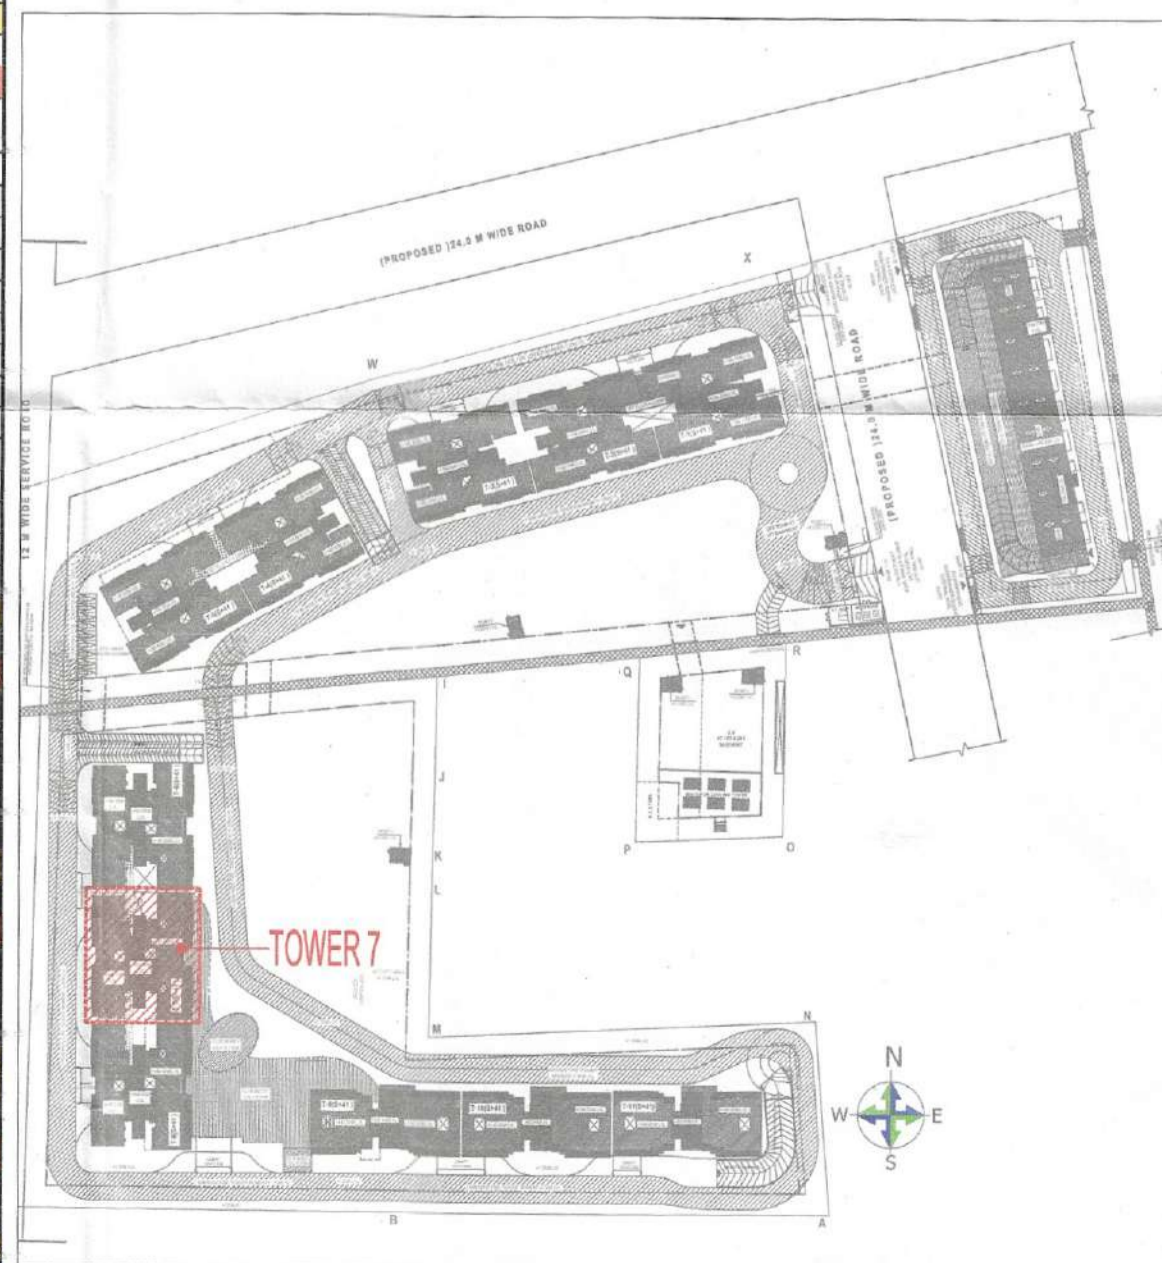

KEY PLAN SCALE: NTS

Hillemans
S.T.P. (HQ) Member Secretary B.P.A.C.
S.T.P. (G) Member B.P.A.C.
C.T.P. (HR) Chairman B.P.A.C.

DTP(HQ)
ATP(HQ)

AD PA ATP

TO BE READ WITH THIS OFFICE MEMO NO.:
DATED: _____

Checked and found ok for Public Health (Internal) Service only subject to comments in forwarding letter No. 29.69.76...Dt. 09/09/2025

GURPREET J.D.(HQ)
Superintending Engineer (HQ)
D/o Chief Engineer-1

J.D.T. Member B.P.A.C.

DOOR SCHEDULE TYPICAL FLOOR

S.NO	TYPE	OPENING	LINTEL FROM SILL	SILL HEIGHT	LOCATION	
1	FD	1200	2450	50	2400	REFUGED HR. FIRE RATED DOOR
2	DT	1200	2450	50	2400	MAIN KITCHEN HR. FIRE RATED DOOR
3	GD	600	2450	50	2400	BED ROOM, S ROOM
4	DT	500	2450	50	2400	HR. FIRE RATED HR. FIRE RATED DOOR
5	GD	750	2450	50	2400	TOILET BALCONY
6	GD	600	2450	50	2400	OUT DOOR UNIT SHAFT
7	DT	400	2450	350	2100	ELEC. & LV. SHAFT
8	DT	540	2450	350	2100	SHAFT

WINDOW SCHEDULE TYPICAL FLOOR (TYPE A)

S.NO	TYPE	OPENING	LINTEL FROM SILL	SILL HEIGHT	LOCATION	
1	SD	5200	2700	50	2650	BEDROOM-1&2
2	SD	2130	2700	80	2680	LIVING/DINNING
3	SD	1900	2700	50	2680	BEDROOM-3
4	SD	1500	2700	50	2680	BALCONY
5	SD	4540	2700	50	2680	BEDROOM-1
6	SD	2450	2700	50	2680	BEDROOM-2
7	SD	5900	2700	50	2680	LIVING/DINNING
8	SD	2950	2700	50	2680	LIVING/DINNING
9	W	2700	2811	1111	1400	STAIRCASE
10	W	2130	2700	350	1750	STAIRCASE
11	W	1250	2700	350	1750	STAIRCASE
12	W	1500	2700	350	1750	STAIRCASE
13	V	600	2700	1500	1000	TOILET

CLIENT: SIGNATUREGLOBAL HOMES PVT. LTD.

ARCHITECT: HSVP, Panchkula.
NISAR AHMED ANSARI
ARCHITECT (B.ARCH)
CA/2005/06034

PROJECT: PROPOSED MIXED LAND USE COLONY (80% RESIDENTIAL COMPONENT & 20% COMMERCIAL COMPONENT) UNDER TOD POLICY ON THE AREA MEASURING 13.9686 ACRES IN THE REVENUE ESTATE GADAUJI KALAN, SECTOR 37D, GURUGRAM MANESAR URBAN COMPLEX, LICENSE NO.172 OF 2024, DATED 03.12.2024, BEING DEVELOPED BY SIGNATUREGLOBAL HOMES PVT. LTD.

DRAWING TITLE: 1ST FLOOR PLAN & AREA LINE DIAGRAM (TOWER 7)

SHEET NO. 111

SCALE: 1:100

DATE: 2025.08.13

ARCHITECT'S SIGN: NISAR AHMED ANSARI ARCHITECT (B.ARCH) CA/2005/06034

OWNER'S SIGN: SIGNATUREGLOBAL HOMES