
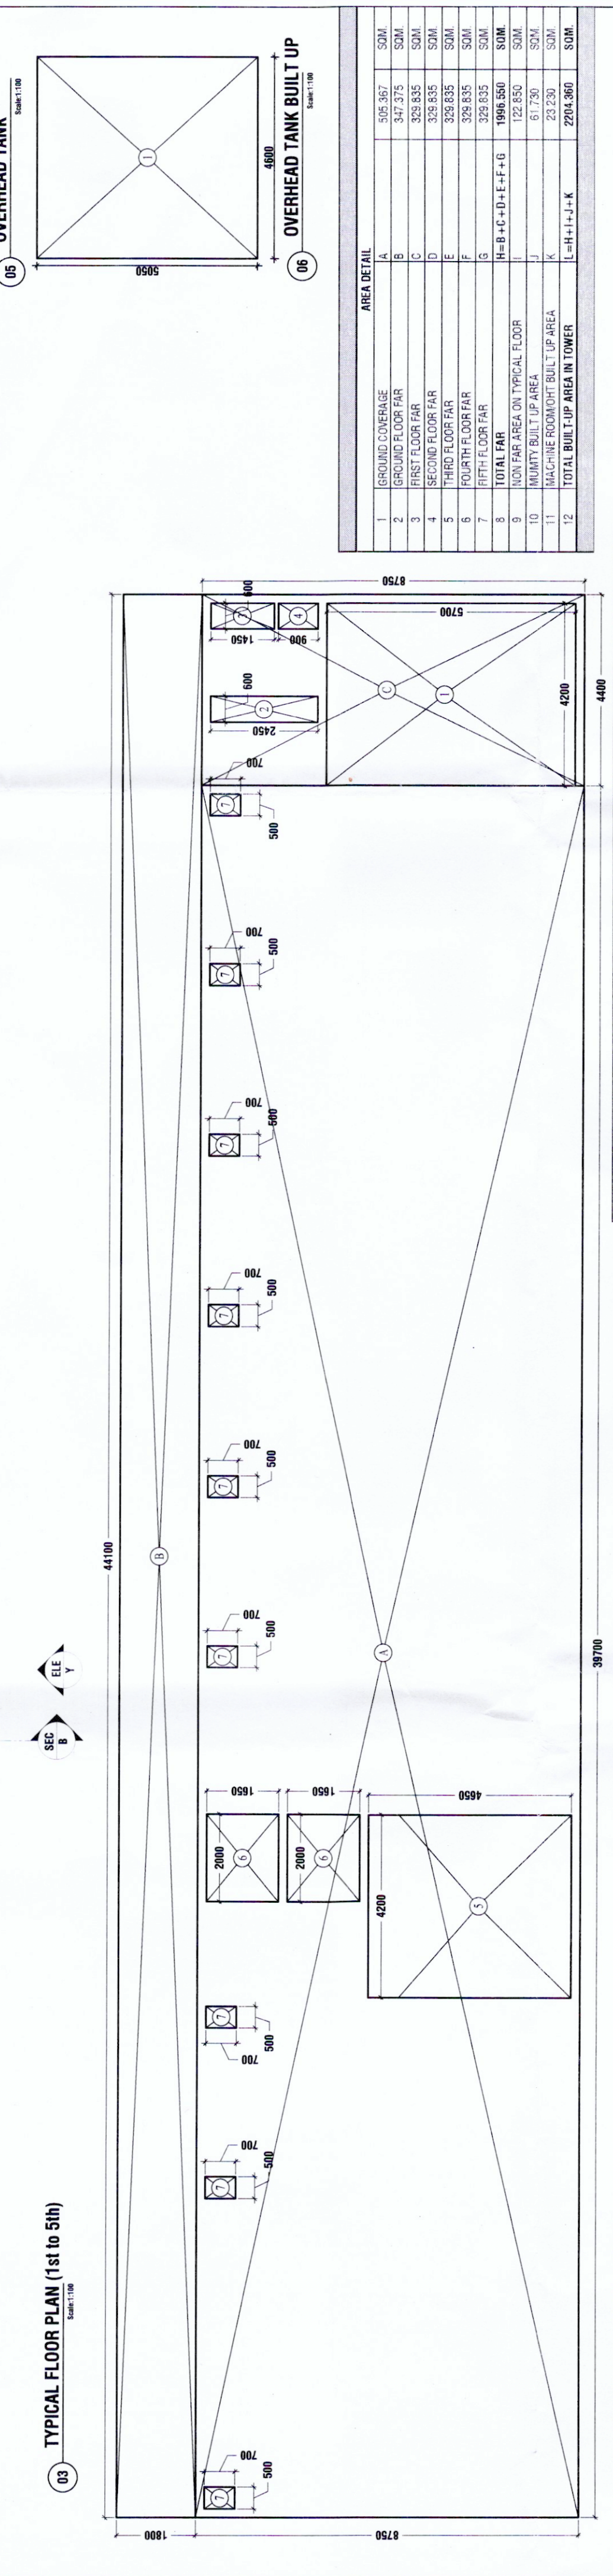
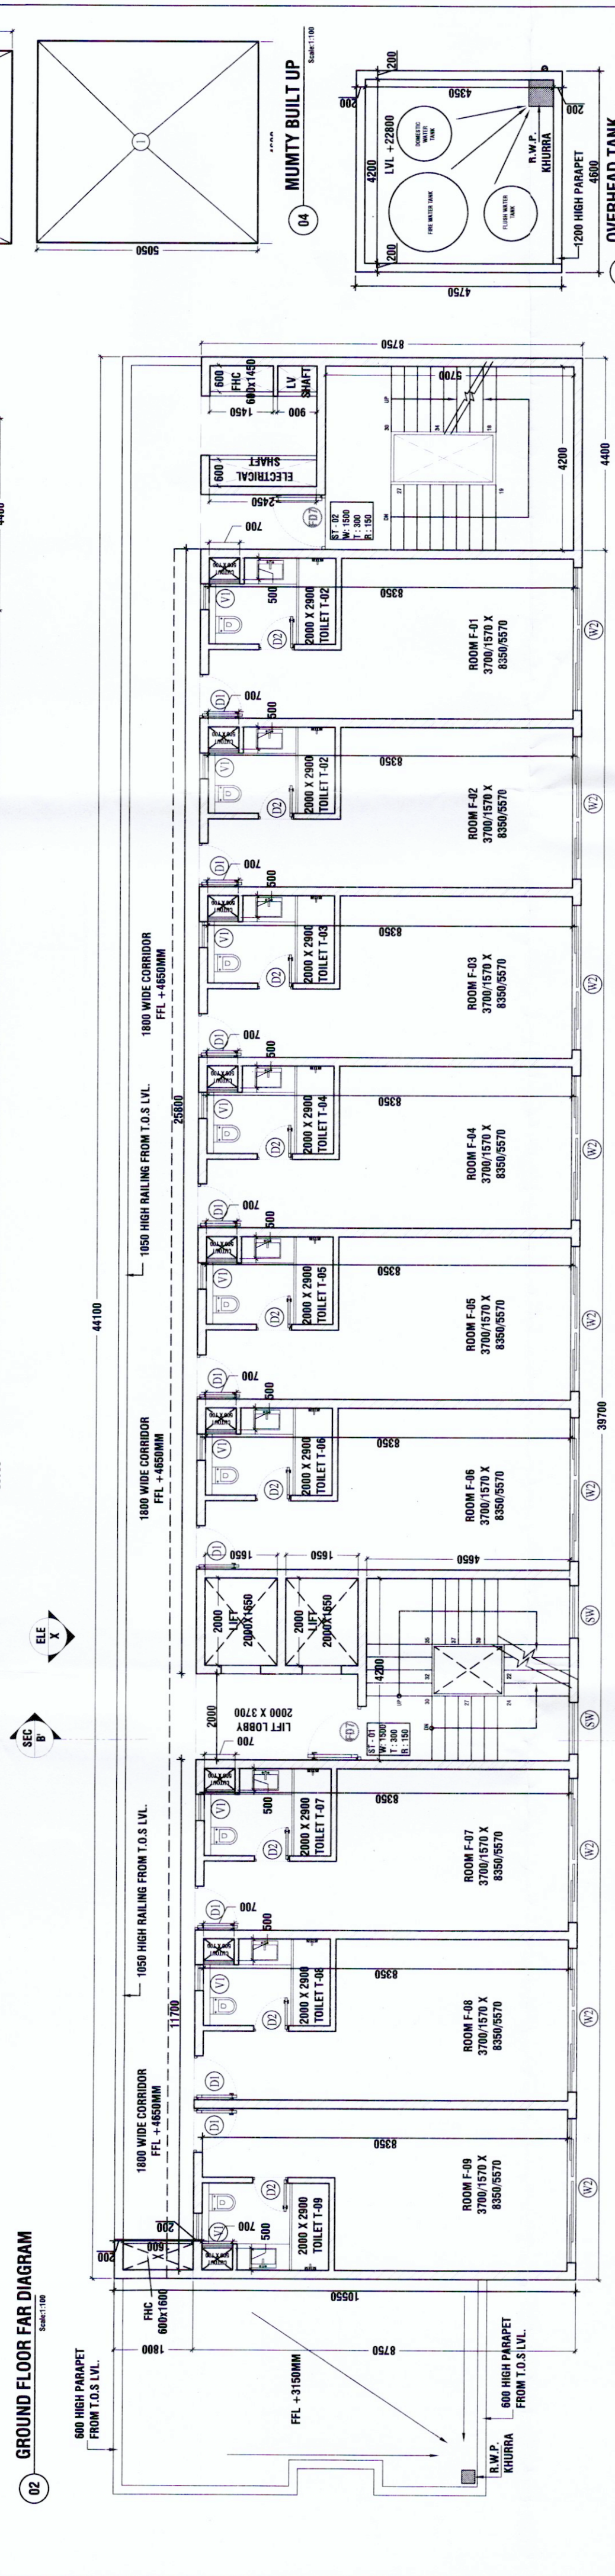


DOOR SCHEDULE

SR. No.	TYPE	OPENING SIZE	DESCRIPTON
01	DO	3300x2400	SHOP PLAZED DOOR
02	D1	1000x2100	ROOM DOOR
03	D2	600x2100	TOILET DOOR
04	FFD	1200x2100	SHOPIFY DOOR
05	WT	3300x1200	SHOP WINDOW
06	WZ	3300x1200	ROOM WINDOW
07	V1	600x900	TOILET VENTILATOR
08	SW	1500x1200	STAIRCASE WINDOW

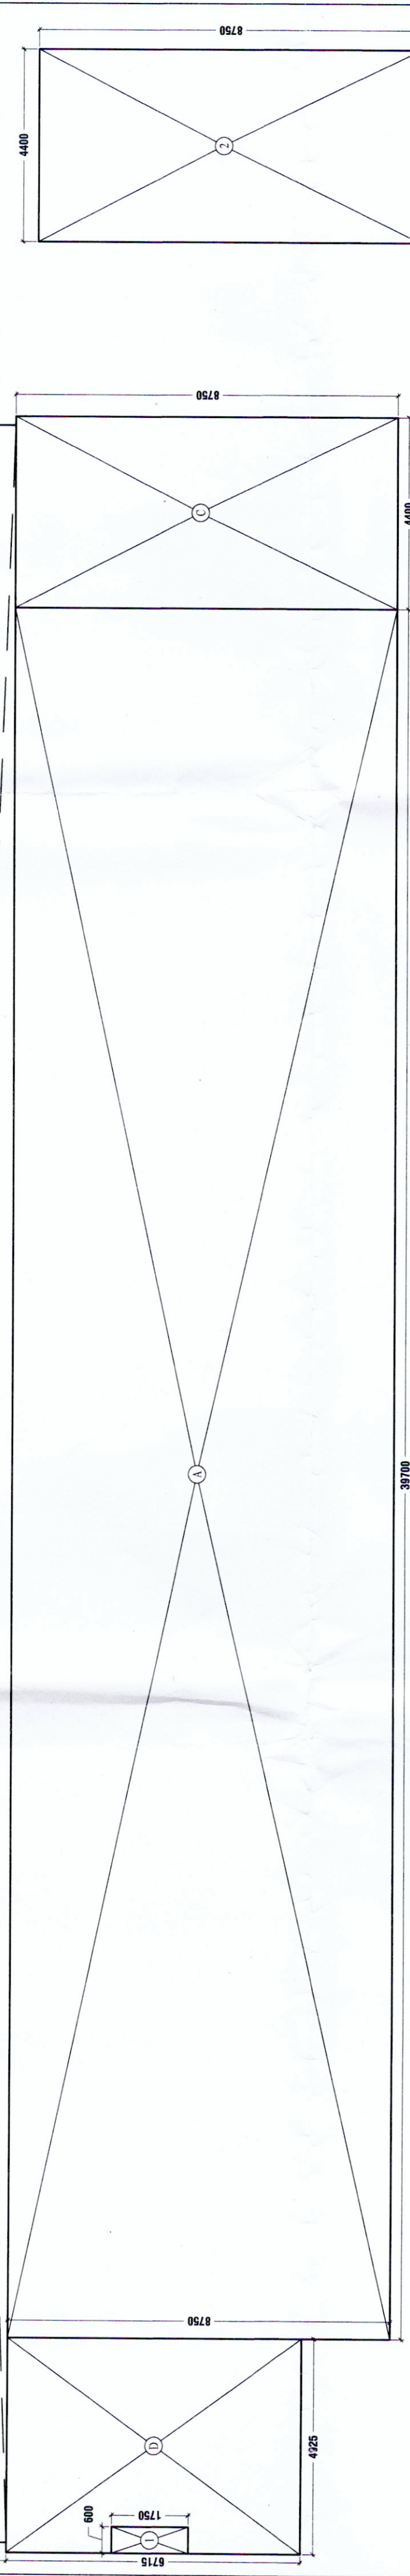

AREA DETAIL

1	GROUND COVERAGE	509.367	SQM
2	GROUND FLOOR FAR	347.275	SQM
3	1ST FLOOR FAR	347.275	SQM
4	2ND FLOOR FAR	347.275	SQM
5	3RD FLOOR FAR	347.275	SQM
6	4TH FLOOR FAR	347.275	SQM
7	5TH FLOOR FAR	347.275	SQM
8	100% FAR AREA ON TYPICAL FLOOR	347.275	SQM
9	MAINTY BUILT UP AREA	129.835	SQM
10	MAINTY BUILT UP AREA IN TOWER	61.730	SQM
11	MACHINE ROOM/BUILT UP AREA	22.230	SQM
12	TOTAL BUILT UP AREA IN TOWER	2294.300	SQM

TYPICAL FLOOR FAR OF COMMERCIAL

S. No.	NAME	SHAPE	LENGTH (L)	WIDTH (B)	HEIGHT (H)	FORMULA	AREA	QUANTITY	TOTAL AREA
1	A	Rectangle	39.700	8.750	--	L x B	347.275	1	347.275
2	C	Rectangle	4.400	8.750	--	L x B	38.500	1	38.500
1. TOTAL ADDITION									385.775

GROUND FLOOR FAR OF COMMERCIAL

S. No.	NAME	SHAPE	LENGTH (L)	WIDTH (B)	HEIGHT (H)	FORMULA	AREA	QUANTITY	TOTAL AREA
1	A	Rectangle	39.700	8.750	--	L x B	347.275	1	347.275
TOTAL FAR ON GROUND FLOOR									347.275

NON FAR IN BUILT UP - ALL FLOORS

S. No.	NAME	SHAPE	LENGTH (L)	WIDTH (B)	HEIGHT (H)	FORMULA	AREA	QUANTITY	TOTAL AREA
1	1	Rectangle	4.200	5.700	--	L x B	23.940	1	23.940
2	2	Rectangle	2.000	3.300	--	L x B	6.600	2	13.200
3	3	Rectangle	44.100	1.800	--	L x B	79.380	1	79.380
TOTAL NON FAR									122.850

TOTAL FAR OF TYPICAL FLOOR

ADDITION (XX)	DEDUCTION (YY)	SQM
385.775	122.850	262.925

MACHINE ROOM & OVERHEAD TANK BUILT UP AREA CALCULATION

S. No.	NAME	SHAPE	LENGTH (L)	WIDTH (B)	HEIGHT (H)	FORMULA	AREA	QUANTITY	TOTAL AREA
1	1	Rectangle	4.600	5.050	--	L x B	23.230	1	23.230
MACHINE ROOM & OVERHEAD TANK BUILT UP AREA									23.230

MUNITY BUILT UP AREA CALCULATION

S. No.	NAME	SHAPE	LENGTH (L)	WIDTH (B)	HEIGHT (H)	FORMULA	AREA	QUANTITY	TOTAL AREA
1	1	Rectangle	4.200	5.700	--	L x B	23.940	1	23.940
2	2	Rectangle	2.000	3.300	--	L x B	6.600	2	13.200
3	3	Rectangle	44.100	1.800	--	L x B	79.380	1	79.380
TOTAL MAINTY BUILT UP AREA									116.520

MUNITY BUILT UP AREA

S. No.	NAME	SHAPE	LENGTH (L)	WIDTH (B)	HEIGHT (H)	FORMULA	AREA	QUANTITY	TOTAL AREA
1	1	Rectangle	4.400	8.750	--	L x B	38.500	1	38.500
2	2	Rectangle	4.400	8.750	--	L x B	38.500	1	38.500
MUNITY FLOOR BUILT UP AREA									61.730

MACHINE ROOM & OVERHEAD TANK BUILT UP AREA

S. No.	NAME	SHAPE	LENGTH (L)	WIDTH (B)	HEIGHT (H)	FORMULA	AREA	QUANTITY	TOTAL AREA
1	1	Rectangle	4.600	5.050	--	L x B	23.230	1	23.230
2	2	Rectangle	4.400	8.750	--	L x B	38.500	1	38.500
TOTAL AREA									61.730

PRINCIPAL ARCHITECT:

 DESIGN FORUM INTERNATIONAL
 K-47, KAILASH COLONY, NEW DELHI-110048
 PHONE NO. 011-46556600

OWNER'S SIGNATURE ARCHITECT'S SIGNATURE

CLIENT:
 M/S BLOSSOM PVT. LTD.

PROJECT:
 PROPOSED BUILDING PLANS OF AFFORDABLE GROUP HOUSING COLONY ADMEASURING 6.675 ACRES (LICENSE NO.09 OF 2022 DATED 31-01-2022) BEING DEVELOPED IN VILLAGE HARASRU, SECTOR 68-B, GURUGRAM BY M/S BLOSSOM PROPERTIES PVT. LTD. AND OTHER LAND OWNERS IN COLLABORATION WITH M/S MAHRA HOMES PVT. LTD.

DRAWING TITLE:
 COMMERCIAL PLANS WITH AREA DIAGRAM

SHEET NO. 19
 SCALE: 1:100
 DATE: 24.02.2022

