





4th FLOOR	0.00
FAR (IN SQ.M)	27222.82
NON-FAR (IN SQ.M)	27222.82
BUILDUP AREA (IN SQ.M)	27222.82

**Exit Calculation For 4th Basement**

Floors	Area	Average Occupant load as per NBCC	No. of Occupant	As per NBCC (@ 10 mm Person)	Exit Required	Exit Provided
Basement Area	27222.82	30	816.68	816.68	4 (F1-F4)	4 (F1-F4)
ST-01	2300		230	230		
ST-02	2300		230	230		
ST-03	2150		215	215		
ST-04	2150		215	215		
ST-05	2300		230	230		
ST-06	2300		230	230		
ST-07	2150		215	215		
ST-08	2150		215	215		
ST-09	2150		215	215		
ST-10	2150		215	215		
ST-11	2150		215	215		
ST-12	2150		215	215		
<b>TOTAL</b>			<b>816.68</b>	<b>816.68</b>		<b>816.68</b>

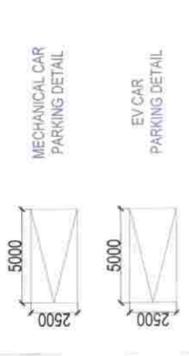

**4th BASEMENT :-  
MECHANICAL CAR PARKING  
= 500 X 2 = 1066 NOS.**

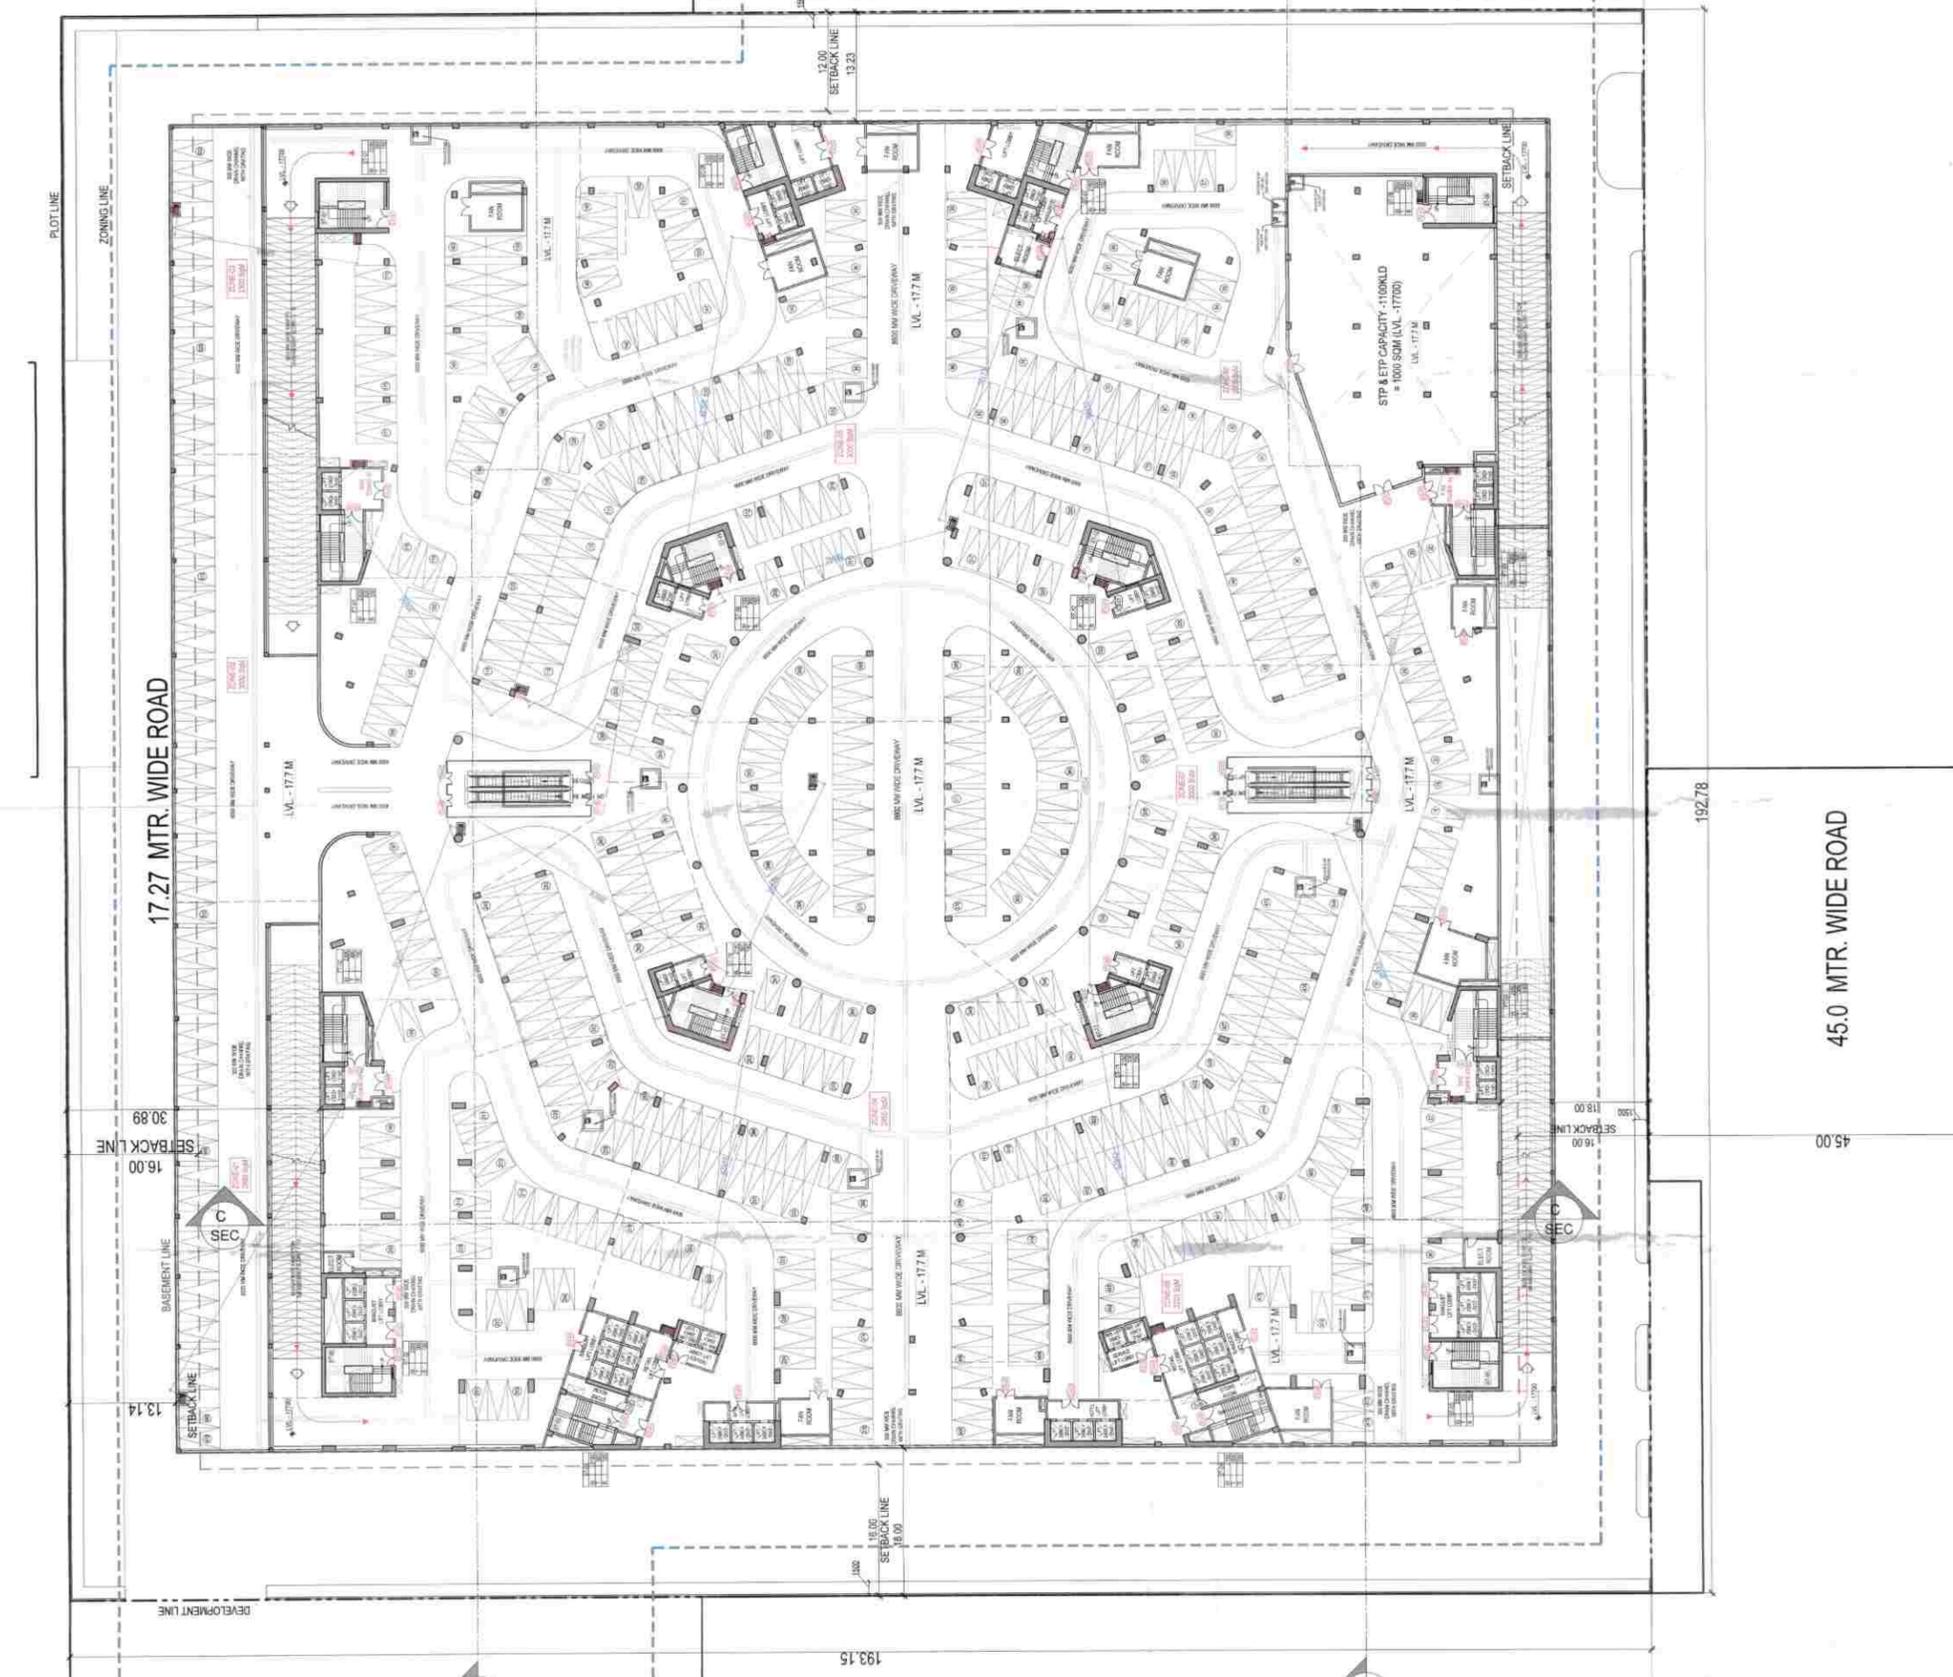

**NOTES**

- THE DEVELOPER SHALL BE RESPONSIBLE FOR DESIGNING AND PROVIDING THE NECESSARY MEASURES TO PROTECT THE BUILDING FROM COLLAPSE DURING CONSTRUCTION.
- ALL CONSTRUCTION SHALL BE MECHANICALLY SCHEDULED TO THE 'TOILET ROOMS AND WENT OUT ROOMS' AS PER THE 'MECHANICAL SCHEDULE'.
- ALL SPACES SHALL BE MAINTAINED AS PER THE 'MECHANICAL SCHEDULE'.
- ALL MATERIALS SHALL BE STORED IN THE 'MATERIALS STORAGE AREA' AND NOT IN THE 'TOILET ROOMS'.
- ALL AREAS SHALL BE MAINTAINED AS PER THE 'MECHANICAL SCHEDULE'.
- ALL SERVICES SHALL BE PROVIDED AS PER THE 'MECHANICAL SCHEDULE'.
- ALL SERVICES SHALL BE PROVIDED AS PER THE 'MECHANICAL SCHEDULE'.
- ALL SERVICES SHALL BE PROVIDED AS PER THE 'MECHANICAL SCHEDULE'.
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- ALL SERVICES SHALL BE PROVIDED AS PER THE 'MECHANICAL SCHEDULE'.
- ALL SERVICES SHALL BE PROVIDED AS PER THE 'MECHANICAL SCHEDULE'.

**SUBMISSION DRAWING**

KEY PLAN

**OWNER:** [Logo]

**ARCHITECTS:** [Logo]

**STRUCTURE CONSULTANT:** [Logo]

**MEP CONSULTANT:** [Logo]

**ARCHITECT SIGN:** [Logo]

**OWNER SIGN:** [Logo]

**PROJECT:** [Text]

**DATE:** [Text]

**SCALE:** 1:300

**DWG. NO.:** SS-GFM-4R-02

**4th BASEMENT FLOOR PLAN**

**SCHEDULE OF OPENINGS**

TYPE	WIDTH	HEIGHT	SILL HT.	UNITS	TYPE	WIDTH	HEIGHT	SILL HT.	UNITS
D01	2500	2100	-	2100	FIRE DOOR	2000	2100	-	2100
D02	2000	2100	-	2100	FIRE DOOR	2000	2100	-	2100
D03	1500	2100	-	2100	FIRE DOOR	2000	2100	-	2100
D04	1200	2100	-	2100	FIRE DOOR	2000	2100	-	2100
D05	1000	2100	-	2100	FIRE DOOR	2000	2100	-	2100
D06	750	2100	-	2100	FIRE DOOR	2000	2100	-	2100
D07	1050	600	1500	2100	FIRE DOOR	2000	2100	-	2100
D08	600	600	1500	2100	FIRE DOOR	2000	2100	-	2100
D09	1800	1200	900	2100	FIRE DOOR	2000	2100	-	2100
D10	AS PER PLAN	AS PER PLAN	AS PER PLAN	2100	FIRE DOOR	2000	2100	-	2100
D11	AS PER PLAN	AS PER PLAN	AS PER PLAN	2100	FIRE DOOR	2000	2100	-	2100
D12	AS PER PLAN	AS PER PLAN	AS PER PLAN	2100	FIRE DOOR	2000	2100	-	2100
D13	AS PER PLAN	AS PER PLAN	AS PER PLAN	2100	FIRE DOOR	2000	2100	-	2100

**4th BASEMENT PLAN**  
LVL. - 17.70 M








2nd BASEMENT	
FAR (IN SQ.M)	0.00
NON-FAR (IN SQ.M)	25948.75
BUILT-UP AREA (IN SQ.M)	25948.75

Exit Calculation For 2nd Basement

Floor	Area	Average Occupant load as per NBC	No. of Occupant	As per NBC ( @ 10 min Person)	Exit Required	Exit Provided
Built-up Area	25948.75	30	868.33	10	As per NBC ( @ 10 min Person)	JD/HQ
Star No.						Width of Staircase in mm
FT-01						2300
FT-02						2300
FT-03						2300
FT-04						2300
FT-05						2300
FT-06						2300
FT-07						2300
FT-08						2300
FT-09						2300
FT-10						2300
FT-11						2300
FT-12						2300
TOTAL						36800

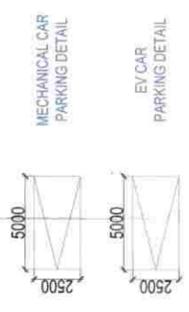

2nd BASEMENT :-  
MECHANICAL CAR PARKING  
= 346 X 2 = 692 NOS.


- NOTES**
1. ALL USABLE SPACES ARE TO BE PROVIDED WITH CEILING LIGHTING AND VENTILATION AS PER NBC REQUIREMENTS.
  2. ALL USABLE SPACES ARE TO BE PROVIDED WITH CEILING LIGHTING AND VENTILATION AS PER NBC REQUIREMENTS.
  3. ALL USABLE SPACES ARE TO BE PROVIDED WITH CEILING LIGHTING AND VENTILATION AS PER NBC REQUIREMENTS.
  4. ALL USABLE SPACES ARE TO BE PROVIDED WITH CEILING LIGHTING AND VENTILATION AS PER NBC REQUIREMENTS.
  5. ALL USABLE SPACES ARE TO BE PROVIDED WITH CEILING LIGHTING AND VENTILATION AS PER NBC REQUIREMENTS.
  6. ALL USABLE SPACES ARE TO BE PROVIDED WITH CEILING LIGHTING AND VENTILATION AS PER NBC REQUIREMENTS.
  7. ALL USABLE SPACES ARE TO BE PROVIDED WITH CEILING LIGHTING AND VENTILATION AS PER NBC REQUIREMENTS.
  8. ALL USABLE SPACES ARE TO BE PROVIDED WITH CEILING LIGHTING AND VENTILATION AS PER NBC REQUIREMENTS.
  9. ALL USABLE SPACES ARE TO BE PROVIDED WITH CEILING LIGHTING AND VENTILATION AS PER NBC REQUIREMENTS.
  10. ALL USABLE SPACES ARE TO BE PROVIDED WITH CEILING LIGHTING AND VENTILATION AS PER NBC REQUIREMENTS.

SUBMISSION DRAWING  
KEY PLAN

OWNER: OMASE WORLD STREET PRIVATE LIMITED  
ARCHITECTS: O.P.S. ARCHITECTS  
STRUCTURE CONSULTANT: manish consultants  
MEP CONSULTANT: UDAYAN CHAUDHARI & ASSOCIATES PRIVATE LIMITED  
ARCHITECT SIGN: UDAYAN CHAUDHARI & ASSOCIATES PRIVATE LIMITED

SCHEDULE OF OPENINGS

TYPE	WIDTH	HEIGHT	SILL HT.	UNTEL	TYPE	WIDTH	HEIGHT	SILL HT.	UNTEL
001	2500	2100	-	2100	FIRE DOOR	2500	2100	-	2100
002	2000	2100	-	2100	FIRE DOOR	2000	2100	-	2100
003	1500	2100	-	2100	FIRE DOOR	1500	2100	-	2100
004	1000	2100	-	2100	FIRE DOOR	1000	2100	-	2100
005	750	2100	-	2100	FIRE DOOR	750	2100	-	2100
006	600	2100	-	2100	FIRE DOOR	600	2100	-	2100
007	500	2100	-	2100	FIRE DOOR	500	2100	-	2100
008	400	2100	-	2100	FIRE DOOR	400	2100	-	2100
009	300	2100	-	2100	FIRE DOOR	300	2100	-	2100
010	200	2100	-	2100	FIRE DOOR	200	2100	-	2100

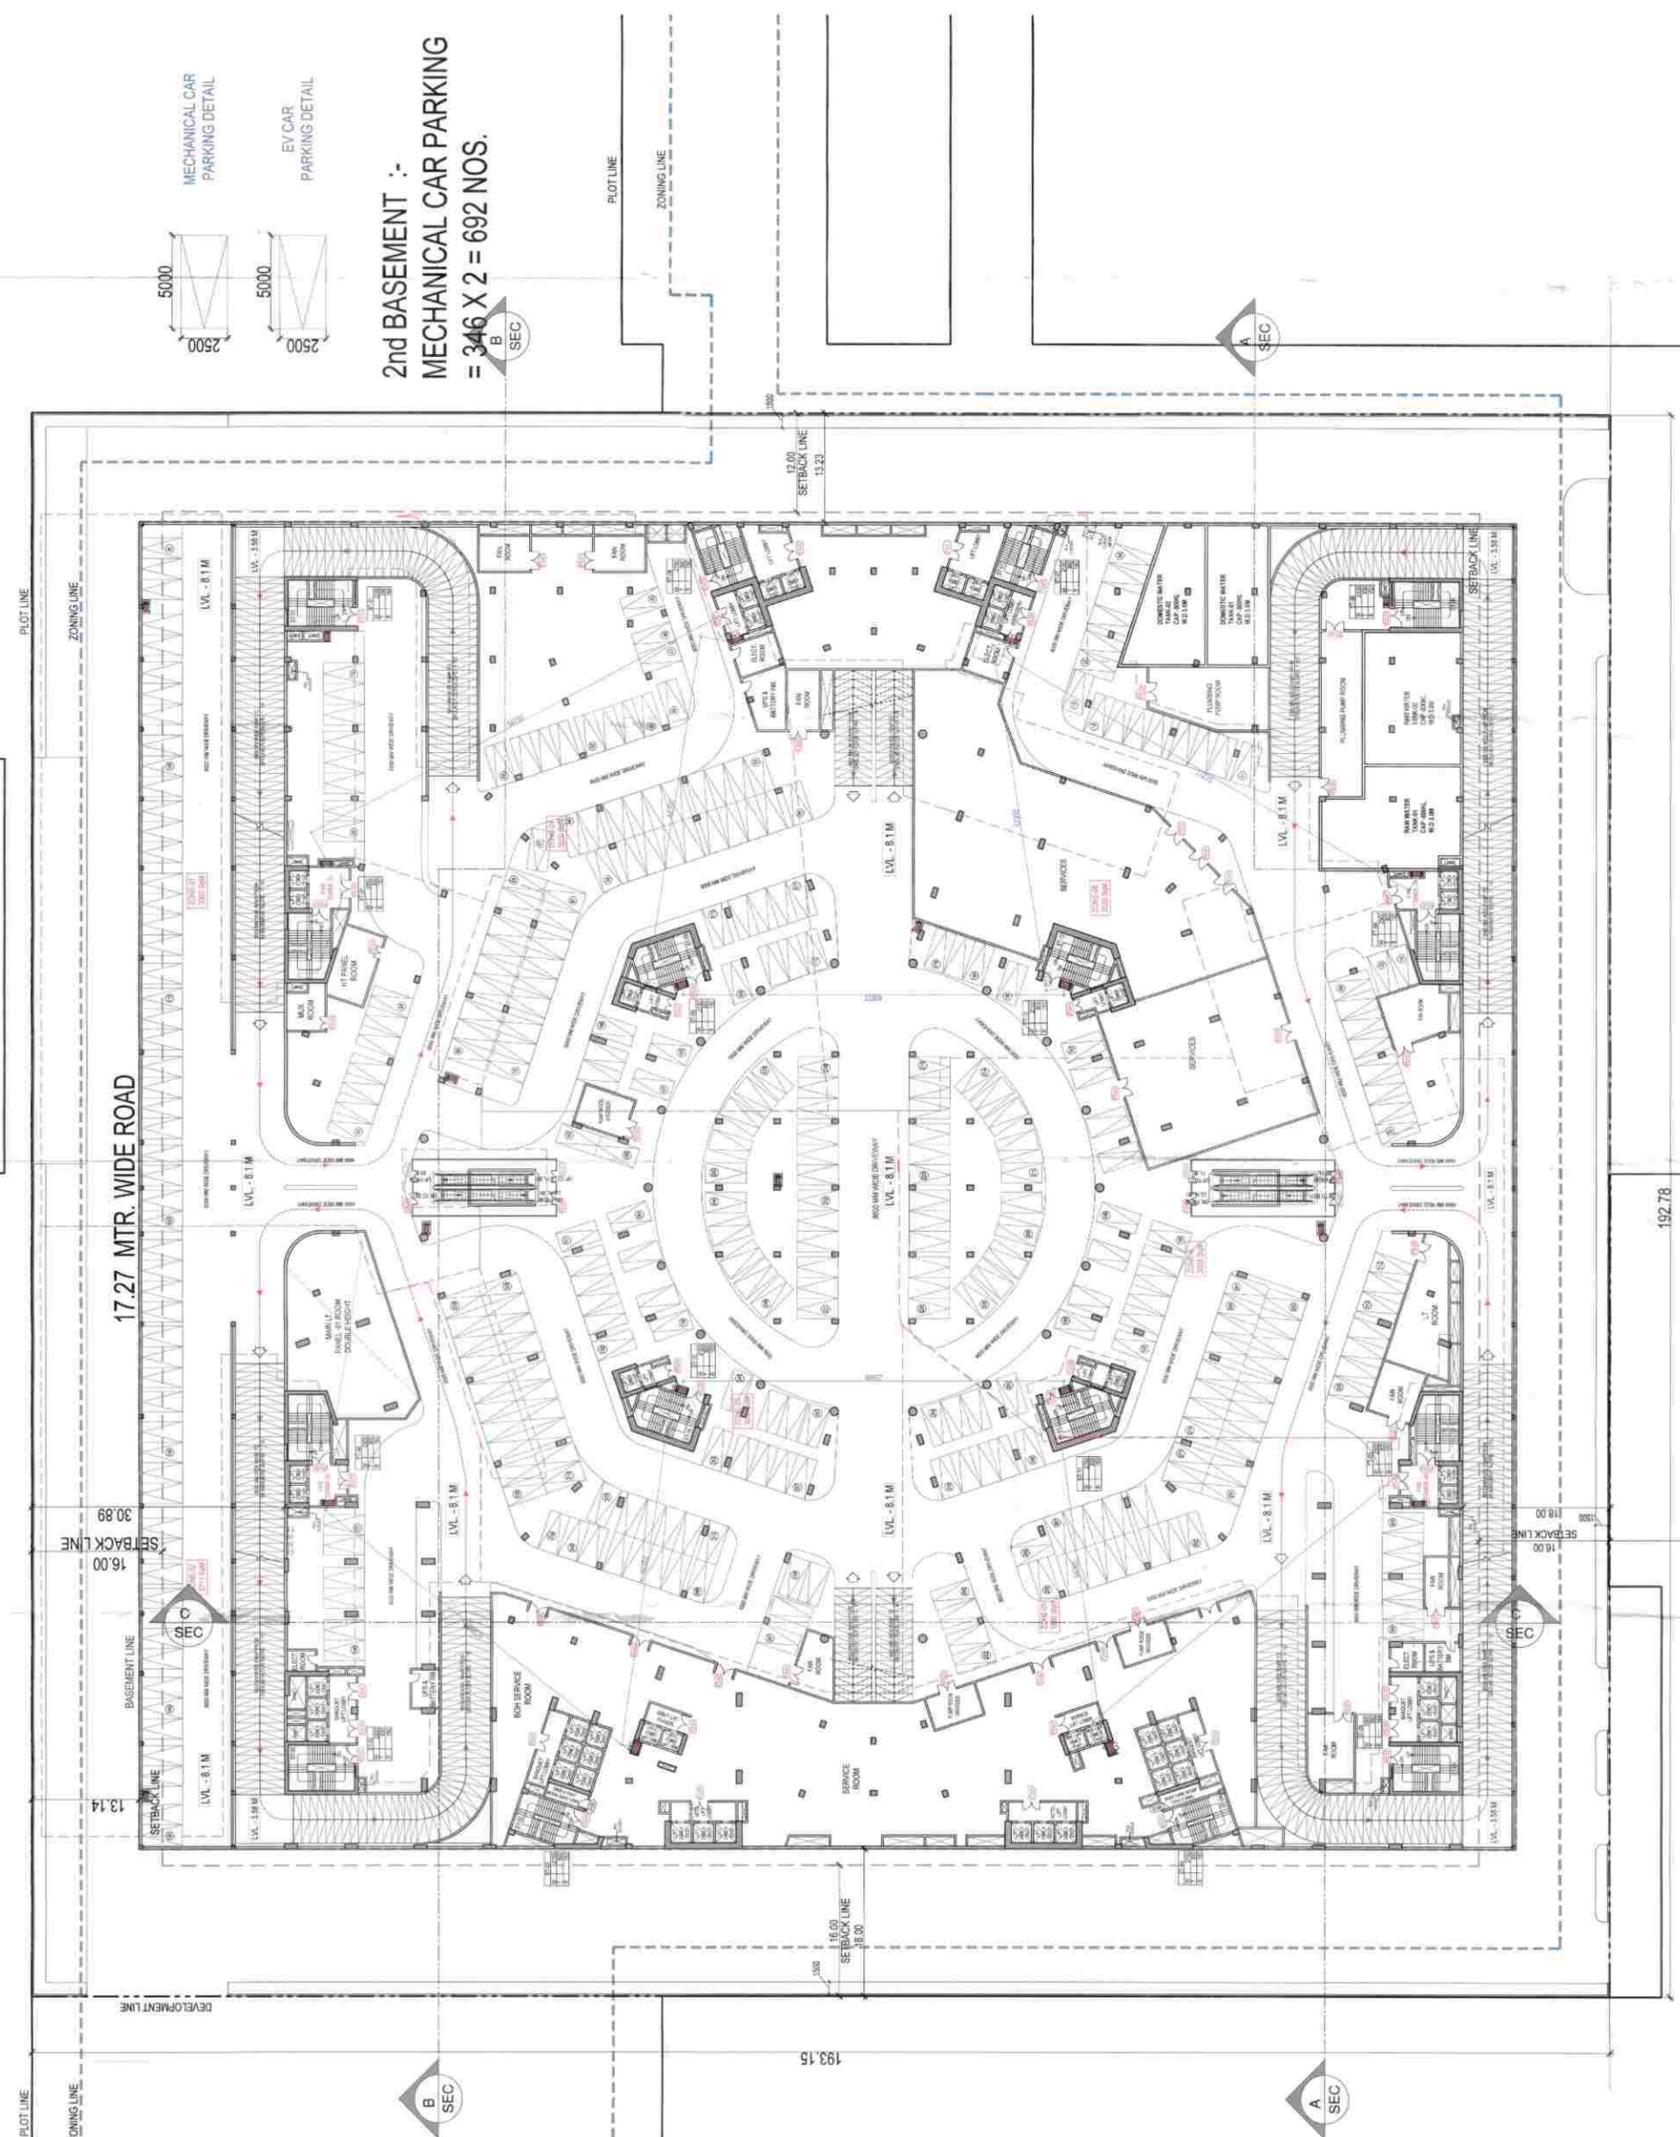

2nd BASEMENT PLAN  
LVL. - 8.10 M








**GROUND COVERAGE**  
 2444.03  
 2444.03  
 2444.03

**Exit Calculation For Ground Floor**

Total Building Area	2444.03
Direct Exit Area	1948.75
Net Building Area	495.28

Floors	Area	Average Occupant load as per NBCC	No. of Occupant	As per NBCC ( @ 10 mm Person)	Exit Required	Exit Provided
1st	1948.75	3	6496.58	10	10	10
2nd						
3rd						
4th						
5th						
6th						
7th						
8th						
9th						
10th						
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89th						
90th						
91st						
92nd						
93rd						
94th						
95th						
96th						
97th						
98th						
99th						
100th						
TOTAL	67400					

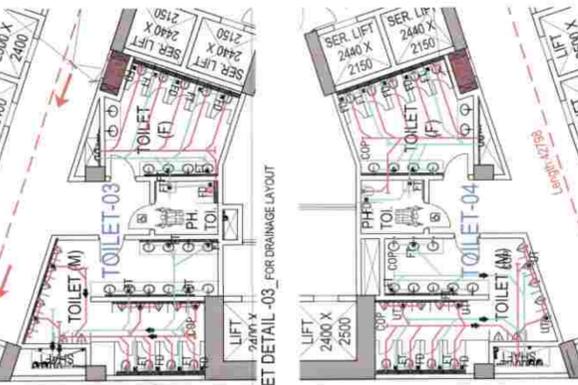

**GROUND FLOOR TOILET CALCULATION**

NO.	AREA	NO. OF TOILETS	NO. OF OCCUPANTS	NO. OF TOILETS REQUIRED
1	100	1	10	1
2	100	1	10	1
3	100	1	10	1
4	100	1	10	1
5	100	1	10	1
6	100	1	10	1
7	100	1	10	1
8	100	1	10	1
9	100	1	10	1
10	100	1	10	1
11	100	1	10	1
12	100	1	10	1
13	100	1	10	1
14	100	1	10	1
15	100	1	10	1
16	100	1	10	1
17	100	1	10	1
18	100	1	10	1
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22	100	1	10	1
23	100	1	10	1
24	100	1	10	1
25	100	1	10	1
26	100	1	10	1
27	100	1	10	1
28	100	1	10	1
29	100	1	10	1
30	100	1	10	1
31	100	1	10	1
32	100	1	10	1
33	100	1	10	1
34	100	1	10	1
35	100	1	10	1
36	100	1	10	1
37	100	1	10	1
38	100	1	10	1
39	100	1	10	1
40	100	1	10	1
41	100	1	10	1
42	100	1	10	1
43	100	1	10	1
44	100	1	10	1
45	100	1	10	1
46	100	1	10	1
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84	100	1	10	1
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89	100	1	10	1
90	100	1	10	1
91	100	1	10	1
92	100	1	10	1
93	100	1	10	1
94	100	1	10	1
95	100	1	10	1
96	100	1	10	1
97	100	1	10	1
98	100	1	10	1
99	100	1	10	1
100	100	1	10	1



**SCHEDULE OF OPENINGS**

TYPE	WIDTH	HEIGHT	SILL HT. UNITS	TYPE	WIDTH	HEIGHT	SILL HT. UNITS
D01	2500	2100	-	2100	200	2100	-
D02	2000	2100	-	2100	200	2100	-
D03	1500	2100	-	2100	200	2100	-
D04	1000	2100	-	2100	200	2100	-
D05	750	2100	-	2100	200	2100	-
D06	500	2100	-	2100	200	2100	-
D07	250	2100	-	2100	200	2100	-
D08	100	2100	-	2100	200	2100	-
D09	50	2100	-	2100	200	2100	-
D10	25	2100	-	2100	200	2100	-
D11	12.5	2100	-	2100	200	2100	-
D12	6.25	2100	-	2100	200	2100	-
D13	3.125	2100	-	2100	200	2100	-
D14	1.5625	2100	-	2100	200	2100	-
D15	0.78125	2100	-	2100	200	2100	-
D16	0.390625	2100	-	2100	200	2100	-
D17	0.1953125	2100	-	2100	200	2100	-
D18	0.09765625	2100	-	2100	200	2100	-
D19	0.048828125	2100	-	2100	200	2100	-
D20	0.0244140625	2100	-	2100	200	2100	-
D21	0.01220703125	2100	-	2100	200	2100	-
D22	0.006103515625	2100	-	2100	200	2100	-
D23	0.0030517578125	2100	-	2100	200	2100	-
D24	0.00152587890625	2100	-	2100	200	2100	-
D25	0.000762939453125	2100	-	2100	200	2100	-
D26	0.0003814697265625	2100	-	2100	200	2100	-
D27	0.00019073486328125	2100	-	2100	200	2100	-
D28	0.000095367431640625	2100	-	2100	200	2100	-
D29	0.000047683715						

GROUND FLOOR  
 FAR (IN SQ.M) 24440.03  
 NEAR (IN SQ.M) 1402.84  
 BUILT-UP AREA (IN SQ.M) 24440.03

Exit Calculation For Ground Floor

Floors	Area	Average Occupant load as per NBCC	No. of Occupant	Exit Required	Exit Provided
Built-up Area	19485.75	3	58456.25	54955.82	
Total Built-up Area	24440.03				
Direct Exit Area	4950.28				
Net Built-up Area	19485.75				

Sl. No.	Length	Breadth	Formula	No.	Area (SQM)
F01	161.55	X	17.48	2	5647.79
F02	73.44	X	19.46	4	5716.57
F03	4.86	X	14.59	4	141.67
F04	1.62	X	4.88	2	15.81
F05	161.55	X	70.38	1	11369.89
F06	7.85	X	6.57	1	51.57
F07	5.31	X	7.55	1	40.09
G03	6.00	X	9.00	1	54.00
<b>TOTAL FAR AREA AT GROUND FLOOR (A)</b>					<b>23037.39</b>

GROUND FLOOR AREA CALCULATION






S.No.	Length	Breadth	Formula	No.	Area (SQM)
F01	161.55	X	17.48	2	5647.79
F02	73.44	X	19.46	4	5716.57
F03	4.86	X	14.59	4	141.67
F04	1.62	X	4.88	2	15.81
F05	161.55	X	70.38	1	11369.89
F06	7.85	X	6.57	1	51.57
F07	5.31	X	7.55	1	40.09
G03	6.00	X	9.00	1	54.00
<b>TOTAL FAR AREA AT GROUND FLOOR (A)</b>					<b>23037.39</b>

GROUND COVERAGE (GFT) AREA CALCULATION

S.No.	Length	Breadth	Formula	No.	Area (SQM)
F01	161.55	X	17.48	2	5647.79
F02	73.44	X	19.46	4	5716.57
F03	4.86	X	14.59	4	141.67
F04	1.62	X	4.88	2	15.81
F05	161.55	X	70.38	1	11369.89
F06	7.85	X	6.57	1	51.57
F07	5.31	X	7.55	1	40.09
G01	7.06	X	9.76	2	137.81
G02	30.23	X	5.23	1	1264.82
G03	6.00	X	9.00	1	54.00
<b>TOTAL AREA AT (GFT) GROUND COVERAGE (A)</b>					<b>24440.03</b>

SCHEDULE OF OPENINGS

TYPE	WIDTH	HEIGHT	SILL HT.	UNTEL	TYPE	WIDTH	HEIGHT	SILL HT.	UNTEL
I01	2500	2100	-	2100	FERRE DOOR	2400	2100	-	2100
I02	2000	2100	-	2100	F02	2400	2100	-	2100
I03	1500	2100	-	2100	I03	2000	2100	-	2100
I04	1200	2100	-	2100	I04	1500	2100	-	2100
I05	750	2100	-	2100	I05	1000	2100	-	2100
I06	1050	600	1500	2100	I06	1000	2100	-	2100
I07	600	600	1500	2100	I07	1000	2100	-	2100
I08	1800	1200	900	2100	I08	1000	2100	-	2100
I09	AS PER PLAN	-	-	-	I09	AS PER PLAN	-	-	-
I10	AS PER PLAN	-	-	-	I10	AS PER PLAN	-	-	-
I11	AS PER PLAN	-	-	-	I11	AS PER PLAN	-	-	-
I12	AS PER PLAN	-	-	-	I12	AS PER PLAN	-	-	-

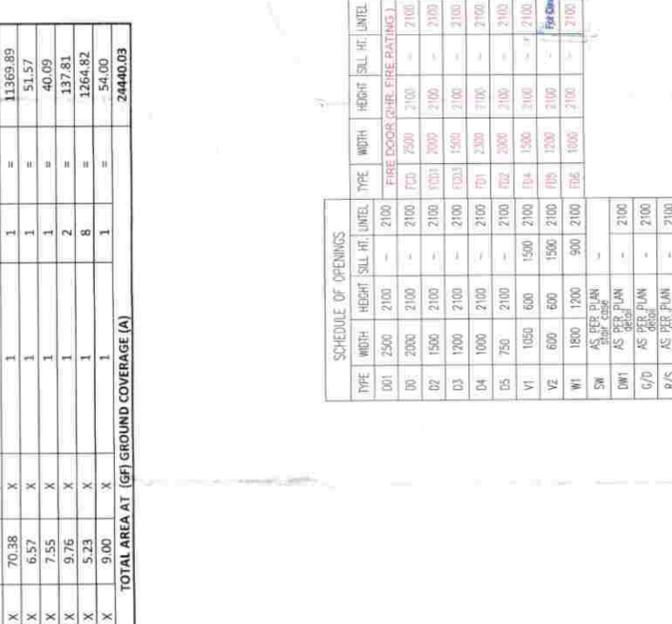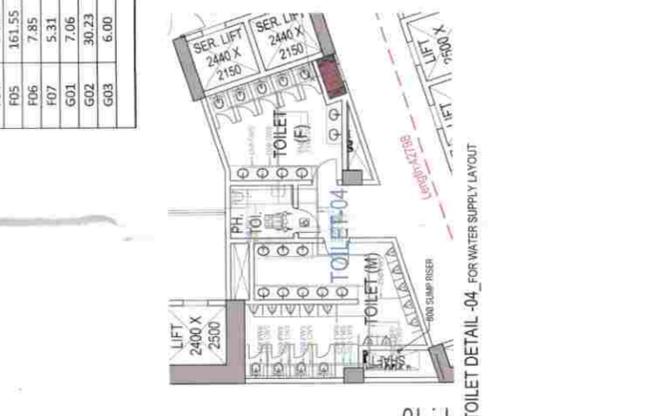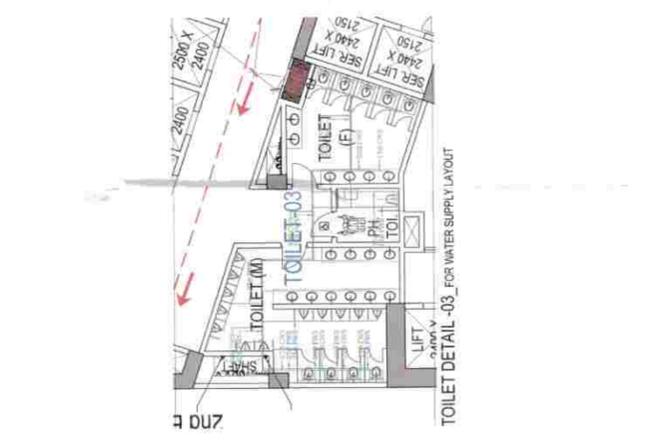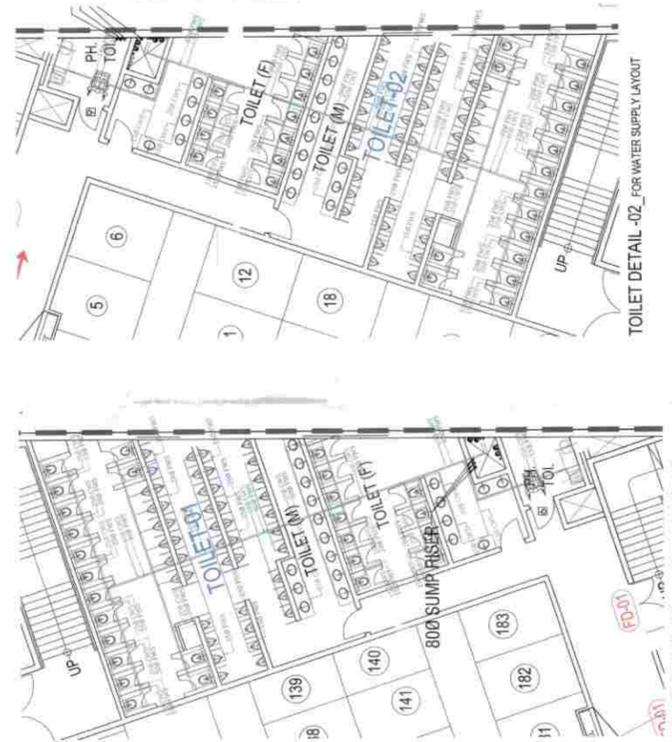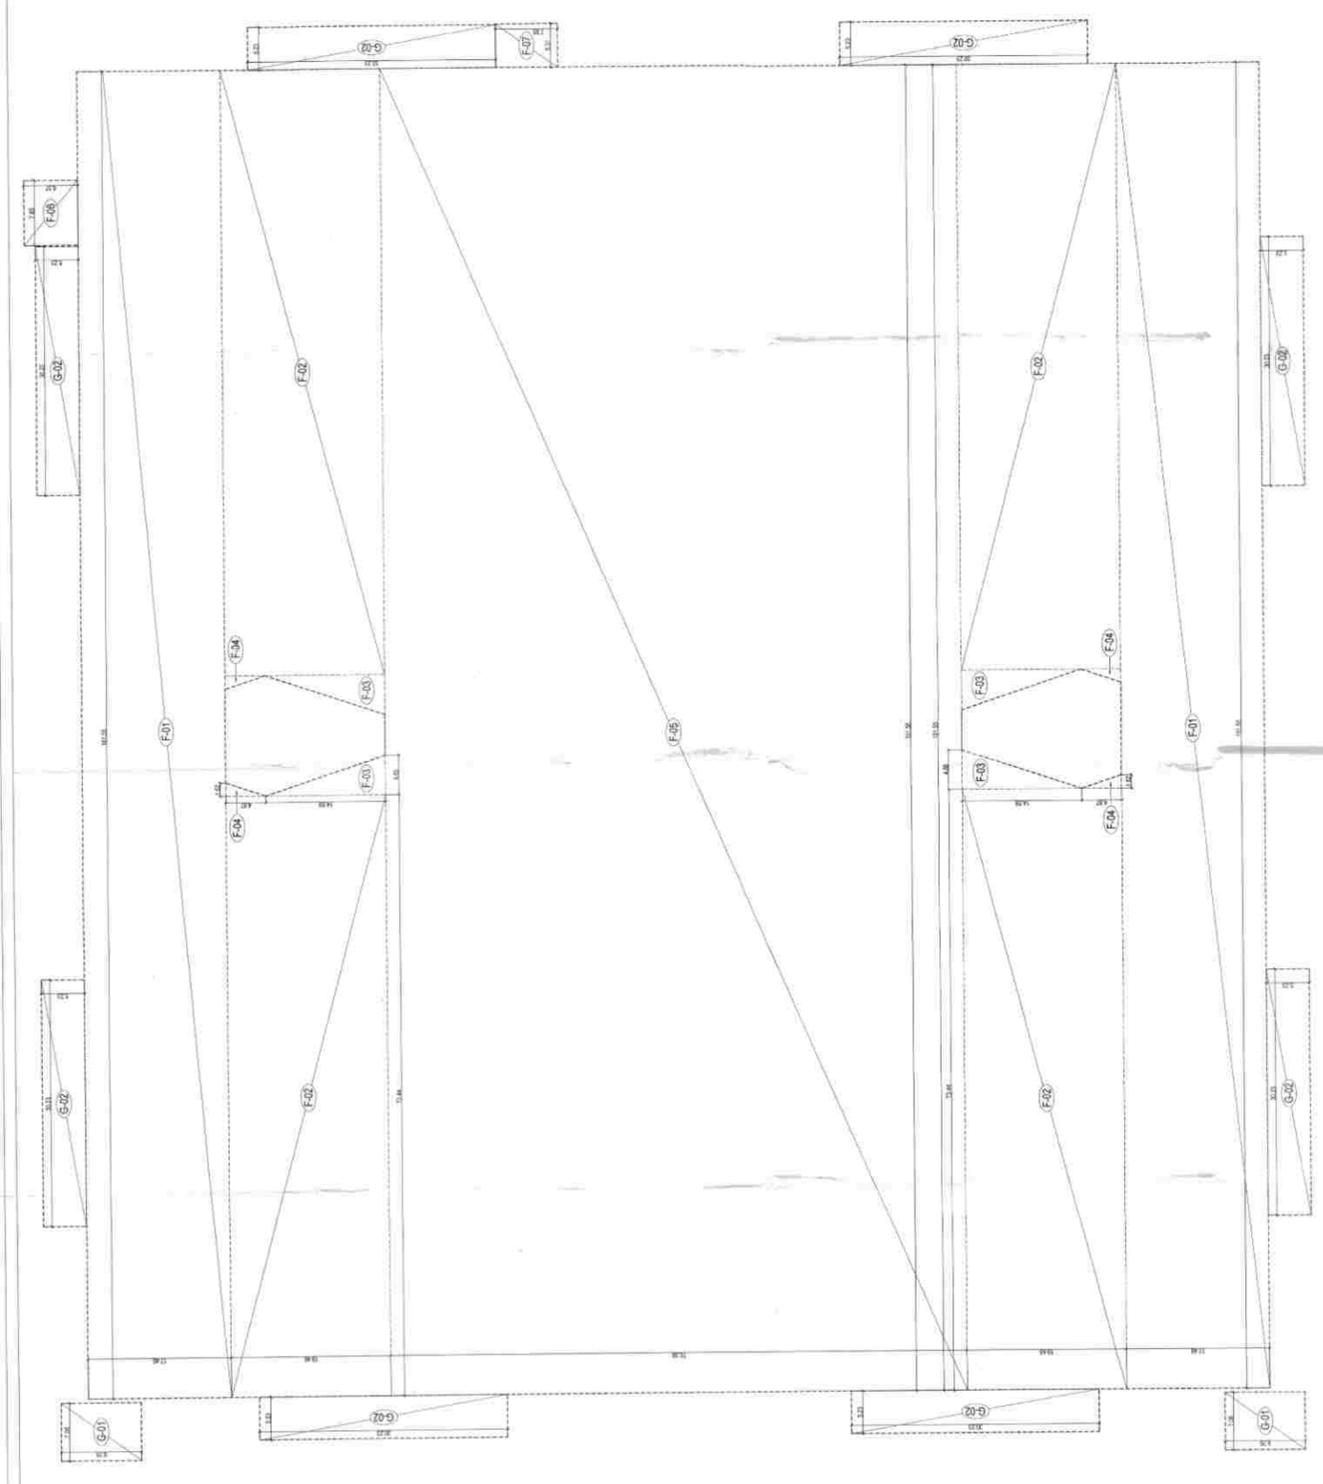

NOTES  
 1. THE DEVELOPMENT HAS BEEN CONSIDERED, DESIGNED AND  
 2. ALL SERVICES SHALL BE PROVIDED IN ACCORDANCE WITH THE  
 3. ALL SERVICES SHALL BE PROVIDED IN ACCORDANCE WITH THE  
 4. ALL SERVICES SHALL BE PROVIDED IN ACCORDANCE WITH THE  
 5. ALL SERVICES SHALL BE PROVIDED IN ACCORDANCE WITH THE  
 6. ALL SERVICES SHALL BE PROVIDED IN ACCORDANCE WITH THE  
 7. ALL SERVICES SHALL BE PROVIDED IN ACCORDANCE WITH THE  
 8. ALL SERVICES SHALL BE PROVIDED IN ACCORDANCE WITH THE  
 9. ALL SERVICES SHALL BE PROVIDED IN ACCORDANCE WITH THE  
 10. ALL SERVICES SHALL BE PROVIDED IN ACCORDANCE WITH THE

SUBMISSION DRAWING

KEY PLAN

OWNER: OMAKA WORLD STREET FRONTAL DEVELOPMENT

ARCHITECTS: OMAKA WORLD STREET FRONTAL DEVELOPMENT

STRUCTURE CONSULTANT: manish manish consultants

MEP CONSULTANT: UDAYAN CHAUDHARI & ASSOCIATES PRIVATE LIMITED

PROJECT: OMAKA WORLD STREET FRONTAL DEVELOPMENT

OWNER SIGN: OMAKA WORLD STREET FRONTAL DEVELOPMENT

ARCHITECT SIGN: OMAKA WORLD STREET FRONTAL DEVELOPMENT

GROUND FLOOR PLAN AREA CALCULATION

DRG. NO. SS-GPM-AR-05A

SCALE: 1:300

DATE: 11/07/2025 11:52 AM

<b>1st FLOOR</b>	
F.A.R. (IN SQ.MT)	15138.96
NON F.A.R. (IN SQ.MT)	703.73
BUILT-UP AREA (IN SQ.MT)	15842.69

EXIT Calculation For 1st Floor  
15842.69

Floors	Area	Average Occupant load as per NBC	No. of Occupant	As per NBC (10 min Person)	Exit Required	Exit Provided
Build-up Area	15842.69	6	2940.45	10	2940.45	
ST-01						2300
ST-02						2300
ST-03						2300
ST-04						2300
ST-05						2300
ST-06						2300
ST-07						2300
ST-08						2300
ST-09						2300
ST-10						2300
ST-11						2300
ST-12						2300
<b>TOTAL</b>						<b>38600</b>

1st FLOOR TOILET CALCULATION

TOILET	AREA (SQ.M)	NO. OF TOILETS	NO. OF OCCUPANTS	NO. OF TOILETS REQUIRED
TOILET-01	100	1	10	1
TOILET-02	100	1	10	1
TOILET-03	100	1	10	1
TOILET-04	100	1	10	1
TOILET-05	100	1	10	1
TOILET-06	100	1	10	1
TOILET-07	100	1	10	1
TOILET-08	100	1	10	1
TOILET-09	100	1	10	1
TOILET-10	100	1	10	1
TOILET-11	100	1	10	1
TOILET-12	100	1	10	1
<b>TOTAL</b>	<b>1200</b>	<b>12</b>	<b>120</b>	<b>12</b>

**NOTES**

- THE DEVELOPMENT HAS BEEN CONSIDERED UNDER THE USE OF COMMON SERVICES UNIT SERVANT ROOM (USE OF COMMON SERVICES UNIT SERVANT ROOM IS NOT PERMITTED AS PER NBC).
- ALL TOILETS SHALL BE PROVIDED WITH VENTILATION SYSTEM AS PER NBC.
- ALL TOILETS SHALL BE PROVIDED WITH WATER SUPPLY SYSTEM AS PER NBC.
- ALL TOILETS SHALL BE PROVIDED WITH ELECTRICAL SUPPLY SYSTEM AS PER NBC.
- ALL TOILETS SHALL BE PROVIDED WITH MECHANICAL SUPPLY SYSTEM AS PER NBC.
- ALL TOILETS SHALL BE PROVIDED WITH SANITATION SYSTEM AS PER NBC.
- ALL TOILETS SHALL BE PROVIDED WITH HEATING SYSTEM AS PER NBC.
- ALL TOILETS SHALL BE PROVIDED WITH COOLING SYSTEM AS PER NBC.
- ALL TOILETS SHALL BE PROVIDED WITH FIRE ALARM SYSTEM AS PER NBC.
- ALL TOILETS SHALL BE PROVIDED WITH FIRE EXTINGUISHING SYSTEM AS PER NBC.
- ALL TOILETS SHALL BE PROVIDED WITH FIRE ESCAPE SYSTEM AS PER NBC.
- ALL TOILETS SHALL BE PROVIDED WITH FIRE FIGHTING SYSTEM AS PER NBC.
- ALL TOILETS SHALL BE PROVIDED WITH FIRE PREVENTION SYSTEM AS PER NBC.
- ALL TOILETS SHALL BE PROVIDED WITH FIRE DETECTION SYSTEM AS PER NBC.
- ALL TOILETS SHALL BE PROVIDED WITH FIRE ALARM SYSTEM AS PER NBC.

**SUBMISSION DRAWING**

KEY PLAN

OWNER: ONASA WORLD CITY PRIVATE LIMITED

ARCHITECTS: MANISH MANI CONSULTANTS

STRUCTURE CONSULTANT: MANISH MANI CONSULTANTS

MEP CONSULTANT: MANISH MANI CONSULTANTS

PROJECT: ONASA WORLD CITY (PHASE 1) COMMERCIAL RESIDENTIAL BUILDING

OWNER SIGN: MANISH MANI CONSULTANTS


ARCHITECT SIGN: MANISH MANI CONSULTANTS

MEP SIGN: MANISH MANI CONSULTANTS


DATE: 11/27/2023 11:32 AM

SCALE: 1:300

DWG. NO.: SS-GPM-AR-07

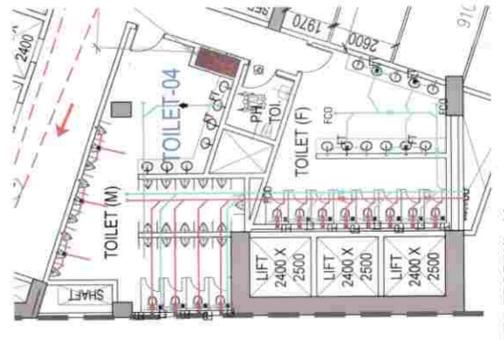

TOILET DETAIL -04 FOR DRAINAGE LAYOUT

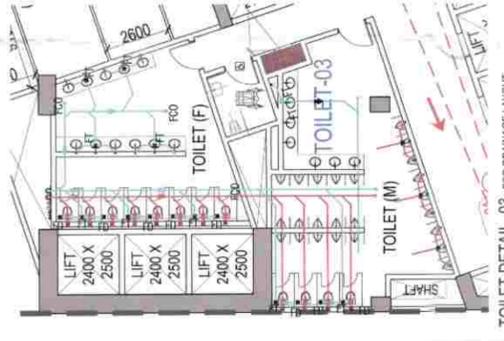


TOILET DETAIL -03 FOR DRAINAGE LAYOUT



TOILET DETAIL -01 FOR DRAINAGE LAYOUT

SCHEDULE OF OPENINGS


TYPE	WIDTH	HEIGHT	SILL HT. LEVEL	LEVEL	TYPE	WIDTH	HEIGHT	SILL HT. LEVEL	LEVEL
D01	2500	2100	-	2100	FIRE DOOR	2500	2100	-	2100
D02	2000	2100	-	2100	TO	2000	2100	-	2100
D03	1500	2100	-	2100	TO	1500	2100	-	2100
D04	1200	2100	-	2100	TO	1200	2100	-	2100
D05	1000	2100	-	2100	TO	1000	2100	-	2100
D06	750	2100	-	2100	TO	750	2100	-	2100
D07	1050	600	1500	2100	TO	1050	600	1500	2100
D08	600	600	1500	2100	TO	600	600	1500	2100
D09	1800	1200	900	2100	TO	1800	1200	900	2100
D10	AS PER PLAN	-	-	2100	SW	AS PER PLAN	-	-	2100
D11	AS PER PLAN	-	-	2100	SW	AS PER PLAN	-	-	2100
D12	AS PER PLAN	-	-	2100	SW	AS PER PLAN	-	-	2100
D13	AS PER PLAN	-	-	2100	SW	AS PER PLAN	-	-	2100

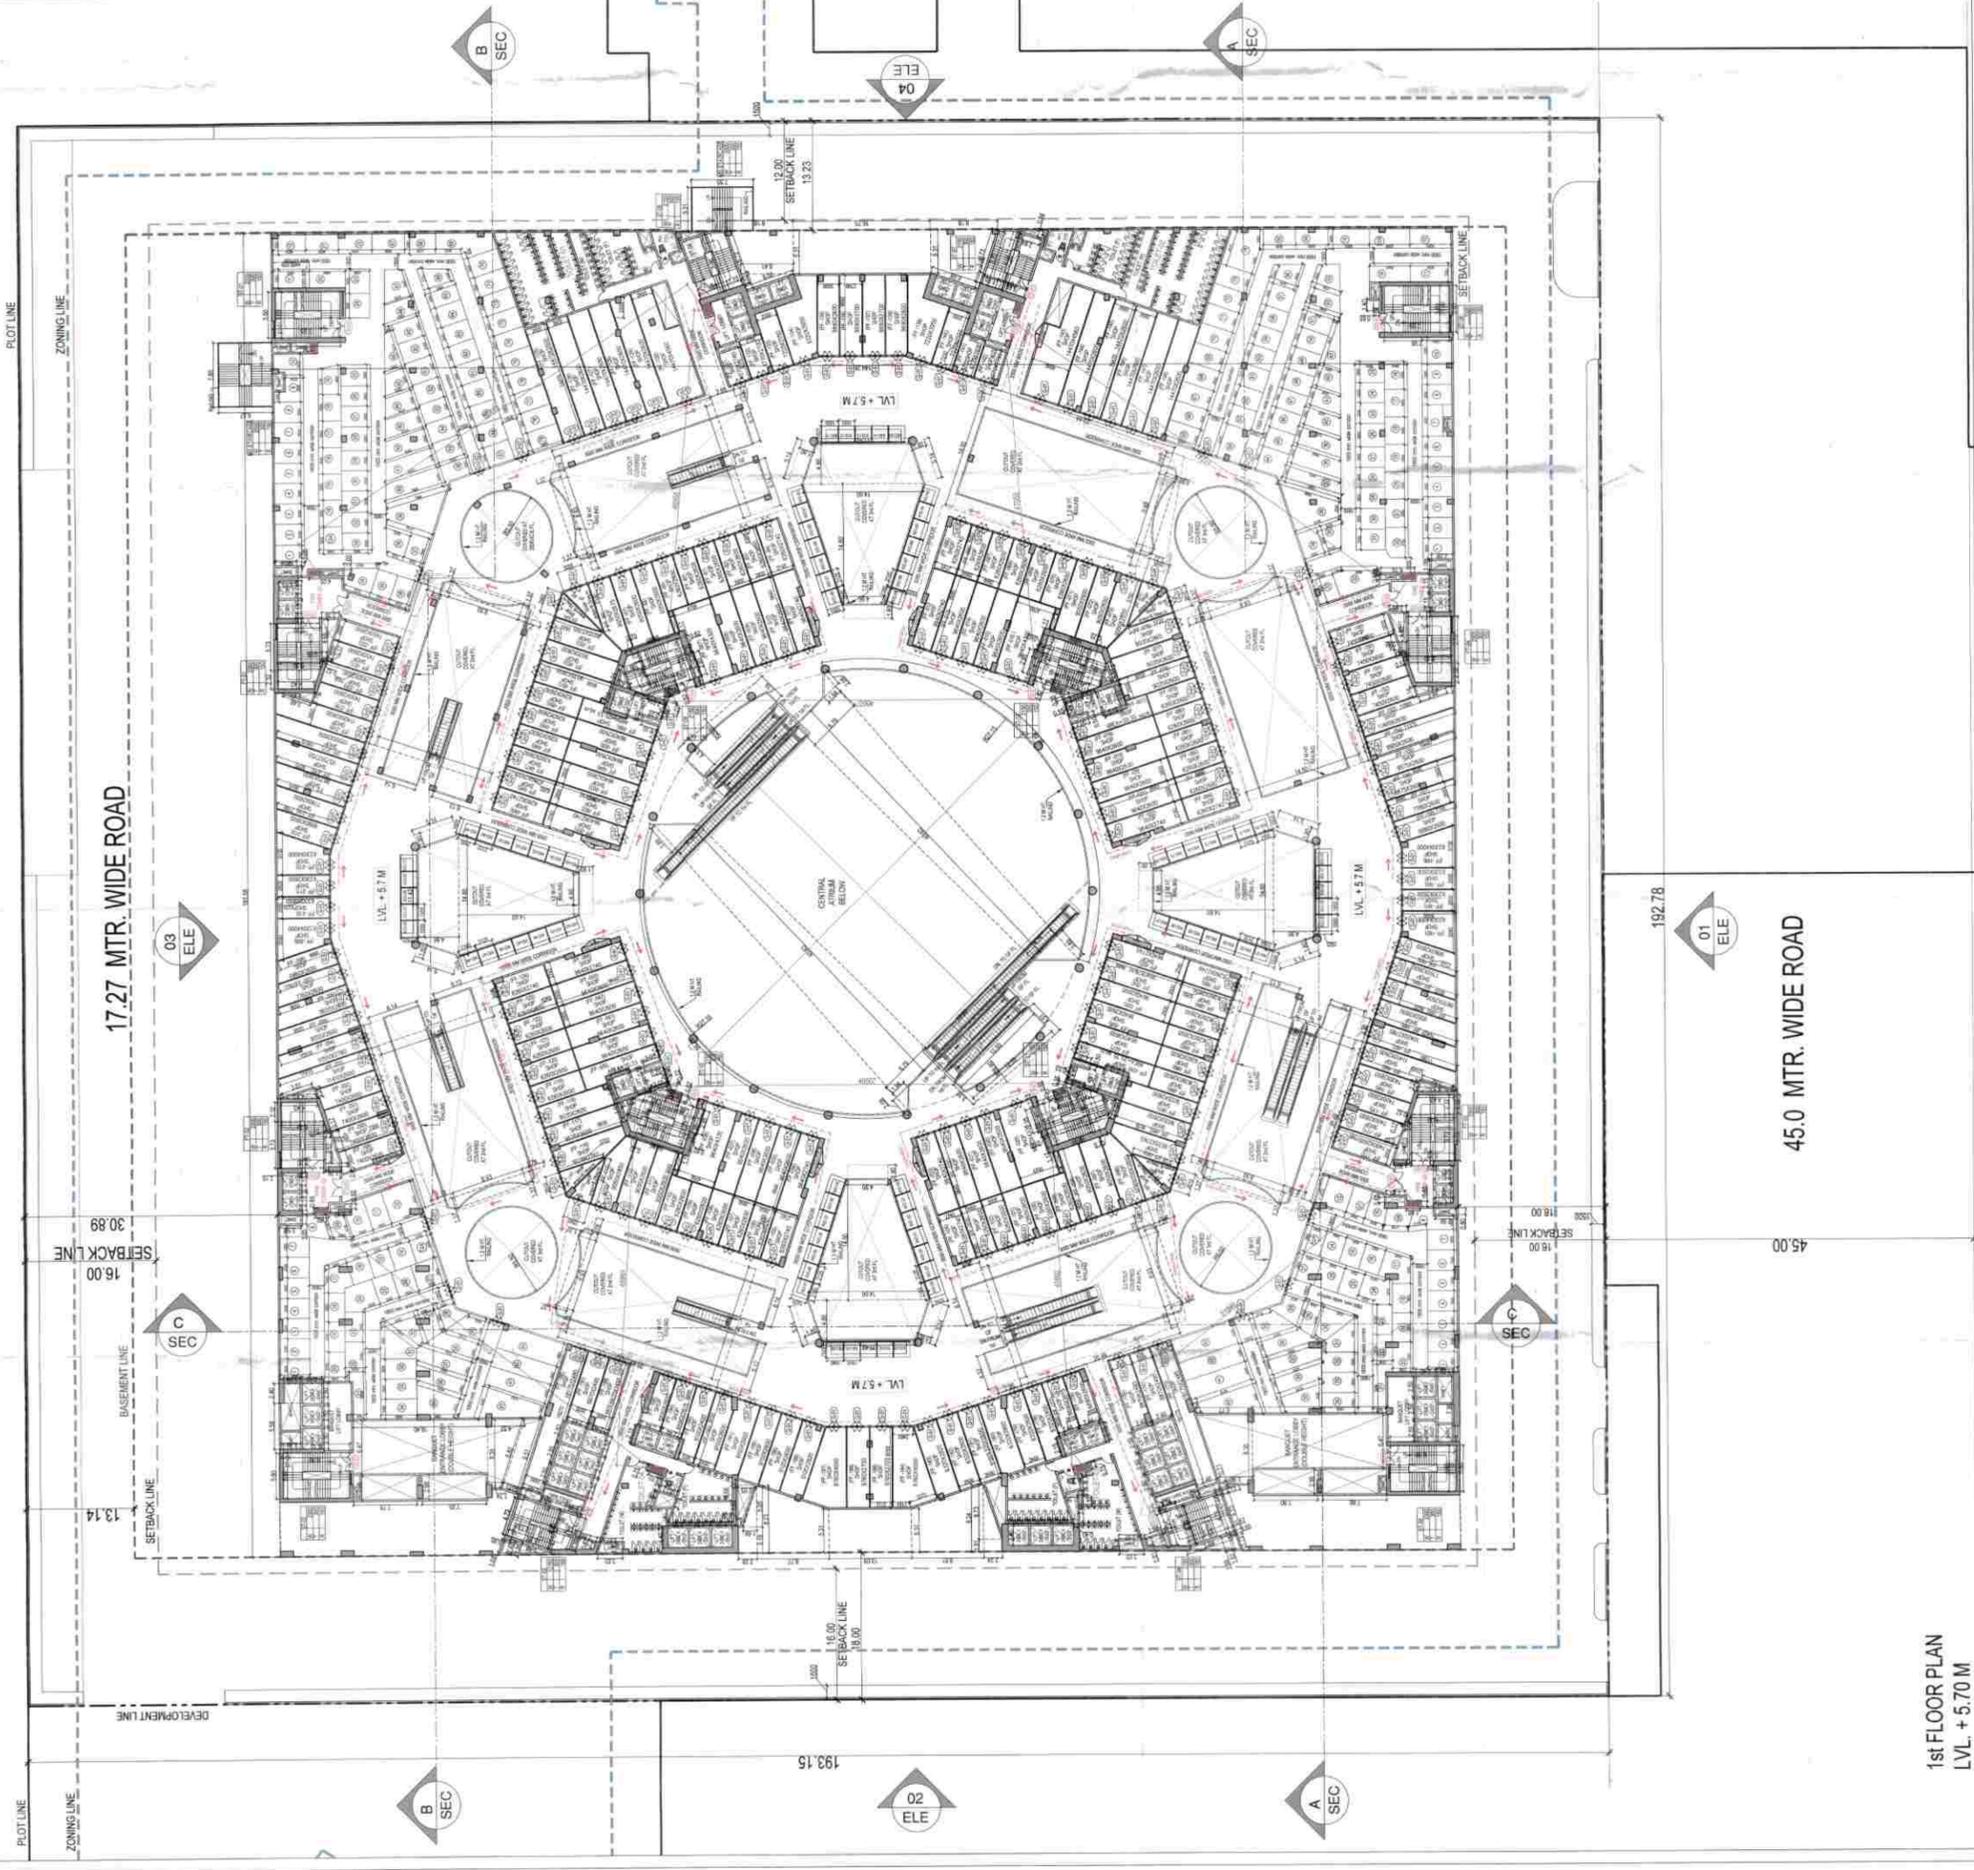

1st FLOOR PLAN  
LVL. +5.70 M





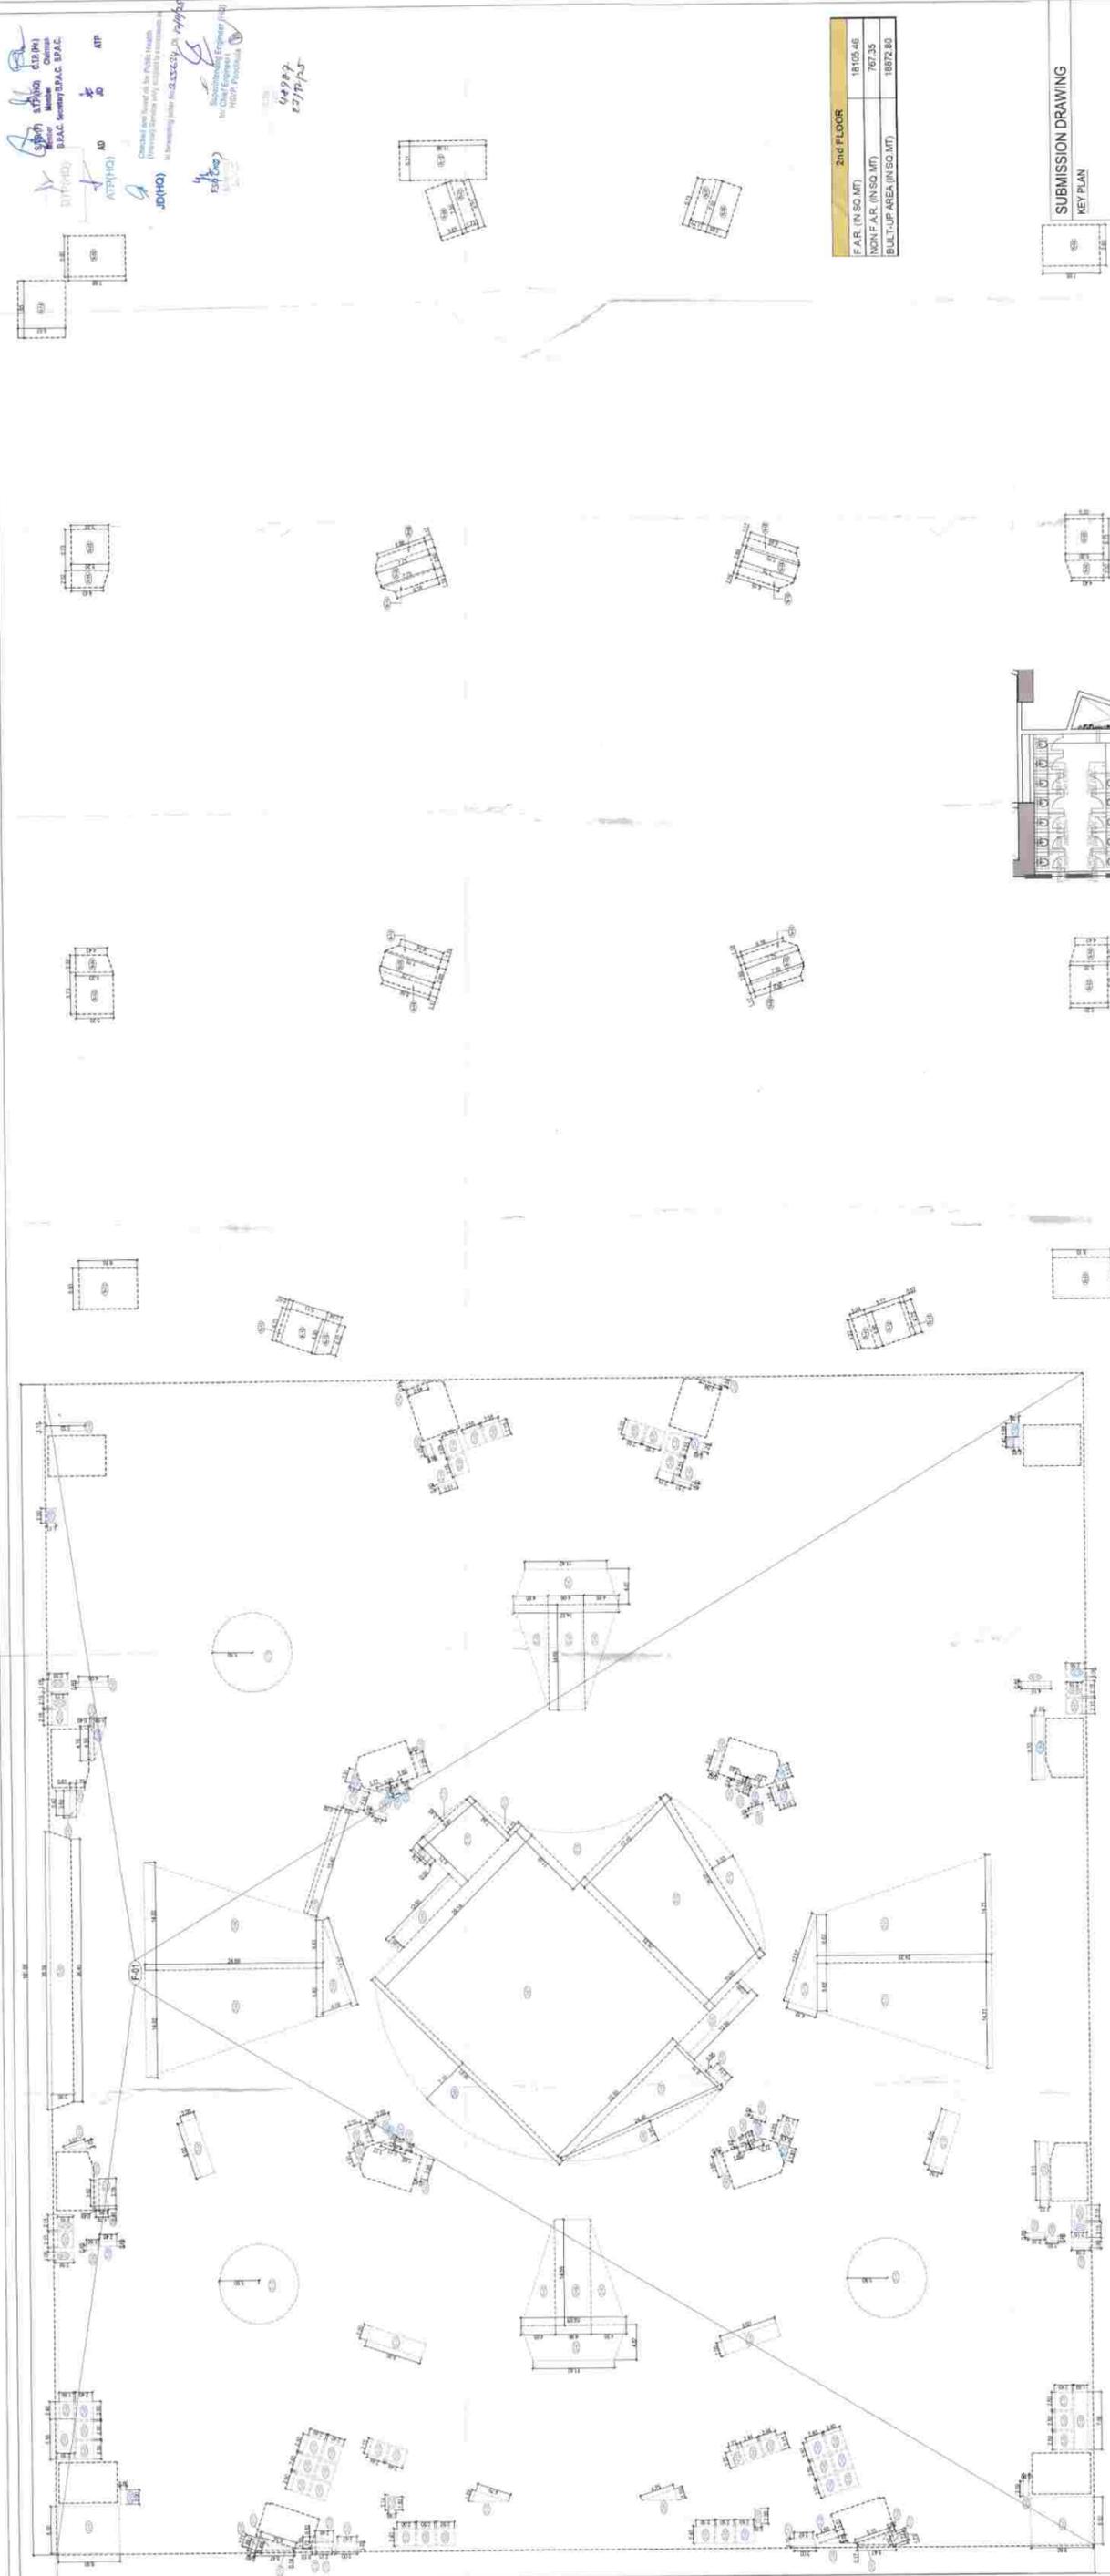


2nd FLOOR	18103.46
FAR (IN SQ.MT)	767.35
NON-FAR (IN SQ.MT)	18103.46
BUILT-UP AREA (IN SQ.MT)	18872.80

**SUBMISSION DRAWING**  
KEY PLAN

THE DEVELOPMENT HAS BEEN CONSIDERED DESIRABLE AND USE OF THE BUILDING IS APPROVED FOR THE PURPOSES OF THE ZONING BY-LAW. THE DEVELOPER SHALL BE RESPONSIBLE FOR OBTAINING ALL NECESSARY PERMITS AND APPROVALS FROM THE RELEVANT AUTHORITIES. THE DEVELOPER SHALL BE RESPONSIBLE FOR OBTAINING ALL NECESSARY PERMITS AND APPROVALS FROM THE RELEVANT AUTHORITIES. THE DEVELOPER SHALL BE RESPONSIBLE FOR OBTAINING ALL NECESSARY PERMITS AND APPROVALS FROM THE RELEVANT AUTHORITIES.

TYPE	WIDTH	HEIGHT	SILL HT.	UNIT	TYPE	WIDTH	HEIGHT	SILL HT.	UNIT
D01	2500	2100	-	2100	FRAME DOOR	2500	2100	-	2100
D02	2000	2100	-	2100	FRAME DOOR	2000	2100	-	2100
D03	1500	2100	-	2100	FRAME DOOR	1500	2100	-	2100
D04	1200	2100	-	2100	FRAME DOOR	1200	2100	-	2100
D05	1000	2100	-	2100	FRAME DOOR	1000	2100	-	2100
D06	750	2100	-	2100	FRAME DOOR	750	2100	-	2100
D07	600	2100	-	2100	FRAME DOOR	600	2100	-	2100
D08	500	2100	-	2100	FRAME DOOR	500	2100	-	2100
D09	400	2100	-	2100	FRAME DOOR	400	2100	-	2100
D10	300	2100	-	2100	FRAME DOOR	300	2100	-	2100
D11	250	2100	-	2100	FRAME DOOR	250	2100	-	2100
D12	200	2100	-	2100	FRAME DOOR	200	2100	-	2100
D13	150	2100	-	2100	FRAME DOOR	150	2100	-	2100
D14	100	2100	-	2100	FRAME DOOR	100	2100	-	2100
D15	75	2100	-	2100	FRAME DOOR	75	2100	-	2100
D16	50	2100	-	2100	FRAME DOOR	50	2100	-	2100
D17	25	2100	-	2100	FRAME DOOR	25	2100	-	2100
D18	15	2100	-	2100	FRAME DOOR	15	2100	-	2100
D19	10	2100	-	2100	FRAME DOOR	10	2100	-	2100
D20	5	2100	-	2100	FRAME DOOR	5	2100	-	2100

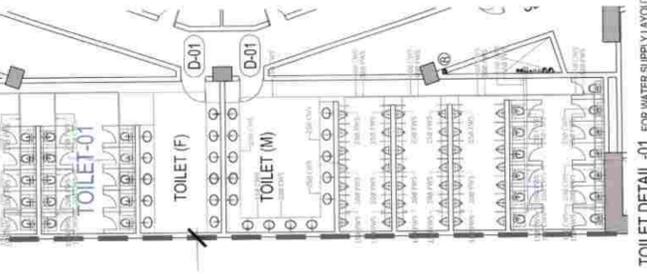

Sl. No.	Room No.	Room Name	Area (sq.m)	Perimeter (m)	Volume (cu.m)
001	001	001	111.90	111.90	111.90
002	002	002	111.90	111.90	111.90
003	003	003	111.90	111.90	111.90
100	100	100	111.90	111.90	111.90

Sl. No.	Room No.	Room Name	Area (sq.m)	Perimeter (m)	Volume (cu.m)
001	001	001	111.90	111.90	111.90
002	002	002	111.90	111.90	111.90
003	003	003	111.90	111.90	111.90
051	051	051	111.90	111.90	111.90
052	052	052	111.90	111.90	111.90</