


SITE DETAIL	
NO. OF FLOORS	1
PLANNING AREA	13.28
PLANNING AREA FOR APPROVED BUILDING PLAN	13.28
A.S. PERMISSIBLE @ 1:75	2077.386
PROPOSED F.A.R.	174.9%
PROPOSED FLOOR AREA	2319.24
PROPOSED GROUND COVERAGE	2319.24
COVERED AREA ON ALL FLOORS	
GROUND FLOOR	2319.24
FIRST FLOOR	2319.24
SECOND FLOOR	2319.24
THIRD FLOOR	2319.24
FOURTH FLOOR	2319.24
FIFTH FLOOR	2319.24
SIXTH FLOOR	2319.24
SEVENTH FLOOR	2319.24
EIGHTH FLOOR	2319.24
GROUND COVERAGE DETAIL	
DESCRIPTION	TOTAL
COVERED AREA ON ALL BASEMENT	2319.24
COVERED AREA ON ALL BASEMENT	2319.24
FIRST BASEMENT	2319.24
SECOND BASEMENT	2319.24
THIRD BASEMENT	2319.24
FOURTH BASEMENT	2319.24
PARKING DETAIL	
1. PARKING TO BE PROVIDED BASED ON PERM F.A.R.	2319.24
TOTAL REQUIRED CAR PARKING @ 25% OF	2319.24
2. AVAILABLE PARKING TO BE PROVIDED @ 25% OF	2319.24
TOTAL AVAILABLE CAR PARKING @ 25% OF	2319.24
3. SHORTAGE OF CAR PARKING @	2319.24
4. OVERABUNDANCE OF CAR PARKING @	2319.24
5. TOTAL NO. OF CARS PROPOSED @ 25% OF COVERED AREA = 2319.24	

NOTE:
 1. FLOOR AREA = 2319.24 Sqm
 Total covered area of basement = 2319.24 Sqm
 = 2319.24 x 0.25 = 579.81 Sqm
 = 579.81 x 2 = 1159.62 Sqm



LEGEND	LEGEND
(1) 100# SOIL & VENT PIPE	(C) CATCH BASIN (SEE DRAWING)
(2) 100# SOIL & VENT PIPE	(RC) (RC) PIPE
(3) 150# SOIL & VENT PIPE	(S) 150# SPRINKLER PIPE
(4) 150# WASTE & VENT PIPE	(W) 150# WATER SUPPLY PIPE
(5) 75# ANTI SIPHON PIPE	(A) 4.5M DEPTH
(6) 50# COLD WATER SUPPLY	(B) 4.5M DEPTH
(7) 50# COLD WATER RISER	(C) 4.5M DEPTH
(8) 50# SOFT WATER RISER	(D) 4.5M DEPTH
(9) 150# SPRINKLER PIPE FOR 2ND BASEMENT	(E) 4.5M DEPTH
(10) 150# SPRINKLER PIPE FOR 3RD BASEMENT	(F) 4.5M DEPTH
(11) 150# SPRINKLER PIPE FOR 4TH BASEMENT	(G) 4.5M DEPTH
(12) 100# RAIN WATER PIPE FOR BASEMENT	(H) 4.5M DEPTH
(13) 200# RAIN WATER PIPE FOR BASEMENT	(I) 4.5M DEPTH
(14) 150# SPRINKLER PIPE FOR 5TH BASEMENT	(J) 4.5M DEPTH
(15) 150# SPRINKLER PIPE FOR 6TH BASEMENT	(K) 4.5M DEPTH
(16) 150# SPRINKLER PIPE FOR 7TH BASEMENT	(L) 4.5M DEPTH
(17) 150# SPRINKLER PIPE FOR 8TH BASEMENT	(M) 4.5M DEPTH
(18) 150# SPRINKLER PIPE FOR 9TH BASEMENT	(N) 4.5M DEPTH
(19) 150# SPRINKLER PIPE FOR 10TH BASEMENT	(O) 4.5M DEPTH
(20) 150# SPRINKLER PIPE FOR 11TH BASEMENT	(P) 4.5M DEPTH
(21) 150# SPRINKLER PIPE FOR 12TH BASEMENT	(Q) 4.5M DEPTH
(22) 150# SPRINKLER PIPE FOR 13TH BASEMENT	(R) 4.5M DEPTH
(23) 150# SPRINKLER PIPE FOR 14TH BASEMENT	(S) 4.5M DEPTH
(24) 150# SPRINKLER PIPE FOR 15TH BASEMENT	(T) 4.5M DEPTH
(25) 150# SPRINKLER PIPE FOR 16TH BASEMENT	(U) 4.5M DEPTH
(26) 150# SPRINKLER PIPE FOR 17TH BASEMENT	(V) 4.5M DEPTH
(27) 150# SPRINKLER PIPE FOR 18TH BASEMENT	(W) 4.5M DEPTH
(28) 150# SPRINKLER PIPE FOR 19TH BASEMENT	(X) 4.5M DEPTH
(29) 150# SPRINKLER PIPE FOR 20TH BASEMENT	(Y) 4.5M DEPTH
(30) 150# SPRINKLER PIPE FOR 21ST BASEMENT	(Z) 4.5M DEPTH
(31) 150# SPRINKLER PIPE FOR 22ND BASEMENT	(AA) 4.5M DEPTH
(32) 150# SPRINKLER PIPE FOR 23RD BASEMENT	(AB) 4.5M DEPTH
(33) 150# SPRINKLER PIPE FOR 24TH BASEMENT	(AC) 4.5M DEPTH
(34) 150# SPRINKLER PIPE FOR 25TH BASEMENT	(AD) 4.5M DEPTH
(35) 150# SPRINKLER PIPE FOR 26TH BASEMENT	(AE) 4.5M DEPTH
(36) 150# SPRINKLER PIPE FOR 27TH BASEMENT	(AF) 4.5M DEPTH
(37) 150# SPRINKLER PIPE FOR 28TH BASEMENT	(AG) 4.5M DEPTH
(38) 150# SPRINKLER PIPE FOR 29TH BASEMENT	(AH) 4.5M DEPTH
(39) 150# SPRINKLER PIPE FOR 30TH BASEMENT	(AI) 4.5M DEPTH
(40) 150# SPRINKLER PIPE FOR 31ST BASEMENT	(AJ) 4.5M DEPTH
(41) 150# SPRINKLER PIPE FOR 32ND BASEMENT	(AK) 4.5M DEPTH
(42) 150# SPRINKLER PIPE FOR 33RD BASEMENT	(AL) 4.5M DEPTH
(43) 150# SPRINKLER PIPE FOR 34TH BASEMENT	(AM) 4.5M DEPTH
(44) 150# SPRINKLER PIPE FOR 35TH BASEMENT	(AN) 4.5M DEPTH
(45) 150# SPRINKLER PIPE FOR 36TH BASEMENT	(AO) 4.5M DEPTH
(46) 150# SPRINKLER PIPE FOR 37TH BASEMENT	(AP) 4.5M DEPTH
(47) 150# SPRINKLER PIPE FOR 38TH BASEMENT	(AQ) 4.5M DEPTH
(48) 150# SPRINKLER PIPE FOR 39TH BASEMENT	(AR) 4.5M DEPTH
(49) 150# SPRINKLER PIPE FOR 40TH BASEMENT	(AS) 4.5M DEPTH
(50) 150# SPRINKLER PIPE FOR 41ST BASEMENT	(AT) 4.5M DEPTH
(51) 150# SPRINKLER PIPE FOR 42ND BASEMENT	(AU) 4.5M DEPTH
(52) 150# SPRINKLER PIPE FOR 43RD BASEMENT	(AV) 4.5M DEPTH
(53) 150# SPRINKLER PIPE FOR 44TH BASEMENT	(AW) 4.5M DEPTH
(54) 150# SPRINKLER PIPE FOR 45TH BASEMENT	(AX) 4.5M DEPTH
(55) 150# SPRINKLER PIPE FOR 46TH BASEMENT	(AY) 4.5M DEPTH
(56) 150# SPRINKLER PIPE FOR 47TH BASEMENT	(AZ) 4.5M DEPTH
(57) 150# SPRINKLER PIPE FOR 48TH BASEMENT	(BA) 4.5M DEPTH
(58) 150# SPRINKLER PIPE FOR 49TH BASEMENT	(BB) 4.5M DEPTH
(59) 150# SPRINKLER PIPE FOR 50TH BASEMENT	(BC) 4.5M DEPTH
(60) 150# SPRINKLER PIPE FOR 51ST BASEMENT	(BD) 4.5M DEPTH
(61) 150# SPRINKLER PIPE FOR 52ND BASEMENT	(BE) 4.5M DEPTH
(62) 150# SPRINKLER PIPE FOR 53RD BASEMENT	(BF) 4.5M DEPTH
(63) 150# SPRINKLER PIPE FOR 54TH BASEMENT	(BG) 4.5M DEPTH
(64) 150# SPRINKLER PIPE FOR 55TH BASEMENT	(BH) 4.5M DEPTH
(65) 150# SPRINKLER PIPE FOR 56TH BASEMENT	(BI) 4.5M DEPTH
(66) 150# SPRINKLER PIPE FOR 57TH BASEMENT	(BJ) 4.5M DEPTH
(67) 150# SPRINKLER PIPE FOR 58TH BASEMENT	(BK) 4.5M DEPTH
(68) 150# SPRINKLER PIPE FOR 59TH BASEMENT	(BL) 4.5M DEPTH
(69) 150# SPRINKLER PIPE FOR 60TH BASEMENT	(BM) 4.5M DEPTH
(70) 150# SPRINKLER PIPE FOR 61ST BASEMENT	(BN) 4.5M DEPTH
(71) 150# SPRINKLER PIPE FOR 62ND BASEMENT	(BO) 4.5M DEPTH
(72) 150# SPRINKLER PIPE FOR 63RD BASEMENT	(BP) 4.5M DEPTH
(73) 150# SPRINKLER PIPE FOR 64TH BASEMENT	(BQ) 4.5M DEPTH
(74) 150# SPRINKLER PIPE FOR 65TH BASEMENT	(BR) 4.5M DEPTH
(75) 150# SPRINKLER PIPE FOR 66TH BASEMENT	(BS) 4.5M DEPTH
(76) 150# SPRINKLER PIPE FOR 67TH BASEMENT	(BT) 4.5M DEPTH
(77) 150# SPRINKLER PIPE FOR 68TH BASEMENT	(BU) 4.5M DEPTH
(78) 150# SPRINKLER PIPE FOR 69TH BASEMENT	(BV) 4.5M DEPTH
(79) 150# SPRINKLER PIPE FOR 70TH BASEMENT	(BW) 4.5M DEPTH
(80) 150# SPRINKLER PIPE FOR 71ST BASEMENT	(BX) 4.5M DEPTH
(81) 150# SPRINKLER PIPE FOR 72ND BASEMENT	(BY) 4.5M DEPTH
(82) 150# SPRINKLER PIPE FOR 73RD BASEMENT	(BZ) 4.5M DEPTH
(83) 150# SPRINKLER PIPE FOR 74TH BASEMENT	(CA) 4.5M DEPTH
(84) 150# SPRINKLER PIPE FOR 75TH BASEMENT	(CB) 4.5M DEPTH
(85) 150# SPRINKLER PIPE FOR 76TH BASEMENT	(CC) 4.5M DEPTH
(86) 150# SPRINKLER PIPE FOR 77TH BASEMENT	(CD) 4.5M DEPTH
(87) 150# SPRINKLER PIPE FOR 78TH BASEMENT	(CE) 4.5M DEPTH
(88) 150# SPRINKLER PIPE FOR 79TH BASEMENT	(CF) 4.5M DEPTH
(89) 150# SPRINKLER PIPE FOR 80TH BASEMENT	(CG) 4.5M DEPTH
(90) 150# SPRINKLER PIPE FOR 81ST BASEMENT	(CH) 4.5M DEPTH
(91) 150# SPRINKLER PIPE FOR 82ND BASEMENT	(CI) 4.5M DEPTH
(92) 150# SPRINKLER PIPE FOR 83RD BASEMENT	(CJ) 4.5M DEPTH
(93) 150# SPRINKLER PIPE FOR 84TH BASEMENT	(CK) 4.5M DEPTH
(94) 150# SPRINKLER PIPE FOR 85TH BASEMENT	(CL) 4.5M DEPTH
(95) 150# SPRINKLER PIPE FOR 86TH BASEMENT	(CM) 4.5M DEPTH
(96) 150# SPRINKLER PIPE FOR 87TH BASEMENT	(CN) 4.5M DEPTH
(97) 150# SPRINKLER PIPE FOR 88TH BASEMENT	(CO) 4.5M DEPTH
(98) 150# SPRINKLER PIPE FOR 89TH BASEMENT	(CP) 4.5M DEPTH
(99) 150# SPRINKLER PIPE FOR 90TH BASEMENT	(CQ) 4.5M DEPTH
(100) 150# SPRINKLER PIPE FOR 91ST BASEMENT	(CR) 4.5M DEPTH

LEGEND
 100# SOIL & VENT PIPE
 150# SOIL & VENT PIPE
 150# WASTE & VENT PIPE
 75# ANTI SIPHON PIPE
 50# COLD WATER SUPPLY
 50# COLD WATER RISER
 50# SOFT WATER RISER
 150# SPRINKLER PIPE FOR 2ND BASEMENT
 150# SPRINKLER PIPE FOR 3RD BASEMENT
 150# SPRINKLER PIPE FOR 4TH BASEMENT
 100# RAIN WATER PIPE FOR BASEMENT
 200# RAIN WATER PIPE FOR BASEMENT

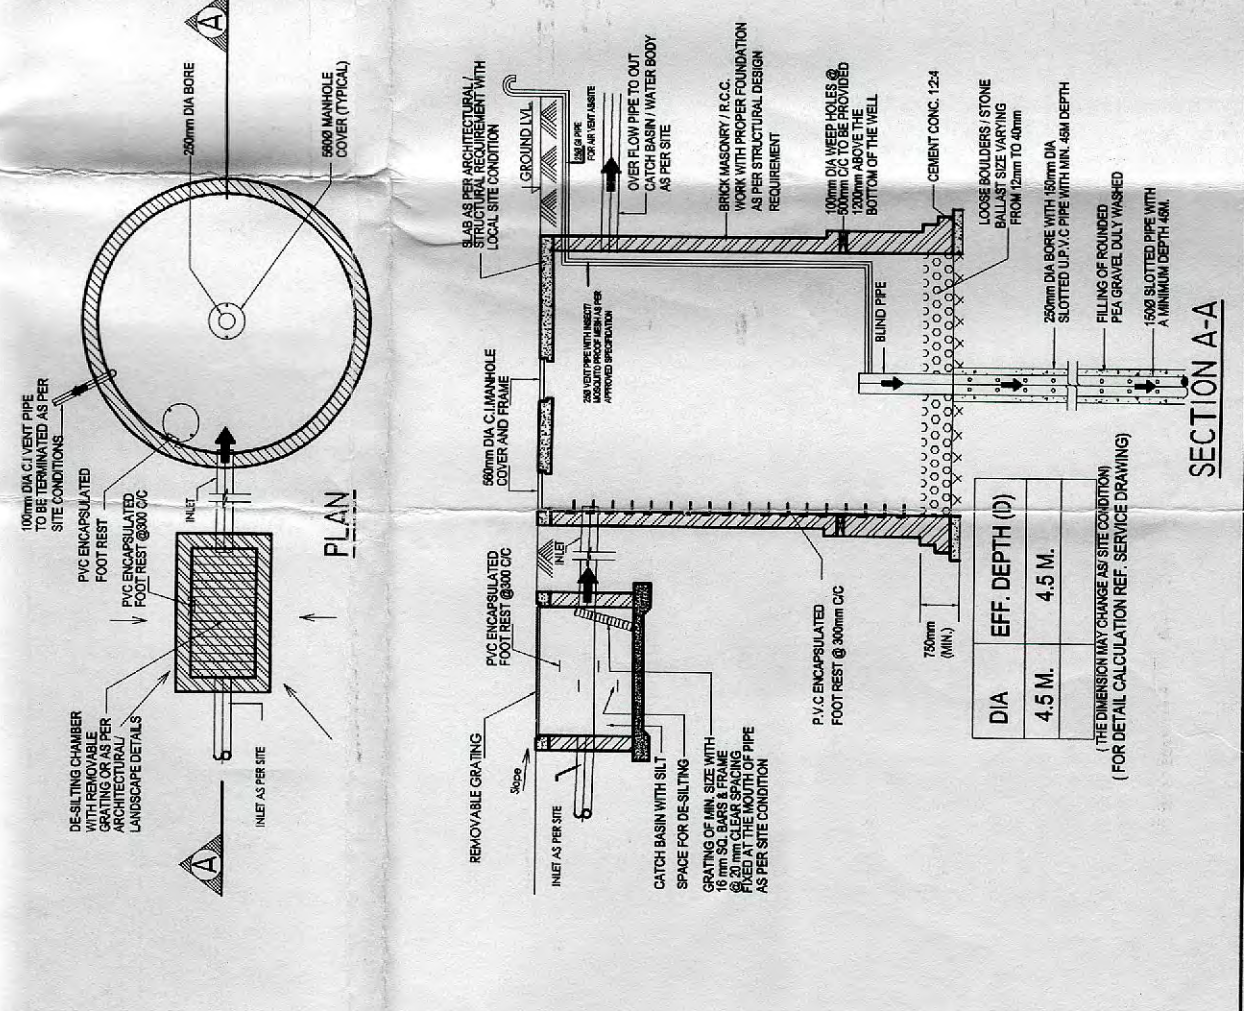

SITE PLAN

NOTE:
 A) THE ENTIRE BUILDING SHALL BE PROVIDED WITH A CENTRALIZED AIR CONDITIONING SYSTEM & 100% POWER BACKUP
 B) ALL BUILDING IS MACHINICALLY VENTILATED AND FULLY SPRINKLERED
 C) GATE & B.WALL AS STD DESIGN

PROPOSED BUILDING PLAN OF COMMERCIAL COLONY ON 13.28 PLANNING AREA AT 1:75 SCALE, DATED 27-02-2012, SECTION 30, DIST - FARGHAWA BEING DEVELOPED BY SHREEJI BUILDWELL PVT. LTD.

SCALE: 1 : 200

SHEET NO. 1

ARCHITECT'S SIGN: [Signature]

ARCHITECT'S NAME: Sachdeva Consultants

OWNER/AUTH. SIGN: [Signature]

OWNER/AUTH. NAME: PARVATI TOWER 3RD FLOOR, S.C.O. 8511 OLD JODHAJI COMPLEX, FARGHAWA, RAJ. 341001