



**15TH FLOOR DEDUCTION AREA DIAGRAM**  
(SCALE:- 1:200)

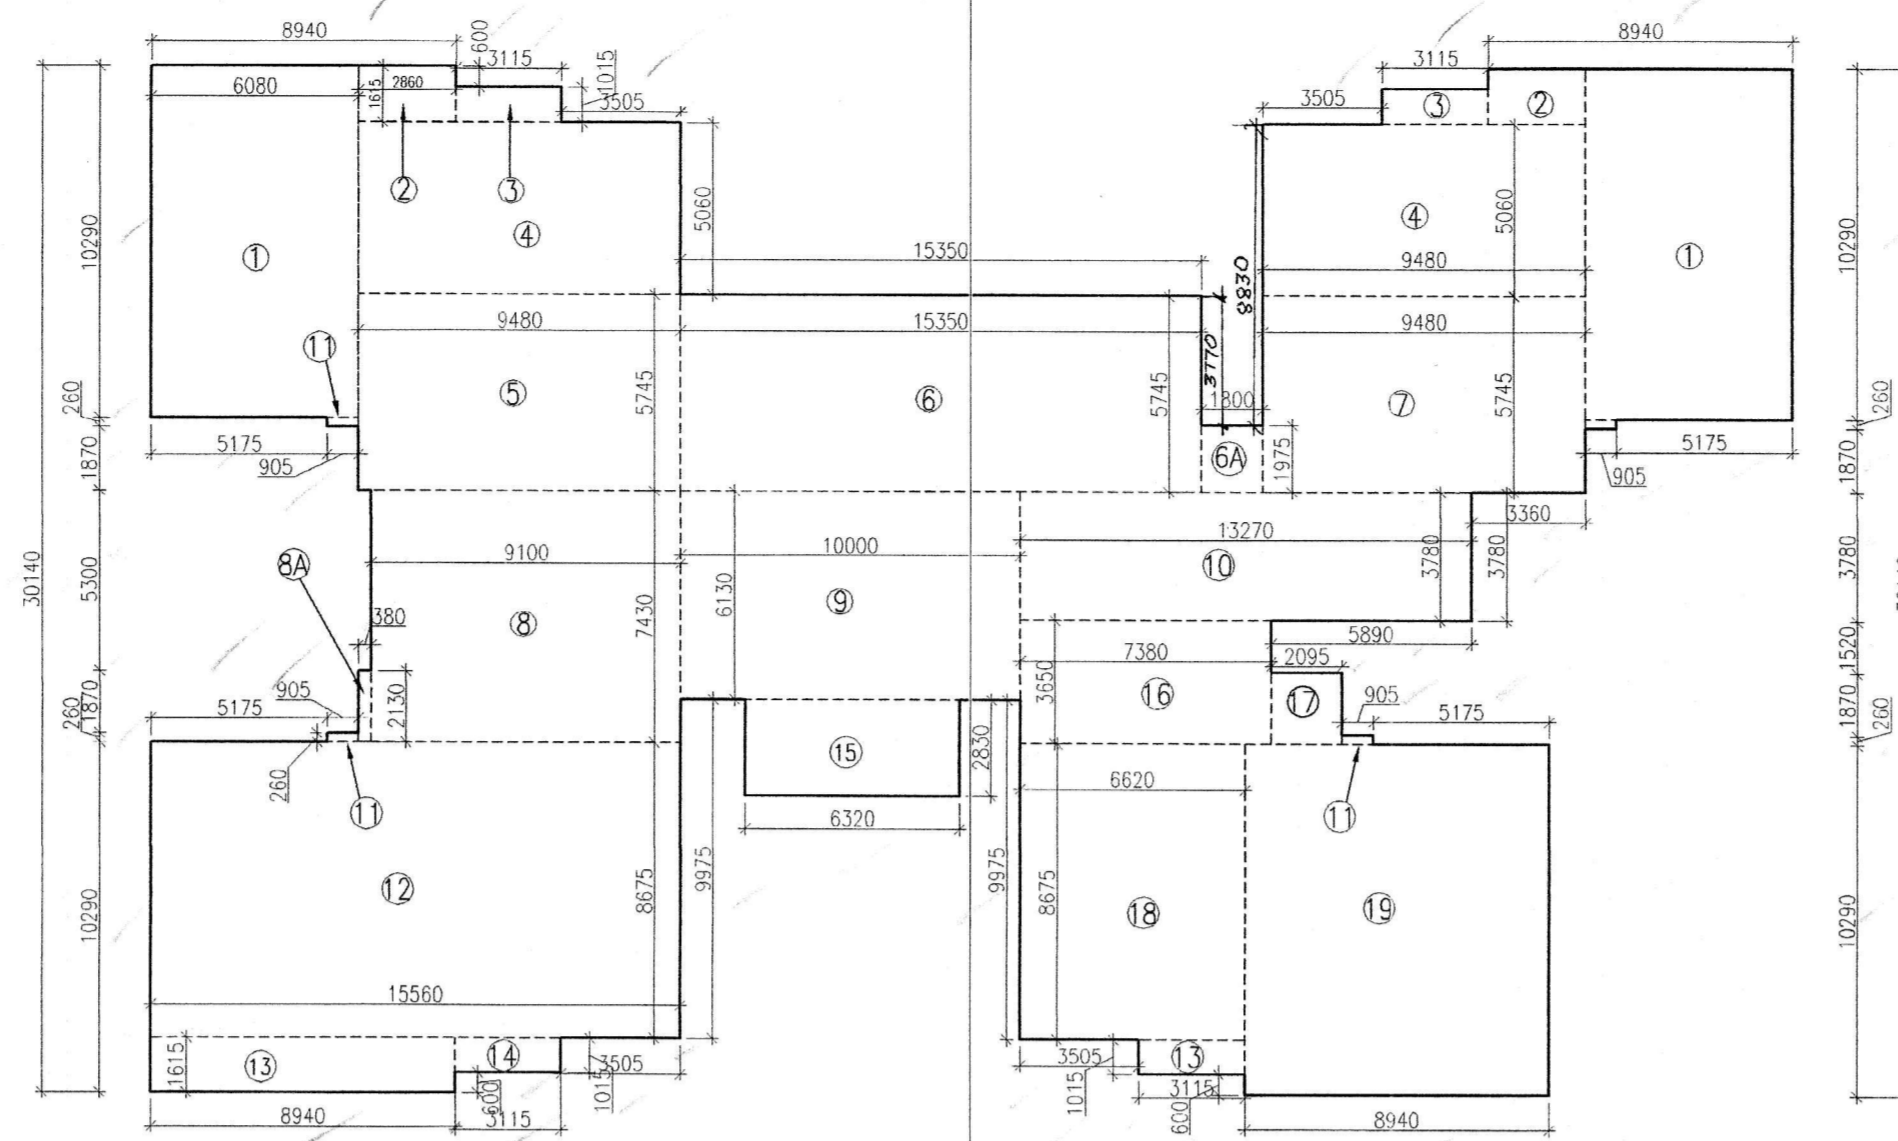

**15TH FLOOR AREA DIAGRAM**  
(SCALE:- 1:200)

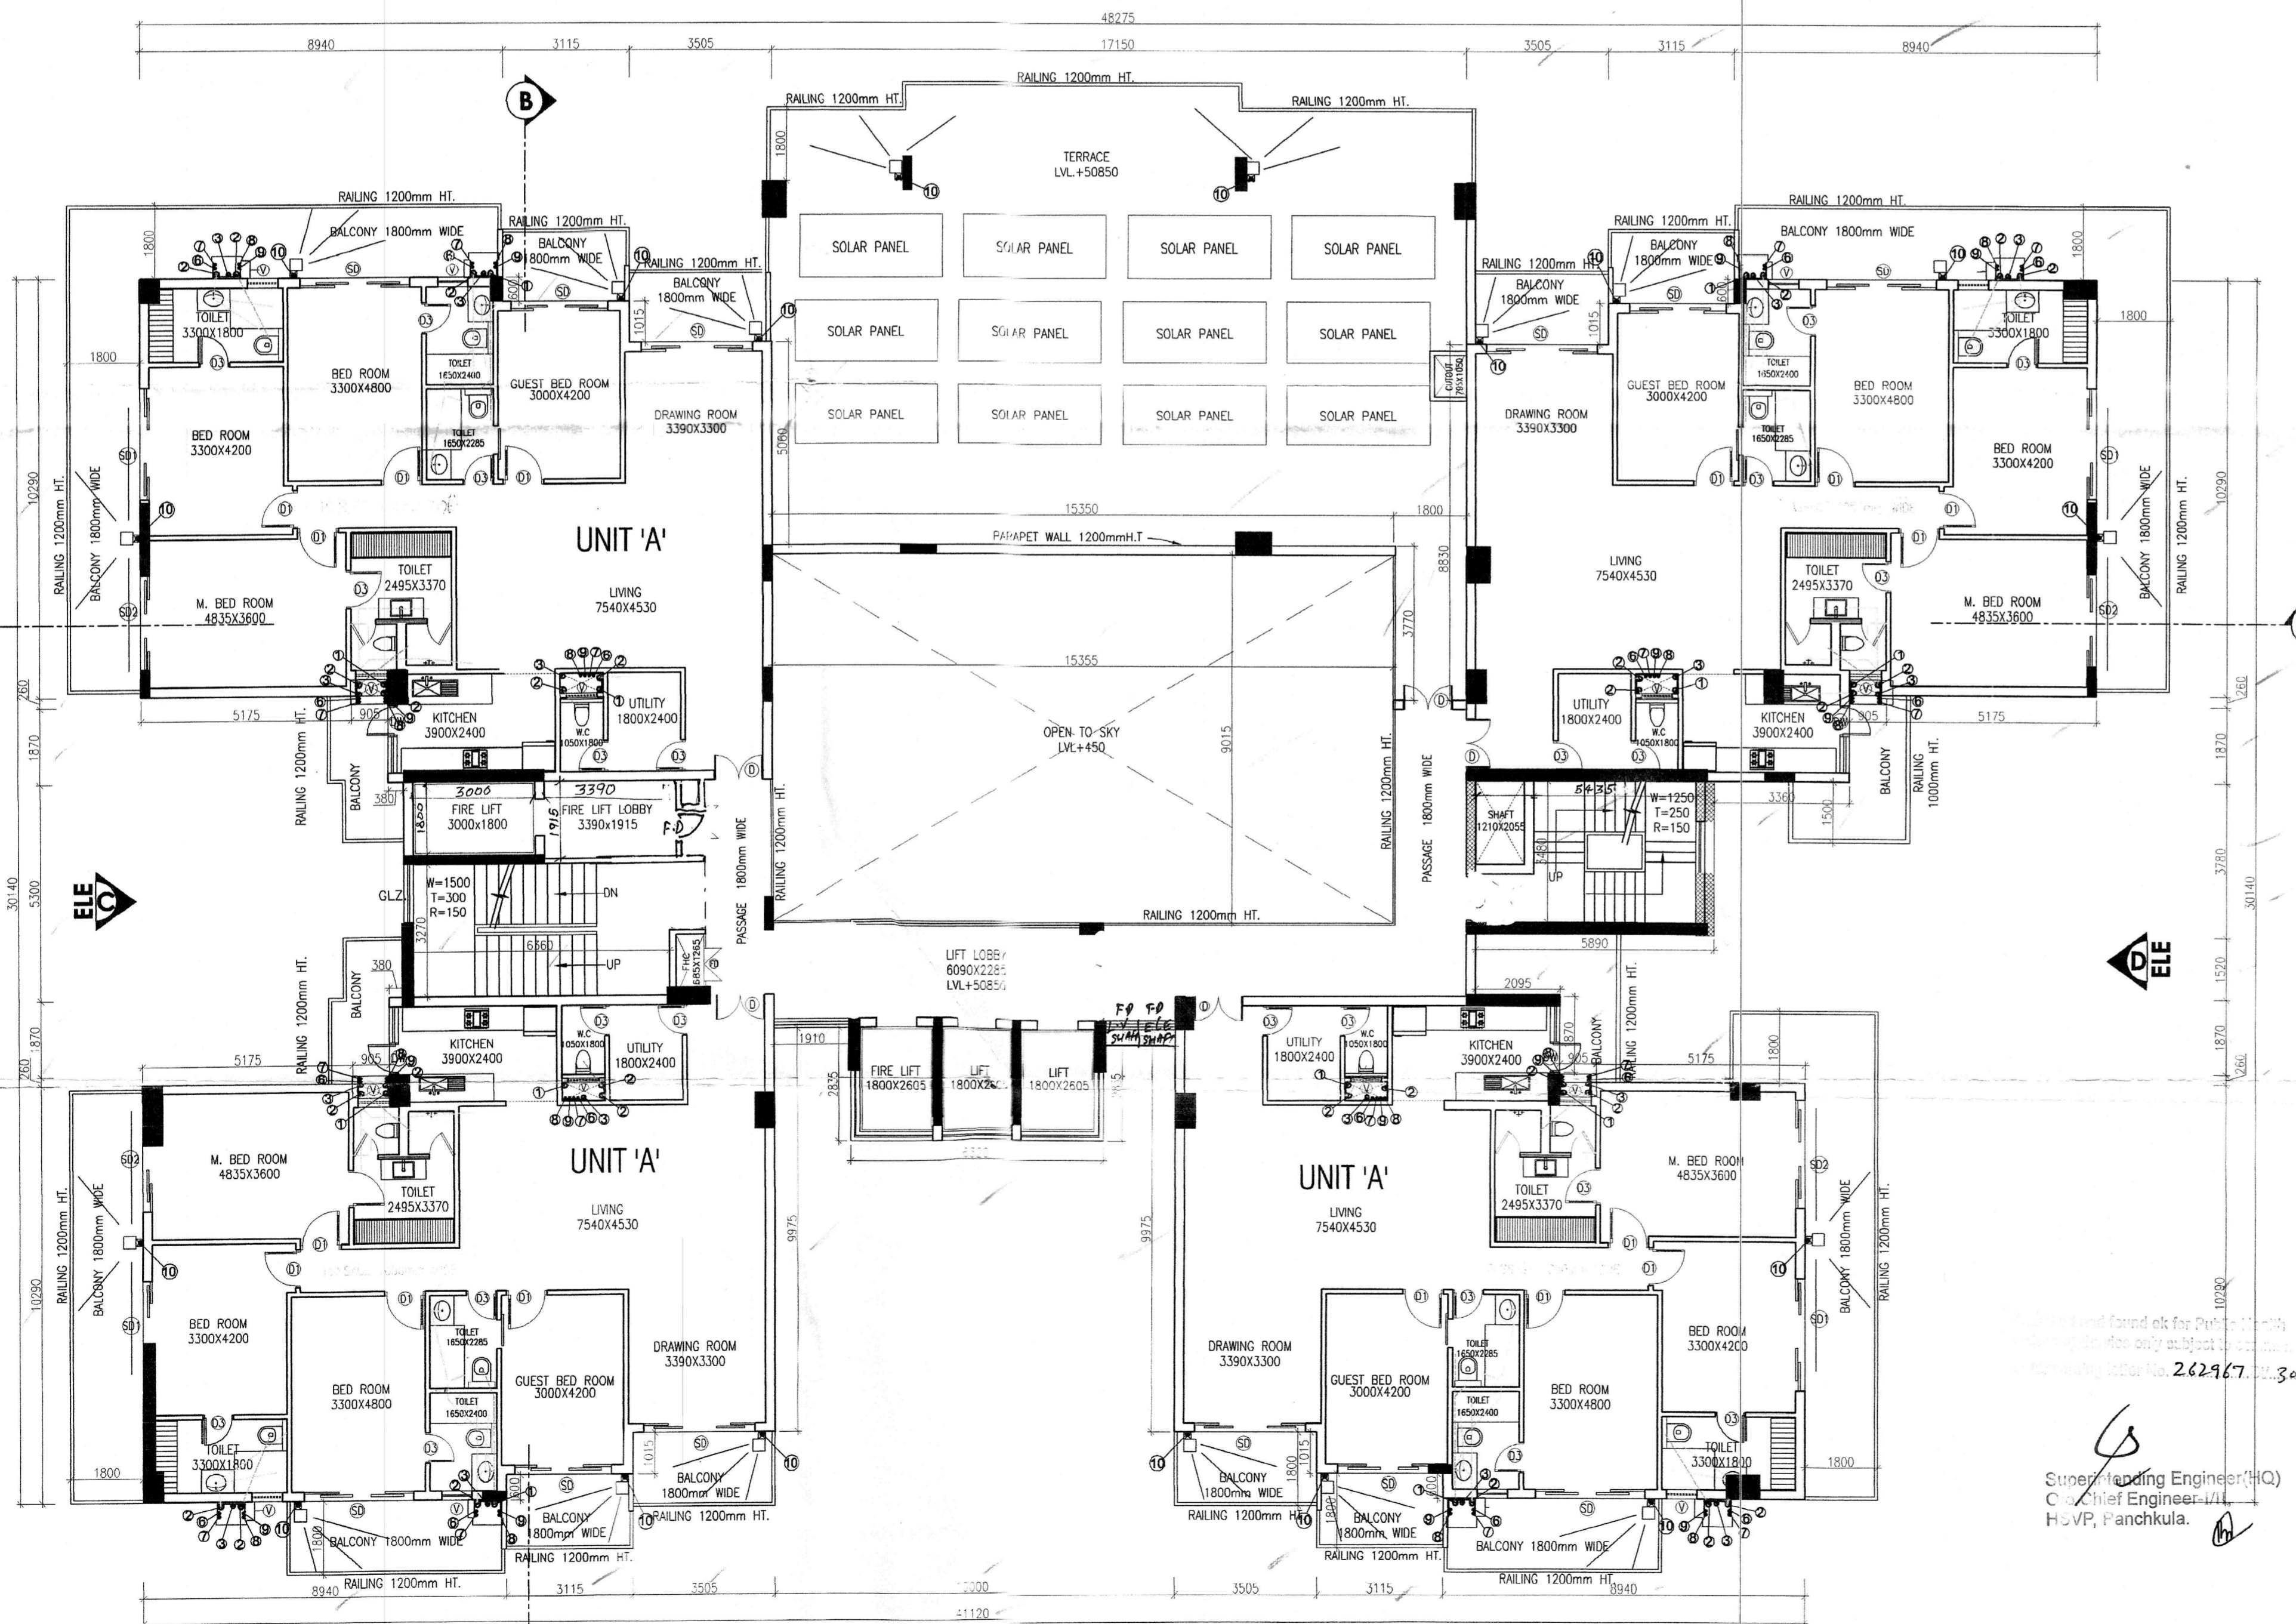

**15TH FLOOR PLAN**

**15 TH FLOOR AREA CALCULATIONS**

NO.	COEFF.	BREADTH	LENGTH	NO.s	AREA (SQ.M)
<b>ADDITIONS</b>					
1	1	6.080	10.290	2	125.126
2	1	2.860	1.615	2	9.238
3	1	3.115	1.015	2	6.323
4	1	9.480	5.060	2	95.938
5	1	9.480	5.745	1	54.463
6	1	15.350	5.745	1	88.186
6A	1	1.800	1.975	1	3.555
7	1	9.480	5.745	1	54.463
8	1	9.100	7.430	1	67.613
8A	1	0.380	2.130	1	0.809
9	1	10.000	6.130	1	61.300
10	1	13.270	3.780	1	50.161
11	1	0.910	0.260	4	0.946
12	1	15.560	8.675	1	134.983
13	1	8.940	1.615	1	14.438
14	1	3.115	1.015	2	6.323
15	1	6.320	2.830	1	17.886
16	1	7.380	3.650	1	26.937
17	1	2.095	2.130	1	4.462
18	1	6.620	8.675	1	57.429
19	1	8.940	10.290	1	91.993
<b>TOTAL ADDITIONS (A1)</b>					<b>972.571</b>
<b>DEDUCTIONS</b>					
D1	1	0.785	0.600	4	1.884
D2	1	1.050	0.635	4	2.667
D3	1	3.230	1.800	1	5.814
D3A	1	3.390	1.915	1	6.492
D3B	1	3.270	6.285	1	20.552
D4	1	0.335	1.915	1	0.642
D5	1	0.685	1.265	1	0.867
D6	1	15.355	9.015	1	138.425
D7	1	5.435	3.480	1	18.914
D8	1	1.800	2.605	3	14.067
<b>TOTAL DEDUCTIONS (B1)</b>					<b>210.323</b>
<b>NET FAR = (A1 - B1)</b>					<b>762.248</b>

Superintending Engineer (H.O.)  
Chief Engineer (H.O.)  
H.O.V.P, Panchkula.

NOTE:-  
BUILDING BLOCK ARE MECHANICALLY VENTILATED  
FULLY AIR CONDITIONED WITH 100 % POWER BACK UP

**SANCTIONED**  
Vide Memo No. 2.7.11.7.6 Dated. 11.11.2011

DTP (HQ) Member Secretary BPAC  
STP (H) Member BPAC  
CTP (H) Chairman BPAC

Suraj Bhan J.D.

J.D. (H) DTP (H) STP (H) MEMBER B.P.A.C.

DTP (H) Member BPAC

SYMBOL	DESCRIPTION
①	1000 BOIL & VENT PIPE
②	1000 RAINFALL & DRAIN PIPE
③	750 ANTISYPHONAGE PIPE
④	DWS RISER TO OHT (DOMESTIC WATER)
⑤	FWS RISER TO OHT (FLUSHING WATER)
⑥	DWS DN TAKE FOR GR TO 8th FLOOR
⑦	DWS DN TAKE FOR FOR 7th TO 13th FLOOR
⑧	DWS DN TAKE FOR FOR 14th TO 15th FLOOR (HYDRO SYSTEM)
⑨	FWS DN TAKE FOR FLUSHING SYSTEM
⑩	90 OD UPVC SWR RAIN WATER PIPE FOR BALCONY
⑪	110 OD UPVC SWR RAIN WATER PIPE FOR TERRACE
⑫	1500 MS FIRE PIPE
⑬	1500 MS SPRINKLER PIPE
⑭	800 SPRINKLER DRAIN PIPE

SCHEDULE OF OPENING					
S.R	TYPE	SIZE	S.L.	LL.	
1	FD	1800 X 2400	00	2400	
2	D	1200 X 2400	00	2400	
3	D1	1000 X 2400	00	2400	
4	D2	750 X 2400	00	2400	
5	SD	2900 X 2400	00	2400	
6	SD1	2800 X 2400	00	2400	
7	SD2	2550 X 2400	00	2400	
8	SD3	2440 X 2400	00	2400	
9	SD4	750 X 2400	00	2400	
10	W	1900 X 1500	900	2400	
11	W1	1250 X 1500	900	2400	
12	V	750 X 900	1500	2400	
13	V1	550 X 900	1500	2400	
14	V2	550 X 900	1500	2400	
15	GLZ.	AS PER SITE			

**PROJECT :-**  
**PROPOSED BUILDING PLAN OF GROUP HOUSING SITE NO. GH26A, IN SECTOR-56, AREA MEASURING - 0.85 ACRE, URBAN ESTATE GURUGRAM - II BELONGINGS TO - M/S MNB BUILD FAB PVT. LTD. TH. PARTNER MR. MOHIT BAJAJ S/o MR. CHANDER BHUSHAN BAJAJ**

**ARCHITECTS :-**  
**SACHDEVA CONSULTANTS.**  
Parmani Tower, 3rd Floor, S.C.O. 50-51, Old Judicial Complex, Civil Lines, Gurgaon - 122001  
Tel.: 0124-4081801, 4081802  
email : saccon1953@gmail.com

ARCHITECT'S SEAL & SIGNATURE  
OWNER'S SEAL & SIGNATURE

Scale : 1:100  
Drawing Title:- **15TH FLOOR PLAN & AREA CALCULATION**  
Drawing No:- **10**