



PHASE	AREA	TOWER
PHASE-1	1.961 Acres	2, 3 & 4
PHASE-2	1.4211 Acres	1
PHASE-3	2.832 Acres	COMMERCIAL
PHASE-4	0.925 Acres	5
PHASE-5	0.616 Acres	--
PHASE-6	0.686 Acres	--
PHASE-7	1.14015 Acres	EWS & N.S.

S.NO.	DESCRIPTION	SYMBOL
1	DOMESTIC WATER LINE	
2	100% TANKER LINE	
3	100% MUNICIPAL LINE	
4	WATER METER	

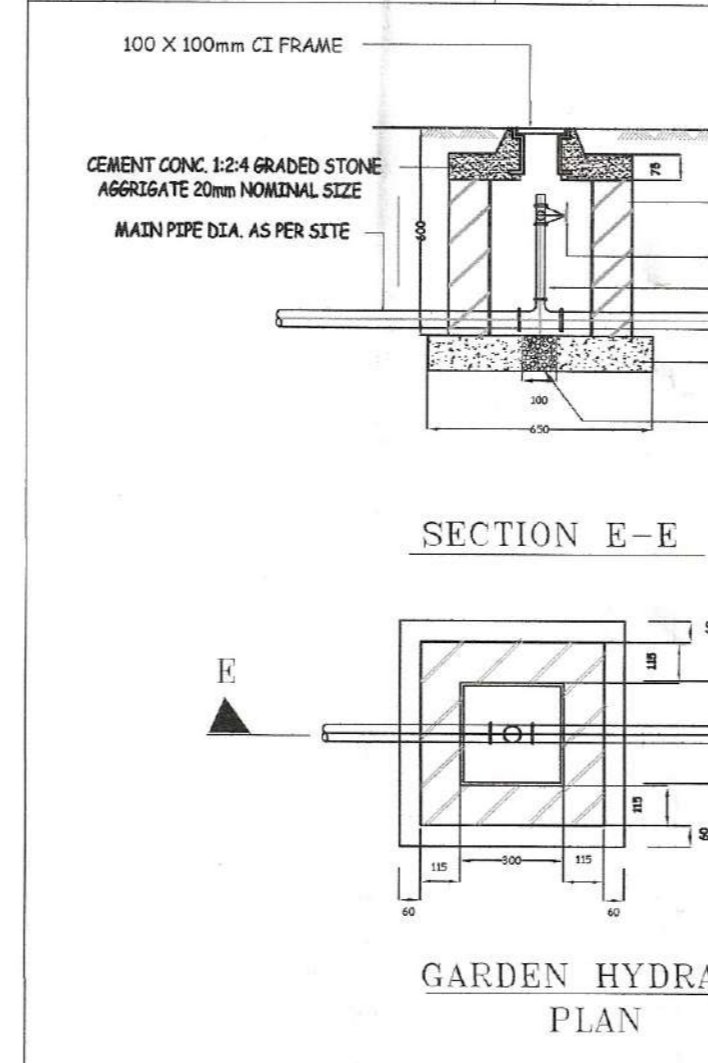

DEPTH	SIZE OF M.H.
0.90m TO 1.65m	900mm DIA
1.65m TO 2.30m	1200mm DIA
2.30m TO 9.00m	1500mm DIA
9.00m TO 14.00m	1800mm DIA

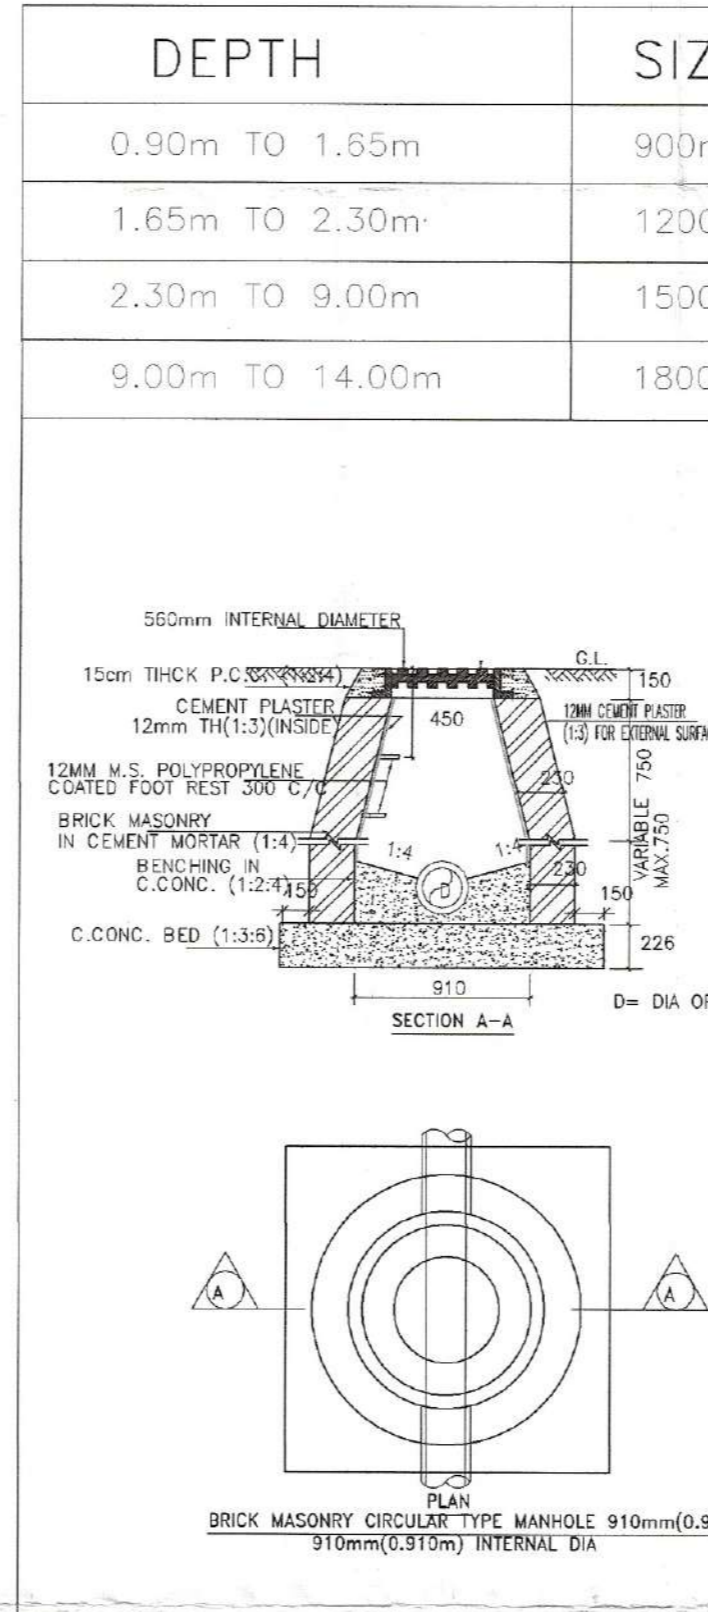

S.N.O.	NO.	PREFIX	BREATH	LENGTH	AREA
A	1	1	7.100	186.838	1,326.550
B	1	(11.767+19.100)/2	9.499	146.603	
C	1	0.5	11.767	2.583	15.197
D	1	0.5	7.845	9.143	35.863
E	0.133	3.143	6.050	6.050	15.338
F	1	(2.580+6.573)/2	4.582	20.970	
G	1	PLINE			48.533
H	1	(0.621+4.800)/2	4.373	11.853	
I	0.128	3.143	6.000	6.000	14.457
J	1	(3.033+3.746)/2	6.621	22.442	
K	0.250	3.143	6.000	6.000	28.286
L	1	(5.925+6.00)/2	1.619	9.633	
M	1	1	7.917	13.658	106.763
N	1	(5.937+6.00)/2	2.272	13.566	
O	0.250	3.143	6.000	6.000	28.286
P	0.25	3.143	6.000	6.000	28.286
Q	1	1	1.598	6.000	9.588
R	1	1	7.598	29.431	223.617
S	0.131	3.143	9.000	9.000	33.236
T	1	(4.862+6.945)/2	1.943	11.471	
U	1.000	(50.534+4.862)/2	48.951	1,355.845	
V	1	0.5	41.186	27.696	570.344
W	1.000	(27.696+22.717)/2	3.348	84.391	
X	1	1	6.000	22.717	136.302
Y	0.344	3.143	6.000	6.000	38.971
Z	1.000	0.500	10.695	41.574	222.317
Z1	1.000	1.000	3.348	7.230	24.206
Z2	0.156	3.143	6.000	6.000	17.600
Z3	1.000	(21.633+12.399)/2	6.000	102.096	
Z7	2.000	0.500	3.143	6.000	113.143
Z8	1	1	12.000	2.647	31.764
Z9	6	0.167	3.143	6.000	113.143
Z10	1.000	1.000	3.000	27.910	83.798
Z11	1	1	3.000	25.681	77.043
Z12	1.000	1.000	3.000	26.681	80.013
Z13	0.250	3.143	6.000	6.000	28.286
Z14	1	1	6.000	5.240	31.440
Z15	1	1	47.027	11.240	528.583
TOTAL ADDITION					6,174.680
SUBTRACTIONS					
1	0.144	3.143	12.000	12.000	65.371
2	2.000	1.000	1.500	2.000	6.000
3	1.000	1.000	5.000	3.615	18.075
4	1.000	0.500	1.402	1.502	1.053
5	6.000	0.500	3.000	5.196	46.764
6	1.000	1.000	3.400	6.290	21.386
TOTAL SUBTRACTIONS					158.649
TOTAL GREEN AREA					6,016.030

NOTES:
 * BOUNDARY WALL AS PER STANDARD DESIGN

MEP CONSULTANT:
SANILAC CONSULTANTS PVT. LTD.
 C-46/2, Datta Industrial Area, Phase-1, New Delhi-110025, INDIA

STRUCTURAL CONSULTANT:
VINTECH CONSULTANTS
 CONSULTING ENGINEERS & PROJECT MANAGERS
 C-25, Panchsheel Park, Convent Road, New Delhi-110017, INDIA

CLIENT:
WHITELAND
 M/s. WhiteLand Corporation Private Limited.
 22 Bark Street, Fort Mumbai-400017, INDIA

PROJECT:
 PROPOSED BUILDING PLAN FOR MIXED LAND USE COLONY (98% RESIDENTIAL COMPONENT & 2% COMMERCIAL COMPONENT) UNDER TOD POLICY FOR THE AREA MEASURING 9.58125 ACRES (LICENSE NO. 263 OF 2023 DATED 12-12-2023) IN SECTOR- 103, GURUGRAM MANESAR URBAN COMPLEX BEING DEVELOPED BY WHITELAND CORPORATION PVT. LTD.

OWNERS SIGNATURE: _____ ARCHITECT SIGNATURE: _____


WhiteLand Corporation Private Limited
 Authorised Signatory

DRAWING TITLE:
SITE PLAN FOR SERVICES

DATE: APR. 2024

SCALE: 1:100 (A1)

SHEET NO. S-2

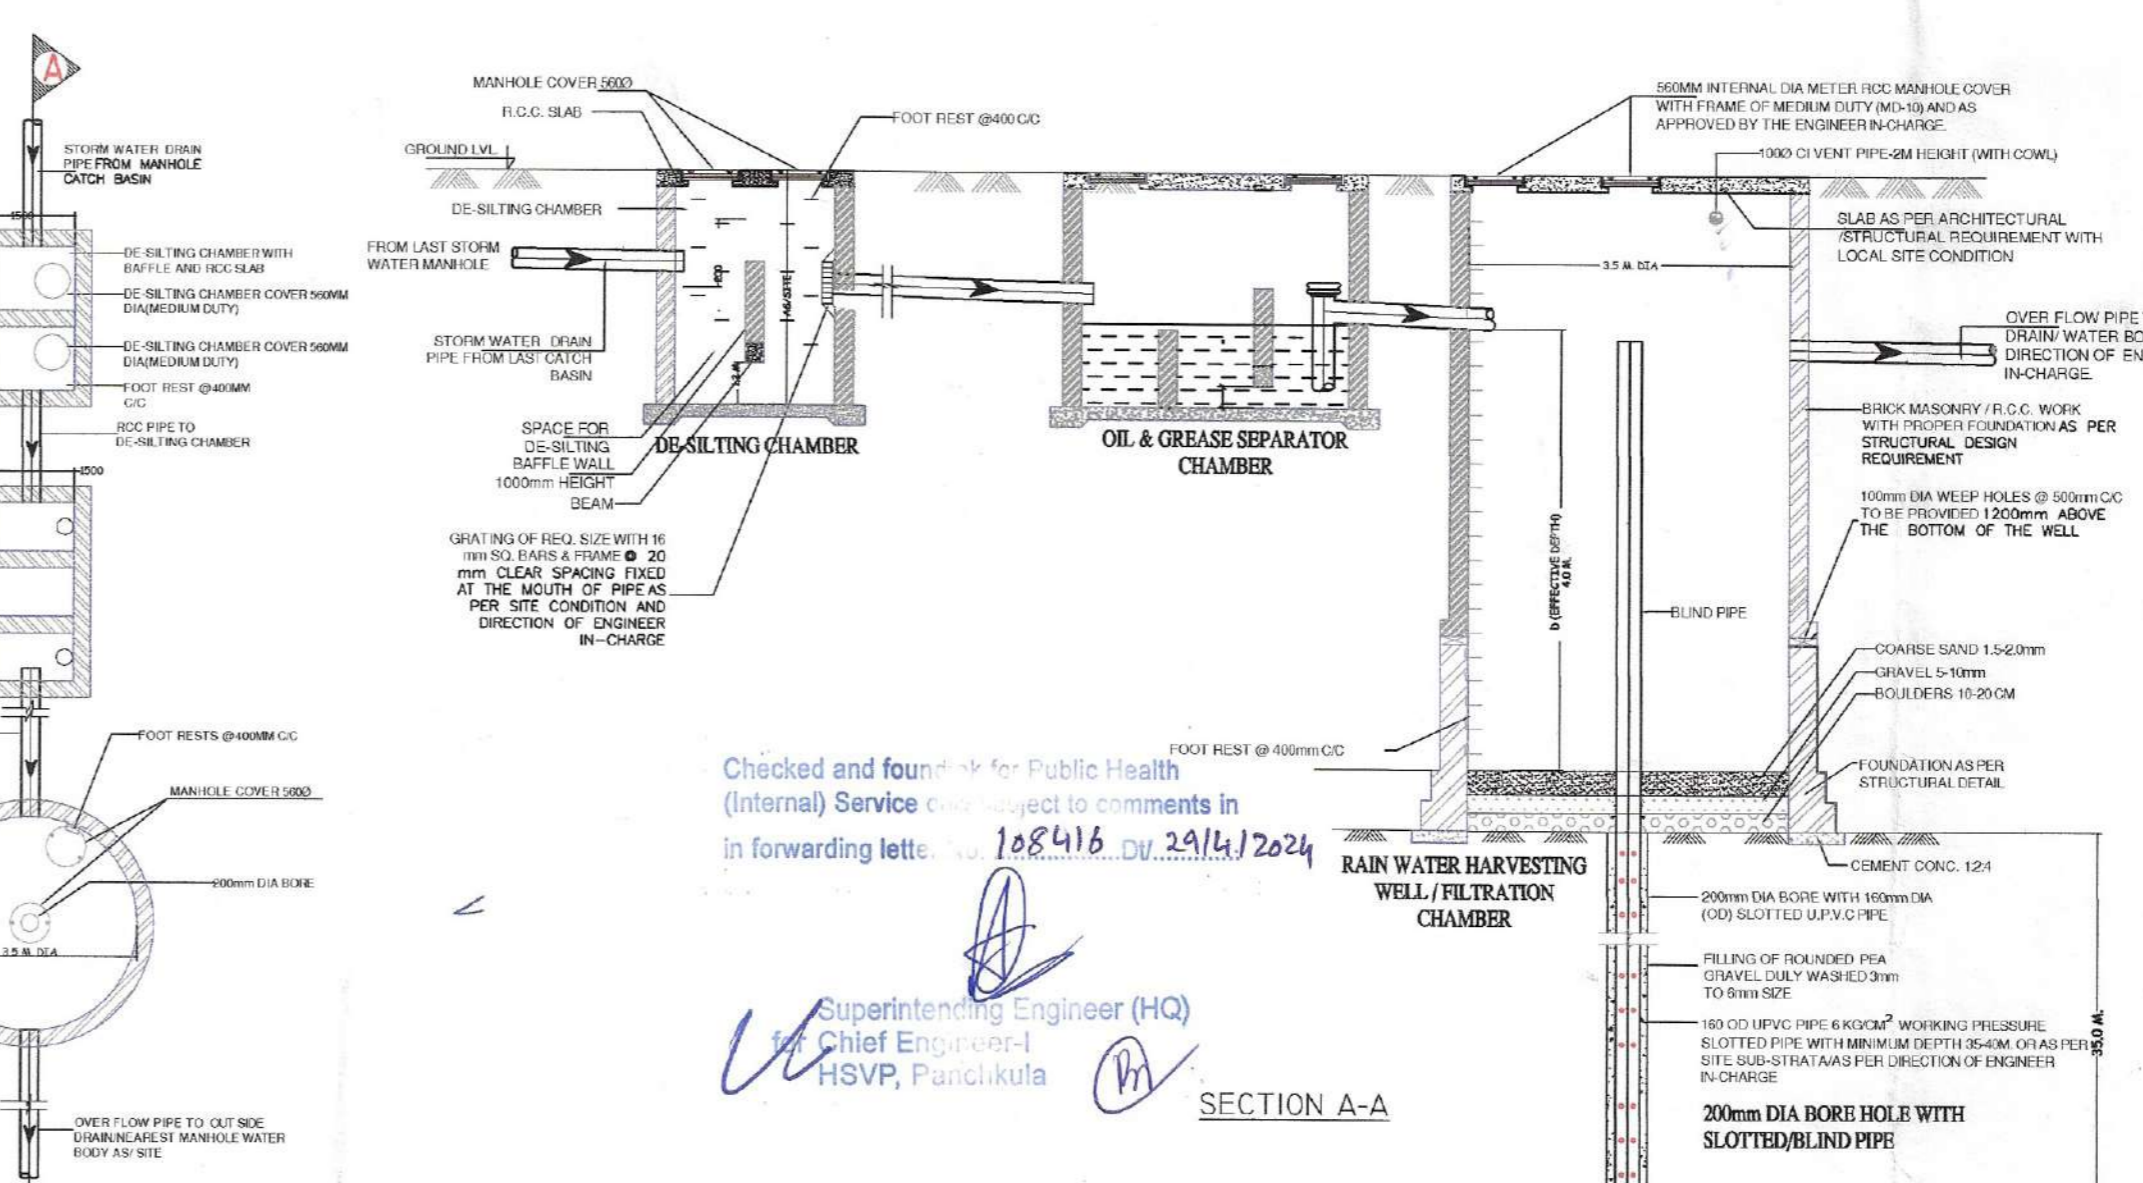

Checked and found OK for Public Health (Internal) Service by comments in following letter no. 188418 dt 24/11/2024

Superintending Engineer (HQ)
 Chief Engineer
 HSWP, Panchsheel Park