


GROUND FLOOR PLAN

GROUND TOILET CALCULATION									
TOTAL FAR AREA AT GROUND FLOOR		DENSITY AT GROUND FLOOR		TOTAL REQUIRED		TOTAL PROVIDED		SQUAT	
NO		PERMANENT POPULATION		TOTAL REQUIRED		TOTAL PROVIDED		SQUAT	
NO		PERMANENT POPULATION		TOTAL REQUIRED		TOTAL PROVIDED		SQUAT	
NO		PERMANENT POPULATION		TOTAL REQUIRED		TOTAL PROVIDED		SQUAT	
NO		PERMANENT POPULATION		TOTAL REQUIRED		TOTAL PROVIDED		SQUAT	
NO		PERMANENT POPULATION		TOTAL REQUIRED		TOTAL PROVIDED		SQUAT	
NO		PERMANENT POPULATION		TOTAL REQUIRED		TOTAL PROVIDED		SQUAT	
NO		PERMANENT POPULATION		TOTAL REQUIRED		TOTAL PROVIDED		SQUAT	
NO		PERMANENT POPULATION		TOTAL REQUIRED		TOTAL PROVIDED		SQUAT	


FAR & NON-FAR AREA CALCULATION FOR COMMERCIAL (RETAIL)							
ADDITION AREA							
S.NO.	NOS.	FORMULA	LENGTH (A)	WIDTH (B)	WIDTH (C)	AREA	UNITS
A1	1	1/2 (A X B)	48.635	36.798		894.835	SQM.
A2	1	A X B	47.972	1.977		94.841	SQM.
A3	1	AS PER PLAN				1.790	SQM.
TOTAL (A) =						991.466	SQM.
DEDUCTION AREA							
D1	1	A X B	2.000	1.629		3.258	SQM.
TOTAL (B) =						3.258	SQM.
NON FAR AREA							
C1	1	1/2 (A X B)	1.460	1.021		0.745	SQM.
C2	1	1/2 (A+C) X B	0.180	0.236	0.359	0.064	SQM.
C3	1	1/2 (A X B)	0.600	0.454		0.136	SQM.
C4	1	A X B	1.364	1.111		1.515	SQM.
C5	1	1/2 (A X B)	1.364	1.032		0.704	SQM.
C6	1	A X B	1.650	3.748		6.184	SQM.
TOTAL (C) =						9.349	SQM.
TOTAL FAR AREA (A-B+C)						978.859	SQM.
COVERED AREA (A)						991.466	SQM.

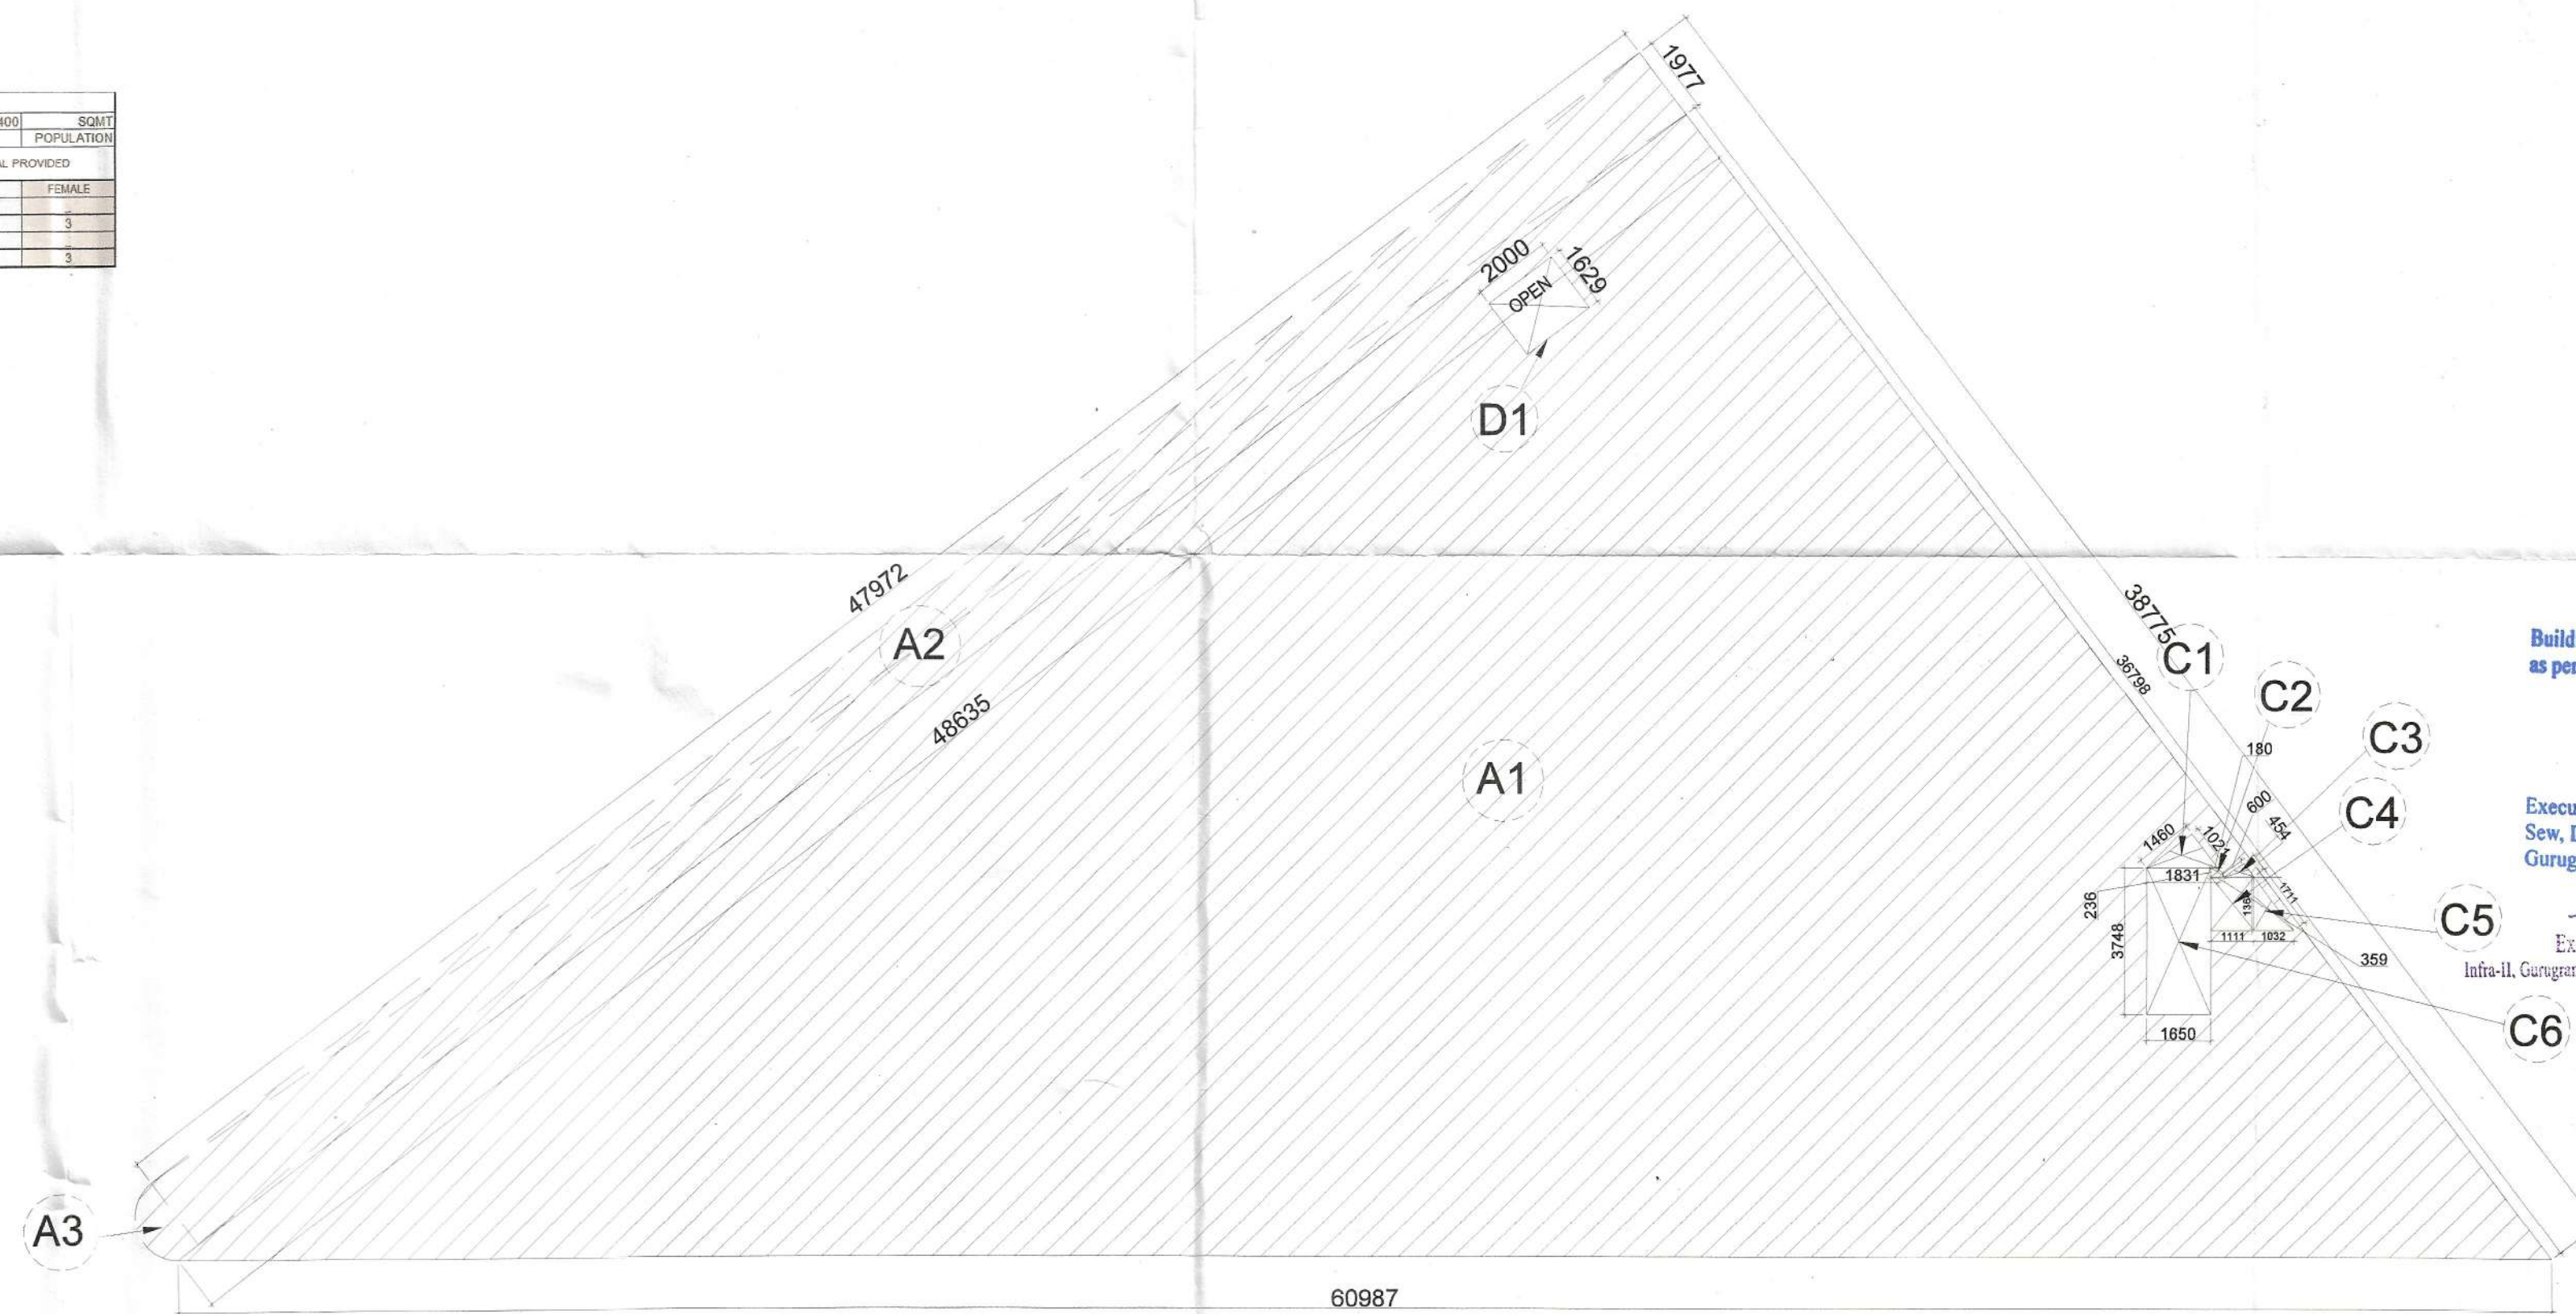

GROUND FLOOR AREA DIAGRAM

DOOR WINDOW OPENING SCHEDULE						
TYPE	WIDTH	HEIGHT	CILL	LINTEL	FIRE RATING	
D1	750	2100	00	2100		
D2	1050	2100	00	2100		
D3	1250	2100	00	2100		
FD	900	2100	300	1800	2 HR	
DW1	2700	2400	150	2400		
DW2	3200	2400	150	2400		
DW3	3300	2400	150	2400		
DW4	6800	2400	150	2400		
DW5	5400	2400	150	2400		
W1	3000	1500	900	2400		
V1	450	900	1500	2400		
V2	1000	600	1500	2400		

PLUMBING LEGEND:-	
1	1100 SOIL PIPE
2	1100 WASTE PIPE
3	1100 RAIN WATER PIPE
4	DWS ON TAKE PIPE
4A	DWS FROM BOOSTER PUMP FOR TOP TWO FLOORS
5	PWS ON TAKE PIPE
6	1100 BALCONY DRAIN PIPE
7	1100 DOMESTIC WATER SUPPLY RISER
8	1100 FLUSHING WATER SUPPLY RISER
9	750 ANTISIPHONAGE PIPE
WB TO FT	400 WASTE PIPE
SNK TO FT	500 WASTE PIPE
FD @	FLOOR DRAIN WITH GRATING
FT @	FLOOR TRAP WITH GRATING
MT @	MULTI TRAP WITH GRATING
BD @	BALCONY DRAIN WITH GRATING
DWS	DOMESTIC WATER SUPPLY PIPE
PWS	FLUSHING WATER SUPPLY PIPE
DWS	DWS PIPE THROUGH BOOSTER PUMP
GEYSER	TOILET GEYSER 20LTR
GEYSER	KITCHEN GEYSER 10LTR
P	BOOSTER PUMP SET FOR TOP TWO FLOORS
	CATCH BASIN 1100x500mm
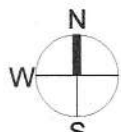
<div><div>NORTH POINT</div><div></div></div>		<div><div>This drawing is a "COPYRIGHT"</div><div>contents of this drawing or part</div><div>thereof may not be used or</div><div>reproduced without the permission</div><div>of the Architect</div></div>	
NO. OF PRINTS	DATE	ISSUED TO	REMARKS
REVISION	DATE	DESCRIPTION	BY

GENERAL NOTES
1. All dimensions are in mm unless mentioned otherwise
2. No dimensions are to be scaled from this drawing.

Sanctioned
TO BE READ WITH THIS OFFICE
MEMO NO: 36015
DATED: 01/12/22

ATP (HQ)
Member
B.P.A.C.

S.T.P. (HQ)
Member Secretary
B.P.A.C.


S.T.P. (G)
Member
B.P.A.C.

S.T.P. (P)
Member
B.P.A.C.

DINESH KUMAR
PA(HQ)

JD.

ATP.

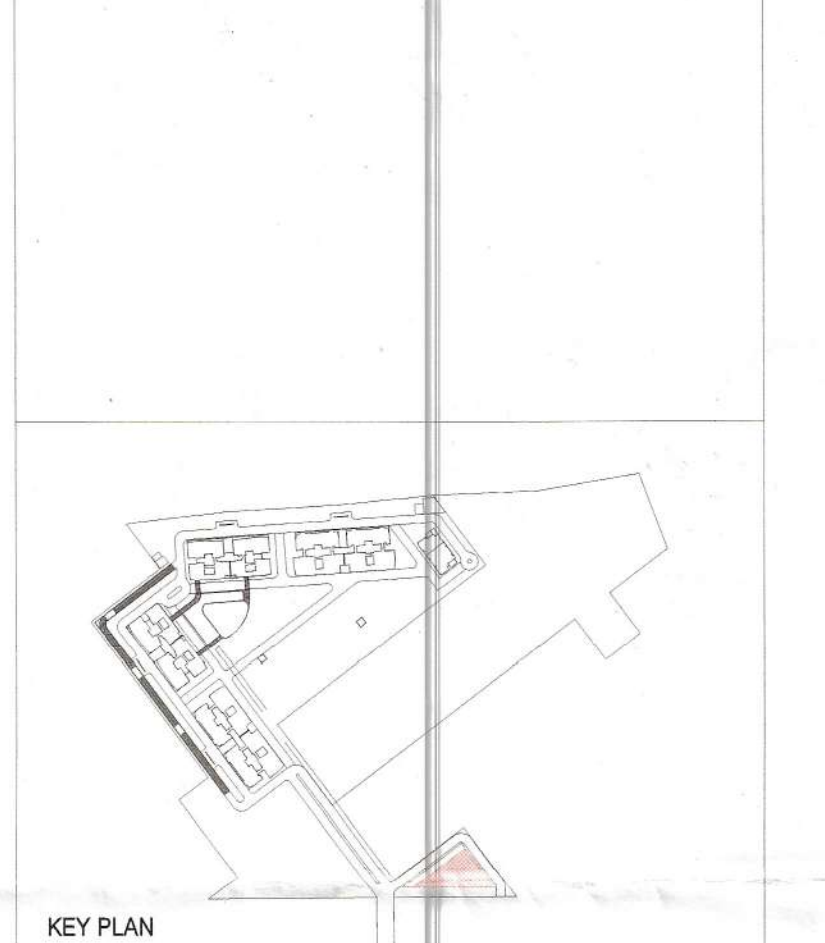

KEY PLAN

SUBMISSION DRAWINGS

CLIENT:
NOURISH DEVELOPERS PVT. LTD.

PROJECT:
BUILDING PLAN FOR RESIDENTIAL COLONY UNDER
TODS POLICY ON THE AREA MEASURING 10.30
ACRES (AFTER FREEZING OF AN AREA MEASURING
5.8125 ACRES (46K-10M) FALLING UNDER NCZ AND
NON COMPACT POCKET DUE TO NCZ) (LICENCE NO.
108 OF 2022, DATED 5/8/2022 AT SECTOR-113
DISTRICT GURUGRAM, HARYANA BEING
DEVELOPED BY NOURISH DEVELOPERS PVT. LTD

DATE	CHECKED BY	APPROVED BY
SEP. 2022	DEEPAK AGARWAL	
SCALE	DEALT BY	
1:100	LAJJARAM	DEEPAK AGARWAL

DRAWING TITLE

COMMERCIAL BLOCK PLAN

GROUND FLOOR PLAN & AREA DIAGRAMS

OWNER'S SIGN
Nourish Developers Private Limited

Authorized Signatory

ARCHITECT'S SIGN

ARCHITECTS:
C. P. KUKREJA ARCHITECTS
ASHIRWAD BUILDING,
D-1 GREEN PARK,
NEW DELHI - 110016
PHONE :- 011 26863953 FAX :- 011 26865770
EMAIL: cpka@cpkukreja.com

DRAWING NO.
21020/SWD-113/SUB/LATEST/COMMERCIAL-A-FP00

CAD NO.


DRG. NO.
45

TYPE	WIDTH	HEIGHT	CILL	LINTEL	FIRE RATING
D1	750	2100	00	2100	
D2	1050	2100	00	2100	
D3	1250	2100	00	2100	
FD	900	2100	300	1800	2 HR
DW1	2700	2400	150	2400	
DW2	3200	2400	150	2400	
DW3	3300	2400	150	2400	
DW4	6800	2400	150	2400	
DW5	5400	2400	150	2400	
W1	3000	1500	900	2400	
V1	450	900	1500	2400	
V2	1000	600	1500	2400	

PLUMBING LEGEND:-	
①	1100 SOIL PIPE
②	1100 WASTE PIPE
③	1100 RAIN WATER PIPE
④	DWS DN TAKE PIPE
④A	DWS FROM BOOSTER PUMP FOR TOP TWO FLOOR
⑤	FWS DN TAKE PIPE
⑥	1100 BALCONY DRAIN PIPE
⑦	⑧ DOMESTIC WATER SUPPLY RISER
⑧	⑨ FLUSHING WATER SUPPLY RISER
⑨	750 ANTISYPHONAGE PIPE
WB TO FT	400 WASTE PIPE
SINK TO FT	500 WASTE PIPE
FD	FLOOR DRAIN WITH GRATING
FT	FLOOR TRAP WITH GRATING
MT	MULTI TRAP WITH GRATING
BD	BALCONY DRAIN WITH GRATING
DWS	DOMESTIC WATER SUPPLY PIPE
FWS	FLUSHING WATER SUPPLY PIPE
DWS	DWS PIPE THROUGH BOOSTER PUMP
⑩	GEYSER TOILET GEYSER 25LTR
⑪	GEYSER KITCHEN GEYSER 6LTR
P	BOOSTER PUMP SET FOR TOP TWO FLOOR
CB	CATCH BASIN 1100x500mm

GENERAL NOTES
1. All dimensions are in mm unless mentioned otherwise.
2. No dimensions are to be scaled from this drawing.

SANCTIONED TO BE READ WITH THIS OFFICE MEMO NO. 36075 DATED: 01/12/22
DINESH KUMAR PA(HQ)
DDA MEMBER BPAC
A.T.P.

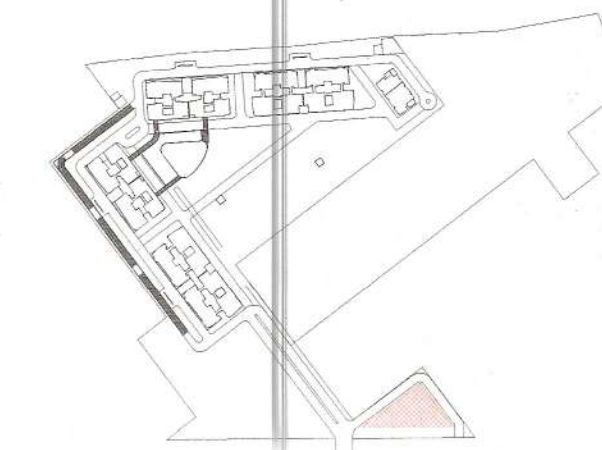

SUBMISSION DRAWINGS
CLIENT:
NOURISH DEVELOPERS PVT. LTD.

PROJECT:
BUILDING PLAN FOR RESIDENTIAL COLONY UNDER TO D POLICY ON THE AREA MEASURING 10.30 ACRES (AFTER FREEZING OF AN AREA MEASURING 5.8125 ACRES (46K-10M) FALLING UNDER NCZ AND NON COMPACT POCKET DUE TO NCZ) (LICENCE NO. 106 OF 2022, DATED 8/8/2022 AT SECTOR-113 DISTRICT GURUGRAM, HARYANA BEING DEVELOPED BY NOURISH DEVELOPERS PVT. LTD)

DATE: SEP. 2022
CHECKED BY: DEEPAK AGARWAL
APPROVED BY:
SCALE: 1:100
DEALT BY: LAJARAM
DEEPAK AGARWAL


DRAWING TITLE
COMMERCIAL BLOCK PLAN FIRST, SECOND FLOOR PLAN & AREA DIAGRAMS

OWNERS SIGN:
Nourish Developers Private Limited
Authorized Signatory



ARCHITECTS:-
C. P. KUKREJA ARCHITECTS
ASHIRWAD BUILDING,
D-1, GREEN PARK,
NEW DELHI - 110016
PHONE :- 011 26863953 FAX :- 011 26865770
EMAIL:- cpka@cpkukreja.com



DRAWING NO. 21020/SWD-113/SUB/LATEST/COMMERCIAL/A-FP01-02
CAD NO.
DRG. NO. 46

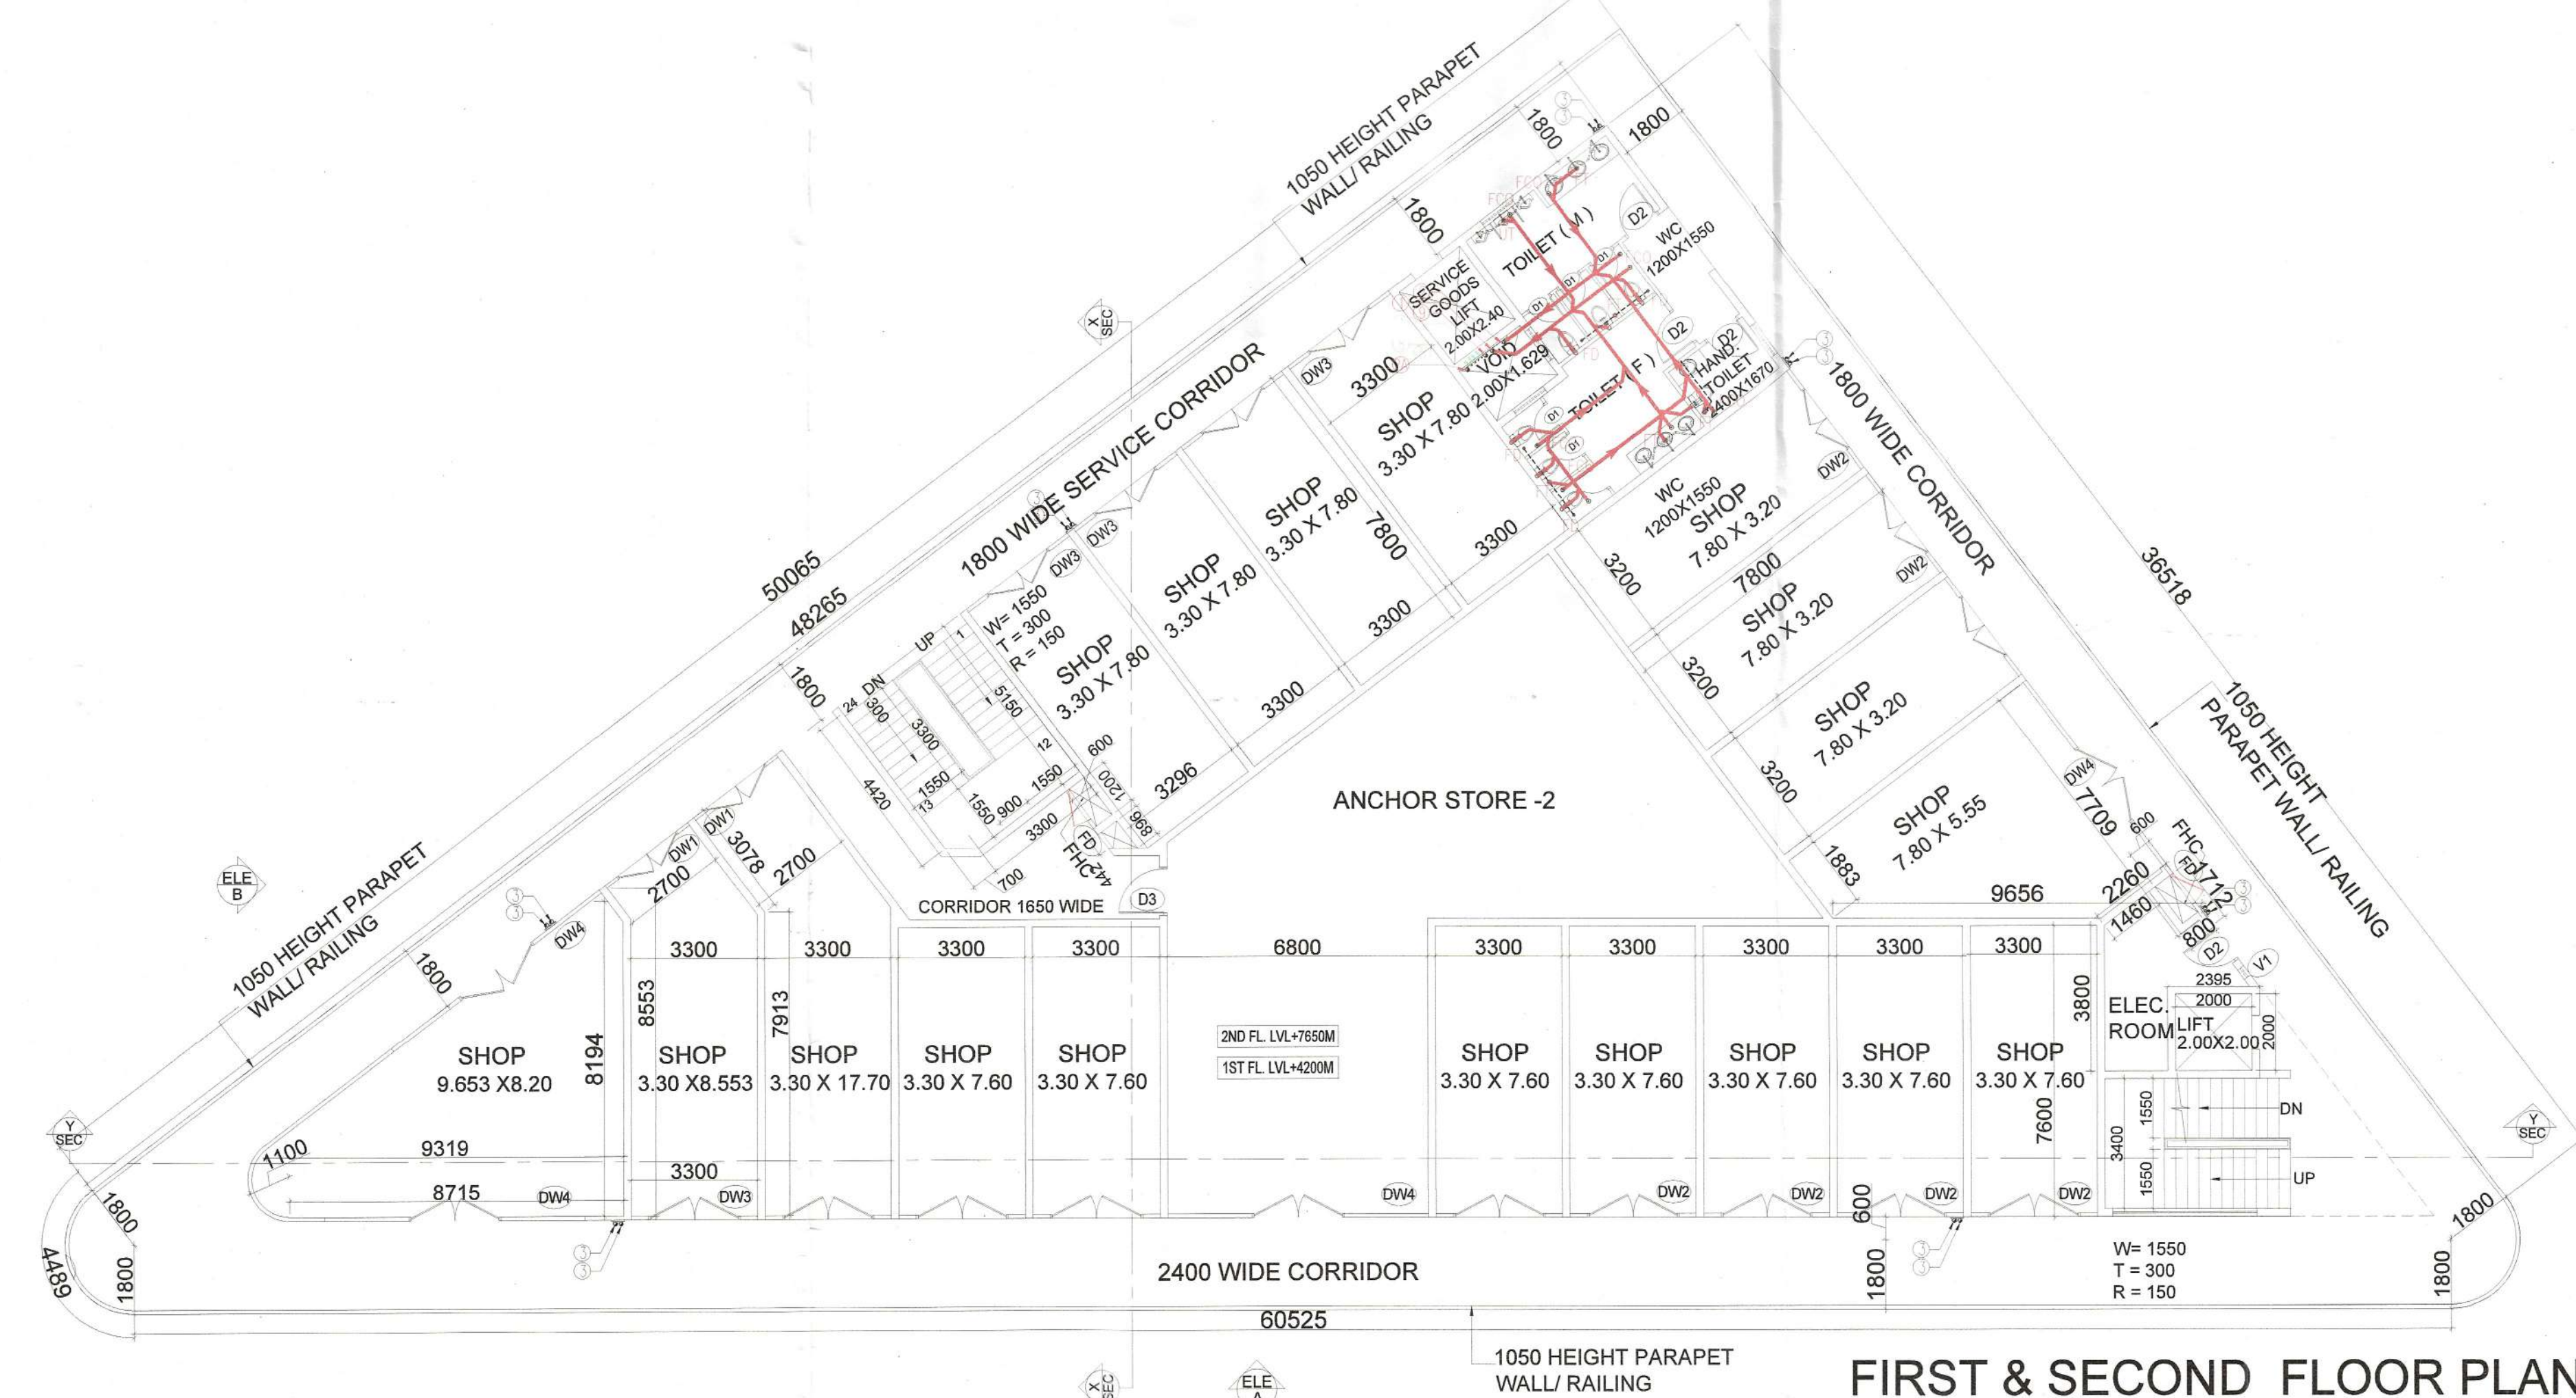

FIRST & SECOND FLOOR PLAN

FIRST TOILET CALCULATION									
TOTAL FAR AREA AT FIRST FLOOR		DENSITY AT FIRST FLOOR		POPULATION		TOTAL REQUIRED		TOTAL PROVIDED	
NO	AREA (SQM)	PERMANENT POPULATION	FLOATING POPULATION	MALE (20)	FEMALE (10)	MALE	FEMALE	MALE	FEMALE
1	9.653 X 8.20	82	82	1	1	1	1	1	1
2	3.30 X 8.553	28	28	1	1	1	1	1	1
3	3.30 X 17.70	89	89	1	1	1	1	1	1
4	3.30 X 7.60	28	28	1	1	1	1	1	1
5	3.30 X 7.60	28	28	1	1	1	1	1	1
6	3.30 X 7.60	28	28	1	1	1	1	1	1
100	3.30 X 7.60	28	28	1	1	1	1	1	1

SECOND TOILET CALCULATION											
TOTAL FAR AREA AT SECOND FLOOR				DENSITY AT SECOND FLOOR				138.934	137	921.665	POPUL
NO	PERMANENT POPULATION		FLOATING POPULATION		TOTAL REQUIRED		TOTAL PROVIDED				
	MALE (20)	FEMALE (10)	MALE (20)	FEMALE (10)	MALE	FEMALE	MALE	FEMALE			
POPULATION	9	5	62	41							
W.C.	0.37	0.30	0.33	0.20	1	1	3	3			
URINAL	0.30		1.64		2						
WASH BASIN	0.37	0.18	0.33	0.29	1	0	3	3			

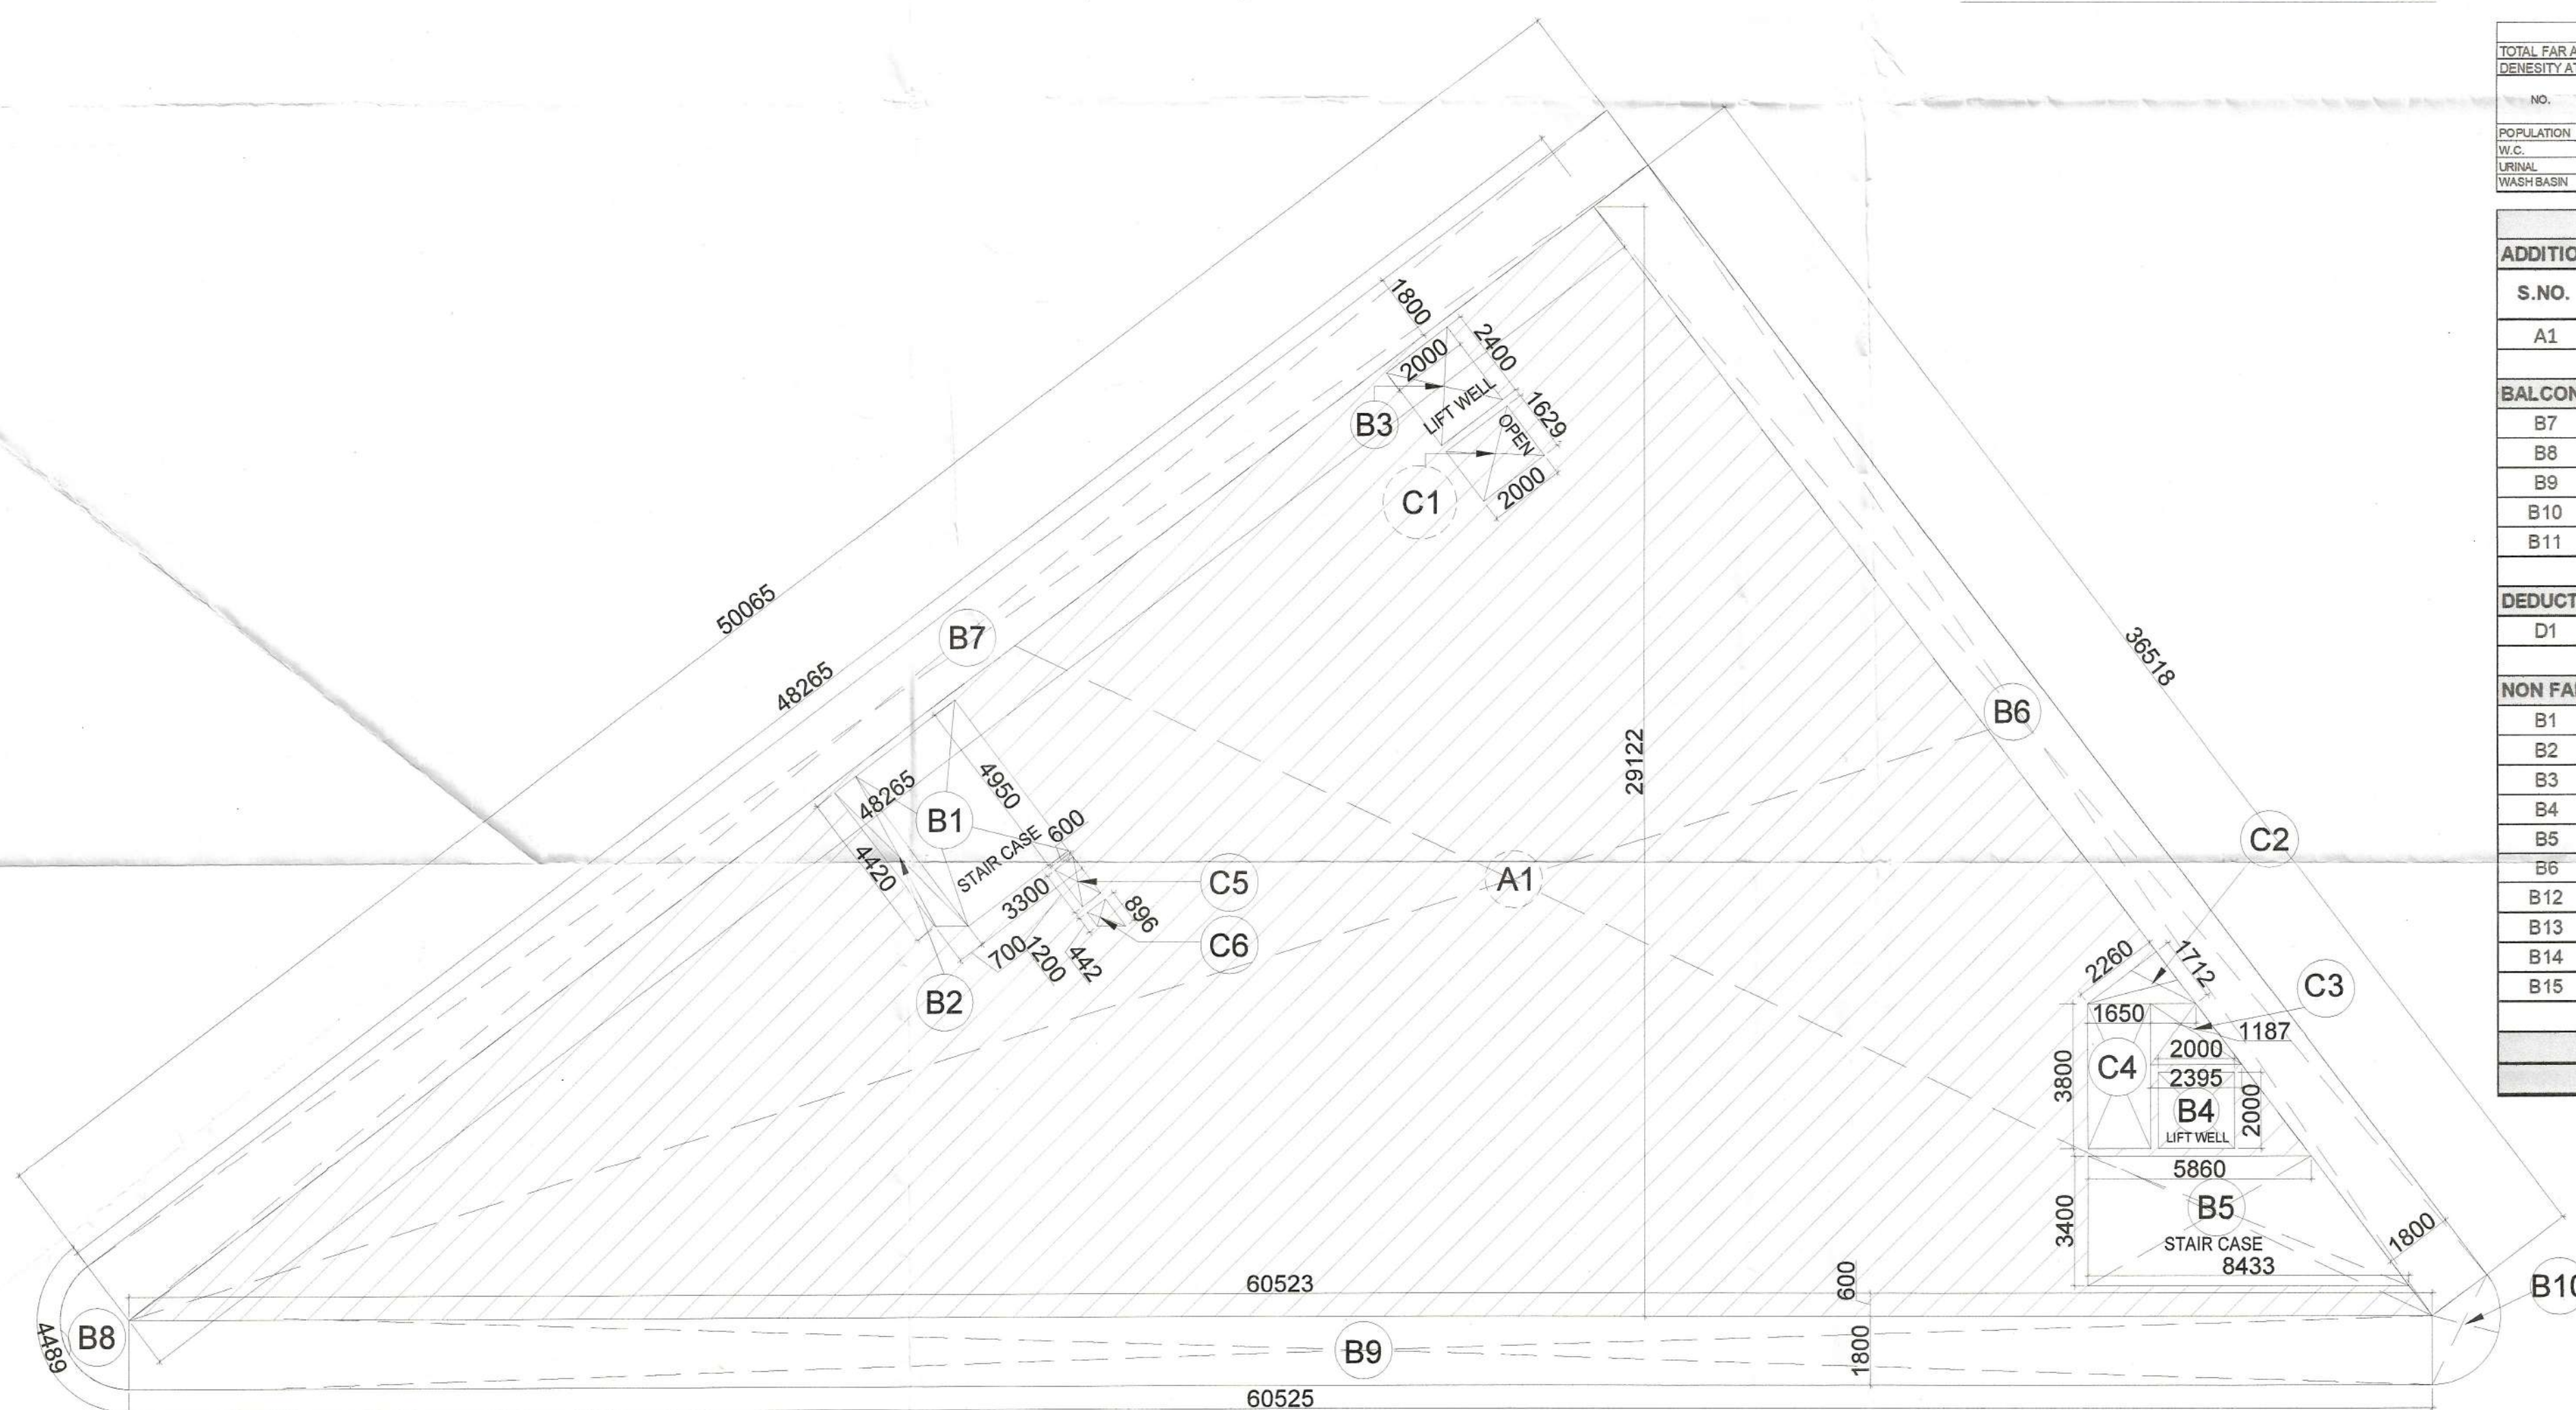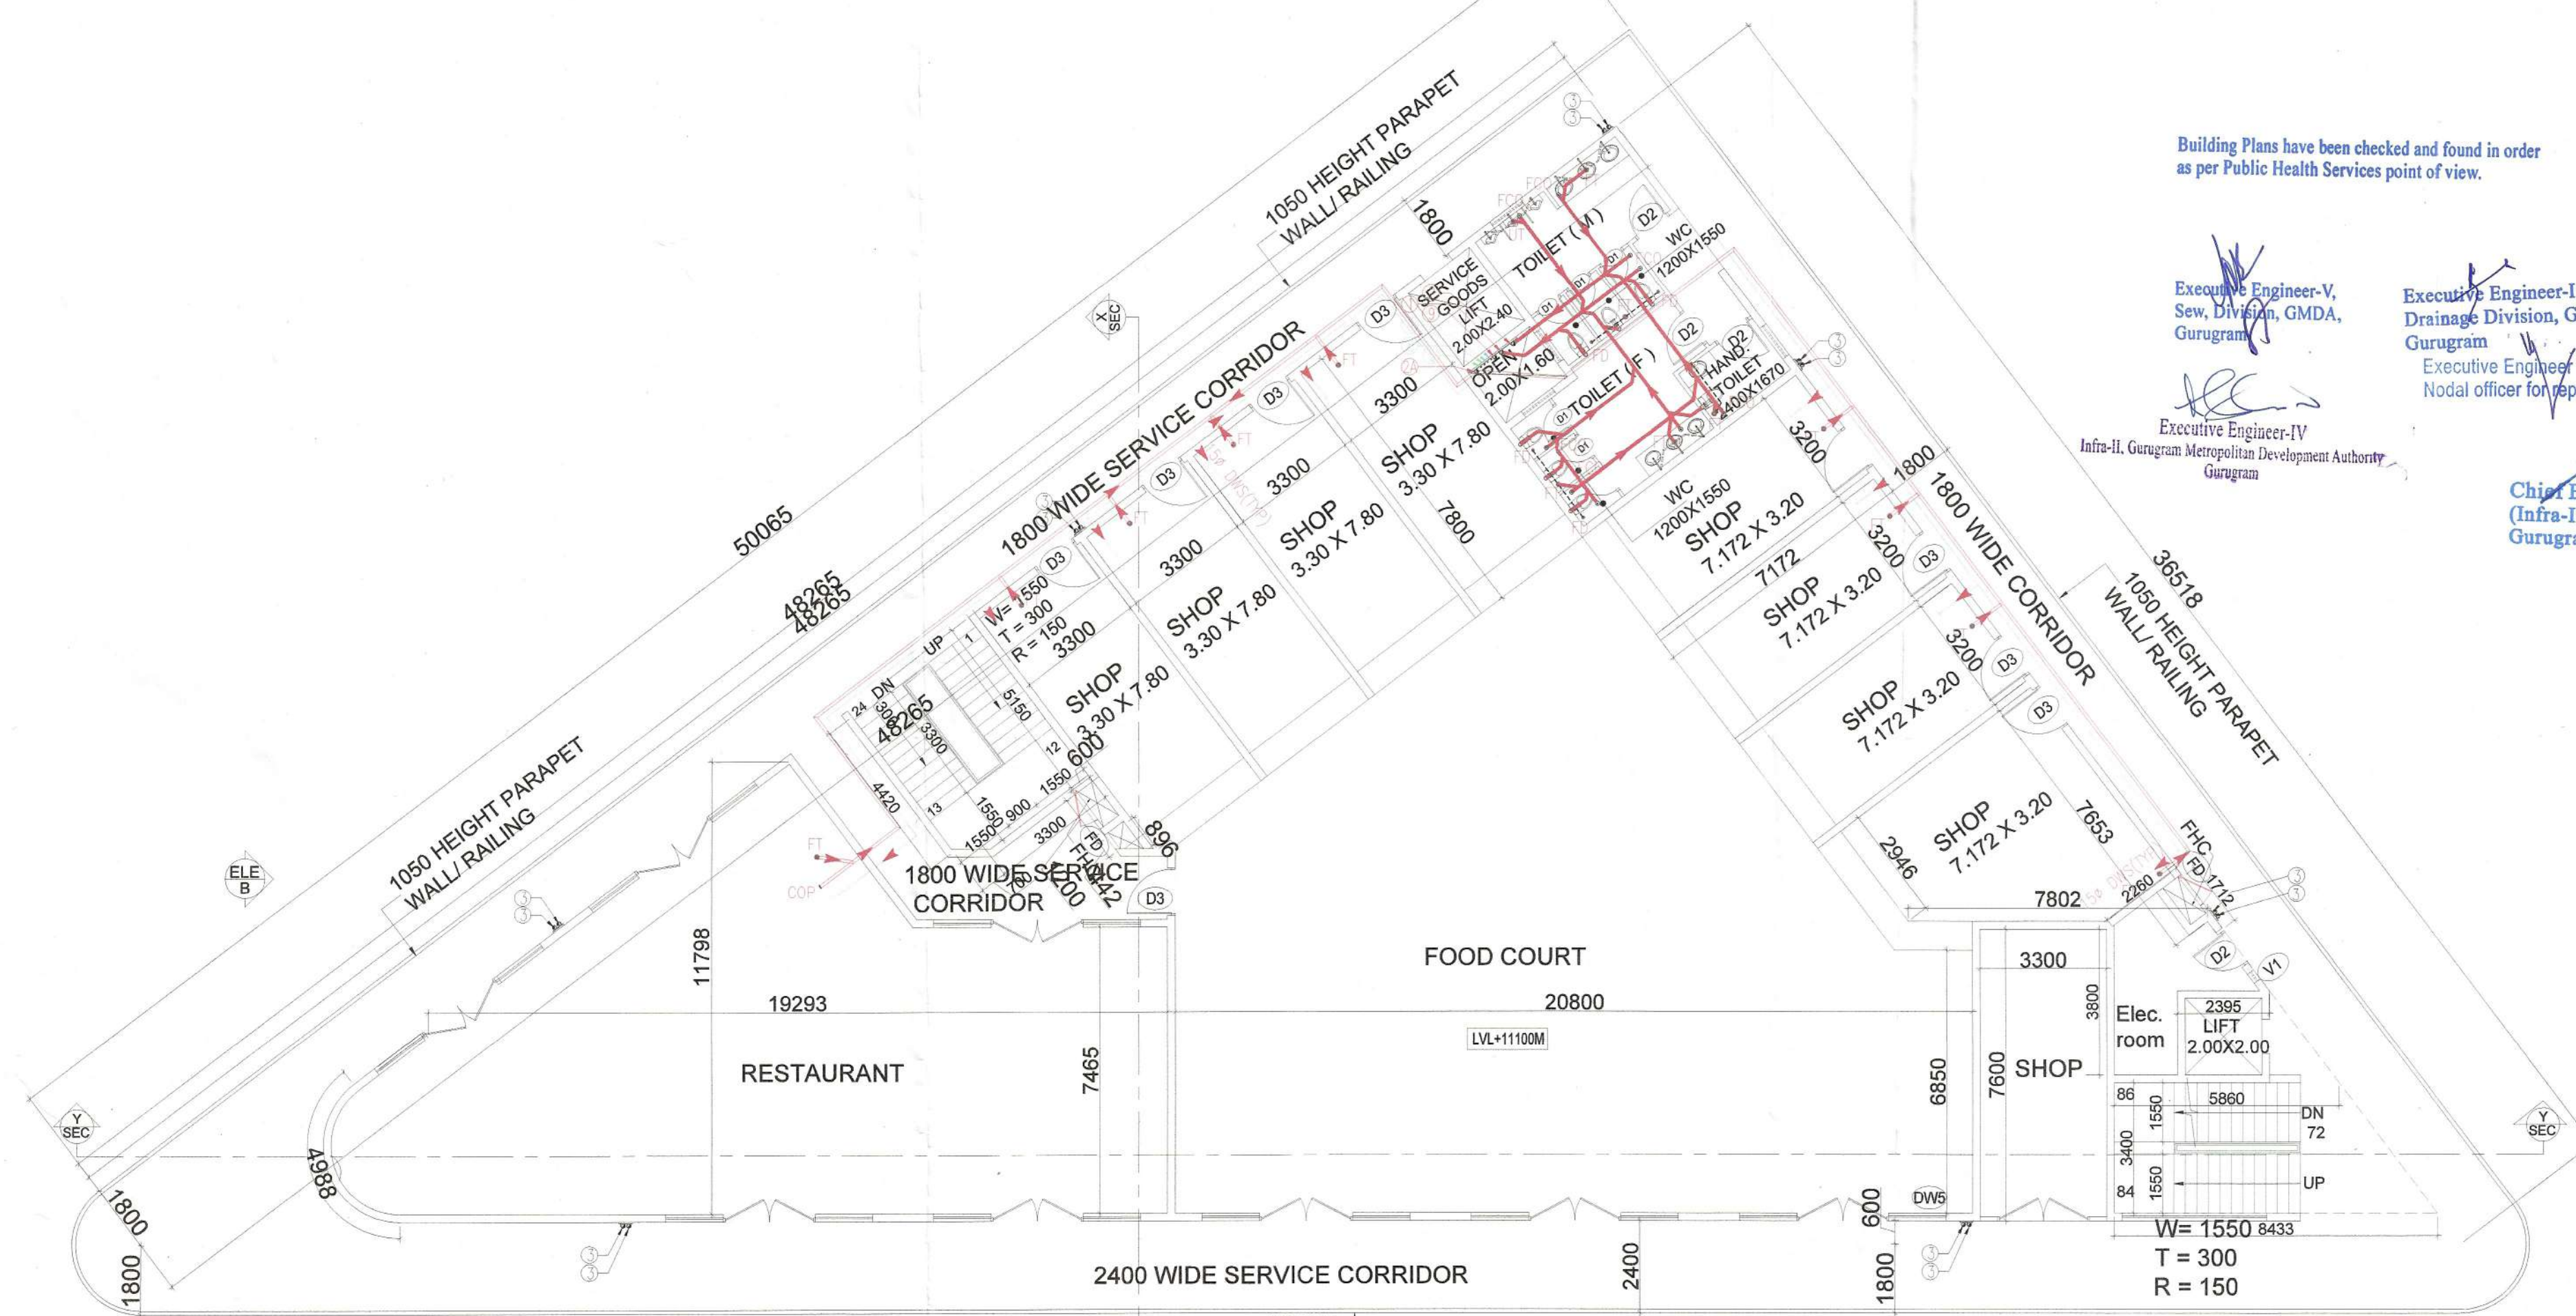

DOOR WINDOW OPENING SCHEDULE					
TYPE	WIDTH	HEIGHT	CILL	LINTEL	FIRE R
D1	750	2100	00	2100	
D2	1050	2100	00	2100	
D3	1250	2100	00	2100	
FD	900	2100	300	1800	2 H
DW1	2700	2400	150	2400	
DW2	3200	2400	150	2400	
DW3	3300	2400	150	2400	
DW4	6800	2400	150	2400	
DW5	5400	2400	150	2400	
W1	3000	1500	900	2400	
V1	450	900	1500	2400	
V2	1000	600	1500	2400	


PLUMBING LEGEND:-	
(1)	110Ø SOIL PIPE
(2)	110Ø WASTE PIPE
(3)	110Ø RAIN WATER PIPE
4	DWS DN TAPE PIPE
4A	DWS FROM BOOSTER PUMP FOR TOP TWO FLOOR
5	FWS DN TAPE PIPE
(6)	110Ø BALCONY DRAIN PIPE
7	Ø DMOESTIC WATER SUPPLY RI
8	Ø FLUSHING WATER SUPPLY RI
(9)	75Ø ANTISIPHONAGE PIPE
WB TO FT	40Ø WASTE PIPE
SINK TO FT	50Ø WASTE PIPE
FD ⊗	FLOOR DRAIN WITH GRATING
FT ⊗	FLOOR TRAP WITH GRATING
MT ⊗	MULTI TRAP WITH GRATING
BD ⊗	BALCONY DRAIN WITH GRATING
DWS	DOMESTIC WATER SUPPLY PIPE
FWS	FLUSHING WATER SUPPLY PIPE
DWS	DWS PIPE THROUGH BOOSTER P
⊙ GEYSER	TOILET GEYSER 25LTR
⊙ GEYSER	KITCHEN GEYSER 15LTR
P -	BOOSTER PUMP SET FOR TOP TWO FLO
	CATCH BASIN 110x50x50mm

THIRD TOILET CALCULATION							831.607	139	POPULATION
TOTAL FAR AREA AT THIRD FLOOR									
GENENSITY AT THIRD FLOOR									
NO.	PERMANENT POPULATION			FLOATING POPULATION		TOTAL REQUIRED	TOTAL PROVIDED		
	10%	10%	10%	20%	10%	10%	MALE	FEMALE	
POPULATION	MALE (23)	FEMALE (1/3)	MALE (23)	FEMALE (1/3)	MALE	FEMALE	MALE	FEMALE	
W.C.	9	5	83	42	1	1			
URINAL	0.37	0.31	0.33	0.28	2	1	3	3	
WASH BASIN	0.37	0.18	0.33	0.30	1	0	3	3	

THIRD FLOOR							
ADDITION AREA							
S.NO.	NOS.	FORMULA	LENGTH (A)	WIDTH (B)	WIDTH (C)	AREA	UNITS
A1	1	1/2 (A X B)	48.265	36.518		881.271	SQM.
TOTAL (A) =						881.271	SQM.
BALCONY AREA							
B7	1	AS PER PLAN				3.592	SQM.
B8	1	A X B	60.525	1.800		108.945	SQM.
B9	1	AS PER PLAN				4.040	SQM.
B10	1	A X B	50.065	1.800		90.117	SQM.
B11	1	A X B	36.518	1.800		65.732	SQM.
TOTAL (B) =						272.426	SQM.
DEDUCTION AREA							
D1	1	A X B	2.000	1.629		3.258	SQM.
TOTAL (C) =						3.258	SQM.
NON FAR AREA							
B1	1	A X B	3.300	4.950		16.335	SQM.
B2	1	1/2 (A+C) X B	4.420	0.700	4.950	3.280	SQM.
B3	1	A X B	2.000	2.400		4.800	SQM.
B4	1	A X B	1.650	3.800		6.270	SQM.
B5	1	A X B	2.000	2.000		4.000	SQM.
B6	1	1/2 (A+C) X B	5.860	3.400	8.433	24.298	SQM.
B12	1	1/2 (A X B)	2.260	1.712		1.935	SQM.
B13	1	1/2 (A+C) X B	1.187	1.608	2.000	2.559	SQM.
B14	1	A X B	0.700	0.600		0.420	SQM.
B15	1	1/2 (A+C) X B	0.442	0.600	0.898	0.401	SQM.
TOTAL (D) =						64.298	SQM.
TOTAL FIRST FLOOR FAR AREA (A-C-D)						813.715	SQM.
TOTAL FIRST FLOOR FAR AREA (A-C-D)						813.715	SQM.

THIRD FLOOR							
ADDITION AREA							
S.NO.	NOS.	FORMULA	LENGTH (A)	WIDTH (B)	WIDTH (C)	AREA	UNITS
A1	1	1/2 (A X B)	48.265	36.518		881.271	SQM.
TOTAL (A) =						881.271	SQM.
BALCONY AREA							
B7	1	AS PER PLAN				3.592	SQM.
B8	1	A X B	60.525	1.800		108.945	SQM.
B9	1	AS PER PLAN				4.040	SQM.
B10	1	A X B	50.065	1.800		90.117	SQM.
B11	1	A X B	36.518	1.800		65.732	SQM.
TOTAL (B) =						272.426	SQM.
DEDUCTION AREA							
D1	1	A X B	2.000	1.629		3.258	SQM.
TOTAL (C) =						3.258	SQM.
NON FAR AREA							
B1	1	A X B	3.300	4.950		16.335	SQM.
B2	1	1/2 (A+C) X B	4.420	0.700	4.950	3.280	SQM.
B3	1	A X B	2.000	2.400		4.800	SQM.
B4	1	A X B	1.650	3.800		6.270	SQM.
B5	1	A X B	2.000	2.000		4.000	SQM.
B6	1	1/2 (A+C) X B	5.860	3.400	8.433	24.298	SQM.
B12	1	1/2 (A X B)	2.260	1.712		1.935	SQM.
B13	1	1/2 (A+C) X B	1.187	1.608	2.000	2.559	SQM.
B14	1	A X B	0.700	0.600		0.420	SQM.
B15	1	1/2 (A+C) X B	0.442	0.600	0.896	0.401	SQM.
TOTAL (D) =						64.298	SQM.
TOTAL FIRST FLOOR FAR AREA (A-C-D)						813.715	SQM.
TOTAL FIRST FLOOR FAR AREA (A-C-D)						813.715	SQM.

NORTH POINT



A circular compass rose with four cardinal directions labeled: N (North) at the top, S (South) at the bottom, E (East) on the right, and W (West) on the left. The letters are in a bold, sans-serif font.

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of the Architect

NO. OF PRINTS	DATE	ISSUED TO	REMARKS
REVISION	DATE	DESCRIPTION	BY


GENERAL NOTES

1. All dimensions are in mm unless mentioned otherwise.
2. No dimensions are to be scaled from this drawing.

SANCTIONED
TO BE READ WITH THIS OFFICE
MEMO NO.: 36075
DATED: 01/12/22

DDT
MEMBE
BRAC

DINESH KUMAR
PA(HQ)

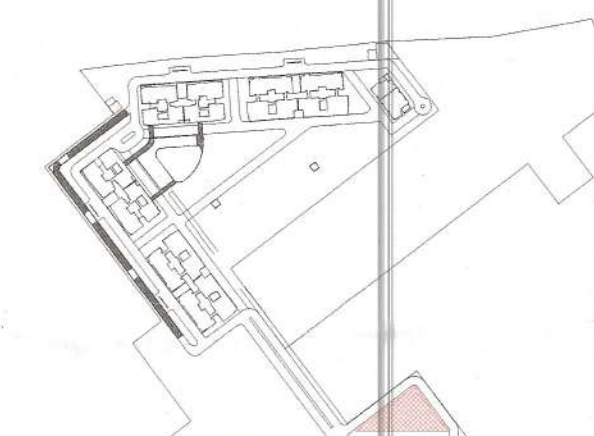

SUBMISSION DRAWINGS

CLIENT :
NOURISH DEVELOPERS PVT. LTD

PROJECT :
BUILDING PLAN FOR RESIDENTIAL COLONY UNDER
D & D POLICY ON THE AREA MEASURING 10.30
ACRES (AFTER FREEZING OF AN AREA MEASURING
5.8125 ACRES (46K-10M) FALLING UNDER NCZ AND
NON COMPACT POCKET DUE TO NCZ) (LICENCE NO
106 OF 2022, DATED 5/8/2022 AT SECTOR-113
DISTRICT GURUGRAM, HARYANA BEING
DEVELOPED BY NOURISH DEVELOPERS PVT. LTD

DATE SEP. 2022	CHECKED BY DEEPAK AGARWAL	APPROVED BY
SCALE 1:100	DEALT BY LAJJARAM	DEEPAK AGARWAL

DRAWING TITLE
COMMERCIAL BLOCK PLAN
THIRD FLOOR PLAN & AREA DIAGRAM

OWNER'S SIGN.

Nourish Developers Private Limited

Authorized signatory


ARCHITECT'S SIGNATURE _____



ARCHITECTS:-
C. P. KUKREJA ARCHITECTS
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D-1, GREEN PARK,
NEW DELHI - 110016
PHONE :- 011 26863953 FAX :- 011 26865770
EMAIL-cpkja@cpkukreja.com


DRAWING NO.	21020/SWD-113/SUB./LATEST/COMMERCIAL/A-FP0
CAD NO.	

DRG. NO.	47
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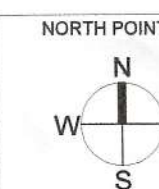
TERRACE FLOOR PLAN

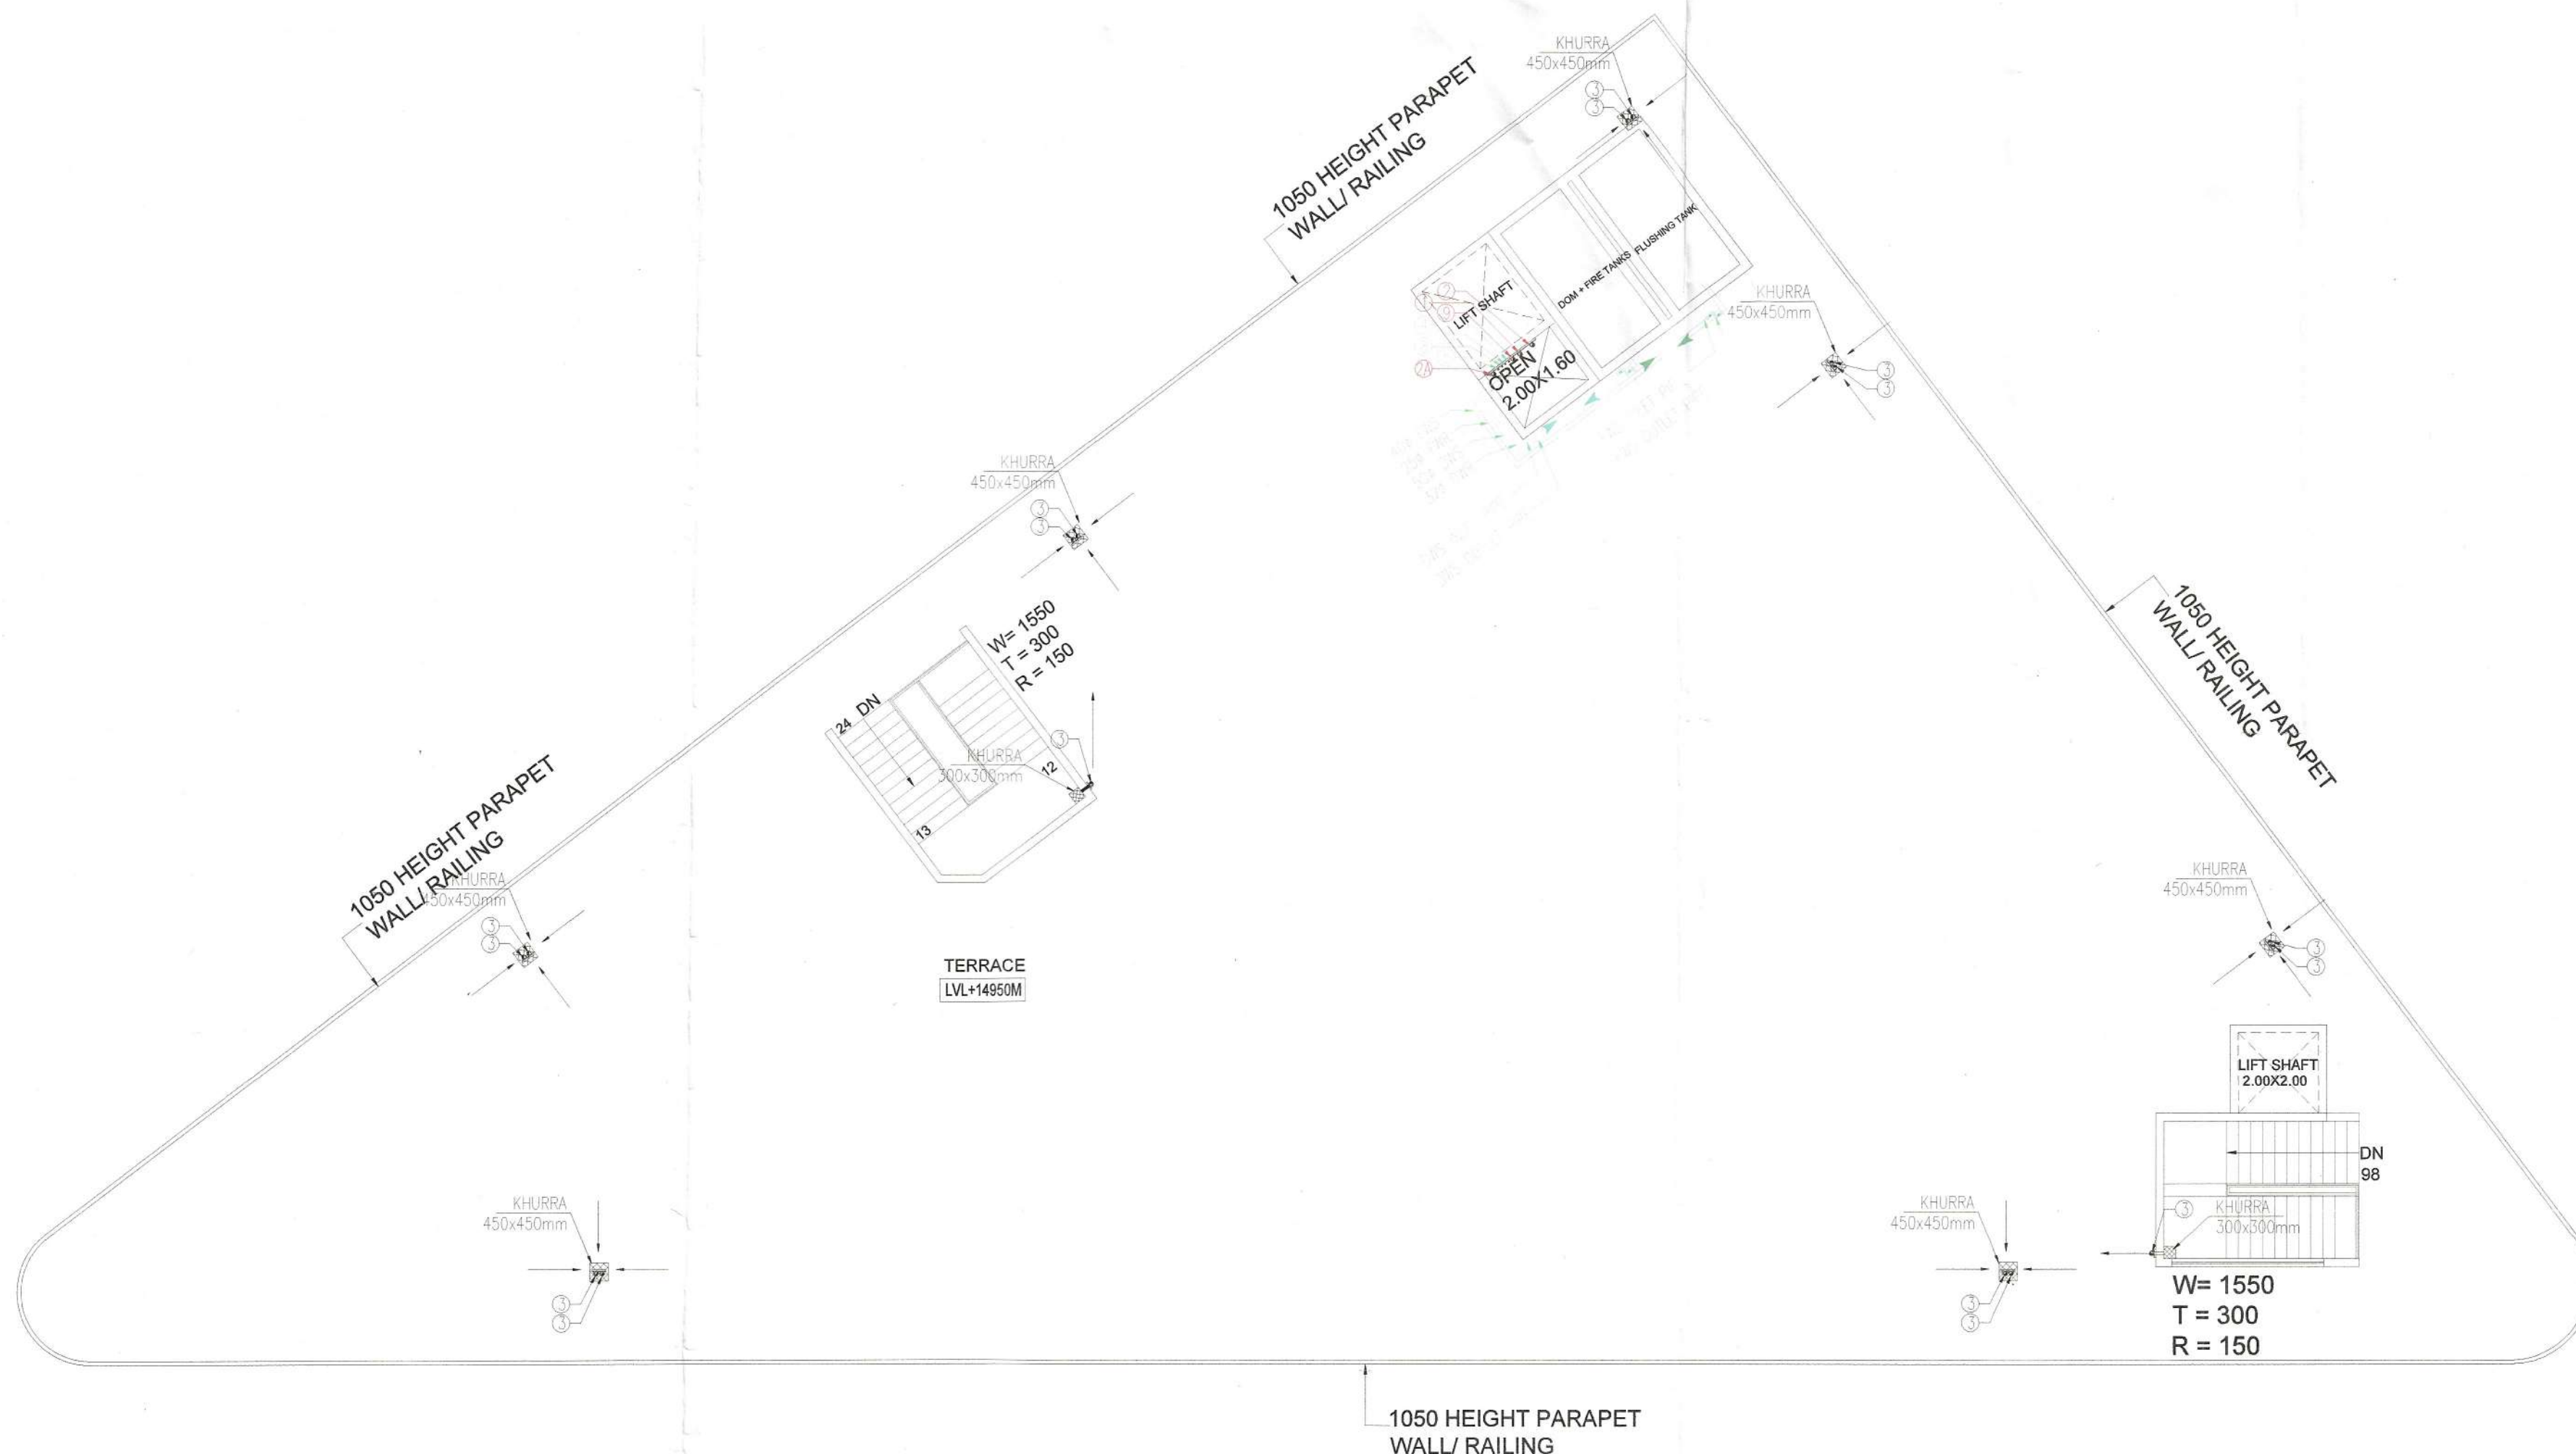TERRACE & MUMTY FLOOR							
NON FAR AREA							
			A	B	C		
B1	1	A X B	3.300	4.950		16.335	SQM.
B2	1	1/2(A+C) X B	4.420	0.700	4.950	3.280	SQM.
B3	1	A X B	4.772	4.629		22.090	SQM.
B4	1	1/2(A+C) X B	7.033	1.880	5.615	11.889	SQM.
B5	1	A X B	1.520	7.033		10.690	SQM.
TOTAL NON -FAR						64.283	SQM.



TERRACE AREA DIAGRAM

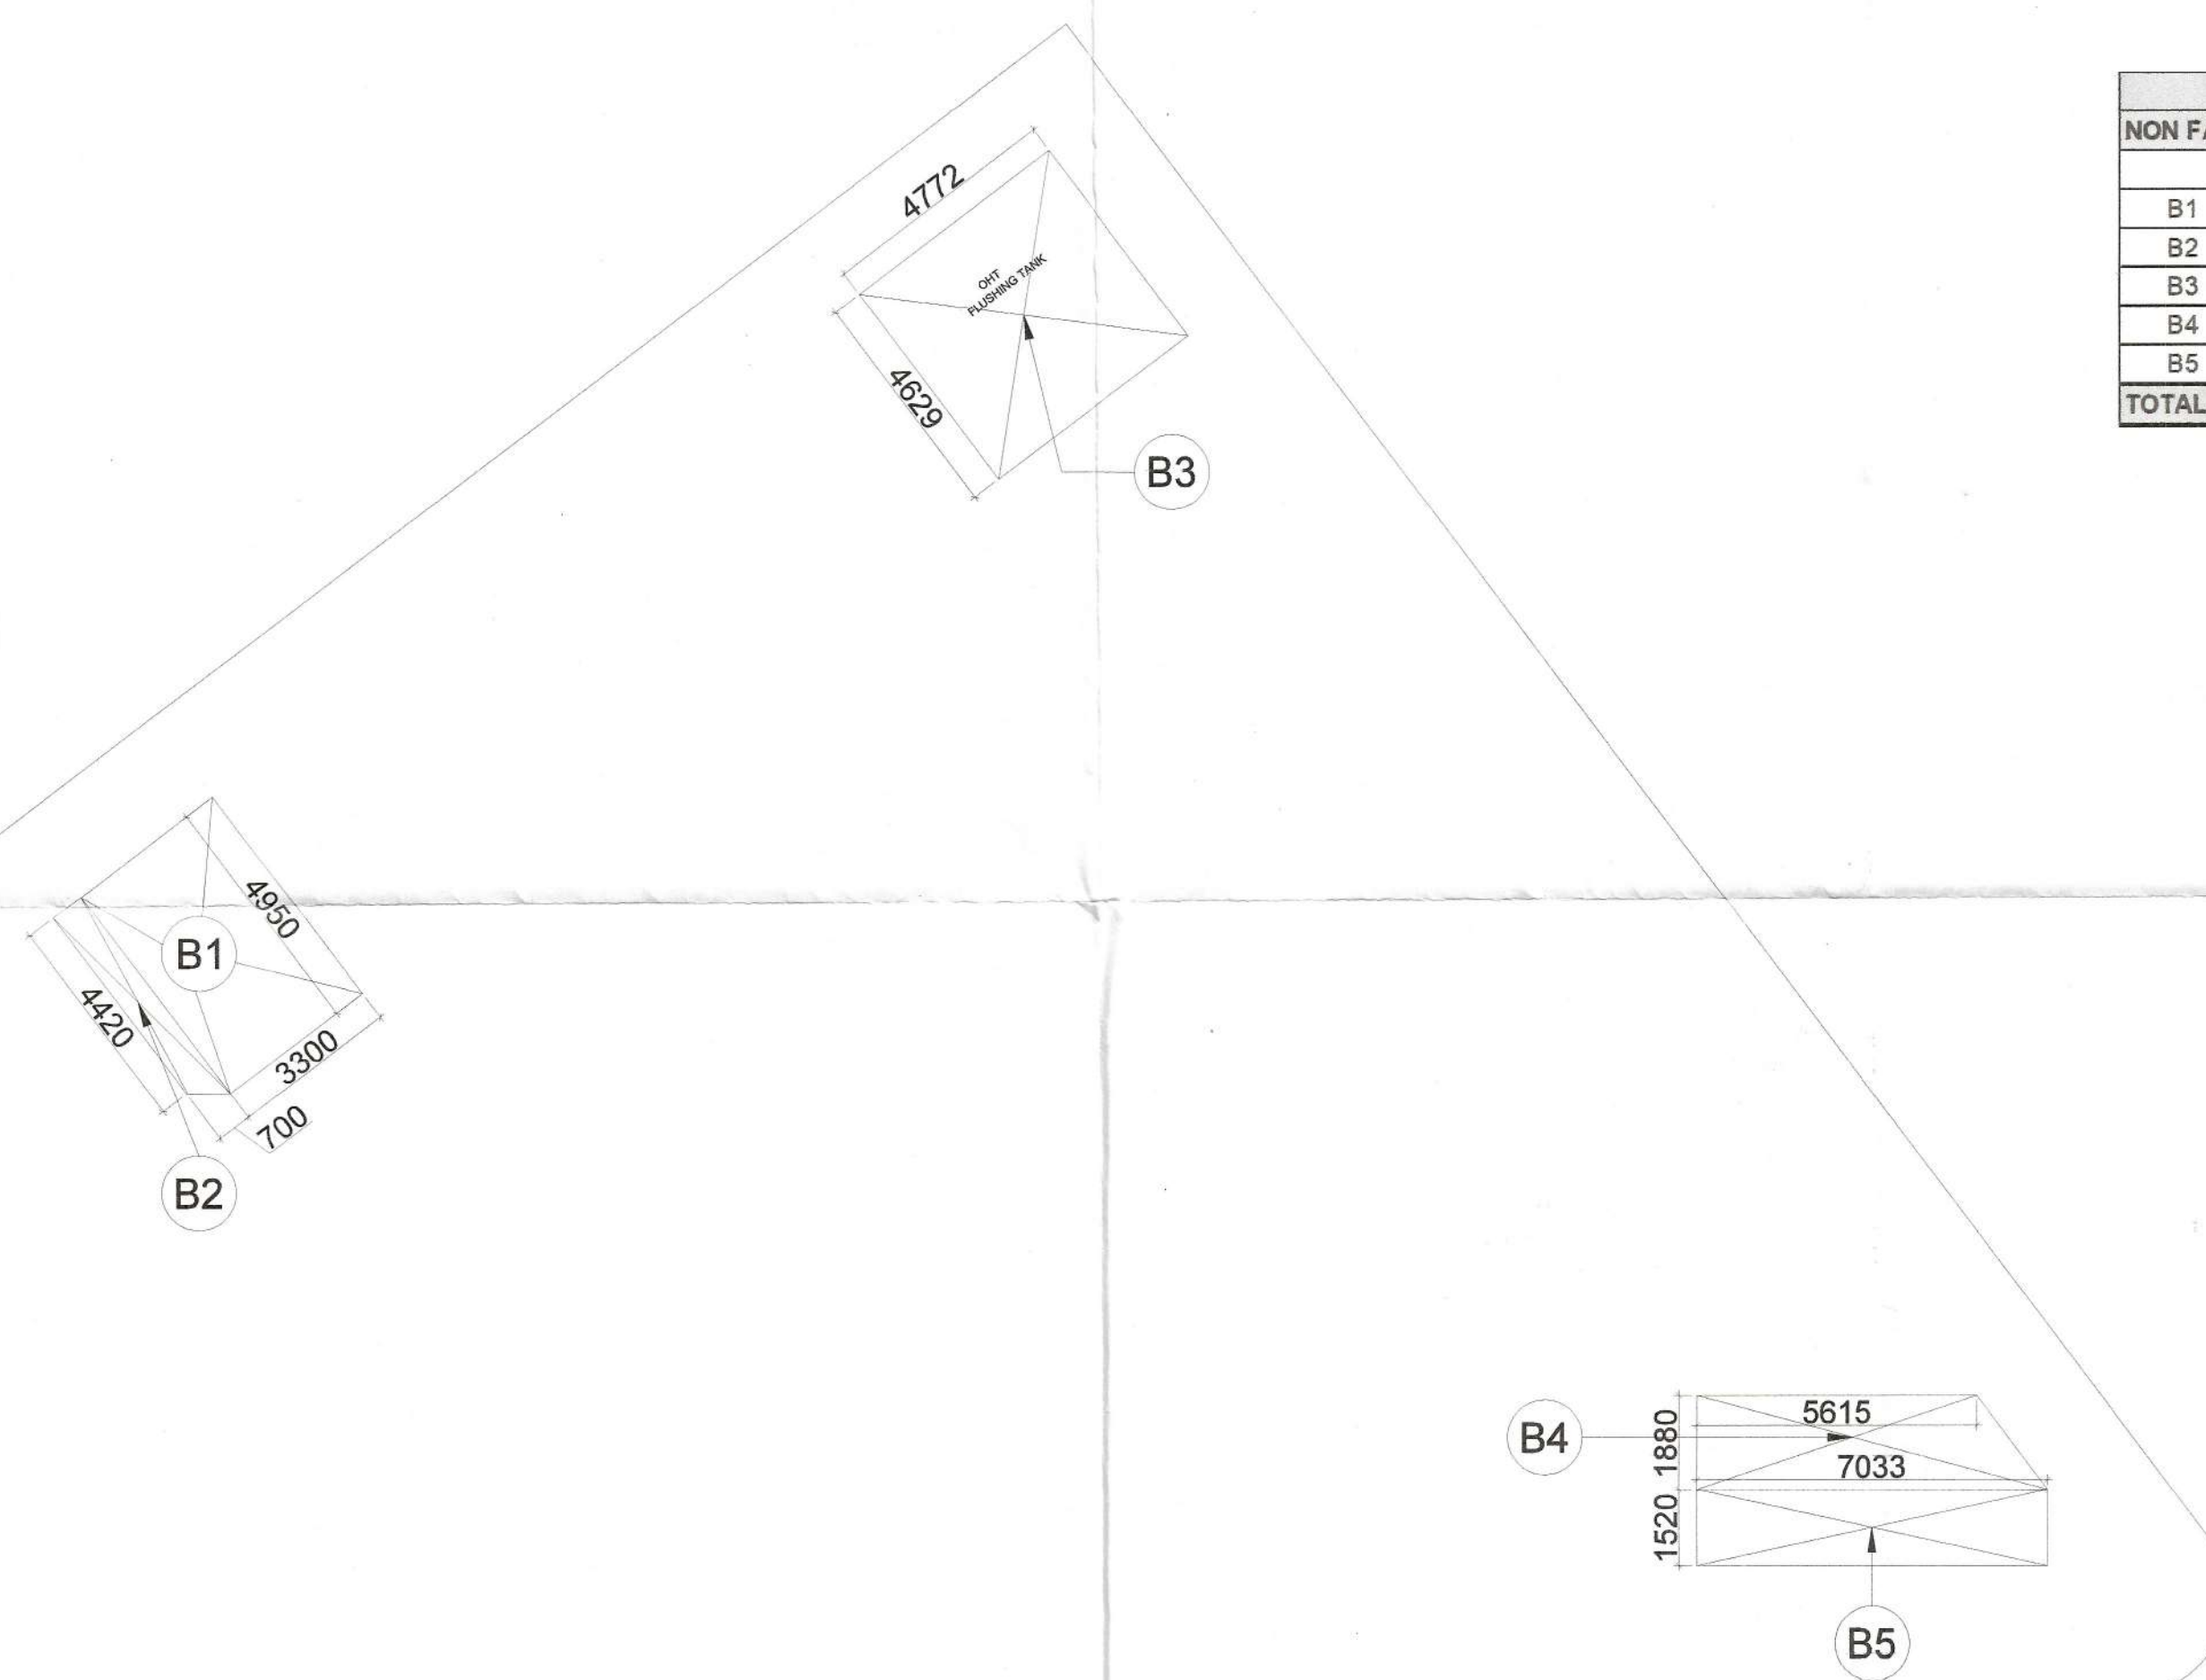PLUMBING LEGEND:-	
①	1100 SOIL PIPE
②	1100 WASTE PIPE
③	1100 RAIN WATER PIPE
④	DWS DN TAKE PIPE
④A	DWS FROM BOOSTER PUMP FOR TOP TWO FLOOR
⑤	FWS DN TAKE PIPE
⑥	1100 BALCONY DRAIN PIPE
⑦	Ø DOMESTIC WATER SUPPLY RISER
⑧	Ø FLUSHING WATER SUPPLY RISER
⑨	750 ANTISYPHONAGE PIPE
WB TO FT	400 WASTE PIPE
SINK TO FT	500 WASTE PIPE
FD	FLOOR DRAIN WITH GRATING
FT	FLOOR TRAP WITH GRATING
MT	MULTI TRAP WITH GRATING
BD	BALCONY DRAIN WITH GRATING
DWS	DOMESTIC WATER SUPPLY PIPE
FWS	FLUSHING WATER SUPPLY PIPE
DWS	DWS PIPE THROUGH BOOSTER PUMP
⊙	GEYSER TOILET GEYSER 25LTR
⊙	GEYSER KITCHEN GEYSER 6LTR
- P -	BOOSTER PUMP SET FOR TOP TWO FLOOR
⊠	CATCH BASIN 1100x500mm



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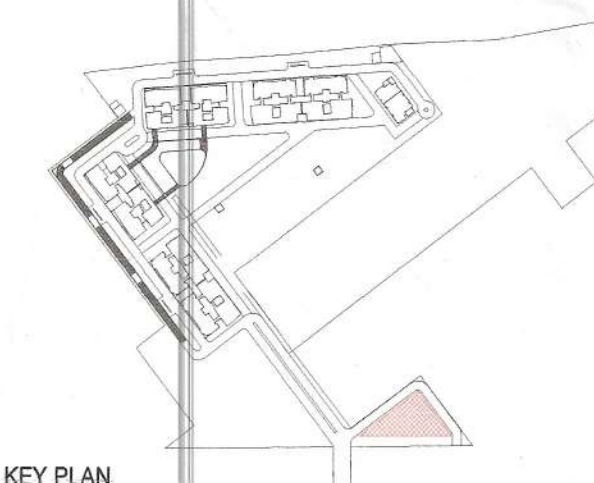
NO. OF PRINTS	DATE	ISSUED TO	REMARKS
REVISION	DATE	DESCRIPTION	BY

GENERAL NOTES

1. All dimensions are in mm unless mentioned otherwise
2. No dimensions are to be scaled from this drawing.

Sanctioned
MEMO NO.: 36075
DATED: 01/12/22

DDA (T)
MEMBER
BPAC
A.T.P.
DINESH KUMAR
PA(HQ)



KEY PLAN

SUBMISSION DRAWINGS

CLIENT:
NOURISH DEVELOPERS PVT. LTD.

PROJECT:
BUILDING PLAN FOR RESIDENTIAL COLONY UNDER TOP POLICY ON THE AREA MEASURING 10.30 ACRES (AFTER FREEZING OF AN AREA MEASURING 5.8125 ACRES (46K-10M) FALLING UNDER NCZ AND NON COMPACT POCKET DUE TO NCZ) (LICENCE NO. 106 OF 2022, DATED 5/8/2022 AT SECTOR-113 DISTRICT GURUGRAM, HARYANA BEING DEVELOPED BY NOURISH DEVELOPERS PVT. LTD

DATE	CHECKED BY	APPROVED BY
SEP. 2022	DEEPAK AGARWAL	
SCALE	DEALT BY	
1:100	LAJJARAM	DEEPAK AGARWAL

COMMERCIAL BLOCK PLAN TERRACE FLOOR PLAN & AREA DIAGRAMS

OWNERS SIGN
Nourish Developers Private Limited
Authorized Signatory
A. P. Deptt.

Building Plans have been checked and found in order as per Public Health Services point of view.


Executive Engineer-V,
Sew. Division, GMDA,
Gurugram
Executive Engineer-IV
Infra-II, Gurugram Metropolitan Development Authority
Gurugram

Executive Engineer-III
Drainage Division, GMDA,
Gurugram

Executive Engineer (P), GMDA
Nodal officer for reports to

Chief Engineer,
(Infra-II), GMDA
Gurugram

ARCHITECT'S SIGN

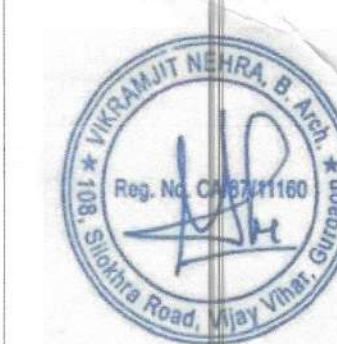

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DRAWING NO.	DRG. NO.
21020/SWD-113/SUB/LATEST/COMMERCIAL/A-TR01	48
CAD NO.	