


DOOR WINDOW SCHEDULE

TYPE	WIDTH	HEIGHT	SILL LVL.	UNTEL LVL.
D1	1000	2400	+00	2400
D2	900	2400	+00	2400
D3	750	2400	+00	2400
DW1	1200	2400	+00	2400
DW2	1200	2400	+00	2400
DW3	650	2400	00	2400
DW4	800	2100	300	2400
DW5	2200	2100	300	2400

LEGEND:-

SYMBOL	DESCRIPTION
①	110 ØD UPVC SOIL & WASTE VENT PIPE
②	110 ØD UPVC WASTE & VENT PIPE
③	110 ØD UPVC RAIN WATER PIPE FOR BALCONY
④	110 ØD UPVC RAIN WATER PIPE FOR TERRACE
⑤	110 ØD UPVC SOIL PIPE
⑥	110 ØD UPVC WASTE PIPE
⑦	50 ØD UPVC WASTE PIPE
⑧	50 ØD UPVC WASTE PIPE
⑨	25 ØD POTABLE DOMESTIC WATER SUPPLY LINE TO O.B.T.
(CRS D)	DOMESTIC WATER SUPPLY PIPE
⑩	DOMESTIC WATER SUPPLY PIPE FROM O.B.T. TO 1ST TO 4TH FLOOR
⑪	DOMESTIC WATER SUPPLY PIPE FROM O.B.T. TO 1ST TO 4TH FLOOR
P1	DOMESTIC (TREATED) WATER PUMP
PV	PRESSURE VESSEL
NT	NANI TRAP
MT	MELT TRAP
FD	FLOOR DRAIN
WPT	150X150 mm CUTOUT FOR FLOOR TRAP
WPC	200X200 mm CUTOUT FOR WC

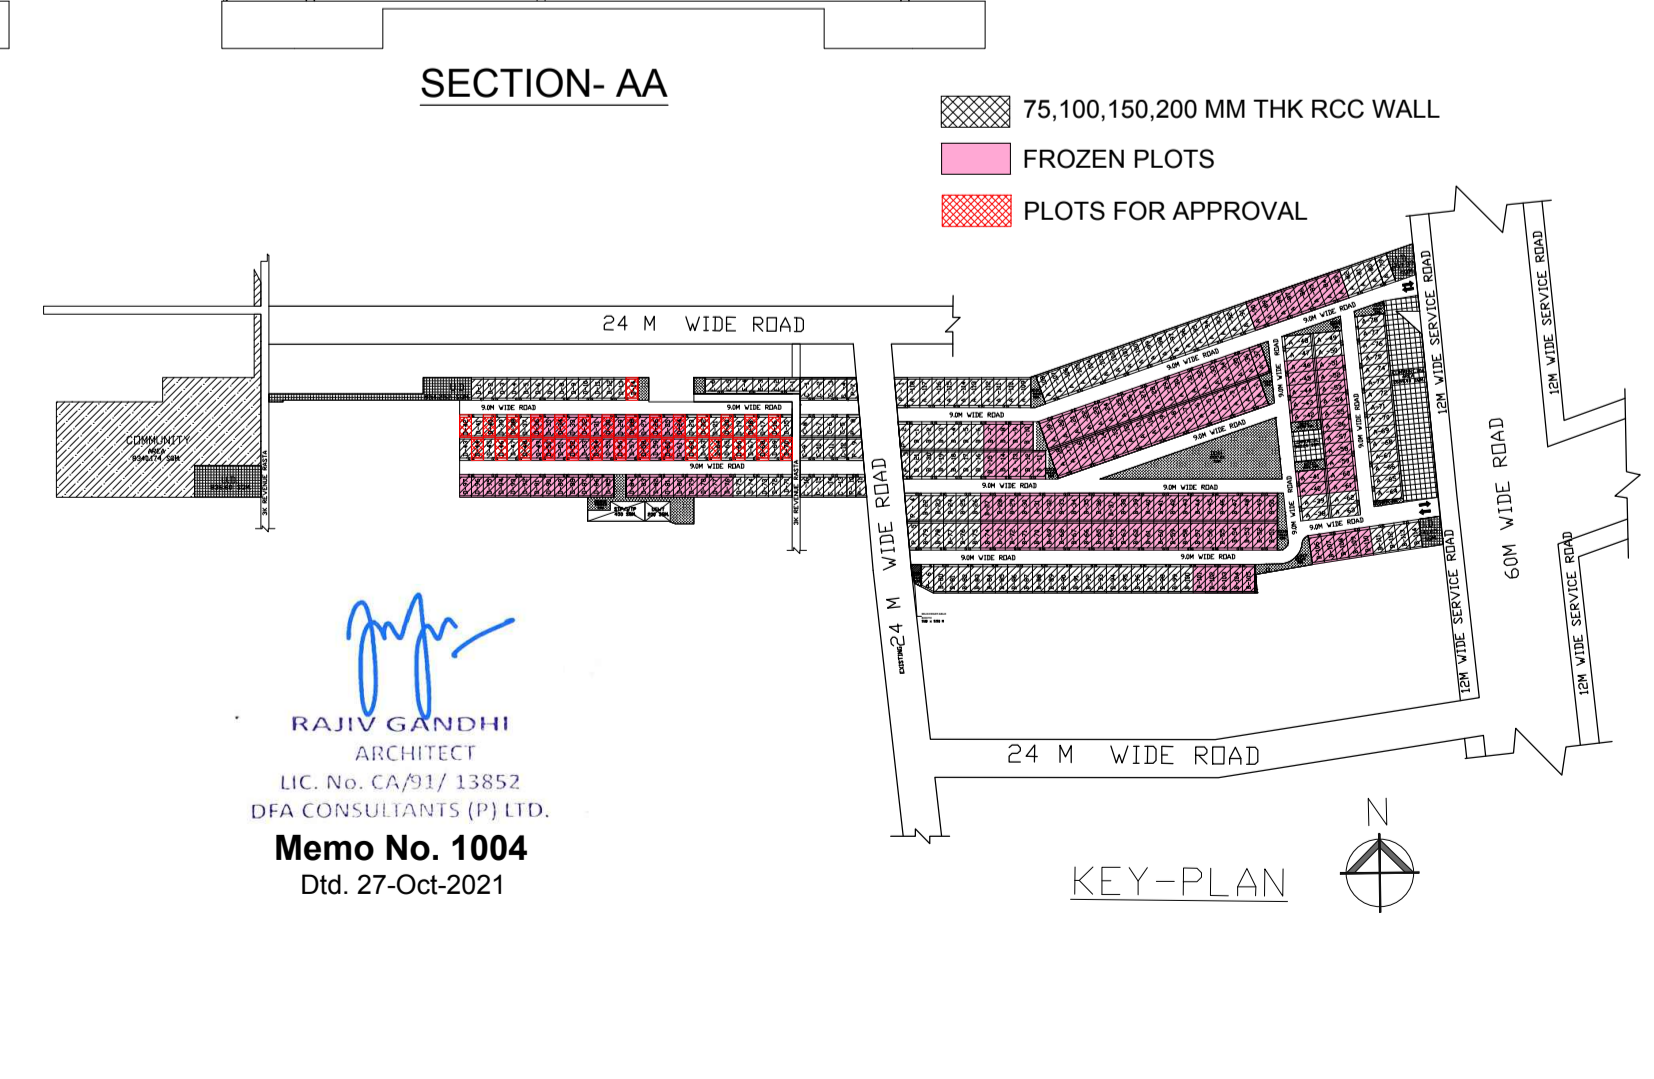

AREA CALCULATION

DESCRIPTION	AREA	UNIT	IN%
PLOT AREA (7.500X14.375M)	107.8125	SQMT.	100%
PERM. GROUND COVERAGE @68% OF PLOT AREA	71.156	SQMT.	66.00
PROPOSED GROUND COVERAGE	71.148	SQMT.	65.99
PERMISSIBLE F.A.R @ 264% OF PLOT AREA	284.625	SQMT.	264.00
PROPOSED F.A.R	254.204	SQMT.	236.78

AREA OF STILL FLOOR (GROUND COVERAGE)

S.No.	LENGTH (IN M.)	WIDTH (IN M.)	AREA	SQMT.
A	7.500	11.325	84.938	SQMT.
TOTAL (a)			84.938	SQMT.
1	2.850	1.925	5.500	SQMT.
2a	1.575	1.700	2.680	SQMT.
2b	1.575	0.375	0.589	SQMT.
3a	2.540	1.850	4.700	SQMT.
3b	2.460	0.950	2.337	SQMT.
TOTAL (b)			13.792	SQMT.
NET GROUND COVERAGE ON STILL FLOOR (a-b) = c			71.146	SQMT.

AREA OF TYPICAL FLOOR (FIRST FLOOR TO FOURTH FLOOR)

S.No.	LENGTH (IN M.)	WIDTH (IN M.)	AREA	SQMT.
A	7.500	11.325	84.938	SQMT.
TOTAL (a)			84.938	SQMT.
1	2.850	1.925	5.500	SQMT.
2a	1.575	1.700	2.680	SQMT.
2b	1.575	0.375	0.589	SQMT.
3a	2.540	1.850	4.700	SQMT.
3b	2.460	0.950	2.337	SQMT.
4 (Staircase)	2.060	3.705	7.636	SQMT.
TOTAL (b)			21.362	SQMT.
FAR AREA OF TYPICAL FLOOR (a-b) = c			63.576	SQMT.
TOTAL FAR AREA OF FIRST TO FOURTH (4 Nos. Floor X (a))			254.204	SQMT.

AREA OF BASEMENT FLOOR

S.No.	LENGTH (IN M.)	WIDTH (IN M.)	AREA	SQMT.
A	7.500	11.875	88.963	SQMT.
TOTAL (a)			88.963	SQMT.

TOTAL BUILT UP AREA

DESCRIPTION	AREA	SQMT.
COVERAGE AT STILL FLOOR-FLOOR AREA (FIRST TO FOURTH) + BASEMENT + STAIRCASE X 4 Nos. (71.146x24.204+88.963x4.365 X 4)	444.793	SQMT.

PROJECT NAME & ADDRESS
 PROPOSED BUILDING PLAN ON PLOT NO. - D-24, D-26, D-28, D-30, D-32, D-34, D-36, D-50, D-52, D-54, D-56, D-58, D-60, (13 FROZEN PLOTS), D-14, D-16, D-18, D-20, D-22, D-38, D-40, D-42, D-44, D-46, D-62, D-64, D-66, D-68, D-70, (16 PLOTS)
 FOR RESIDENTIAL PLOTTED COLONY UNDER DEEN DAYAL JAN AWAS YOJNA SCHEME -2016 IN SECTOR-61, GURUGRAM (HR.), LAND MEASURING 20.60902 ACRES. BEING DEVELOPED BY SUPOSHAA REALCON PRIVATE LIMITED.

OWNER'S NAME
 M/s. SUPOSHAA REALCON PRIVATE LIMITED.

DRAWING TITLE
 TYPE: D - FLOOR PLANS WITH AREA CALCULATION, ELEVATIONS & SECTIONS (LEFT SIDE)

ARCHITECT SIGNATURE
 RAJIV GANDHI ARCHITECT
 LIC. No. CA/91/13852
 DFA CONSULTANTS (P) LTD.

AUTHORIZED SIGNATORY

DATE:
 SHEET- 01 OF 01
 SCALE 1:100