


**MUMTY BUILT-UP AREA CALCULATION**


S.No.	NAME	SHAPE	LENGTH (L)	WIDTH (B)	HEIGHT (H)	FORMULA	AREA	QUANTITY	TOTAL AREA
<b>1. ADDITION - XX</b>									
							1934.94		
S.No.	NAME	SHAPE	LENGTH (L)	WIDTH (B)	HEIGHT (H)	FORMULA	AREA	QUANTITY	TOTAL AREA
1	A	Rectangle	7.550	8.400	-	L X B	63.420	1	63.420
							<b>1. TOTAL ADDITION</b>		<b>63.420</b>
<b>2. DEDUCTION - YY</b>									
1	1	Rectangle	2.000	2.500	-	L X B	5.000	2	10.000
2	2	Rectangle	2.200	3.300	-	L X B	7.260	1	7.260
3	3	Rectangle	2.350	0.600	-	L X B	1.410	1	1.410
4	4	Rectangle	1.200	0.600	-	L X B	0.720	1	0.720
							<b>2. TOTAL DEDUCTION</b>		<b>19.390</b>
<b>MUMTY FLOOR BUILT-UP AREA</b>							<b>ADDITION (XX) - DEDUCTION (YY)</b>		<b>SQM</b>
							44.030		<b>SQM</b>

**MACHINE ROOM & OVERHEAD TANK BUILT-UP AREA CALCULATION**


S.No.	NAME	SHAPE	LENGTH (L)	WIDTH (B)	HEIGHT (H)	FORMULA	AREA	QUANTITY	TOTAL AREA
<b>1. ADDITION - XX</b>									
1	A	Rectangle	8.750	8.400	-	L X B	73.500	1	73.500
<b>MACHINE ROOM &amp; OVERHEAD TANK BUILT-UP AREA</b>							73.500		<b>SQM</b>

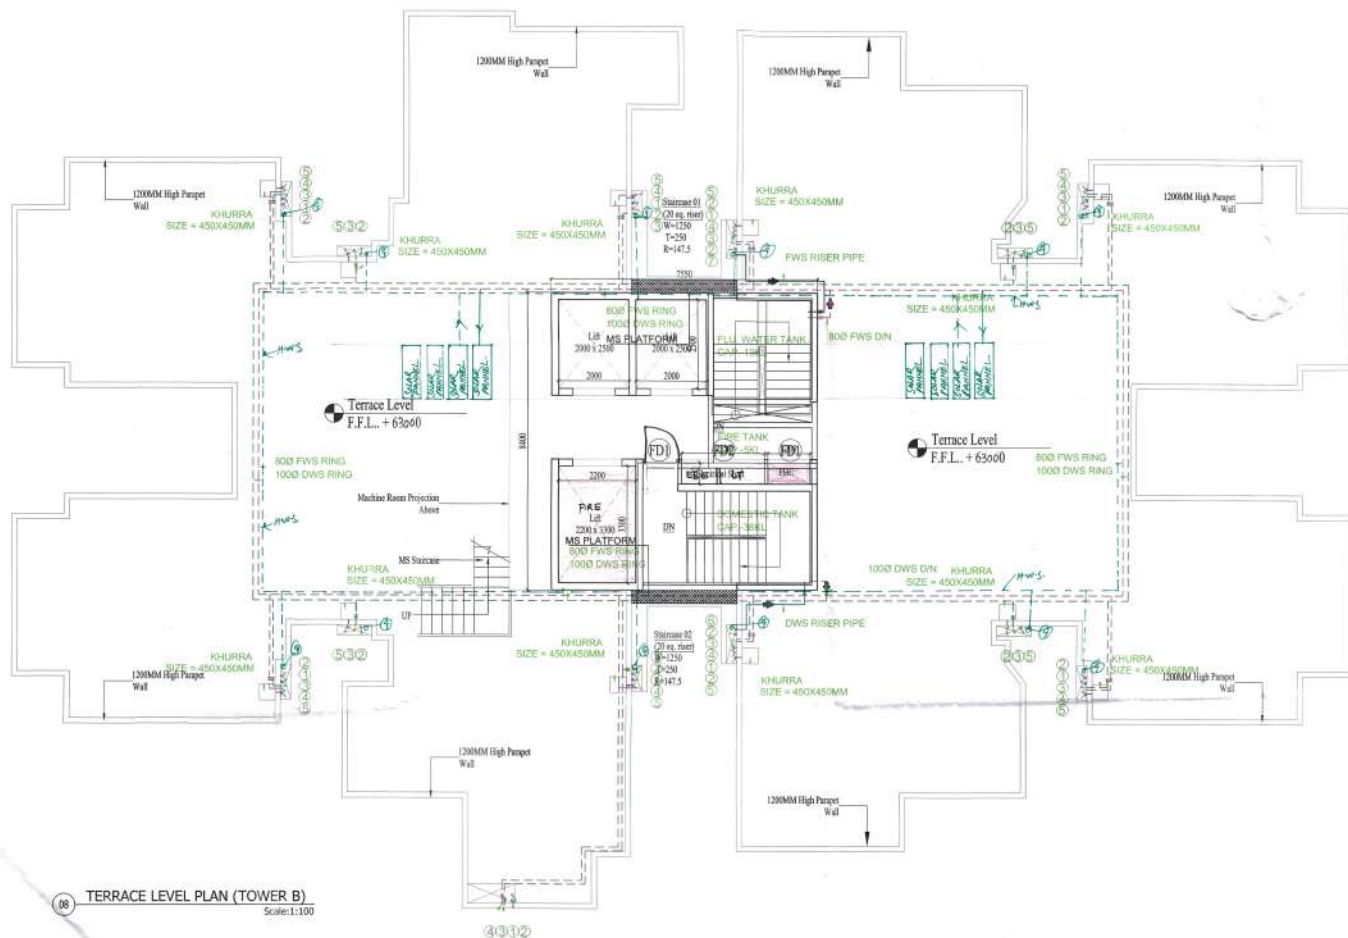


08 TERRACE LEVEL PLAN (TOWER B) Scale: 1:100

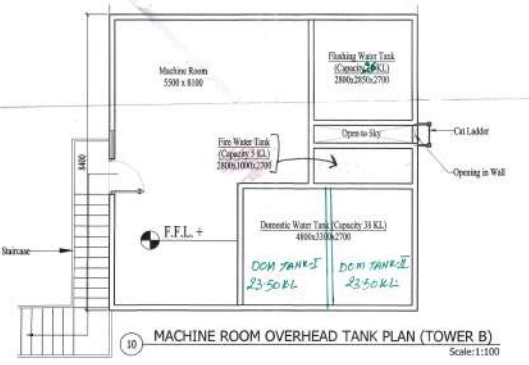

10 MACHINE ROOM OVERHEAD TANK PLAN (TOWER B) Scale: 1:100

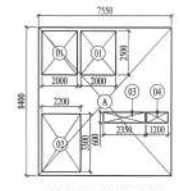

11 MUMTY BUILT UP Scale: 1:200

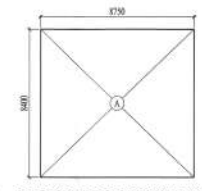

12 MACHINE ROOM TANK BUILT UP Scale: 1:200

**DOOR WINDOW SCHEDULE**

Sl.No.	Type	Opening Size	Cl Level	Level Level	Description
01	D1	750x2100	00	2350	Toilet
02	D2	750x2100	150	2350	Bathroom
03	D3	900x2100	00	2350	Bedroom
04	D4	1050x2100	150	2350	Entrance Lobby
05	D5	1075x2100	150	2350	Entrance Lobby
06	S01	1160x2050	150	2350	Bathroom
07	S02	1300x2050	150	2350	Bathroom
08	S03	1450x2050	150	2350	Bathroom
09	S04	1650x2050	150	2350	Bathroom
10	S05	1800x2050	150	2350	Bathroom
11	S06	2100x2050	150	2350	Bathroom
12	W1	750x1200	800	2350	Bedroom
13	V1	400x650	1200	2350	Toilet
14	V2	800x650	1200	2350	Toilet
15	FD1	750x1800	450	2350	LV Shaft
16	FD2	900x1800	450	2350	PHC
17	FD3	1200x2250	00	2350	Staircase
18	FD4	1500x2100	150	2350	Vertical Shaft

- SCHEDULE OF PIPES**
- PIPE NO. DESCRIPTION
- (1) 110 uPVC SOIL PIPE
  - (2) 110 uPVC WASTE PIPE
  - (3) DOMESTIC WATER SUPPLY PIPE
  - (4) FLUSHING WATER SUPPLY PIPE
  - (5) 110 OD uPVC RAIN WATER PIPE
  - (6) DOMESTIC WATER RISER PIPE
  - (7) FLUSHING WATER RISER PIPE
  - (8) 75 OD uPVC RAIN WATER PIPE
  - (9) HOT WATER SUPPLY.

- PLUMBING NOTE-**
1. WASH BASIN TO FLOOR TRAP (FT)
  2. 45 OD uPVC WASTE PIPE
  3. FLOOR DRAIN (FD) TO FLOOR TRAP (FT)
  4. 63 OD uPVC WASTE PIPE
  5. 110 OD uPVC PIPE USED FOR SOIL & WASTE
- FT FLOOR TRAP (100 x 100) MM  
 FD FLOOR DRAIN (100 x 83) MM  
 MT MULTRY TRAP (100 x 50) MM  
 BD BALCONY DRAIN (100 x 50) MM

**PRINCIPAL ARCHITECT:**

DESIGN FORUM INTERNATIONAL

E-47, KAILASH COLONY, NEW DELHI-110048  
 PHONE NO. 011-4655600

**OWNER'S SIGNATURE** **ARCHITECT'S SIGNATURE**

For GLS INFRACON PVT. LTD. ANOTEVATIA B. Arch (Hons) CA-9519239

**CLIENT:** MS GLS INFRACON PVT. LTD.

**PROJECT:** PROPOSED PLAN OF AFFORDABLE GROUP HOUSING COLONY FOR AN AREA MEASURING 5.683 ACRE (LICENSE NO. 34 OF 2020 DATED 30/10/2020) BY SECTOR-81, GURUGRAM MANESAR URBAN COMPLEX BEING DEVELOPED BY SMT. GEETA YADAV W/O SH. SUMAN KUMAR AND OTHERS IN COLLABORATION WITH GLS INFRACON PVT. LTD.

**DRAWING TITLE:** Tower - B Floor Plans, Area Diagrams & Area Chart

**SHEET NO.** 06b

SCALE: DATE: