


ROADS

1

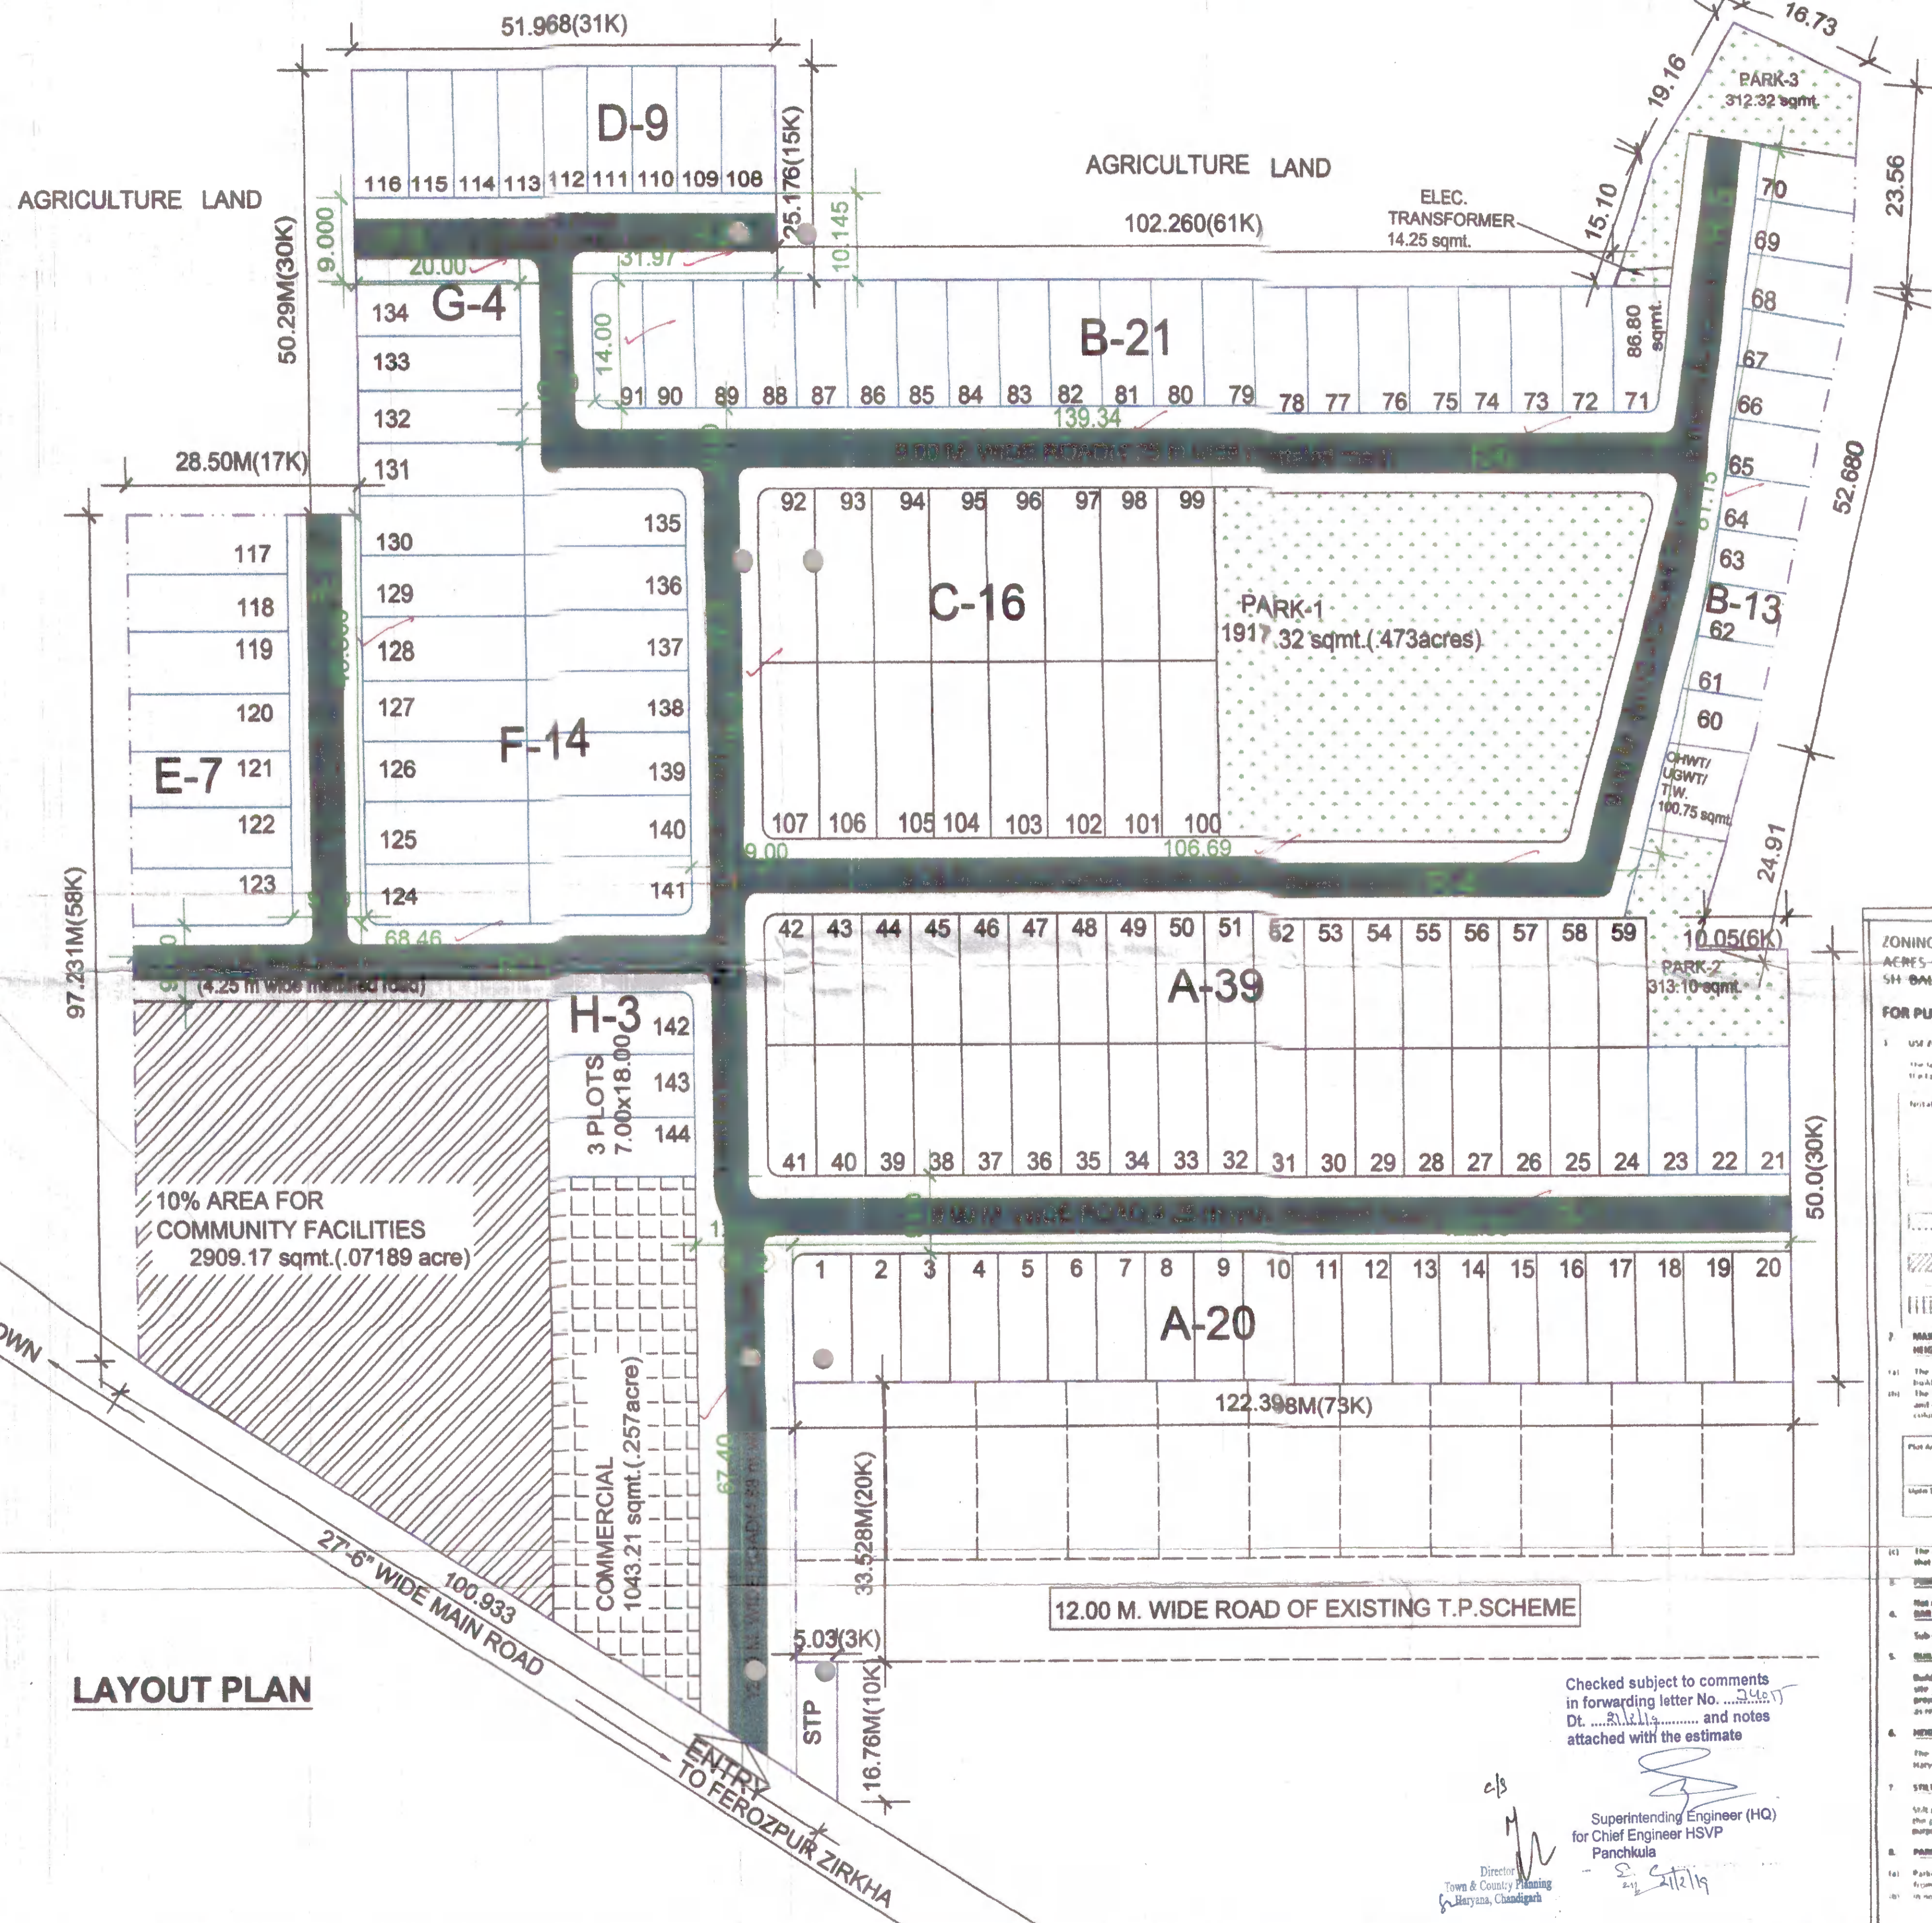

ZONING PLAN OF AFFORDABLE RESIDENTIAL PLOTTED COLONY (UNDER DEEN DAYAL JAN AWAS YOJNA) AREA MEASURING 7.1875 ACRES H.NO. 48 OF 2018 DATED 21.06.2018 IN SECTOR TO FEROPUR JIRKHA, DISTRICT MEWAT BEING DEVELOPED BY SH. BALDEV PARKASH AND OTHERS IN COLLABORATION WITH SH. VIJAY KUMAR.

FOR PURPOSE OF CODE 1.2 (KCVI) & 6.1 (1) OF THE HARYANA BUILDING CODE, 2017, AS AMENDED FROM TIME TO TIME.

1. USE ZONE
 The land shall be used for the purpose as indicated in the zoning plan with the following regulations in that order of priority:

| Use | Permissible use of land in the portion of the plot marked in column 1 | Type of building permissible on land marked in column 2 |
|-------------|---|---|
| Residential | Residential | Residential building |
| Public | Public | Public building |
| Commercial | Commercial | Commercial building |

2. MAXIMUM PERMISSIBLE GROUND COVERAGE, FLOOR AREA RATIO (FAR) AND MAXIMUM PERMISSIBLE HEIGHT / INCLINATION OF ROOF

| Plot Area | Maximum Permissible Ground Coverage | Permissible Basement | Permissible Floor Area Ratio (FAR) | Maximum Permissible Height (E+J Floor) (Including 1st Deck Height) (in meters) |
|---------------|-------------------------------------|----------------------|------------------------------------|--|
| Up to 100 sqm | 60% | Single level | 20% | 13.00 |

3. PARKING
 The parking shall be provided as per the provisions of Haryana Building Code, 2017 as amended from time to time.

4. STAIRS
 The stairs shall be provided as per the provisions of Haryana Building Code, 2017 as amended from time to time.

5. ELEVATION
 The elevation of the building shall be as per Haryana Building Code, 2017.

6. BOUNDARY WALLS
 The boundary wall shall be constructed as per Haryana Building Code, 2017.

7. GATE AND GATE POST
 The gate and gate post shall be constructed as per approved standard design, at the position indicated on the plan.

8. DISPLAY OF PORTAL NUMBER OF THE PLOT
 The portal number and postal address shall be written at the spot shown for this purpose on the standard design of the gate as per approved design.

9. GARBAGE COLLECTION POINT
 Every plot holder shall make adequate provision for garbage collection in his own plot and make suitable arrangement for disposal at the suitable collection point to be provided by the authority.

10. ACCESS
 No plot or building shall have an access from less than 9.00 meters width road.

11. GENERAL
 That the colonizer/owner shall use only Light Emitting Diode tubes (LED) fitting for internal lighting as well as Campus lighting.

12. THAT THE COLONIZER/OWNER SHALL STRICTLY COMPLY WITH THE DIRECTIONS ISSUED UNDER NOTIFICATION No. 154/2006-SP dated 21.03.2006 issued by Haryana Government Renewable Energy Department, if applicable.

13. THAT THE COLONIZER/OWNER SHALL ENSURE THE INSTALLATION OF Solar Photovoltaic Power Plant as per provisions of Haryana Solar Power Policy, 2016 issued by Haryana Government Renewable Energy Department vide Notification No. 197/2016-P dated 14.01.2016, if applicable.

14. THAT THE COLONIZER/OWNER SHALL ENSURE THE INSTALLATION OF Solar Photovoltaic Power Plant as per the provisions of order No. 1215/2006-SP dated 21.03.2006 issued by Haryana Government Renewable Energy Department, if applicable.

NOTE
 Read this drawing in conjunction with the demarcation plan verified by STP. For detailed site norms no. 3184 dated 05.10.2018.

DWG. NO. DTPC / 445 / DATED 31.10.18

APPROVED BY: [Signatures]

PROJECT :

PROPOSED SITE FOR AFFORDABLE PLOTTED COLONY OVER AN AREA MEASURING 7.1875 ACRES UNDER THE DEEN DAYAL JAN AWAS YOJNA AT FEROPUR ZIRKHA, TEHSIL FEROPUR ZIRKHA, DISTRICT MEWAT, HARYANA. THROUGH AUTH. SIGNATORY :- MR. VIJAY KUMAR S/O SH. CHANDER PARKASH

| | |
|--|--|
| CLIENT | ARCHITECT |
| Vijay Kumar S/o Sh. Chander Parkash For & on behalf of Sh. Baldev Parkash Sh. Vikas Kumar S/o Narash Kumar | AR. SUMAN SHARMA CA/2001/27305 SCO 45, SECTOR-11, PANCHKULA M. 9876119000, 9417055287 |
| Authorised Signatory | Authorised Signatory |

ARC...D ARCHITECTS
 S.C.O.45, SEC.11, PANCHKULA
 M-09876119000, 09417055287
 EMAIL: arcdarchitects@hotmail.com
 arcdarchitects@gmail.com

Executive Engineer
 HSVP, Division Patwal
 SUPERINTENDING ENGINEER
 HSVP CIRCLE, PANCHKULA

ROAD LAYOUT PLAN

LAYOUT PLAN

SCALE: 1:500

| | |
|---------|-------------|
| PROJECT | DRAWING NO. |
| ARC | SB |
| 01 | 01 |

| | | | | | |
|---------|--------|-------|-------|---------|----------|
| CONCEPT | DESIGN | DEALT | DRAWN | CHECKED | DATE |
| SUMAN | PRIYA | CHARU | CHARU | SUMAN | 12-10-18 |

Checked subject to comments in forwarding letter No. 3442/18 Dt. 21.10.18 and notes attached with the estimate

Superintending Engineer (HQ) for Chief Engineer HSVP Panchkula

[Signatures]

LAYOUT PLAN

PROJECT :

PROPOSED SITE FOR AFFORDABLE PLOTTED COLONY OVER AN AREA MEASURING 7.1875 ACRES UNDER THE DEEN DAYAL JAN AWAS YOJNA AT FEROPUR ZIRKHA, TEHSIL FEROPUR ZIRKHA DISTT. MEWAT, HARYANA. THROUGH AUTH. SIGNATORY :- MR. VIJAY KUMAR S/O SH. CHANDER PARKASH

IMP NOTES:-

1. All Soil pipes shall be as I.S. specifications.
2. Backfilling be done in stages, i.e., at least in 2 layers with proper compaction & curing of joints done in cement sand mortar 1 : 1.5
3. For pipe upto depth 1.5 mtrs haunching all round the pipe in 1:5:10 be done, and for more depths further, haunch upto the sides of pipes is recommended.
4. Manholes upto 1.5m depth shall be built in 9" thick brick wall and brick masonry for additional depth shall b13.5" thick and above.
5. All levels are shown in meters.
6. The size of Soil waste Pipe used in the scheme in mm as 200 & 250.
7. The slope of Soil waste Pipe is mentioned in mm.
8. Precaution be taken to avoid mixing of rain water or surface run off with sewer line for effective working of the sewer system.
9. All crossing pipes shall and IC connections has to be of 150 mm size SW Pipe.

ZONING PLAN OF AFFORDABLE RESIDENTIAL PLOTTED COLONY (UNDER DEEN DAYAL JAN AWAS YOJNA) AREA MEASURING 7.1875 ACRES (LICENSE NO. 44 OF 2018 DATED 21.06.2018) IN SECTOR-10, FEROPUR ZIRKHA, DISTRICT MEWAT BEING DEVELOPED BY SH. BALDEV PARKASH AND OTHERS IN COLLABORATION WITH SH. VIJAY KUMAR.

FOR PURPOSE OF CODE 1.2 (K&V) & 6.1 (1) OF THE HARYANA BUILDING CODE, 2017, AS AMENDED FROM TIME TO TIME.

| USE ZONE | PERMISSIBLE USE OF LAND ON THE PORTION OF THE PLOT MARKED IN COLUMN 1 | TYPE OF BUILDING PERMISSIBLE ON LAND MARKED IN COLUMN 2 |
|----------------------------|---|---|
| Road | Road | Road furniture at approved places |
| Public open space | Public open space | To be used only for landscape features. |
| Residential Building (RPH) | Residential Building | Residential building |
| Commercial | Commercial | As per supplementary zoning plan to be approved separately for each site. |

| Plot Area | Minimum Permissible Ground Coverage | Permissible Building Intensity | Maximum Permissible Floor Area Ratio (FAR) | Maximum Permissible Height (5+1 Floor) (Including lift (5+1 Floor) (In meters) |
|-------------------------|-------------------------------------|--------------------------------|--|--|
| Up to 100 square meters | 60% | 100% | 300% | 15.00 |

(1) The villas are permitted parking spaces in residential plots of all sizes, subject to the condition that maximum permissible height of building shall not exceed 15 meters.

(2) **PERMISSIBLE NUMBER OF DWELLING UNITS ON EACH PLOT**
Not more than three dwelling units shall be allowed on each plot.

(3) Sub-division & chocking of the plots shall not be permitted in any circumstances.

(4) **BUILDING SETBACKS**
Building other than boundary wall and gate shall be constructed only in the portion of the site marked as buildable zone in the zoning plan. The maximum permissible height / including with parking on the area of the site mentioned in column 1, according to the table below.


(5) **HEIGHT OF THE BUILDING AND PERMISSIBLE NUMBER OF STOREY**
The maximum height and number of storey shall be allowed on the plot as per provisions of Haryana Building Code, 2017.

(6) **STYLE PARKING**
Vill parking is allowed in all sizes plots. The clear height of the villa shall be 2.80 metres from the ground level and below the bottom of the beam. The villa shall not be permissible for any purpose other than parking.



(7) **PARKING**
Parking shall be provided as per the provisions of Haryana Building Code, 2017 as amended from time to time.

(8) In no circumstance, the vehicles belonging to the plot shall be parked outside the plot area.

| BOQ SWD | Pipe Size/Slope | DEPTHS (in Mtrs.) | | | |
|-----------------------|-----------------|-------------------|---------------|--------------|------------|
| | | (0-1.50) | (0-1.50) | (1.50-3.00) | above 3.00 |
| M1-M2 ✓ | 200/(1:200) | 17.00 ✓ | | | |
| M3-M2 ✓ | 200/(1:200) | 22.50 ✓ | | | |
| M2-M5 ✓ | 200/(1:200) | 32.00 ✓ | | | |
| M6-M8 ✓ | 200/(1:200) | 50.00 ✓ | | | |
| M11-M12 ✓ | 200/(1:200) | 7.00 ✓ | | | |
| M16-M17 ✓ | 200/(1:200) | 25.00 ✓ | | | |
| M17-M20 ✓ | 200/(1:200) | 63.00 ✓ | | | |
| M26-M27 ✓ | 200/(1:200) | 48.00 ✓ | | | |
| M30-M33 ✓ | 200/(1:200) | 66.00 ✓ | | | |
| IC-IC-M36 | 200/(1:200) | 17.00 | | | |
| | | 347.50 | | | |
| M5-M13 ✓ | 200/(1:200) | | 20.00 ✓ | | |
| M8-M12 ✓ | 200/(1:200) | | 63.00 ✓ | | |
| M12-M13 ✓ | 200/(1:200) | | 7.00 ✓ | | |
| M13-M15 ✓ | 200/(1:200) | | 44.00 ✓ | | |
| M20-M24 ✓ | 200/(1:200) | | 103.00 ✓ | | |
| M15-M24 ✓ | 200/(1:200) | | 8.00 ✓ | | |
| M24-M29 ✓ | 200/(1:200) | | 9.00 ✓ | | |
| M27-M29 ✓ | 200/(1:200) | | 56.00 ✓ | | |
| M29-M36 ✓ | 200/(1:200) | | 24.00 ✓ | | |
| M33-M36 ✓ | 200/(1:200) | | 55.00 ✓ | | |
| M36-M37 ✓ | 200/(1:200) | | 9.00 ✓ | | |
| | | | 398.00 | | |
| M37-M39 | 250/(1:260) | | | 49.00 | |
| M39-STP | 250/(1:260) | | | 5.00 | |
| | | | | 54.00 | |
| Connection to SW Line | 150/(1:140) | 0.75x28=21 | | | |
| | | 1.75x45=79 | | | |
| | | 9.25x43=398 | | | |
| | | 498 | | | |

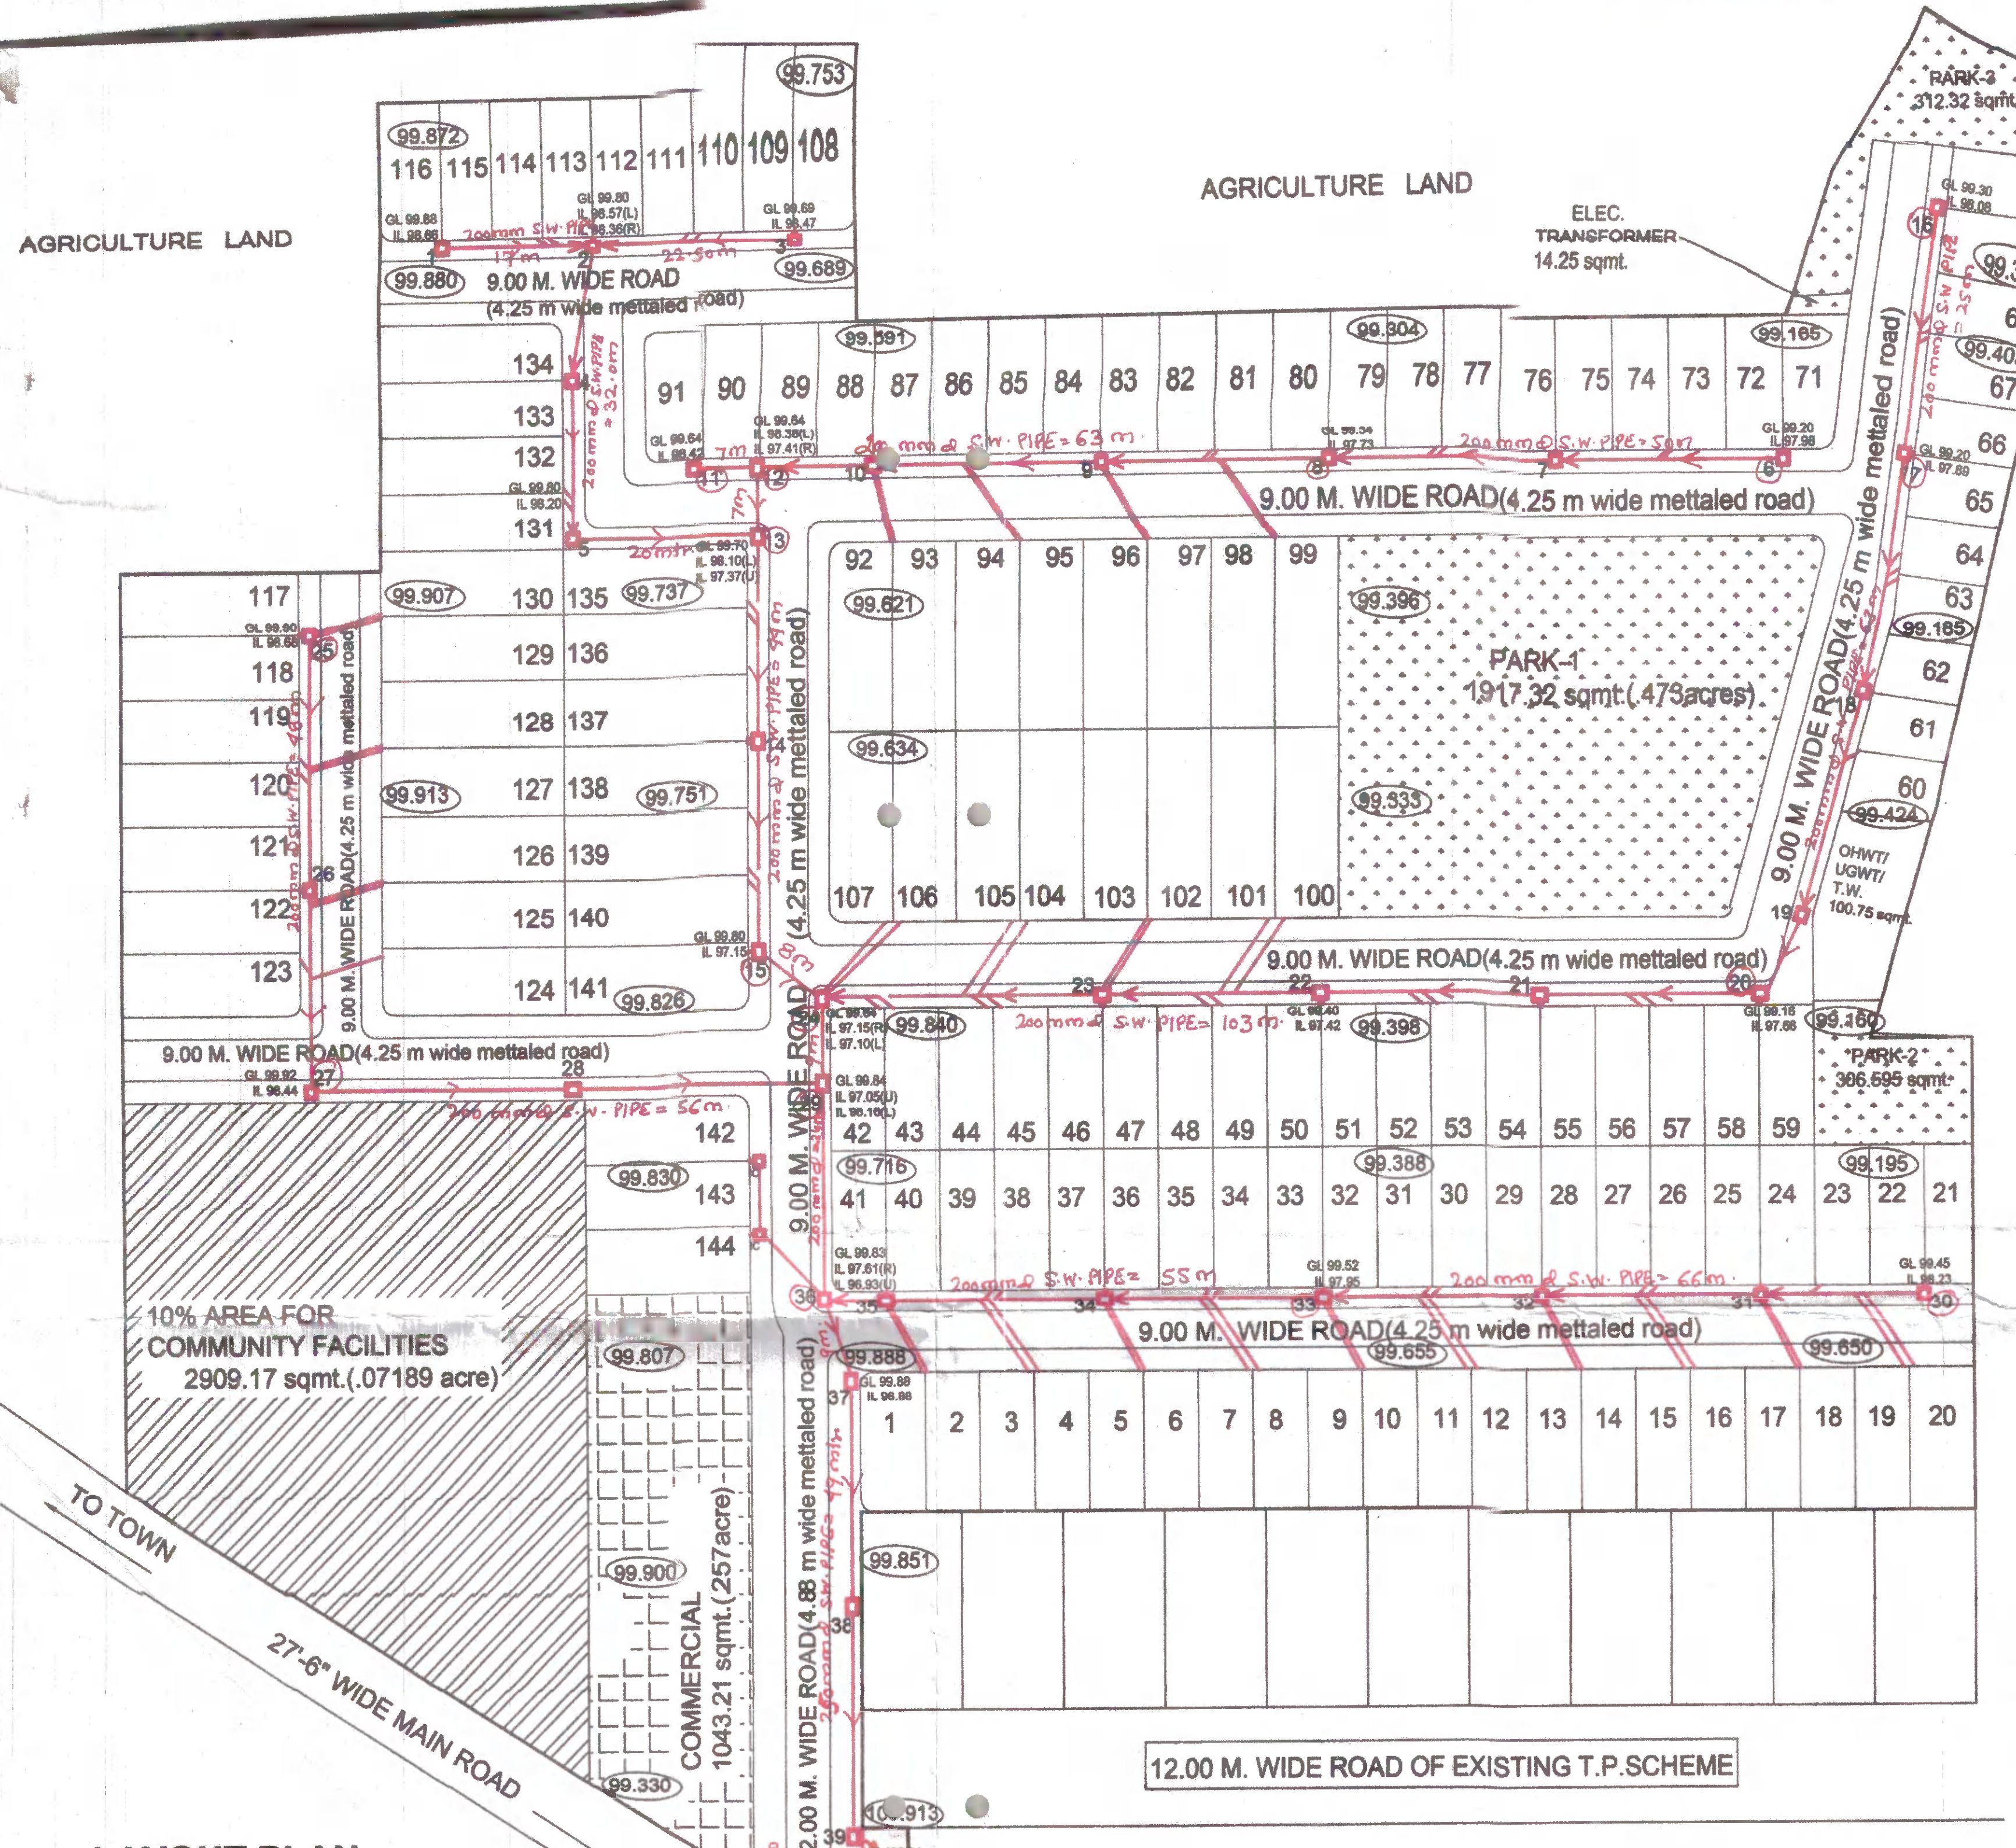

LAYOUT PLAN

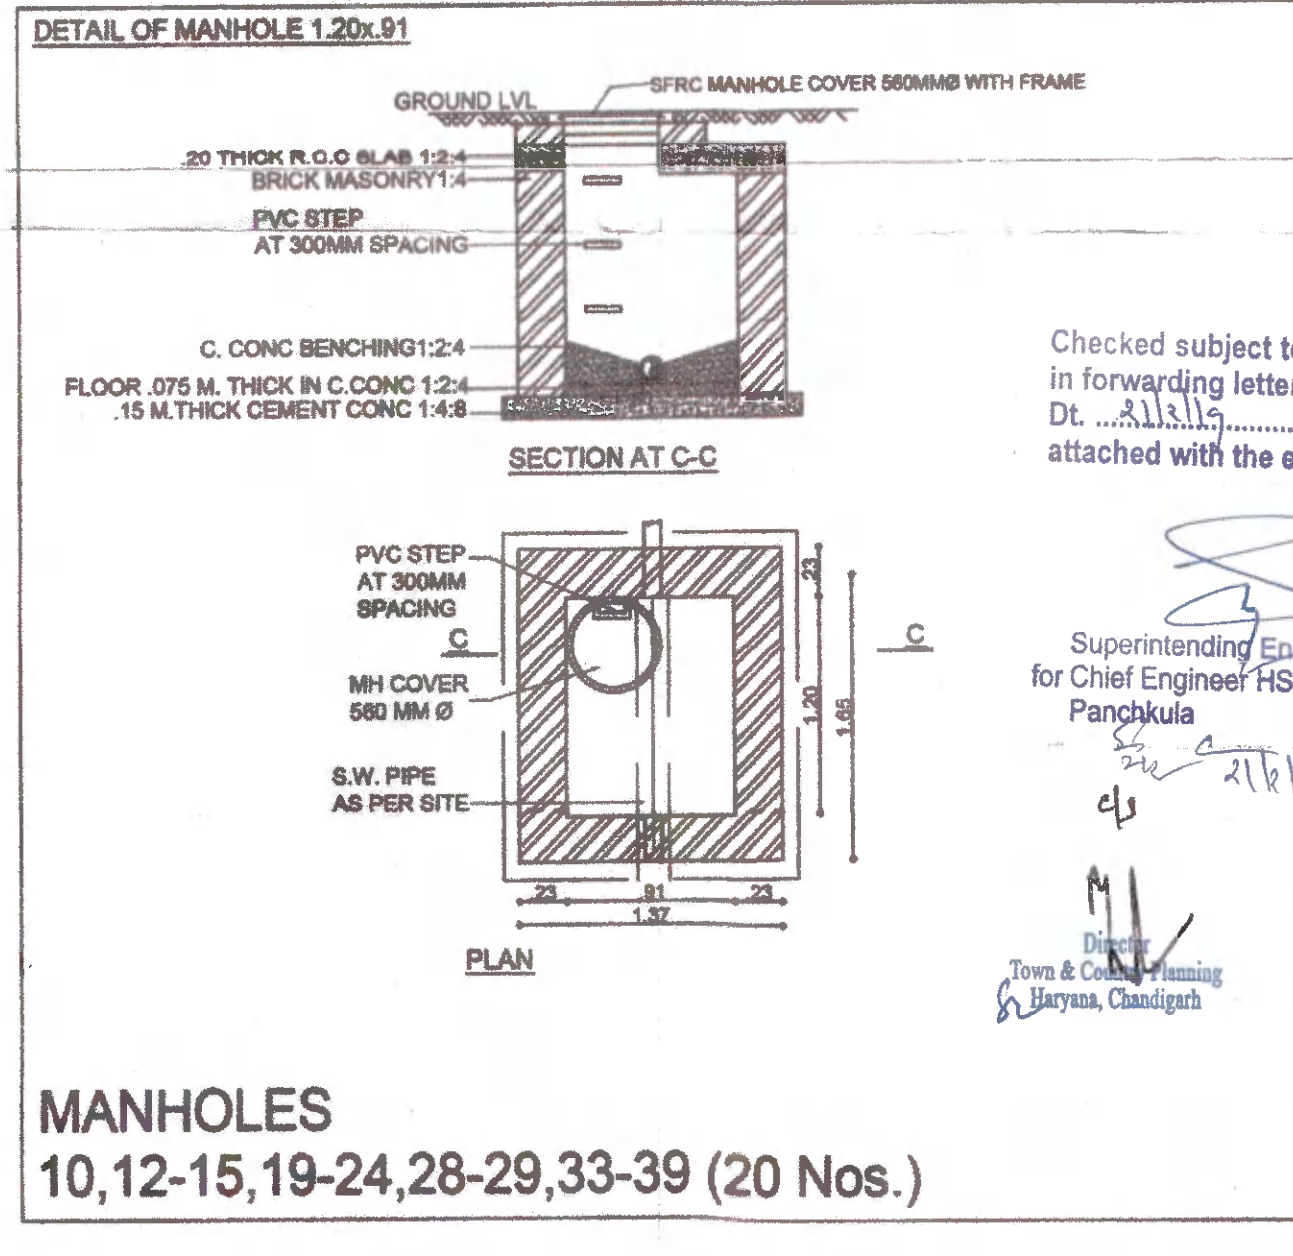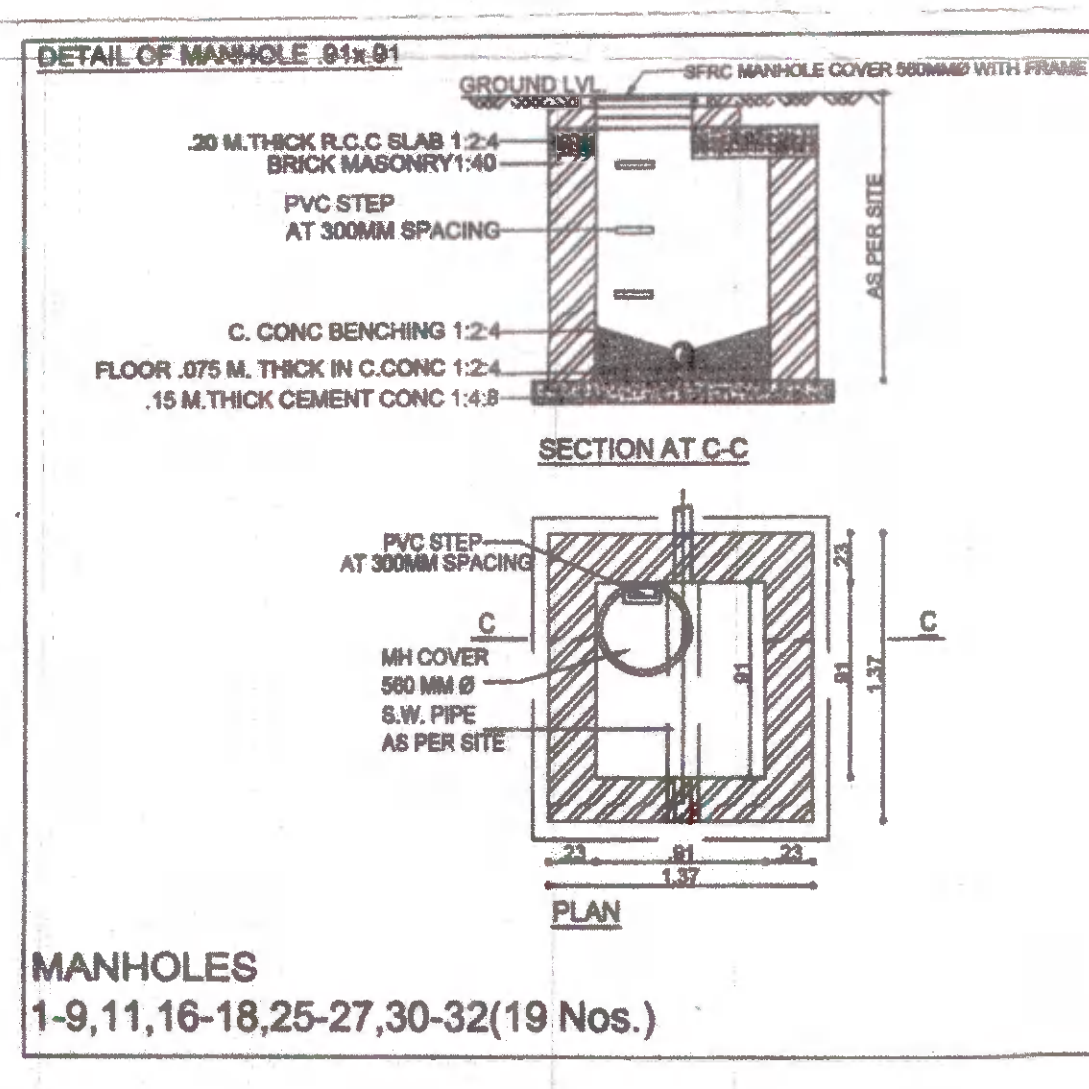

Checked subject to comments in forwarding letter No. ... Dt. ... and notes attached with the estimate

Superintending Engineer (HQ) for Chief Engineer HSVP Panchkula

District Planning Officer, Panchkula

| | |
|---|---|
| CLIENT | ARCHITECT |
| Vijay Kumar S/o Sh. Chandar Parkash For & on behalf of Sh. Baldev Parkash, Sh. Vijay Kumar S/o Narsen Kumar | AR. SUMAN SHARMA CA/2001/27305 SCO 46, SECTOR-11, PANCHKULA M. 9876119000, 9417055267 |
| | Executive Engineer HSVP, Division Patwa |


ARC...D ARCHITECTS
S.C.O.45, SEC.11, PANCHKULA
M-09876119000, 9417055267
EMAIL: arcdarchitects@hotmail.com indianarchitects@rediffmail.com

Acad. Chief Engineer HSVP, Gurugram

SEWERAGE LAYOUT PLAN

LAYOUT PLAN

| | | |
|---------|----------------|-------------|
| SCALE | PROJECT | DRAWING NO. |
| 1:500 | ARC SB | 02 |
| | 901 U.A.D. | |
| | COLONY FEROPUR | |
| CONCEPT | DESIGN | DEALT |
| SUMAN | PRIYA | CHARU |
| | DRAWN | CHECKED |
| | CHARU | SUMAN |
| | DATE | 12-10-18 |

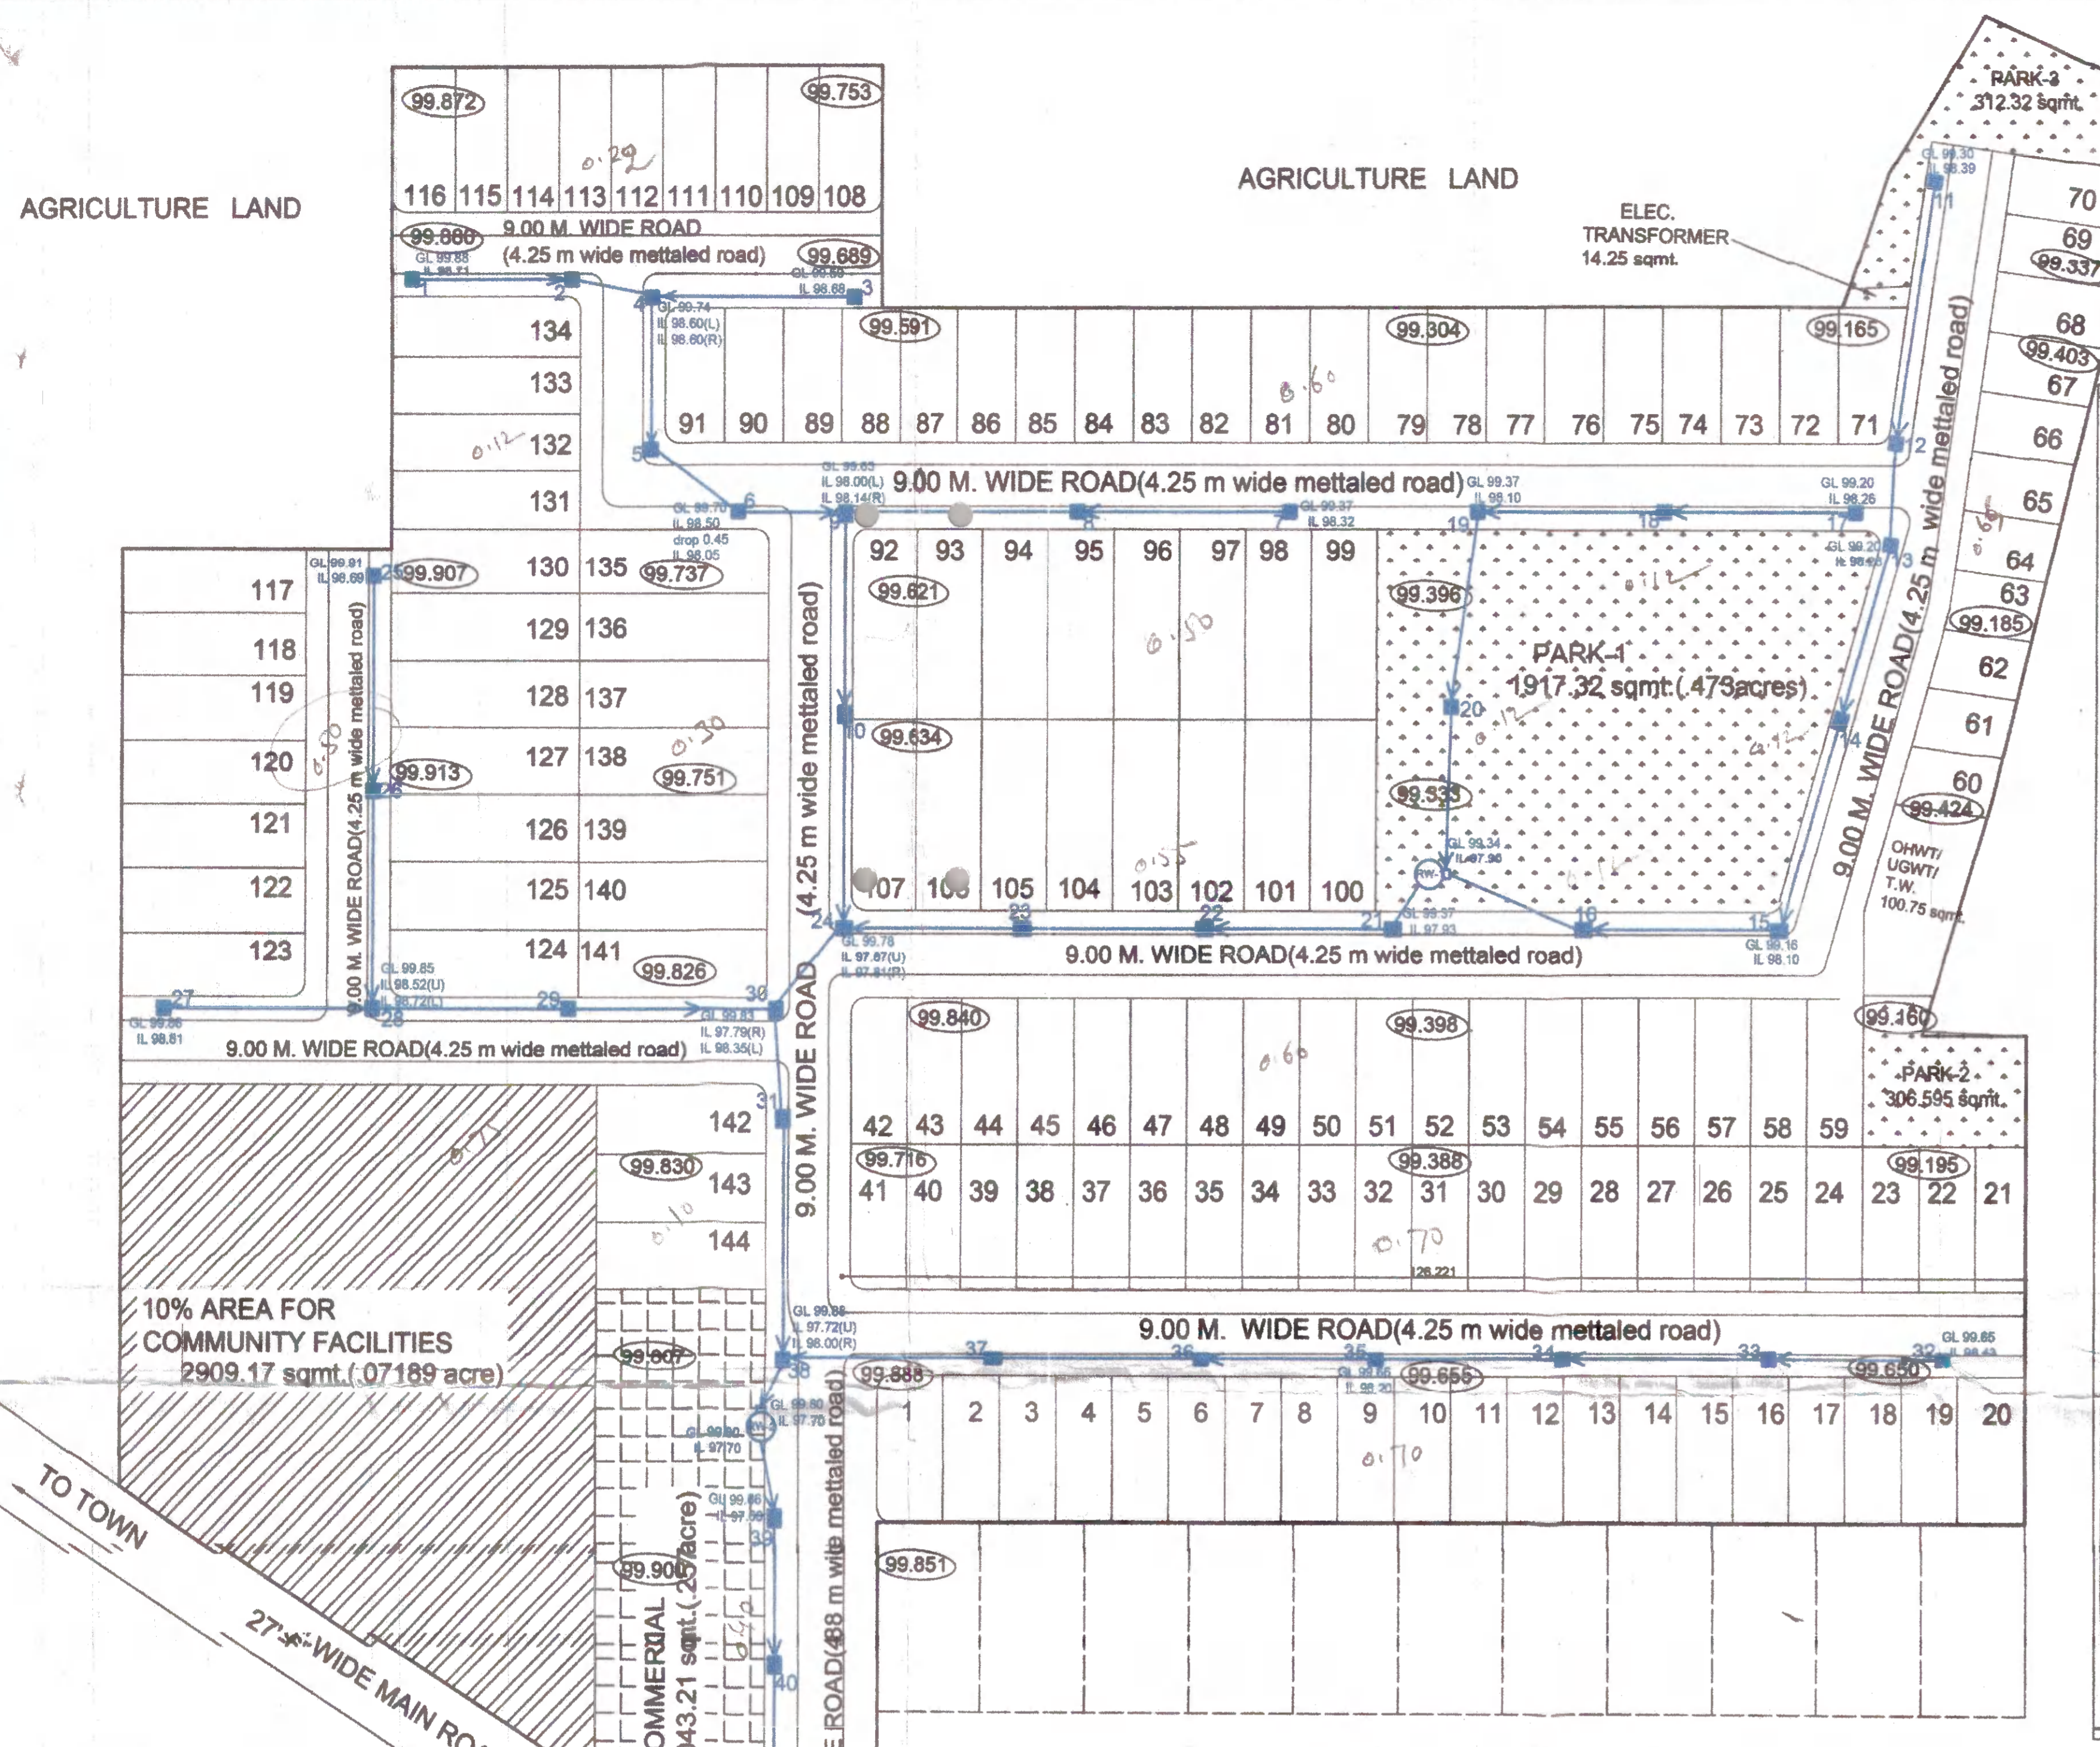

ZONING PLAN OF AFFORDABLE RESIDENTIAL PLOTTED COLONY (UNDER DEEN DAYAL JAN AWAS YOJNA) AREA MEASURING 7.1875 ACRES (LICENSE NO. 44 OF 2018 DATED 21.06.2018) IN SECTOR-10, FEROPUR ZIRKHA, DISTRICT MEWAT BEING DEVELOPED BY SH. BALDEV PARKASH AND OTHERS IN COLLABORATION WITH SH. VIJAY KUMAR.

FOR PURPOSE OF CODE 1.2 (KCVI) & 6.1 (1) OF THE HARYANA BUILDING CODE, 2017, AS AMENDED FROM TIME TO TIME.

| Use Zone | Permissible use of land | Type of building permissible on land |
|-------------|-------------------------|--------------------------------------|
| Residential | Residential | Residential building |
| Public | Public | Public building |
| Commercial | Commercial | Commercial building |

PERMISSIBLE NUMBER OF DWELLING UNIT ON EACH PLOT

| Plot Area | Maximum Permissible Ground Coverage | Permissible Basement | Maximum Permissible Floor Area Ratio (FAR) | Maximum permissible height (5+1 floor) (Including sill (5+4 floor) in meters) |
|-------------------------|-------------------------------------|----------------------|--|---|
| Up to 100 square meters | 60% | Single Level | 200% | 15.00 |

STAIRS
The stairs are permitted parking purpose in residential plots of all sizes, subject to the condition that maximum permissible height of building shall not exceed 15 meters.



PARKING
The parking shall be provided as per the provisions of Haryana Building Code, 2017 as amended from time to time.

PROJECT :
PROPOSED SITE FOR AFFORDABLE PLOTTED COLONY OVER AN AREA MEASURING 7.1875 ACRES UNDER THE DEEN DAYAL JAN AWAS YOJNA AT FEROPUR ZIRKHA, TEHSIL FEROPUR ZIRKHA, DISTT. MEWAT, HARYANA. THROUGH AUTH. SIGNATORY :- MR. VIJAY KUMAR S/O SH. CHANDER PARKASH

- IMP. NOTES:-**
- All R.C.C pipes shall be as I.S. specifications, NP2 off road & NP3 under roads.
 - Backfilling be done in stages, i.e., at least in 2 layers with proper compaction & curing of joints done in cement sand mortar 1 : 1.5
 - For pipe upto depth 1.5 mtrs hunching all round the pipe in 1:5:10 to be done, and for more depths further, haunch upto the sides of pipes is recommended.
 - Manholes upto 1.6m depth shall be built in 9" thick brick wall and brick masonry for additional depth shall be 13.5" thick and above.
 - All levels are shown in meters.
 - The size of R.C.C Pipe mentioned in drawing in mm.
 - The slope of R.C.C Pipe mentioned in drawing in mm.
 - Pipe sizes given is internal & pipe thickness is separate.

CLIENT
 Vijay Kumar S/o Sh. Chander Parkash
 For & on behalf of Sh. Baldev Parkash
 Sh. Manoj Kumar
 A. Panwar Signatory

LAYOUT PLAN

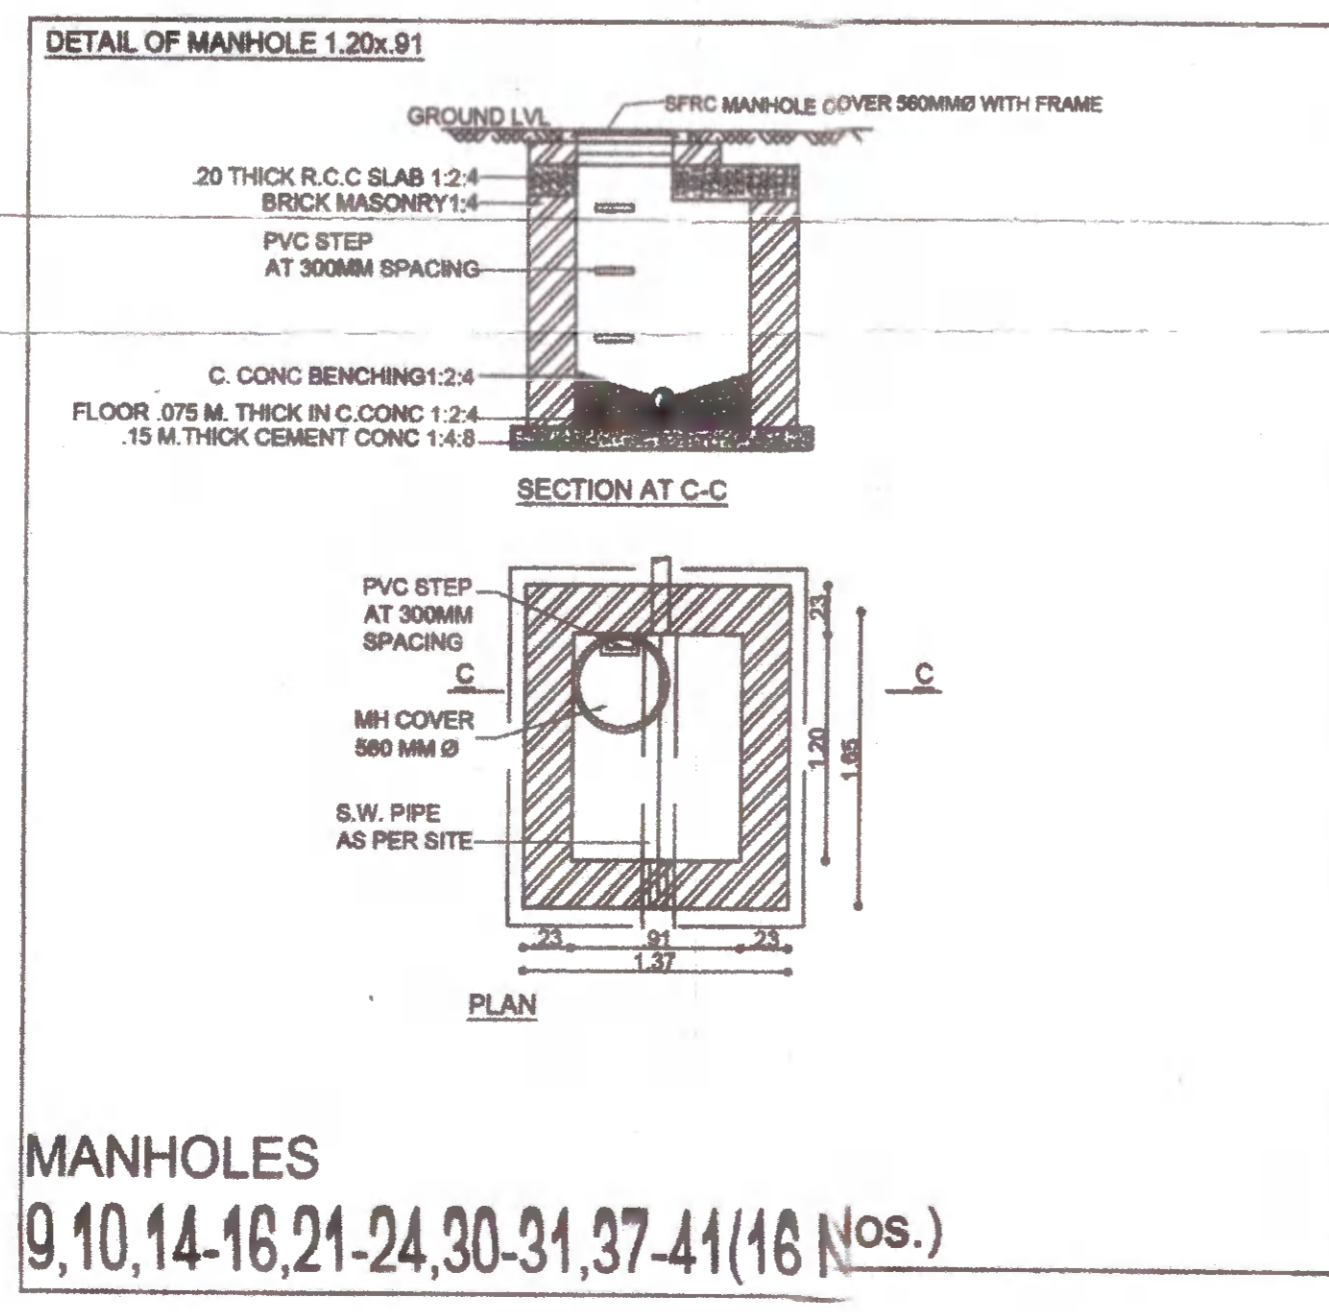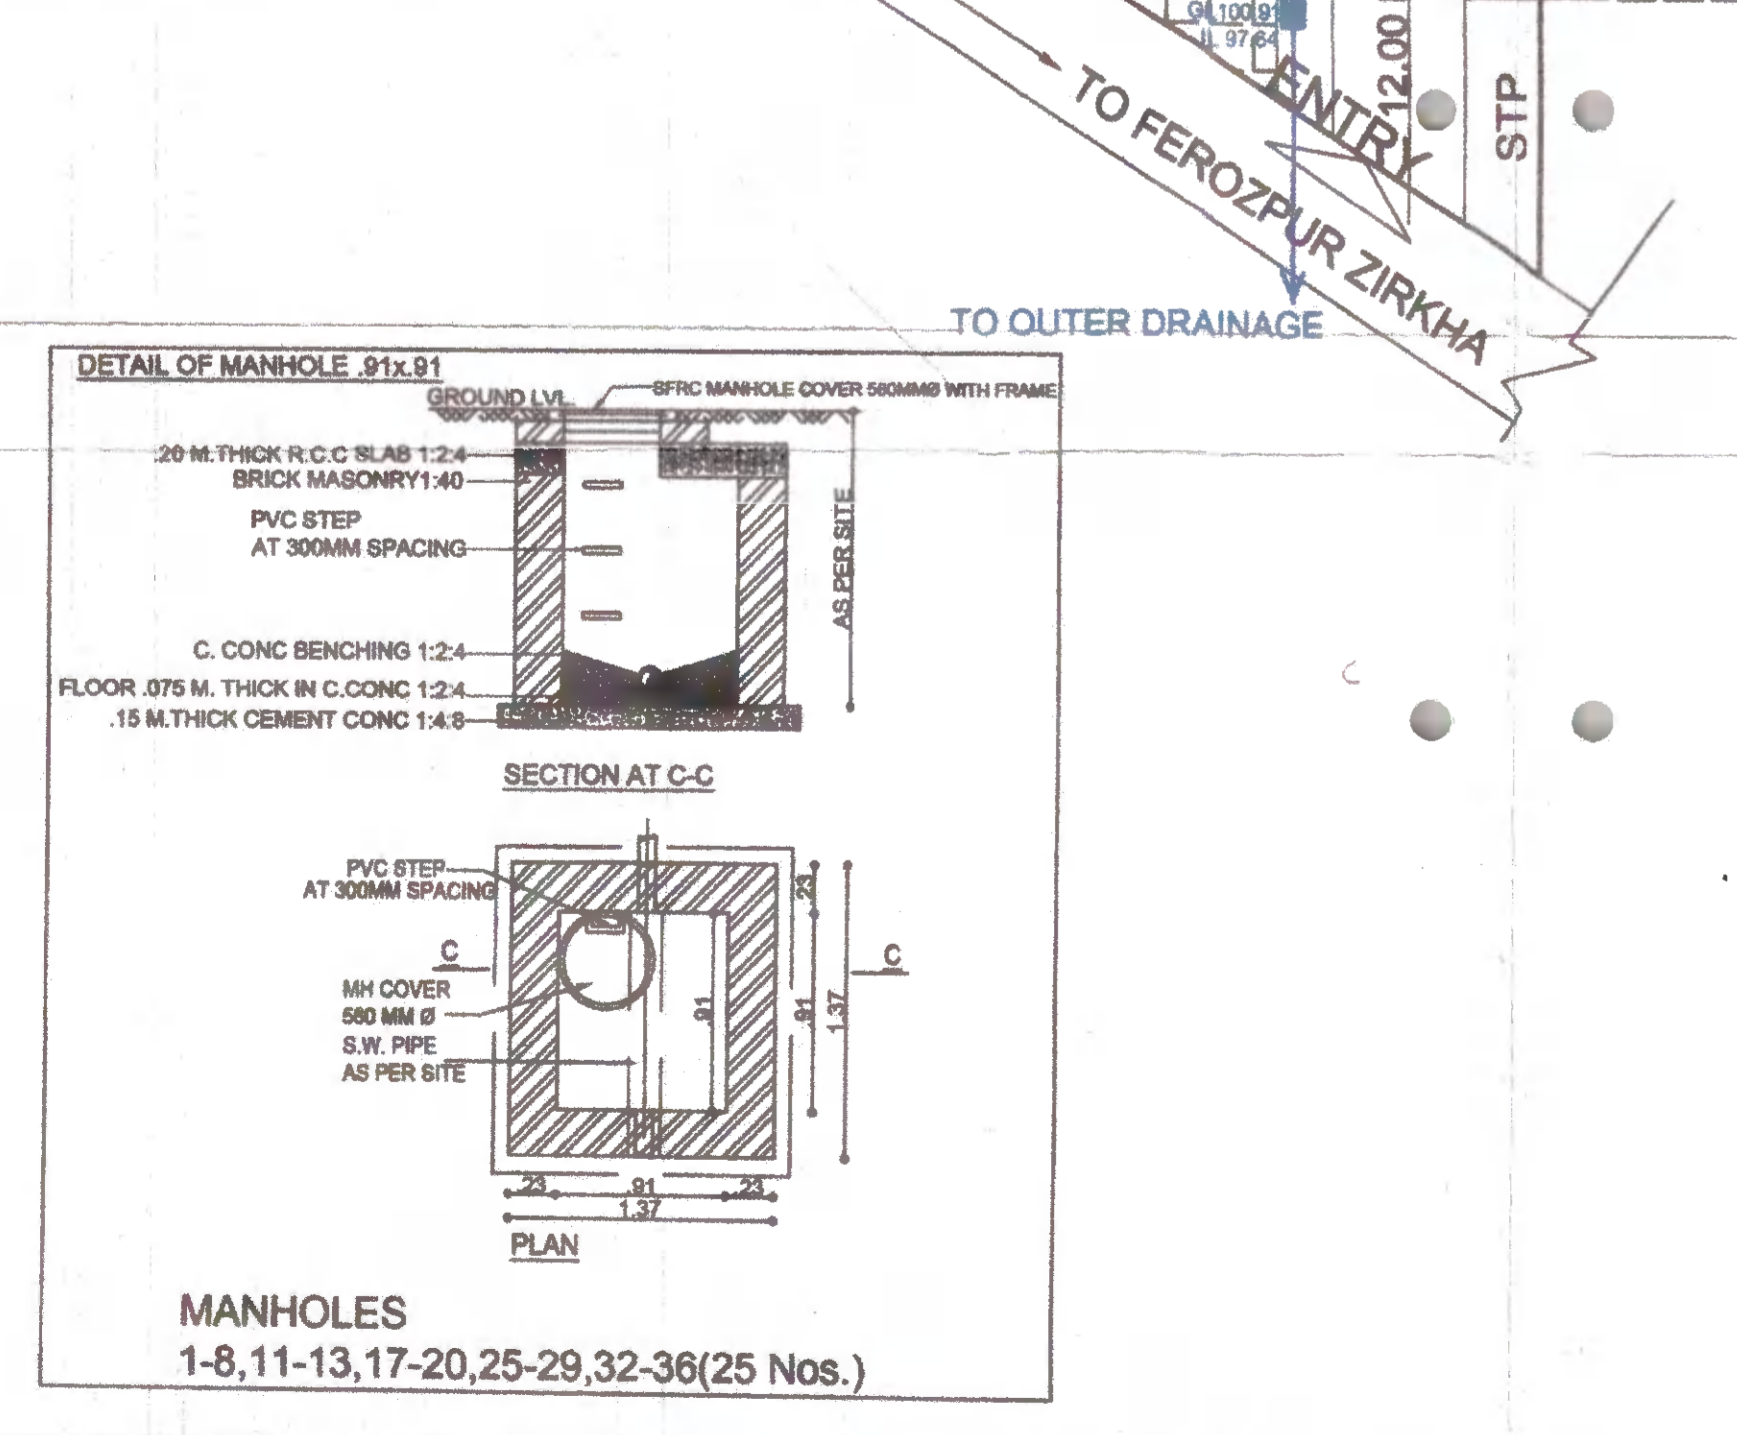

Checked subject to comments in forwarding letter No. ... Dt. ... and notes attached with the estimate

Superintending Engineer (HQ) for Chief Engineer HSVP Panchkula

Director Town & Country Planning & Survey, Chandigarh

| BOQ SWD | Pipe Size/Slope | DEPTHS(in Mtrs.) | | |
|---------|-----------------|-------------------|-------------|------------|
| (in mm) | (0-1.50) | (0-1.50) | (1.50-3.00) | above 3.00 |
| M1-M4 | 250/(1:250) | 28.00 | | |
| M3-M4 | 250/(1:250) | 20.00 | | |
| M4-M6 | 250/(1:250) | 26.50 | | |
| M6-M9 | 250/(1:250) | 12.00 | | |
| M7-M9 | 250/(1:250) | 48.00 | | |
| M11-M13 | 250/(1:250) | 34.00 | | |
| M13-M15 | 250/(1:250) | 42.00 | | |
| M15-RW1 | 250/(1:250) | 37.50 | | |
| M17-M19 | 250/(1:250) | 40.50 | | |
| M19-RW1 | 250/(1:250) | 37.50 | | |
| RW1-M21 | 400/(1:300) | 5.30 | | |
| M25-M28 | 250/(1:250) | 44.53 | | |
| M27-M28 | 250/(1:250) | 22.14 | | |
| M28-M30 | 250/(1:250) | 43.14 | | |
| M32-M35 | 250/(1:250) | 60.00 | | |
| | | 501.11 | | |
| M9-M24 | 400/(1:300) | | 43.00 | |
| M21-M24 | 400/(1:480) | | 58.00 | |
| M4-M6 | 400/(1:480) | | 11.30 | |
| M30-M38 | 450/(1:500) | | 37.20 | |
| M35-M38 | 400/(1:300) | | 64.00 | |
| M38-RW2 | 400/(1:300) | | 7.00 | |
| RW2-M39 | 400/(1:300) | | 8.60 | |
| | | | 229.10 | |
| M39-M41 | 450/(1:300) | | 35.00 | |
| | | | 35.00 | |

ARCHITECT
 AR. SUMAN SHARMA
 CA/20107304
 SCO 45, SECTOR-11, PANCHKULA
 M. 9876119000, 9417055287

Executive Engineer HSVP, Division Patwal

Superintending Engineer HSVP, Panchkula

Add. Chief Engineer HSVP, Gurugram

STORM WATER DISPOSAL PLAN

LAYOUT PLAN


| SCALE | PROJECT | DRAWING NO. |
|-------|----------------|-------------|
| 1:500 | ARC SB | 04 |
| | 901 U.A.D. | |
| | COLONY FEROPUR | |

| CONCEPT | DESIGN | DEALT | DRAWN | CHECKED | DATE |
|---------|--------|-------|-------|---------|----------|
| SUMAN | PRIYA | CHARU | CHARU | SUMAN | 12-10-18 |

AGRICULTURE LAND

AGRICULTURE LAND

LAYOUT PLAN

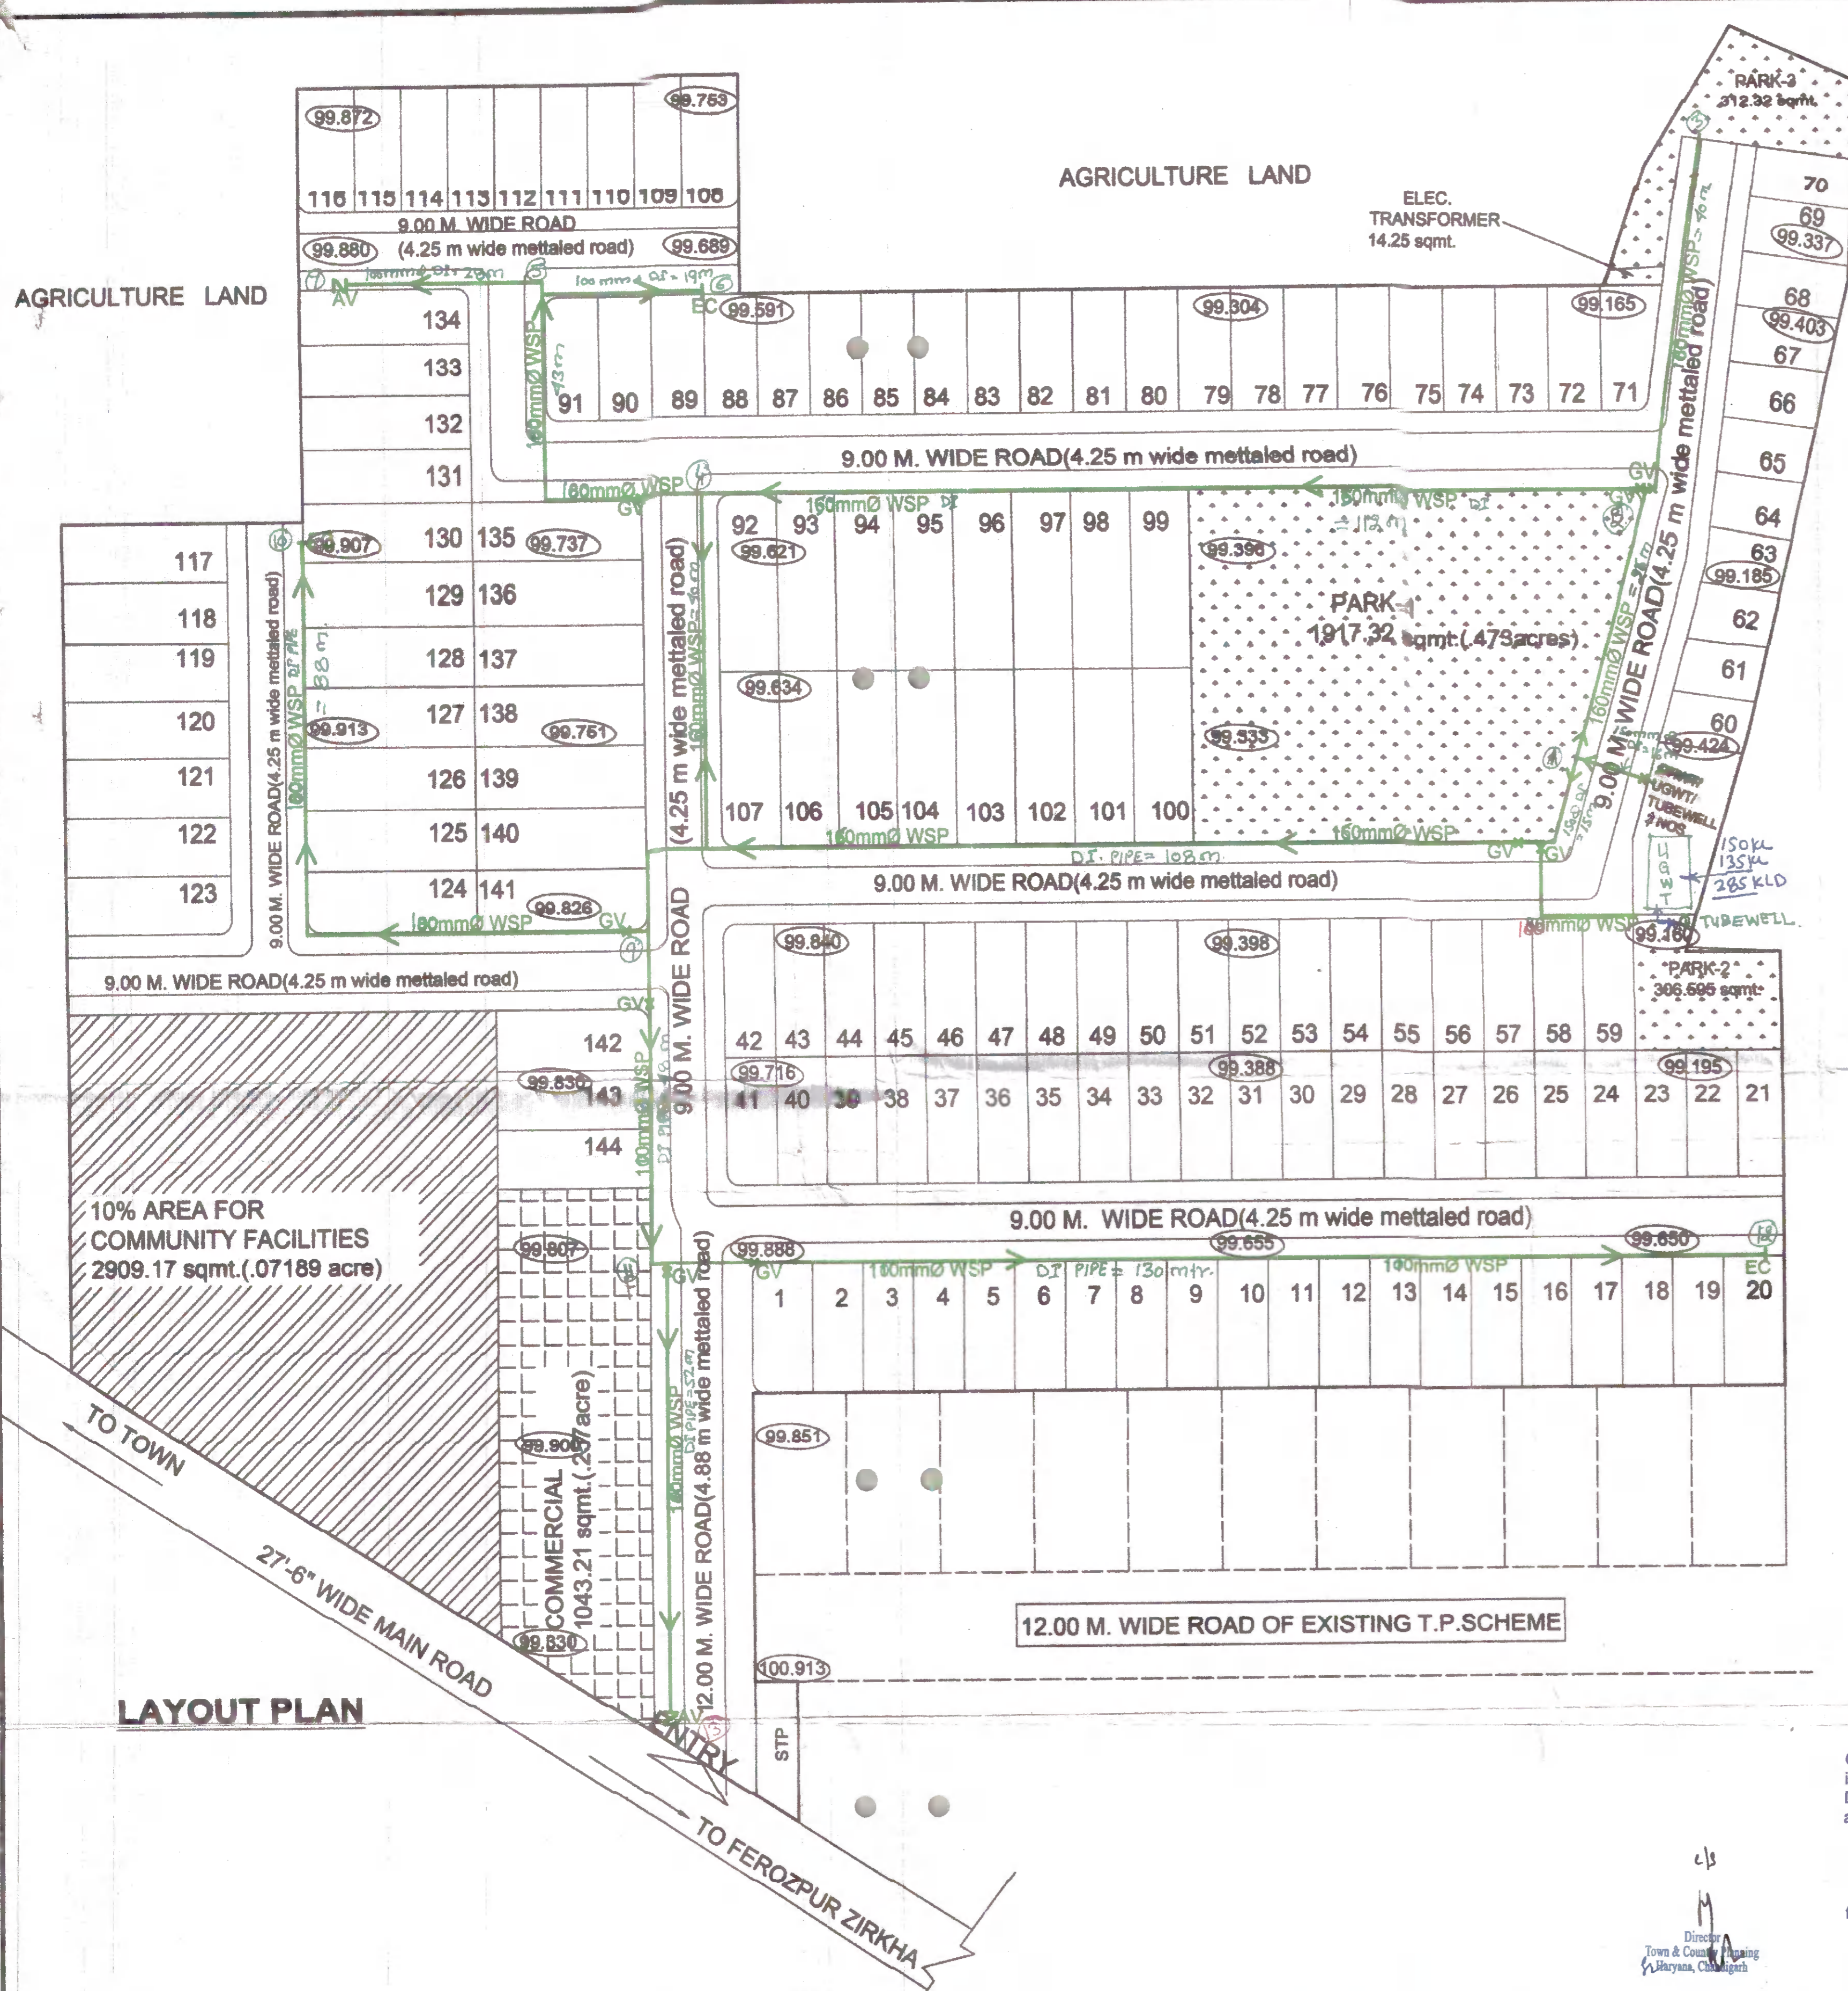

ZONING PLAN OF AFFORDABLE RESIDENTIAL PLOTTED COLONY (UNDER DEEN DAYAL JAN AWAS YOJNA) AREA MEASURING 7.1875 ACRES (LICENSE NO. 44 OF 2018 DATED 21.06.2018) IN SECTOR-10, FEROPUR ZIRKHA, DISTRICT MEWAT BEING DEVELOPED BY SH. BALDEV PARKASH AND OTHERS IN COLLABORATION WITH SH. VIJAY KUMAR.

FOR PURPOSE OF CODE 1.2 (KCVI) & 6.1 (1) OF THE HARYANA BUILDING CODE, 2017, AS AMENDED FROM TIME TO TIME.

1. USE ZONE
The land shown in this zoning plan shall be utilized in accordance with the marking explained in the table below and as per the following conditions:

| Marking | Permissible use of Land on the portion of the plot marked as column 1 | Type of building permissible on land marked as column 2 |
|----------|---|---|
| (Symbol) | Road | Road furniture at approved places |
| (Symbol) | Public open space | To be used only for landscape features |
| (Symbol) | Residential Buildable Zone | Residential building |
| (Symbol) | Commercial | As per supplementary zoning plan to be approved separately for each site. |

2. MAXIMUM PERMISSIBLE GROUND COVERAGE, HEIGHT / INCLUDING STYL PICOSS

| Plot Area upto 150 square metres | Maximum Permissible Ground Coverage | Permissible Maximum Height (Floor Area Ratio (FAR)) | Maximum Permissible Height (No. of Floor) (Maximum) |
|----------------------------------|-------------------------------------|---|---|
| upto 150 square metres | 60% | Single Level | 20% |

3. BUILDING SETBACKS
Building other than boundary wall and gates shall be constructed only within the portion of the site marked as (Z)Z) residential buildable zone in clause number 1 above. The setback projections as allowed in Haryana Building Code, 2017 shall project beyond the portion marked as residential buildable zone.

4. HEIGHT OF THE BUILDING AND PERMISSIBLE NUMBER OF STOREY
The maximum height and number of storey shall be allowed on the plot as per provision of Haryana Building Code, 2017.

5. STYL PARKING
Styl parking is allowed in all plots. The maximum number of cars shall be as per the provision of Haryana Building Code, 2017. The cars shall not be parked on the plot area other than the parking.

6. PARKING
(a) Parking shall be provided as per the provision of Haryana Building Code, 2017 as amended from time to time.
(b) In all circumstances, the vehicles belonging to the plot shall be parked outside the plot area.

7. GATE AND GATE POST
The gate and gate post shall be constructed as per approved standard design, at the position indicated on the zoning plan.

8. DISPLAY OF POSTAL NUMBER OF THE PLOT
The premises number and postal address shall be written at the space shown for this purpose on the standard design of the gate as per approved design.

9. GARBAGE COLLECTION POINT
Every plot holder shall make adequate provision for garbage collection in his own plot and make suitable arrangement for deposit at the taxable collection point to be provided by the authority.

10. ACCESS
No plot or public building will derive an access from less than 9.00 metres wide road.

11. GENERAL
(a) That the collector/owner shall use only Light Emitting Diode lamps (LED) fitting for internal lighting as well as Campus lighting.
(b) That the collector/owner shall strictly comply with the directions issued vide Notification No. 13/04/2016-SR dated 13.05.2016 issued by Haryana Government Renewable Energy Department, if applicable.
(c) That the collector/owner shall ensure the installation of Solar Power Plant as per provisions of Haryana Solar Power Policy, 2016 issued by Haryana Government Renewable Energy Department vide Notification No. 19/04/2016-S Power dated 14.03.2016, if applicable.
(d) That the collector/owner shall ensure the installation of Solar Photovoltaic Power Plant as per the provisions of order No. 22/51/2005-Shower dated 21.03.2016 issued by Haryana Government Renewable Energy Department, if applicable.

NOTE
Read this drawing in conjunction with the demarcation plan verified by STP, Faridabad vide memo no. 3186 dated 05.10.2018.

DWG NO: DTPC / 2251 / DATED: 21-10-18

(PLANNING) (ARCHITECT) (SUPERINTENDING ENGINEER) (SUPERINTENDING ENGINEER) (SUPERINTENDING ENGINEER) (SUPERINTENDING ENGINEER) (SUPERINTENDING ENGINEER)

PROJECT :
PROPOSED SITE FOR AFFORDABLE PLOTTED COLONY OVER AN AREA MEASURING 7.1875 ACRES UNDER THE DEEN DAYAL JAN AWAS YOJNA AT FEROPUR ZIRKHA, TEHSIL FEROPUR ZIRKHA, DISTT. MEWAT, HARYANA. THROUGH AUTH. SIGNATORY :- MR. VIJAY KUMAR S/O SH. CHANDER PARKASH

- IMP. NOTES:-**
- DI K-7 pipe is recommended for drinking water supply.
 - Jointing of pipes be done with rubber gasket joints and all spls. to be used should be mechanical flanged ones, tested to capacity and requisite pressure after the laying of pipe is complete.
 - The depth of pipes be considered around 1.0 Mtrs from Gr. Level.
 - Testing of Pipes be done at the requisite pressure after installing required capacity pump.
 - Special precautionary steps be taken while using fittings at turns to avoid any leakage or thrust at later stage.

CLIENT
Vijay Kumar S/o Sh. Chander Parkash
For & on behalf of Sh. Baldev Parkash
Sh. Vikas Kumar S/o Nareish Kumar

ARCHITECT
AR. SUMAN SHARMA
CA/200/127305
SCO-45, SECTOR-11, PANCHKULA
M. 9876119000, 9417055287

Authorised Signatory

| BOQ WS | D.I. PIPE | QTY |
|------------------|-----------|---------|
| 150MMØ | | 306.00M |
| 100MMØ | | 242.00M |
| 80MMØ | | 214.00M |
| 50MMØ | | 20.00M |
| AV-AIR VALVE(3") | | 2NOS. |
| SV-SLUICE VALVE | | 3 NOS. |
| 160MMØ | | 3 NOS. |
| 110MMØ | | 3 NOS. |
| 80MMØ | | 3 NOS. |
| 50MMØ | | 1 NOS. |

Checked subject to comments in forwarding letter No. ... Dt. ... and notes attached with the estimate

Superintending Engineer (HQ) for Chief Engineer HSVP Panchkula

ARC...D ARCHITECTS
S.C.O.45, SEC. 11, PANCHKULA
M-09876119000, 09417055287
EMAIL:- arcdarchitects@hotmail.com
indianarchitects@rediffmail.com

Executive Engineer HSVP, Division Panchkula

WATER SUPPLY

LAYOUT PLAN

| SCALE | PROJECT | DRAWING NO. |
|-------|---------|-------------|
| 1:500 | ARC | SB 03 |
| | 901 | U.A.D. |
| | COLONY | FEROPUR |

| CONCEPT | DESIGN | DEALT | DRAWN | CHECKED | DATE |
|---------|--------|-------|-------|---------|----------|
| SUMAN | PRIYA | CHARU | CHARU | SUMAN | 12-10-18 |