

NOTE

LOCAL HEALTH SYSTEM
PREPARED AT TERESA

THE CONTRACTOR SHALL BE RESPONSIBLE FOR OBTAINING ALL NECESSARY PERMITS FROM THE NATIONAL BUILDING CODE AND THE RESIDENTIAL CODE LAWS AND REGULATIONS INCLUDING IS COVER FOR STRUCTURAL ASSESSMENT OF EXISTING AND OTHER BUILDINGS. THE LOCAL GOV. CONCERNING THE LOAD BEARING CAPACITY AND THE FOUNDATION. THESE SHALL BE KEPT IN THE FILE BEHIND THE NAME.

METEORIC ALARM SHALL BE PROVIDED. A.P.M. SHALL BE PROVIDED.



NO PARKING SHALL BE PROVIDED.

PROVISIONS OF LETTER BOX BACK DRILLING UNIT AT GROUND FLOOR.

ALL NEW TREE WALLS AND TREES EXISTING FOR SHALL BE PROVIDED IN ALL BETWEEN A TOILET.

FEE CALCULATION

F.A.R. AREA	= 7486.774 sq. mt.
NON F.A.R. AREA	
BASEMENT AREA (TOTAL)	= 31,983.574 sq. mt.
STILT AREA (TOTAL)	= 1,818.083 sq. mt.
FIRE EXTINGUISHER (ALL BLOCKS)	= 1,071.365 sq. mt.
MS WASTEWATER BLOCKS	= 282.365 sq. mt.
SCHOOL	= 463.119 sq. mt.
TOTAL AREA	= 1,08,706.874 sq. mt.
BAYS	= 11,00,000 sq. mt. x 1.10
	= 11,00,000.00 sq. mt.

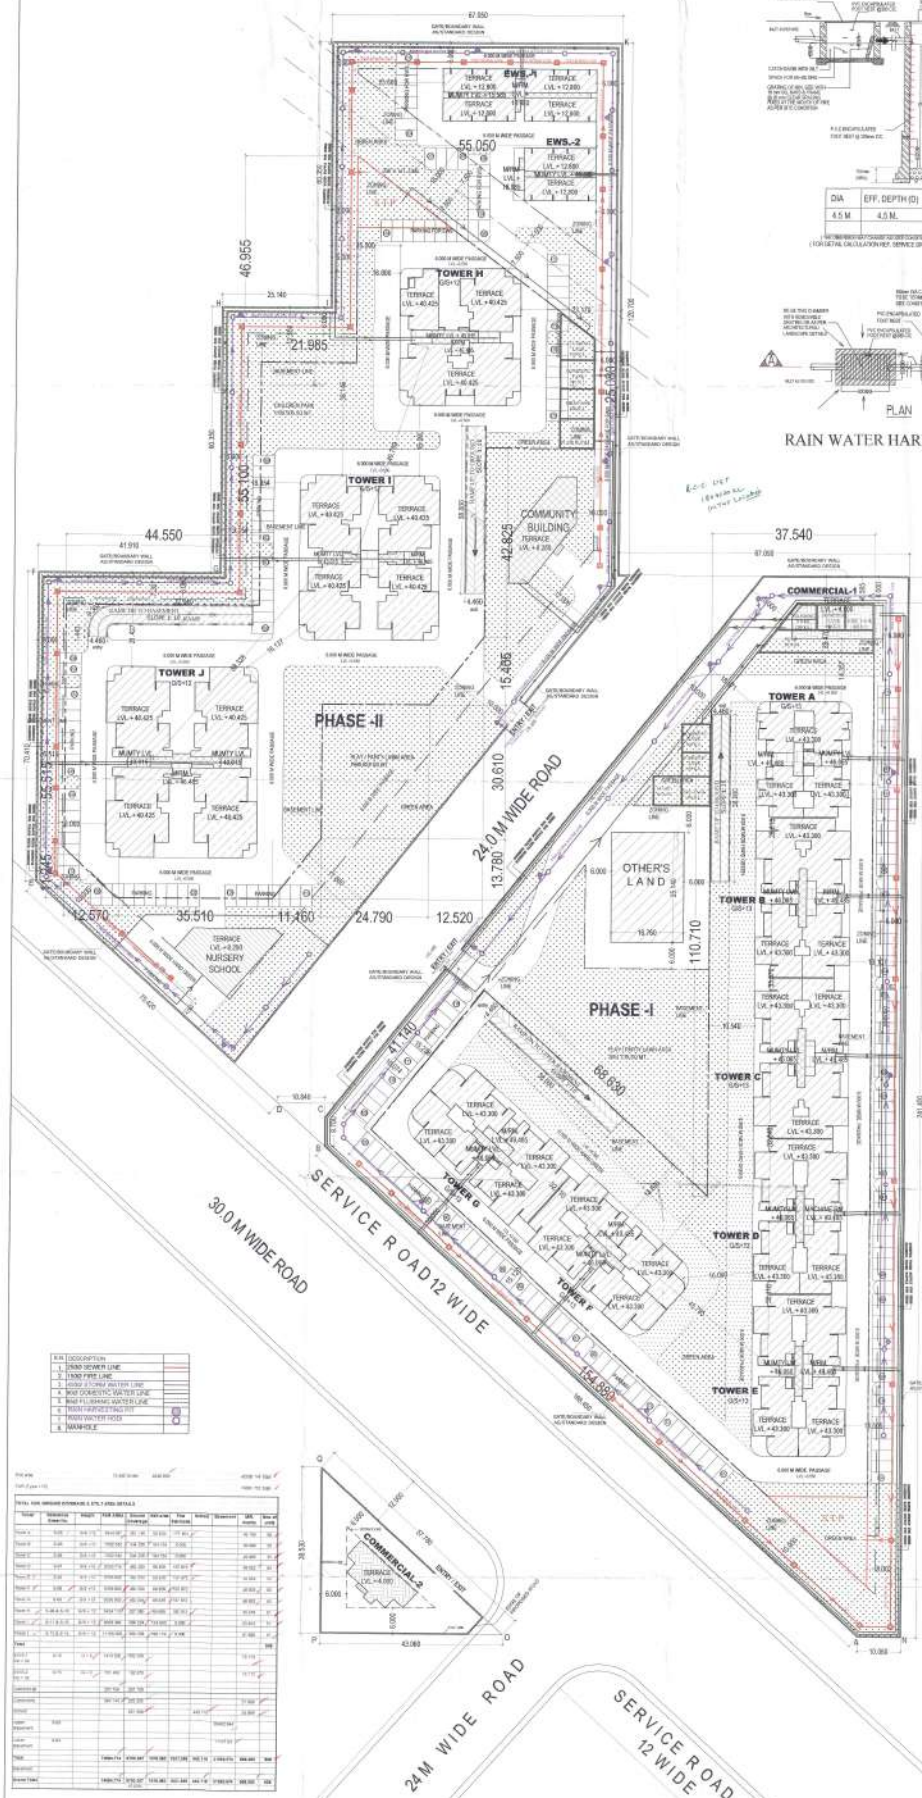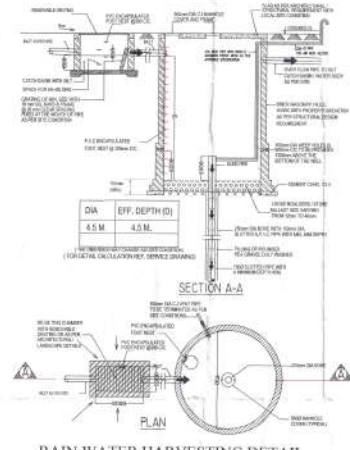

Total Plot Area As Per Zoning = 10.462 Acres 42338.144 sq. mt.

Perm. FAR 175% of Plot Area = 74091.752 sq. mt.

FAR Achieved = 74084.774 sq. mt.

Commercial plot area 0.5 % of total plot area = 211.690 sq. mt. (42338.144x0.5%)

Proposed Commercial Plot Area = 207.709 sq. mt.

Perm. Ground Coverage 35% = 14818.350 sq. mt.

Proposed TOTAL Ground Coverage (15.83%) = 6700.367 sq. mt.

Required Green Area 15% = 6350.725 sq. mt.

Proposed Green Area 18.65% = 8320.429 sq. mt.

Parking Required
(186 COVID-201 OPEN)
Parking Provided = 807 ECS

COVERED PARKING:

PARKING IN UPPER BASEMENT = 473 ECS

PARKING IN LOWER BASEMENT = 248 ECS

TOTAL AREA OF STILT = 26 ECS

TOTAL OPEN PARKING = 211 ECS

TOTAL PARKING = 968 ECS

Parking Required FOR EWS:

TOTAL PARKING REQUIRED = 807/100 = 40.36 ECS

Parking Provided FOR EWS:

TOTAL PARKING PROVIDED = 41 ECS (FROM 171 TO 211)

Total No. DUS = 538 Nos.

EWS Required @15% of Main DUS = 80

EWS Provided = 96

Service Personnel Required @10% of Main DUS = 54

Service Personnel Provided = 55 (under Block - D)

Total Basement Area

UPPER BASEMENT AREA = 29462.944 sq. mt. (REF. DWG. NO. - S-02)

LOWER BASEMENT AREA = 11707.630 sq. mt. (REF. DWG. NO. - S-03)

TOTAL BASEMENT AREA = 31166.574 sq. mt.

Total Basement Area For Parking

UPPER BASEMENT AREA = 18623.503 sq. mt. (REF. DWG. NO. - S-02)

LOWER BASEMENT AREA = 10314.116 sq. mt. (REF. DWG. NO. - S-04)

TOTAL BASEMENT AREA = 28938.319 sq. mt.

PROPOSED COVERED PARKING RESERVED FOR EWS (WITHIN BASEMENT PARKING)

5% OF 807 = 41 ECS

Site Area = 1018.083 sq. mt.

Density Permissible = 100-300 PPA


Density Achieved = (MAIN DUS X5)+EWS X 2)+SERVICE PERSON X 2 = 285.98 PPA (2563 persons)

No of Nursery School Required = 1

No of Nursery School Provided (976.806 sq. mt per school) = 1

LEGEND

1	EXISTING CONTOUR
2	PROPOSED CONTOUR
3	EXISTING ROAD
4	PROPOSED ROAD
5	EXISTING WATER LINE
6	PROPOSED WATER LINE
7	EXISTING SEWER LINE
8	PROPOSED SEWER LINE
9	EXISTING ELECTRICAL
10	PROPOSED ELECTRICAL
11	EXISTING TELEPHONE
12	PROPOSED TELEPHONE
13	EXISTING GAS
14	PROPOSED GAS
15	EXISTING FENCE
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19	EXISTING CURB
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21	EXISTING DRIVE
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23	EXISTING SIDEWALK
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GREEN AREA			
S.NO	LENGTH	WIDTH	AREA(SQM)
1	14.600	x 19.945	= 291.197
2	11.500	x 22.945	= 263.868
3	20.000	x 11.445	= 228.900
4	10.000	x 14.985	= 149.850
5	35.140	x 26.045	= 916.305
6	AS PER PLINE		= 309.993
7	55.470	x 20.385	= 1130.756
8	26.980	x 8.360	= 225.537
9	AS PER PLINE		= 328.148
10	38.460	x 8.470	= 325.756
11	52.990	x 47.045	= 2491.048
12	4.160	x 36.545	= 152.027
13	8.695	x 32.300	= 280.849
14	AS PER PLINE		= 311.795
15	19.620	x 2.475	= 48.510
16	12.355	x 7.000	= 86.485
17	22.785	x 5.500	= 125.318
18	13.885	x 4.000	= 55.540
19	7.355	x 34.080	= 252.658
20	41.910	x 7.375	= 309.086
21	5.000	x 10.990	= 54.950
22	5.100	x 63.035	= 321.479
23	5.010	x 5.600	= 28.056
24	25.000	x 2.000	= 50.000
25	20.000	x 2.000	= 40.000
26	5.100	x 17.380	= 88.578
27	4.540	x 20.095	= 91.231
28	8.100	x 6.500	= 52.650
29	AS PER PLINE		= 49.900
TOTAL GREEN AREA (19.65%)			= 8320.469

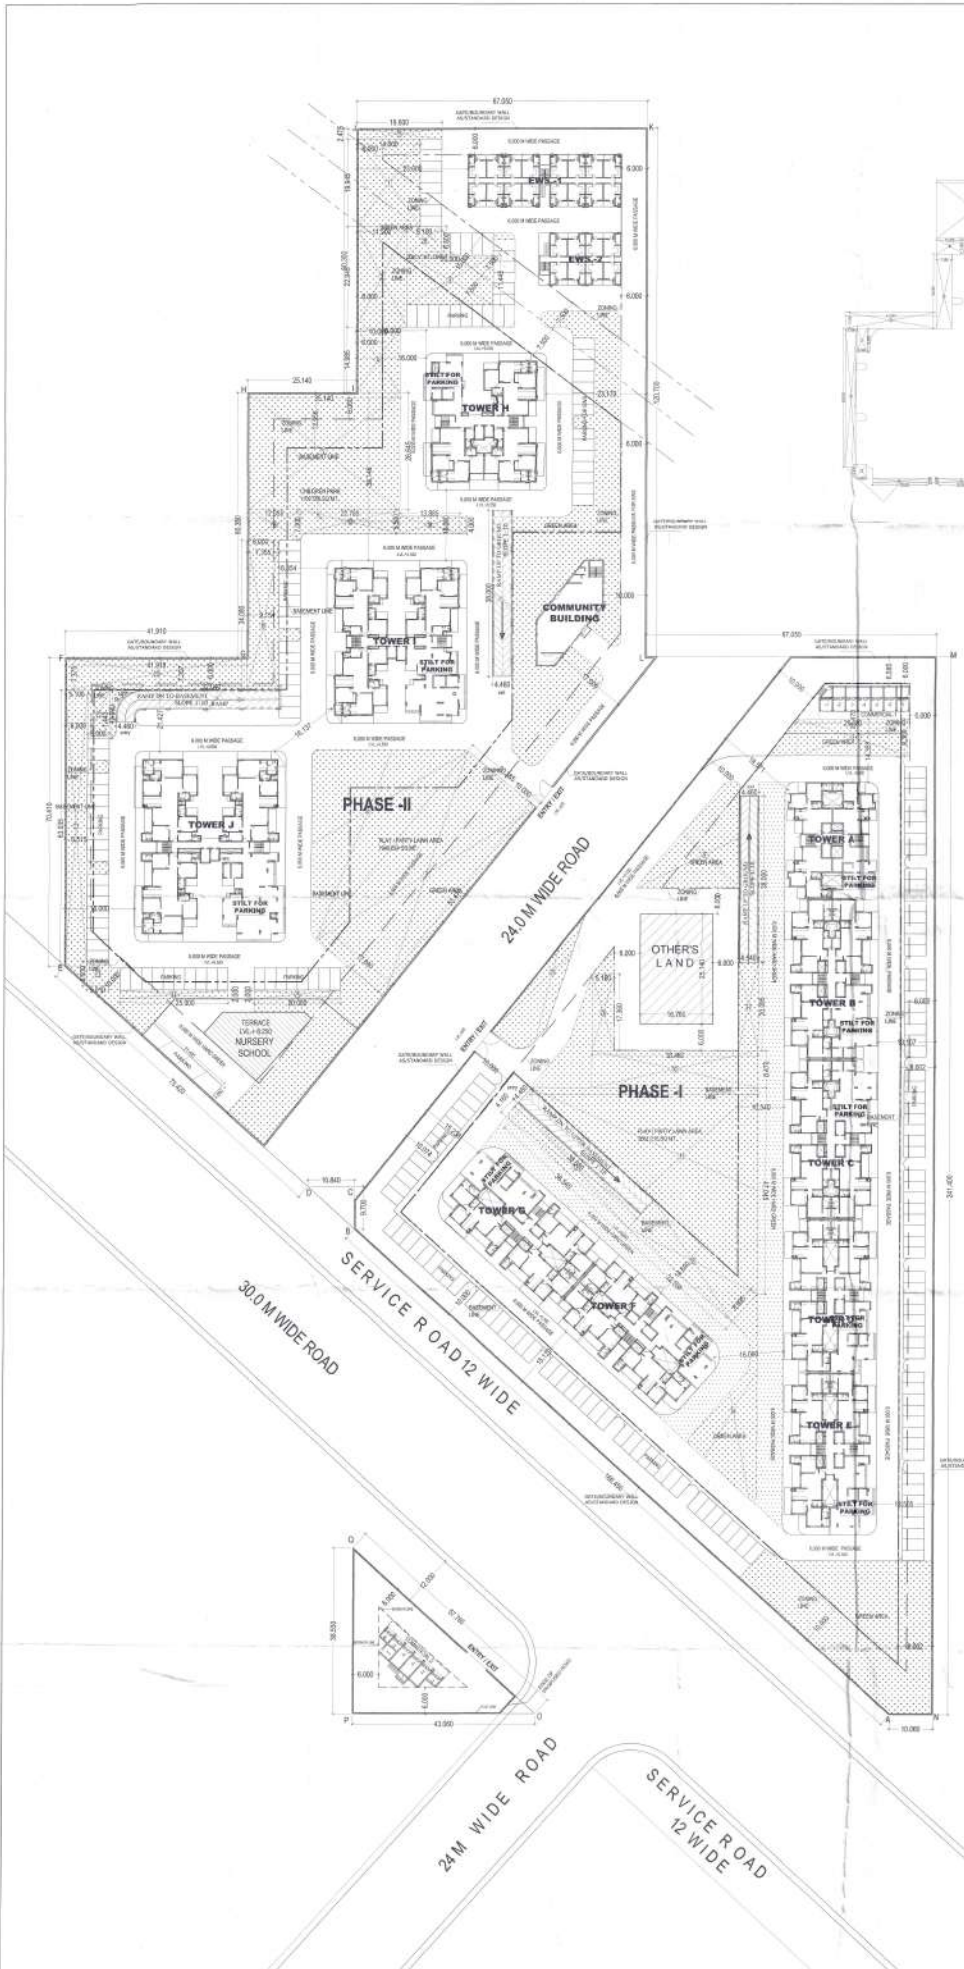

PROJECT TITLE:
 APPROVAL OF REVISED BUILDING PLAN
 OF GROUP HOUSING EXTREME GUN AREA,
 MEASURING 16.442 ACRES (Lot No. 14
 17th Phase) IN R-2(1)111 SEC-13A(1),
 GURGAON MANESAR URBAN COMPLEX,
 BEING DEVELOPED BY K.S. INFRACON
 PVT. LTD. AND OTHERS

DRAWING TITLE: S-02a
 LANDSCAPE PLAN

SCALE: 1:400
 DATE: 20/08/20
 DRAWN: [Signature]
 CHECKED: [Signature]
 JOB NO: [Number]

DEEPAK MEHTA & ASSOCIATES
 ARCHITECTS, PLANNERS, LANDSCAPERS & INTERIORS
 PLOT NO. 10, SECTOR 14/2, GURGAON PHASE 1, DISTRICT
 OF GURGAON, HARYANA

Approved by [Signature]
 COASTWAYS
 Plot No. 10, Sector 14/2, Gurgaon
 Major Plot No. 10, Dist-01

[Signatures and stamps of project team members]

PROJECT'S SIGN

PREPARED BY: [Signature]
 CHECKED BY: [Signature]

PKR & P&S CONSULTANTS

PHASE-I AREA CALCULATION


UPPER BASEMENT PLAN S-03

DOORS & WINDOWS SCHEDULE				
S.NO.	TYPE	SIZE	S.V/L	L.V/L
1	D1	1.250x2.100	20.0	2.100

BASEMENT AREA CALCULATION PHASE-I


CALCULATION OF UPPER BASEMENT AREA OF PHASE-I

SNO.	LENGTH	WIDTH	AREA (SQ.MT.)
1	19.730	24.365	240.361
2	17.810	24.365	433.941
3	37.540	110.710	4156.053
4	37.540	88.740	1665.650
5	41.100	87.150	1790.933
6	68.630	41.100	2820.691
TOTAL			11107.630

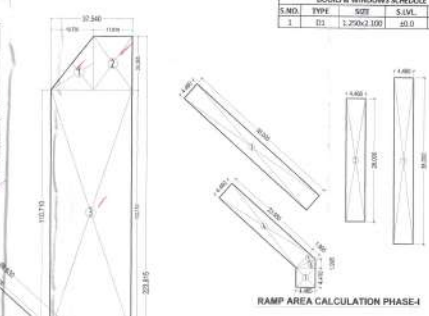

CALCULATION OF RAMPS AT UPPER BASEMENT AREA OF PHASE-I

SNO.	LENGTH	WIDTH	AREA (SQ.MT.)
1	4.460	38.000	169.480
2	4.460	28.000	124.880
3	4.460	38.000	169.480
4	4.460	23.955	106.839
5	4.460	1.995	4.449
6	4.460	1.995	4.449
7	4.460	4.410	19.669
TOTAL			599.246

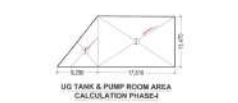

CALCULATION OF U.G. T & PUMP ROOM AT UPPER BASEMENT AREA OF PHASE-I

SNO.	LENGTH	WIDTH	AREA (SQ.MT.)
1	9.290	11.470	53.778
2	17.810	11.470	204.281
TOTAL			257.559

CALCULATION OF S.T.P. AT UPPER BASEMENT AREA OF PHASE-I

SNO.	LENGTH	WIDTH	AREA (SQ.MT.)
1	73.005	20.190	236.836
TOTAL			236.836

TOTAL UPPER BASEMENT AREA

PHASE I	=	11107.630
PHASE II	=	9345.314
TOTAL UPPER BASEMENT AREA	=	20452.944

UPPER BASEMENT AREA FOR PARKING (SQ.MT.)

SNO.	LENGTH	WIDTH	AREA (SQ.MT.)
TOTAL BASEMENT AREA			20452.944
U.G.T AREA AT UPPER BASEMENT AREA OF PHASE-I			257.559
U.G.T & PUMP ROOM AREA AT UPPER BASEMENT AREA OF PHASE-II			226.987
S.T.P AREA AT UPPER BASEMENT AREA OF PHASE-II			236.836
S.T.P AREA AT UPPER BASEMENT AREA OF PHASE-I			169.853
RAMP AREA AT UPPER BASEMENT AREA OF PHASE-II			599.246
RAMP AREA AT UPPER BASEMENT AREA OF PHASE-I			338.960
BASEMENT AREA FOR PARKING	=	18623.563	
AREA REQD. FOR ONE ECS IN BASEMENT	=	35.000	
NO. OF ECS IN BASEMENT= PARKING AREA / 35 = 18623.563/35	=	532.100	
SAYS ECS	=	532	
NO. OF ECS SHOWN	=	473	

TOTAL NO. OF ECS.

UPPER BASEMENT ECS.	=	473
LOWER BASEMENT ECS.	=	248
TOTAL NO. OF ECS.	=	721

CALCULATION OF S.T.P. AT UPPER BASEMENT AREA OF PHASE-II

SNO.	LENGTH	WIDTH	AREA (SQ.MT.)
1	21.345	15.915	169.853
TOTAL			169.853

PROJECT TITLE: APPROVAL OF REVISED BUILDING PLAN OF GROUP HOUSING SCHEME ON AREA MEASURING TO BE ACQUISITION No. 24 OF 2011 dated 16.04.2011 IN SEC-11(A) III, BANGALORE MANGALURU URBAN COMPLEX, BEING DEVELOPED BY K.N.S INFRACON PVT.LTD AND OTHERS

DRAWING TITLE: UPPER BASEMENT PLAN S-03


SCALE: 1:400

DATE: 20/11/20

DESIGN: K.N.S INFRACON PVT.LTD

PREPARED BY: DEEPAK MEHTA & ASSOCIATES ARCHITECTS, PLANNERS, ENGINEERS & INTERIORS

FOR K.N.S INFRACON PVT.LTD

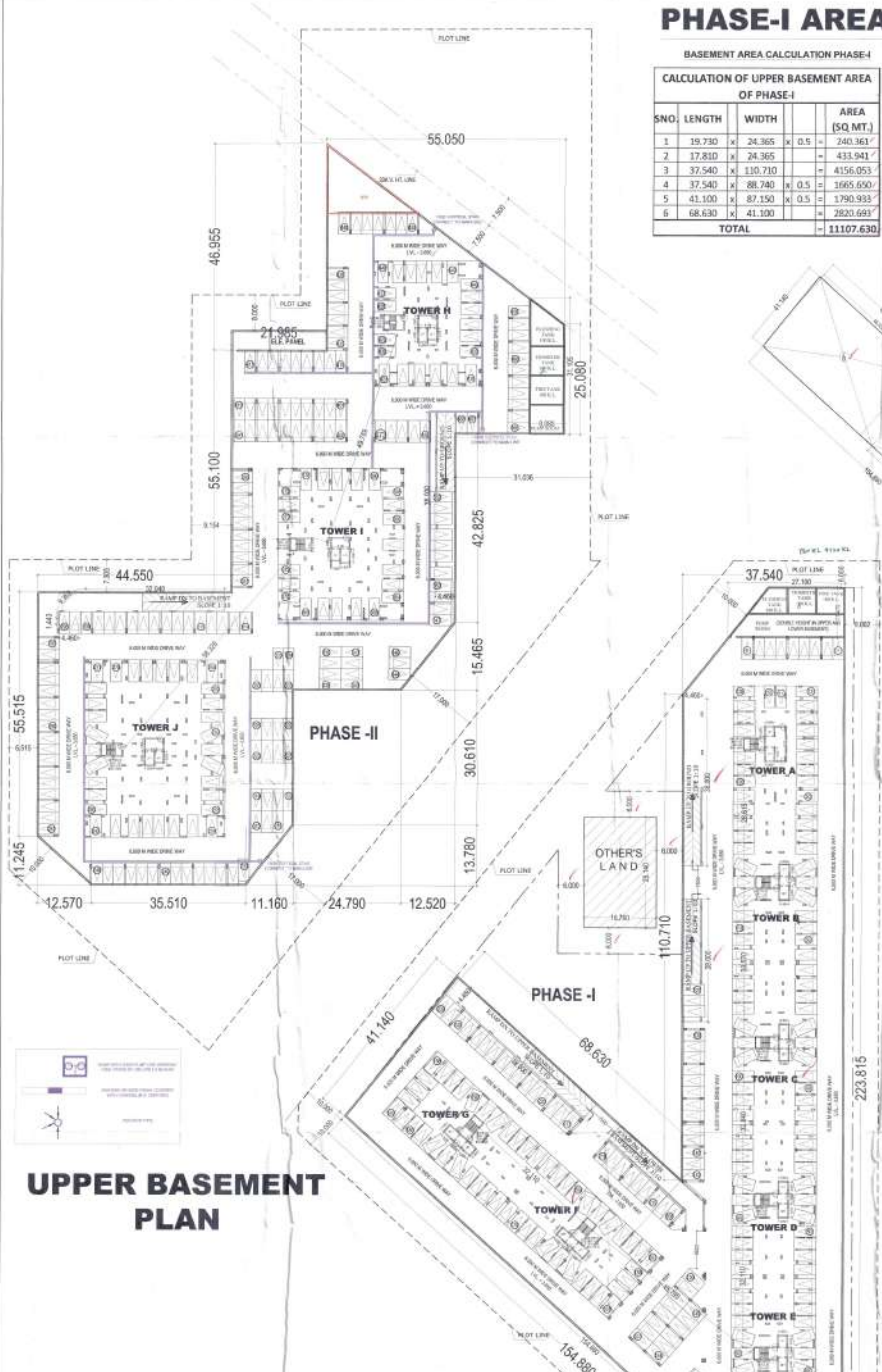


UPPER BASEMENT PLAN

PHASE-II AREA CALCULATION

CALCULATION OF UPPER BASEMENT AREA OF PHASE-II

SNO.	LENGTH	WIDTH	AREA (SQ.MT.)
1	55.050	41.055	1130.039
2	55.050	25.080	1380.194
3	21.865	19.180	421.672
4	12.530	42.825	536.169
5	39.480	35.920	1418.122
6	12.520	15.465	96.811
7	24.790	22.370	554.552
8	11.160	52.980	591.257
9	11.160	13.780	76.892
10	35.510	66.790	2370.648
11	12.520	55.515	697.824
12	12.520	11.245	70.675
TOTAL			9345.314

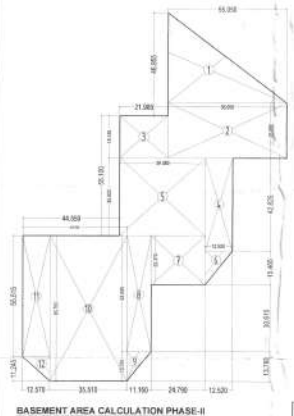

CALCULATION OF RAMPS AT UPPER BASEMENT AREA OF PHASE-II

SNO.	LENGTH	WIDTH	AREA (SQ.MT.)
1	4.460	38.000	169.480
2	4.460	38.000	169.480
TOTAL			338.960

CALCULATION OF U.G.T & PUMP ROOM AT UPPER BASEMENT AREA OF PHASE-II

SNO.	LENGTH	WIDTH	AREA (SQ.MT.)
1	8.890	5.025	24.341
2	8.890	25.080	222.646
TOTAL			226.987


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Prepared by: [Signature]

For K.N.S INFRACON PVT.LTD

GROUND TYPICAL & TYPICAL CORE AREA COUNT

ROOM TYPE	SUB	AREA	UNIT
1	01	17,792.100	4.02
2	02	10,000.100	4.02
3	03	10,000.100	4.02
4	04	10,000.100	4.02
5	05	15,520.240	40.00/1.00
6	06	1,800.000	40.00/1.00
7	07	2,000.000	40.00/1.00
8	08	1,000.000	1.00
9	09	1,000.000	1.00
10	10	1,000.000	1.00
100	100	1,000.000	1.00

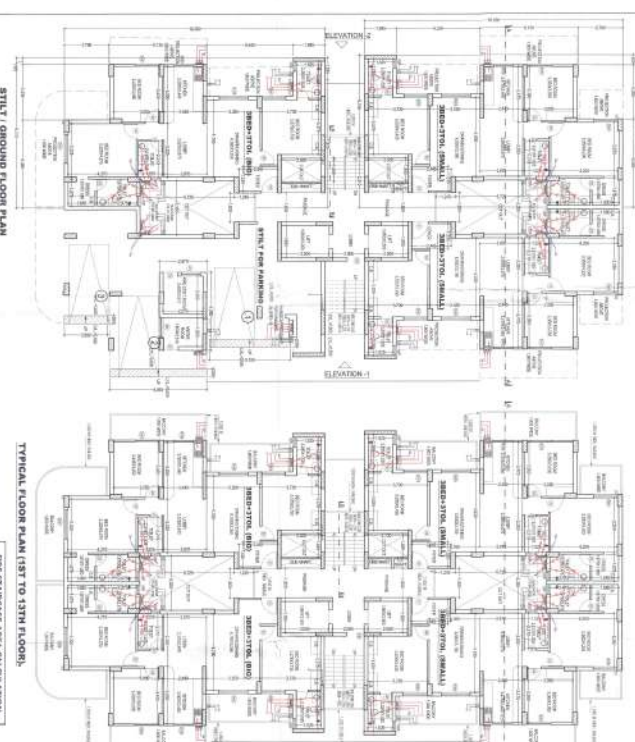

TYPICAL CORE AREA



3x10 WIDTH	LENGTH	AREA (SQ.MT)
1	1,800 x 1,800	3,240
2	6,000 x 2,800	16,800
3	7,920 x 2,800	22,176
4	1,460 x 2,800	4,088
5	0,200 x 3,460	692
6	1,800 x 1,800	3,240
TOTAL		36,836

REDUCTIONS

3x10 WIDTH	LENGTH	AREA (SQ.MT)
1	1,800 x 2,800	5,040
2	1,800 x 3,100	5,580
3	1,800 x 3,400	6,120
4	1,800 x 3,700	6,660
5	1,800 x 4,000	7,200
6	1,800 x 4,300	7,740
7	1,800 x 4,600	8,280
8	1,800 x 4,900	8,820
9	1,800 x 5,200	9,360
10	1,800 x 5,500	9,900
11	1,800 x 5,800	10,440
12	1,800 x 6,100	10,980
13	1,800 x 6,400	11,520
14	1,800 x 6,700	12,060
15	1,800 x 7,000	12,600
16	1,800 x 7,300	13,140
17	1,800 x 7,600	13,680
18	1,800 x 7,900	14,220
19	1,800 x 8,200	14,760
20	1,800 x 8,500	15,300
21	1,800 x 8,800	15,840
22	1,800 x 9,100	16,380
23	1,800 x 9,400	16,920
24	1,800 x 9,700	17,460
25	1,800 x 10,000	18,000
26	1,800 x 10,300	18,540
27	1,800 x 10,600	19,080
28	1,800 x 10,900	19,620
29	1,800 x 11,200	20,160
30	1,800 x 11,500	20,700
31	1,800 x 11,800	21,240
32	1,800 x 12,100	21,780
33	1,800 x 12,400	22,320
34	1,800 x 12,700	22,860
35	1,800 x 13,000	23,400
36	1,800 x 13,300	23,940
37	1,800 x 13,600	24,480
38	1,800 x 13,900	25,020
39	1,800 x 14,200	25,560
40	1,800 x 14,500	26,100
41	1,800 x 14,800	26,640
42	1,800 x 15,100	27,180
43	1,800 x 15,400	27,720
44	1,800 x 15,700	28,260
45	1,800 x 16,000	28,800
46	1,800 x 16,300	29,340
47	1,800 x 16,600	29,880
48	1,800 x 16,900	30,420
49	1,800 x 17,200	30,960
50	1,800 x 17,500	31,500
51	1,800 x 17,800	32,040
52	1,800 x 18,100	32,580
53	1,800 x 18,400	33,120
54	1,800 x 18,700	33,660
55	1,800 x 19,000	34,200
56	1,800 x 19,300	34,740
57	1,800 x 19,600	35,280
58	1,800 x 19,900	35,820
59	1,800 x 20,200	36,360
60	1,800 x 20,500	36,900
61	1,800 x 20,800	37,440
62	1,800 x 21,100	37,980
63	1,800 x 21,400	38,520
64	1,800 x 21,700	39,060
65	1,800 x 22,000	39,600
66	1,800 x 22,300	40,140
67	1,800 x 22,600	40,680
68	1,800 x 22,900	41,220
69	1,800 x 23,200	41,760
70	1,800 x 23,500	42,300
71	1,800 x 23,800	42,840
72	1,800 x 24,100	43,380
73	1,800 x 24,400	43,920
74	1,800 x 24,700	44,460
75	1,800 x 25,000	45,000
76	1,800 x 25,300	45,540
77	1,800 x 25,600	46,080
78	1,800 x 25,900	46,620
79	1,800 x 26,200	47,160
80	1,800 x 26,500	47,700
81	1,800 x 26,800	48,240
82	1,800 x 27,100	48,780
83	1,800 x 27,400	49,320
84	1,800 x 27,700	49,860
85	1,800 x 28,000	50,400
86	1,800 x 28,300	50,940
87	1,800 x 28,600	51,480
88	1,800 x 28,900	52,020
89	1,800 x 29,200	52,560
90	1,800 x 29,500	53,100
91	1,800 x 29,800	53,640
92	1,800 x 30,100	54,180
93	1,800 x 30,400	54,720
94	1,800 x 30,700	55,260
95	1,800 x 31,000	55,800
96	1,800 x 31,300	56,340
97	1,800 x 31,600	56,880
98	1,800 x 31,900	57,420
99	1,800 x 32,200	57,960
100	1,800 x 32,500	58,500
101	1,800 x 32,800	59,040
102	1,800 x 33,100	59,580
103	1,800 x 33,400	60,120
104	1,800 x 33,700	60,660
105	1,800 x 34,000	61,200
106	1,800 x 34,300	61,740
107	1,800 x 34,600	62,280
108	1,800 x 34,900	62,820
109	1,800 x 35,200	63,360
110	1,800 x 35,500	63,900
111	1,800 x 35,800	64,440
112	1,800 x 36,100	64,980
113	1,800 x 36,400	65,520
114	1,800 x 36,700	66,060
115	1,800 x 37,000	66,600
116	1,800 x 37,300	67,140
117	1,800 x 37,600	67,680
118	1,800 x 37,900	68,220
119	1,800 x 38,200	68,760
120	1,800 x 38,500	69,300
121	1,800 x 38,800	69,840
122	1,800 x 39,100	70,380
123	1,800 x 39,400	70,920
124	1,800 x 39,700	71,460
125	1,800 x 40,000	72,000
126	1,800 x 40,300	72,540
127	1,800 x 40,600	73,080
128	1,800 x 40,900	73,620
129	1,800 x 41,200	74,160
130	1,800 x 41,500	74,700
131	1,800 x 41,800	75,240
132	1,800 x 42,100	75,780
133	1,800 x 42,400	76,320
134	1,800 x 42,700	76,860
135	1,800 x 43,000	77,400
136	1,800 x 43,300	77,940
137	1,800 x 43,600	78,480
138	1,800 x 43,900	79,020
139	1,800 x 44,200	79,560
140	1,800 x 44,500	80,100
141	1,800 x 44,800	80,640
142	1,800 x 45,100	81,180
143	1,800 x 45,400	81,720
144	1,800 x 45,700	82,260
145	1,800 x 46,000	82,800
146	1,800 x 46,300	83,340
147	1,800 x 46,600	83,880
148	1,800 x 46,900	84,420
149	1,800 x 47,200	84,960
150	1,800 x 47,500	85,500
151	1,800 x 47,800	86,040
152	1,800 x 48,100	86,580
153	1,800 x 48,400	87,120
154	1,800 x 48,700	87,660
155	1,800 x 49,000	88,200
156	1,800 x 49,300	88,740
157	1,800 x 49,600	89,280
158	1,800 x 49,900	89,820
159	1,800 x 50,200	90,360
160	1,800 x 50,500	90,900
161	1,800 x 50,800	91,440
162	1,800 x 51,100	91,980
163	1,800 x 51,400	92,520
164	1,800 x 51,700	93,060
165	1,800 x 52,000	93,600
166	1,800 x 52,300	94,140
167	1,800 x 52,600	94,680
168	1,800 x 52,900	95,220
169	1,800 x 53,200	95,760
170	1,800 x 53,500	96,300
171	1,800 x 53,800	96,840
172	1,800 x 54,100	97,380
173	1,800 x 54,400	97,920
174	1,800 x 54,700	98,460
175	1,800 x 55,000	99,000
176	1,800 x 55,300	99,540
177	1,800 x 55,600	100,080
178	1,800 x 55,900	100,620
179	1,800 x 56,200	101,160
180	1,800 x 56,500	101,700
181	1,800 x 56,800	102,240
182	1,80	

ROOMS & WINDOWS SCHEDULE

NO.	TYPE	DESCRIPTION	AREA (SQ. FT.)	PERIMETER (LINEAR FT.)
1	OFFICE	OFFICE	1,114	1,114
2	OFFICE	OFFICE	1,114	1,114
3	OFFICE	OFFICE	1,114	1,114
100	OFFICE	OFFICE	1,114	1,114

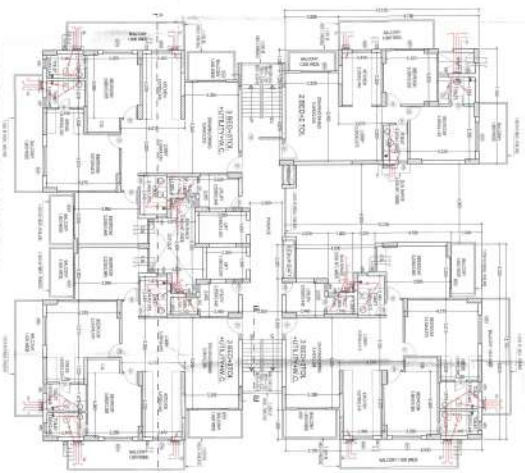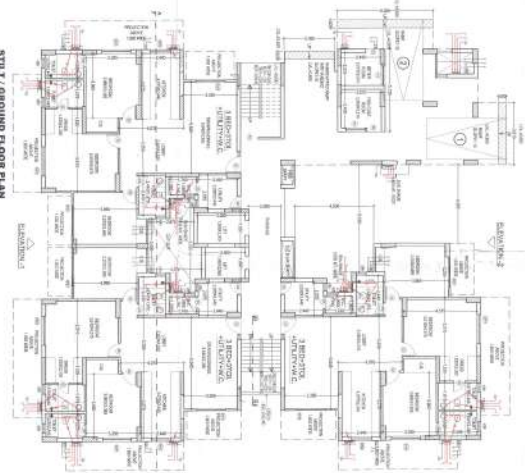

3 BED + 2 TOILET + UTILITY + W.C.

UNIT AREA = (7,100 X 12,180) = 86,487
 LESS AREA = 79,419 SQ. FT.

S.NO	WIDTH	LENGTH	AREA (SQ. FT.)
1	3,300	1,800	5,940
2	1,800	3,300	5,940
3	1,800	1,800	3,240
4	1,800	1,800	3,240
5	2,315	1,505	3,494
6	1,700	1,375	2,334
TOTAL AREA			25,188



GROUND CORE AREA

S.NO	WIDTH	LENGTH	AREA (SQ. FT.)
1	1,000	2,000	2,000
2	1,000	2,000	2,000
3	1,000	2,000	2,000
4	1,000	2,000	2,000
5	1,000	2,000	2,000
6	1,000	2,000	2,000
7	1,000	2,000	2,000
8	1,000	2,000	2,000
9	1,000	2,000	2,000
10	1,000	2,000	2,000
TOTAL AREA			20,000

TYPICAL CORE AREA

S.NO	WIDTH	LENGTH	AREA (SQ. FT.)
1	1,000	2,000	2,000
2	1,000	2,000	2,000
3	1,000	2,000	2,000
4	1,000	2,000	2,000
5	1,000	2,000	2,000
6	1,000	2,000	2,000
7	1,000	2,000	2,000
8	1,000	2,000	2,000
9	1,000	2,000	2,000
10	1,000	2,000	2,000
TOTAL AREA			20,000

STILT AREA

S.NO	WIDTH	LENGTH	AREA (SQ. FT.)
1	1,000	2,000	2,000
2	1,000	2,000	2,000
3	1,000	2,000	2,000
4	1,000	2,000	2,000
5	1,000	2,000	2,000
6	1,000	2,000	2,000
7	1,000	2,000	2,000
8	1,000	2,000	2,000
9	1,000	2,000	2,000
10	1,000	2,000	2,000
TOTAL AREA			20,000

FIRE CONT. & WETTER ROOM AREA

S.NO	WIDTH	LENGTH	AREA (SQ. FT.)
1	3,105	2,397	7,450
TOTAL			7,450

NET TYPICAL CORE AREA

S.NO	WIDTH	LENGTH	AREA (SQ. FT.)
1	1,000	2,000	2,000
2	1,000	2,000	2,000
3	1,000	2,000	2,000
4	1,000	2,000	2,000
5	1,000	2,000	2,000
6	1,000	2,000	2,000
7	1,000	2,000	2,000
8	1,000	2,000	2,000
9	1,000	2,000	2,000
10	1,000	2,000	2,000
TOTAL AREA			20,000

CALCULATION OF STILT AREA

S.NO	WIDTH	LENGTH	AREA (SQ. FT.)
1	0,261	2,225	582
2	0,261	0,950	248
3	5,001	2,285	11,431
4	2,101	3,285	6,903
5	2,101	6,555	13,773
6	2,095	3,585	7,511
7	2,770	3,585	9,928
8	1,005	3,055	3,072
TOTAL			55,668

FIRE STAIRCASE AREA CALCULATION

S.NO	WIDTH	LENGTH	AREA (SQ. FT.)
1	4,710	2,100	9,891
TOTAL			9,891

PROJECT TITLE: APPROVAL OF REVISED BUILDING PLAN OF COLONY POLYVALENT SCHEME ON A PLOT OF 1201 SQ.M (28.01 AC) LOCATED AT THE INTERSECTION OF BANGALORE HIGHWAY & N. S. STREET, BANGALORE.

GROUNDING TITLE: GROUNDING TYPICAL & TOWER - 4H (1ST TO 12TH FLOOR)

SCALE: 1/100

DATE: 27/07/23

DRWG: DEEPAK KHETRA & ASSOCIATES

PROJECT LOCATION: BANGALORE

PROJECT NO.: S-09

PROJECT ADDRESS: BANGALORE

PROJECT CONTACT: DEEPAK KHETRA & ASSOCIATES

PROJECT PHONE: 98454 44444

PROJECT EMAIL: DEEPAK@DKA.CO

PROJECT WEBSITE: WWW.DKA.CO

PROJECT SOCIAL MEDIA: FACEBOOK: DKA, INSTAGRAM: DKA, TWITTER: DKA

PROJECT LEGAL: DEEPAK KHETRA & ASSOCIATES, BANGALORE

PROJECT REGISTRATION: DEEPAK KHETRA & ASSOCIATES, BANGALORE

PROJECT CERTIFICATION: DEEPAK KHETRA & ASSOCIATES, BANGALORE

PROJECT APPROVAL: DEEPAK KHETRA & ASSOCIATES, BANGALORE

PROJECT REVIEW: DEEPAK KHETRA & ASSOCIATES, BANGALORE

PROJECT CHECK: DEEPAK KHETRA & ASSOCIATES, BANGALORE

PROJECT VERIFY: DEEPAK KHETRA & ASSOCIATES, BANGALORE

PROJECT CONFIRM: DEEPAK KHETRA & ASSOCIATES, BANGALORE

PROJECT SIGN: DEEPAK KHETRA & ASSOCIATES, BANGALORE

PROJECT SEAL: DEEPAK KHETRA & ASSOCIATES, BANGALORE

PROJECT STAMP: DEEPAK KHETRA & ASSOCIATES, BANGALORE

PROJECT SIGNATURE: DEEPAK KHETRA & ASSOCIATES, BANGALORE

PROJECT NAME: DEEPAK KHETRA & ASSOCIATES, BANGALORE

PROJECT ADDRESS: BANGALORE

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PROJECT LEGAL: DEEPAK KHETRA & ASSOCIATES, BANGALORE

PROJECT REGISTRATION: DEEPAK KHETRA & ASSOCIATES, BANGALORE

PROJECT CERTIFICATION: DEEPAK KHETRA & ASSOCIATES, BANGALORE

PROJECT APPROVAL: DEEPAK KHETRA & ASSOCIATES, BANGALORE

PROJECT REVIEW: DEEPAK KHETRA & ASSOCIATES, BANGALORE

PROJECT CHECK: DEEPAK KHETRA & ASSOCIATES, BANGALORE

PROJECT VERIFY: DEEPAK KHETRA & ASSOCIATES, BANGALORE

PROJECT CONFIRM: DEEPAK KHETRA & ASSOCIATES, BANGALORE

PROJECT SIGN: DEEPAK KHETRA & ASSOCIATES, BANGALORE

PROJECT SEAL: DEEPAK KHETRA & ASSOCIATES, BANGALORE

PROJECT STAMP: DEEPAK KHETRA & ASSOCIATES, BANGALORE


PROJECT SIGNATURE: DEEPAK KHETRA & ASSOCIATES, BANGALORE

PROJECT NAME: DEEPAK KHETRA & ASSOCIATES, BANGALORE




ROOM & WINDOW SCHEDULE

NO.	ROOM	AREA (SQ. FT.)	AREA (SQ. MET.)	TYPE
1	OFFICE	1,000	92.9	2,500
2	CONFERENCE	200	18.6	2,500
3	RECEPTION	100	9.3	2,500
4	STORAGE	50	4.6	2,500
5	RESTROOM	50	4.6	2,500
6	MEETING	100	9.3	2,500
7	TRAINING	200	18.6	2,500
8	WORKSHOP	300	27.9	2,500
9	LABORATORY	400	37.2	2,500
10	SERVER	50	4.6	2,500
11	SERVER	50	4.6	2,500
12	SERVER	50	4.6	2,500
13	SERVER	50	4.6	2,500
14	SERVER	50	4.6	2,500
15	SERVER	50	4.6	2,500
16	SERVER	50	4.6	2,500
17	SERVER	50	4.6	2,500
18	SERVER	50	4.6	2,500
19	SERVER	50	4.6	2,500
20	SERVER	50	4.6	2,500

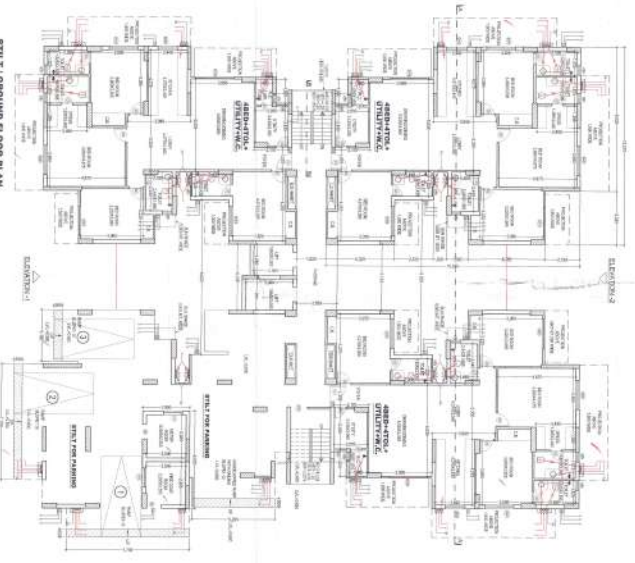

STILT GROUND FLOOR PLAN
 PARKING PROVIDED IN TOWER - 1 @ 03 ECR.

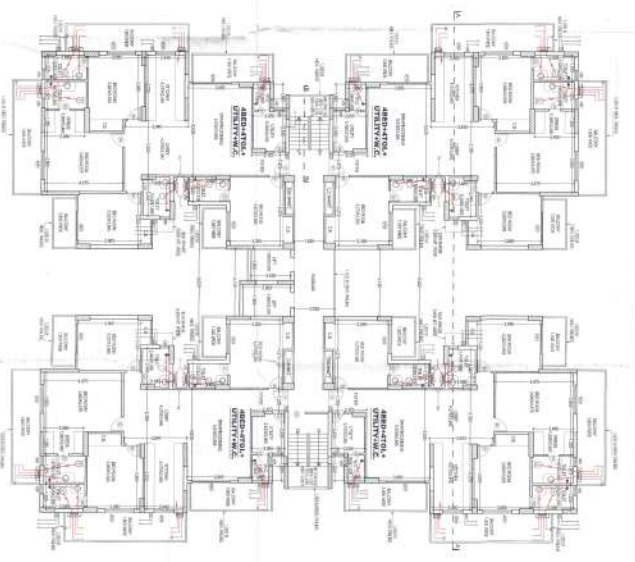


TYPICAL FLOOR PLAN (1ST TO 15TH FLOOR)

ABSD-4-TOLLET-UTILITY-W.C.

UNIT AREA - (12.270 x 33.800) = 38.522
 38.041 (LESS AREA) = 37.481 SQ. MT.

S.NO	WIDTH	LENGTH	AREA (SQ. MT.)
1	3.305	2.150	7.104
2	1.850	1.585	2.930
3	1.525	0.900	1.373
4	2.200	2.100	4.620
5	2.200	2.100	4.620
6	2.200	2.100	4.620
7	4.550	0.340	1.547
8	3.925	1.130	4.433
9	1.925	0.575	1.104
10	1.925	0.575	1.104
11	1.925	0.575	1.104
100	1.925	0.575	1.104

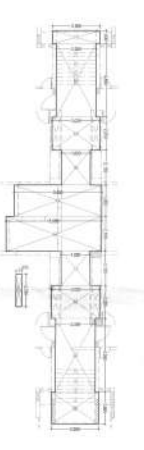



GROUND CORE AREA

S.NO	WIDTH	LENGTH	AREA (SQ. MT.)
1	0.850	2.900	2.465
2	0.850	2.900	2.465
3	0.850	2.900	2.465
100	0.850	2.900	2.465



TYPICAL CORE AREA

S.NO	WIDTH	LENGTH	AREA (SQ. MT.)
1	0.850	2.900	2.465
2	0.850	2.900	2.465
3	0.850	2.900	2.465
4	0.850	2.900	2.465
5	0.850	2.900	2.465
6	0.850	2.900	2.465
7	0.850	2.900	2.465
8	0.850	2.900	2.465
9	0.850	2.900	2.465
10	0.850	2.900	2.465
11	0.850	2.900	2.465
12	0.850	2.900	2.465
13	0.850	2.900	2.465
14	0.850	2.900	2.465
15	0.850	2.900	2.465
16	0.850	2.900	2.465
17	0.850	2.900	2.465
18	0.850	2.900	2.465
19	0.850	2.900	2.465
20	0.850	2.900	2.465
21	0.850	2.900	2.465
22	0.850	2.900	2.465
23	0.850	2.900	2.465
24	0.850	2.900	2.465
25	0.850	2.900	2.465
26	0.850	2.900	2.465
27	0.850	2.900	2.465
28	0.850	2.900	2.465
29	0.850	2.900	2.465
30	0.850	2.900	2.465
31	0.850	2.900	2.465
32	0.850	2.900	2.465
33	0.850	2.900	2.465
34	0.850	2.900	2.465
35	0.850	2.900	2.465
36	0.850	2.900	2.465
37	0.850	2.900	2.465
38	0.850	2.900	2.465
39	0.850	2.900	2.465
40	0.850	2.900	2.465
41	0.850	2.900	2.465
42	0.850	2.900	2.465
43	0.850	2.900	2.465
44	0.850	2.900	2.465
45	0.850	2.900	2.465
46	0.850	2.900	2.465
47	0.850	2.900	2.465
48	0.850	2.900	2.465
49	0.850	2.900	2.465
50	0.850		

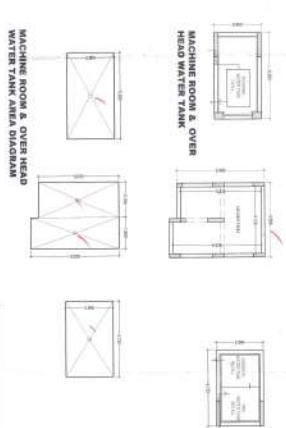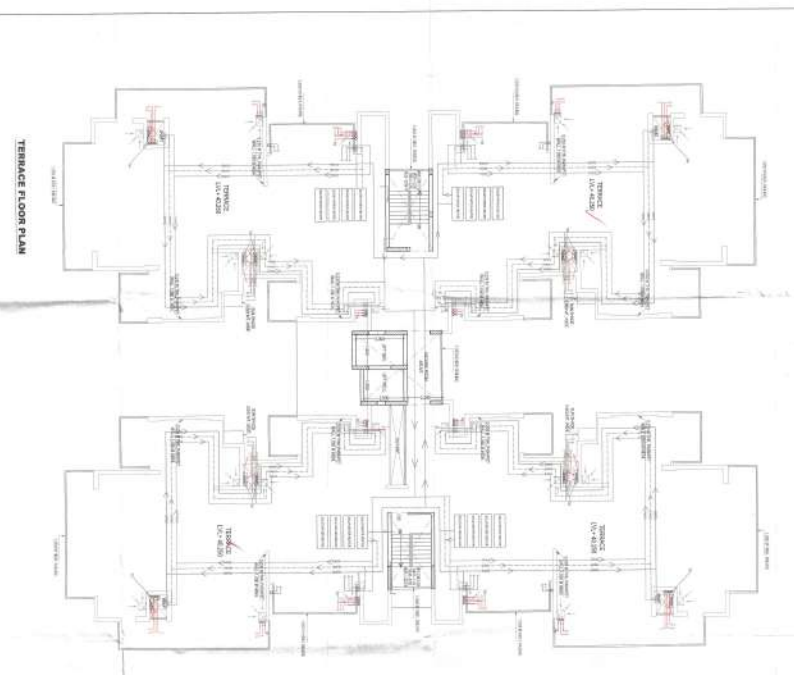


NO.	WIDTH	LENGTH	AREA (SQ.M)
1	5.300	2.900	15.375
2	5.300	2.900	15.375
3	1.500	5.525	8.288
4	4.200	2.900	12.180
TOTAL			51.018

- LEGEND**
- 1. TOILET
 - 2. UTILITY
 - 3. WATER CLOSET
 - 4. BATH
 - 5. BED ROOM
 - 6. BALCONY
 - 7. CORRIDOR
 - 8. STAIRCASE
 - 9. FIRE CONTROL ROOM
 - 10. FIRE ESCAPE
 - 11. M/R
 - 12. NO. OF UNITS

Area details	203 245-1	203 245-2	203 245-3	203 245-4	203 245-5	203 245-6	203 245-7	203 245-8	203 245-9	203 245-10	203 245-11	203 245-12
Ground/Slit Floor	73,357	73,357	73,357	73,357	73,357	73,357	73,357	73,357	73,357	73,357	73,357	73,357
First Floor	871,375	871,375	871,375	871,375	871,375	871,375	871,375	871,375	871,375	871,375	871,375	871,375
Second Floor	871,375	871,375	871,375	871,375	871,375	871,375	871,375	871,375	871,375	871,375	871,375	871,375
Third Floor	871,375	871,375	871,375	871,375	871,375	871,375	871,375	871,375	871,375	871,375	871,375	871,375
Fourth Floor	871,375	871,375	871,375	871,375	871,375	871,375	871,375	871,375	871,375	871,375	871,375	871,375
Fifth Floor	871,375	871,375	871,375	871,375	871,375	871,375	871,375	871,375	871,375	871,375	871,375	871,375
Sixth Floor	871,375	871,375	871,375	871,375	871,375	871,375	871,375	871,375	871,375	871,375	871,375	871,375
Seventh Floor	871,375	871,375	871,375	871,375	871,375	871,375	871,375	871,375	871,375	871,375	871,375	871,375
Eighth Floor	871,375	871,375	871,375	871,375	871,375	871,375	871,375	871,375	871,375	871,375	871,375	871,375
Ninth Floor	871,375	871,375	871,375	871,375	871,375	871,375	871,375	871,375	871,375	871,375	871,375	871,375
Tenth Floor	871,375	871,375	871,375	871,375	871,375	871,375	871,375	871,375	871,375	871,375	871,375	871,375
Eleventh Floor	871,375	871,375	871,375	871,375	871,375	871,375	871,375	871,375	871,375	871,375	871,375	871,375
Twelfth Floor	871,375	871,375	871,375	871,375	871,375	871,375	871,375	871,375	871,375	871,375	871,375	871,375
M/R, mummy												51,698
Total	11,656,668	898,338	186,170	0,000	51,698	51						

PROJECT TITLE: APPROVAL OF LETTER BUILDING PLAN FOR TOWER J, 12/F, 13/F, 14/F, 157/F, 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MUMTY AREA



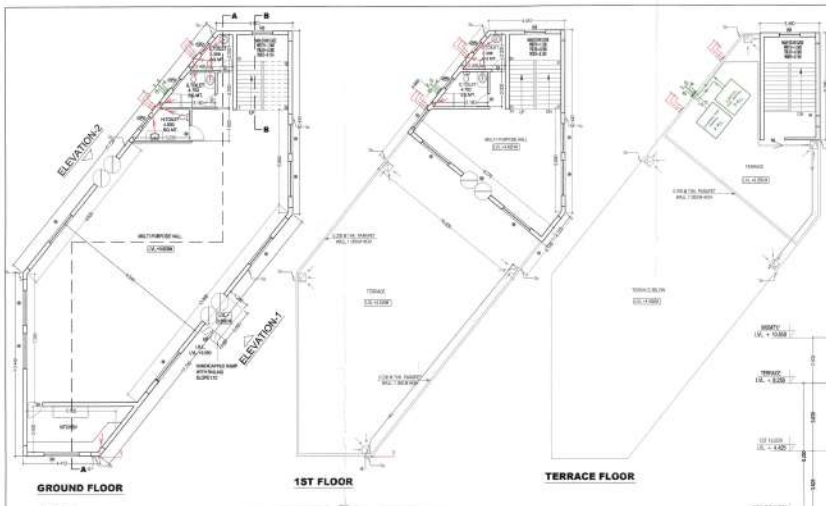
S.NO	WIDTH	LENGTH	AREA (SQM)
1	3.460	6.095	= 21.089
TOTAL AREA			= 21.089

REVISIONS/DETAILS

NO.	DESCRIPTION	DATE
1	ISSUED FOR PERMIT	01/01/2024
2	FOR APPROVAL	01/01/2024
3	FOR APPROVAL	01/01/2024
4	FOR APPROVAL	01/01/2024
5	FOR APPROVAL	01/01/2024
6	FOR APPROVAL	01/01/2024
7	FOR APPROVAL	01/01/2024

LEVEL ELEVATION

S.NO	TYPE	SIZE	SQ. LVL.
1	D	0.750x2.100	1.575
2	D	0.900x2.100	1.890
3	D	1.200x2.100	2.520
4	VP	0.750x1.500	1.125
5	W	2.000x2.400	4.800
6	W	2.000x1.400	2.800
7	W	1.200x2.100	2.520

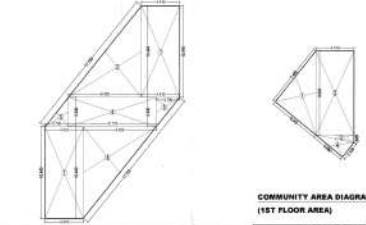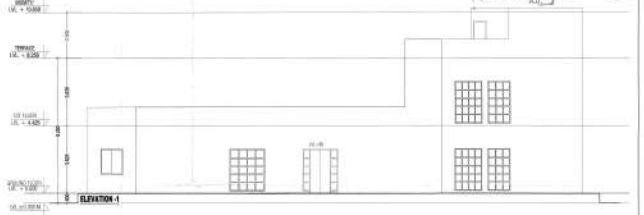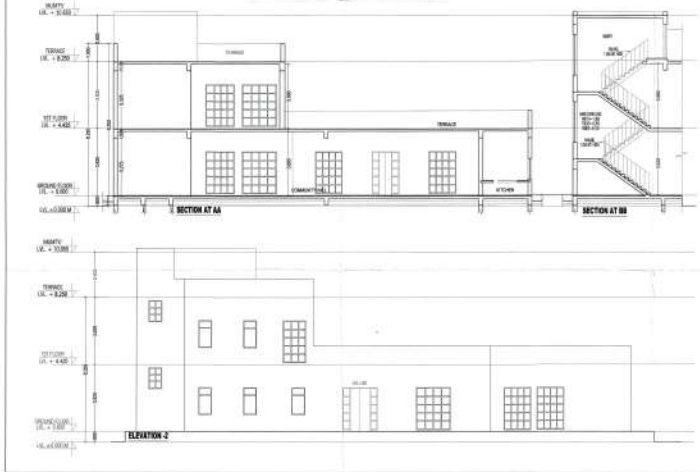

COMMUNITY AREA DIAGRAM (GR. FLOOR AREA)

S.NO	WIDTH	LENGTH	AREA (SQM)
1	4.430	10.640	= 47.135
2	8.455	10.640	= 90.000
3	2.700	3.330	= 9.000
4	10.170	3.330	= 33.866
5	2.700	3.330	= 9.000
6	8.455	10.640	= 90.000
7	4.430	10.640	= 47.135
TOTAL AREA			= 223.208

COMMUNITY AREA DIAGRAM (1ST FLOOR AREA)

S.NO	WIDTH	LENGTH	AREA (SQM)
1	7.460	6.090	= 45.414
2	4.430	9.600	= 42.348
3	4.430	0.945	= 4.186
4	2.125	3.960	= 8.415
TOTAL AREA			= 70.936

TOTAL COMMUNITY P.A.R. AREA
 GR. FL. AREA = 223.208 SQ. MT.
 1ST FL. AREA = 70.936 SQ. MT.
 TOTAL AREA = 294.144 SQ. MT.


TOTAL COMMUNITY GR. COVERAGE
 GR. FL. AREA = 223.208 SQ. MT.

PREPARED BY:
 APPROVAL FOR EXISTING BUILDINGS PLAN
 APPROVAL FOR NEW BUILDINGS PLAN
 APPROVAL FOR PERMITTED WORKS PLAN
 APPROVAL FOR ELECTRICAL WORKS PLAN
 APPROVAL FOR MECHANICAL WORKS PLAN
 APPROVAL FOR PLUMBING WORKS PLAN
 APPROVAL FOR SANITARY WORKS PLAN
 APPROVAL FOR STRUCTURAL WORKS PLAN
 APPROVAL FOR OTHERS

DESIGNED BY:
 FLOOR PLAN, AREA COMPUTATION & ELEVATION
 (COMMUNITY BUILDING)
 (GROUND FLOOR)



DATE: 01/01/2024
SCALE: AS SHOWN
DRG. NO.: S-18

DEEPAK MEHTA & ASSOCIATES
 ARCHITECTS, ENGINEERS, INTERIORS & DESIGNERS
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DOORS & WINDOWS SCHEDULE					
S.NO	TYPE	SIZE	S.LVL	LVL	REMARKS
1	D	0.7500 x 1.00	± 0.0	2.100	CLASS ROOM
2	D1	0.8000 x 1.00	± 0.0	2.100	STAFF ROOM DOOR
3	D2	1.0000 x 1.00	± 0.0	2.100	HANGING TOILET
4	DS	1.5000 x 1.00	± 0.0	2.100	TOILET
5	W1	1.8000 x 1.00	+ 0.000	1.000	CLASS ROOM
6	WV1	1.5000 x 1.50	+ 1.000	1.000	TOILET
7	V1	0.7500 x 1.50	+ 1.000	1.000	TOILET

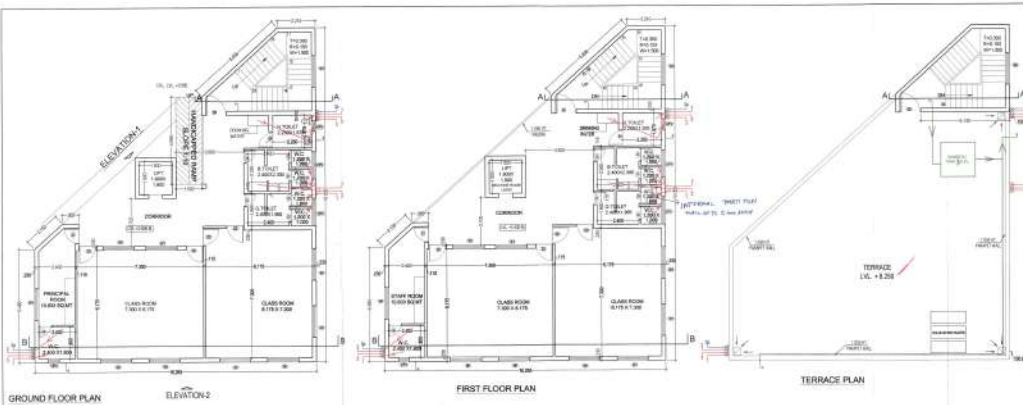
MUMTY AREA CALCULATION			
S.NO	LENGTH	WIDTH	AREA (SQ.MT.)
1	4.363	1.025	= 4.475
2	4.365	3.905	= 17.045
3	2.250	4.960	= 11.160
TOTAL AREA			32.680



NURSERY SCHOOL
 TOTAL PLOT AREA FOR SCHOOL = 970.606 SQ.MT.
 PERMISSIBLE F.A.R. = 100% OF 0.2 ACRE OR 100% OF 609.370 SQ.MT.
 PROPOSED F.A.R. = 443.118 SQ.MT.
PROPOSED F.A.R. AREA CALCULATION
 PROPOSED F.A.R. AT GROUND FLOOR = 221.559 SQ.MT.
 PROPOSED F.A.R. AT FIRST FLOOR = 221.559 SQ.MT.
TOTAL F.A.R. AREA AT ALL FLOORS = 443.118 SQ.MT.

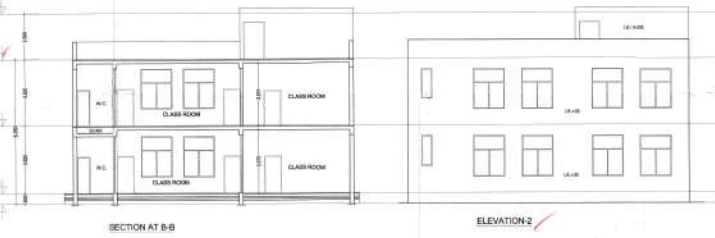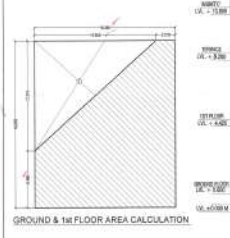REQUIRED PARKING
 PLOT AREA x 10 / 100 = 609.370 x 10 / 100 = 60.937 SQ.MT.
PROVIDED PARKING

GROUND FLOOR			
NURSERY SCHOOL AREA CALCULATION			
GROUND FL AREA = (16.765 x 18.075) - LESS AREA = 305.930 - 88.371 = 221.559 SQ.MT.			
S.NO	LENGTH	WIDTH	AREA (SQ.MT.)
1	16.765	18.075	= 305.930
LESS AREA			= 88.371
TOTAL AREA = 221.559			

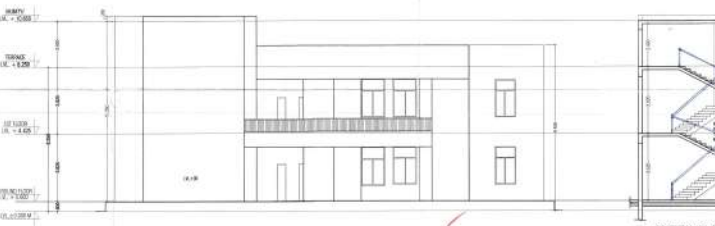

NURSERY SCHOOL SITE AREA

S.NO	WIDTH	LENGTH	LESS AREA	AREA (SQ.MT.)
1	36.25	11.340	=	411.101
2	1.695	36.435	(0.5)	= 29.184
3	15.700	22.150	(0.5)	= 284.120
4	11.050	22.550	=	249.175
5	11.050	0.545	(0.5)	= 3.011
TOTAL				976.691

JOB TITLE
 FLOOR PLAN, ELEVATION, SECTION & AREA DETAIL (G-1)


DATE
 20/10/2024

SCALE
 1:100


PROJECT
 Deepak Mittal and Associates
 Floor - 10, Ashok Park L.I.C.,
 MIDC, Ashok Park L.I.C.

ARCHITECT'S SIGN
 DEEPAK MITTAL & ASSOCIATES
 PLOT NO. 10, ASHOK PARK L.I.C., MIDC, ASHOK PARK L.I.C.

OWNER'S SIGN
 PLOT NO. 10, ASHOK PARK L.I.C., MIDC, ASHOK PARK L.I.C.

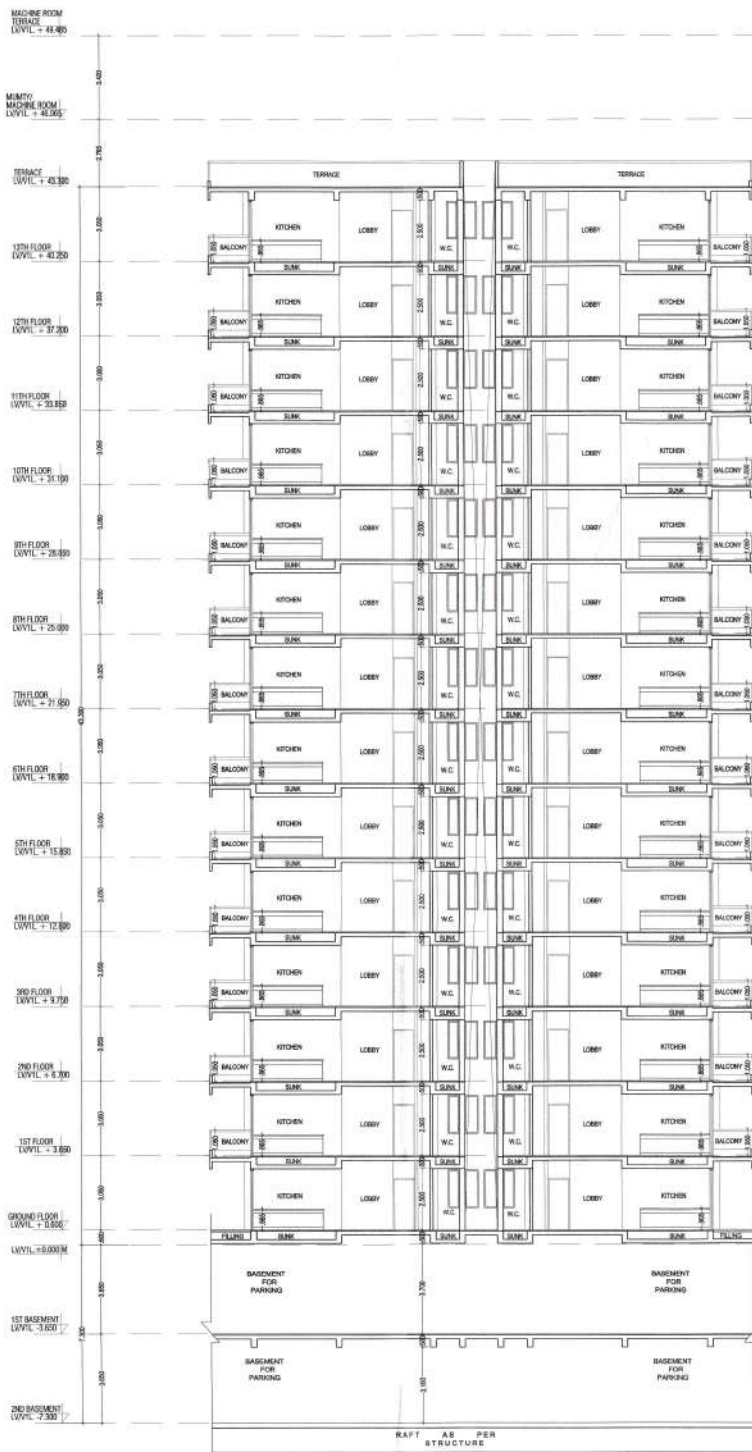

SECTION AT A-A

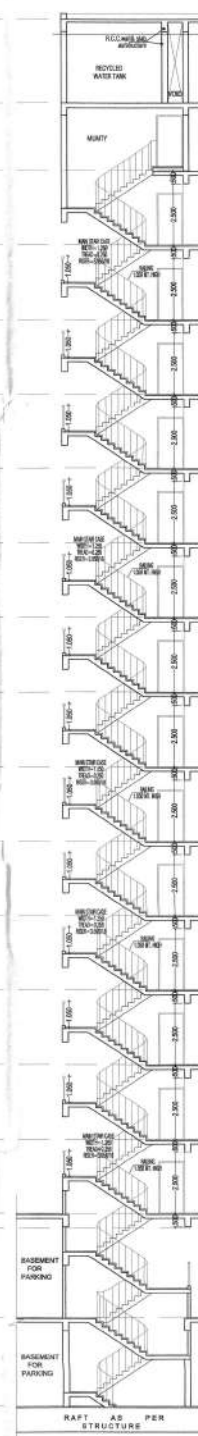

SECTION AT B-B

DTP (H) Member Secretary B.P.C.
 V.P. (D) Member B.P.C.
 C.T.P. (H) Chairman B.P.C.
 AD SATEJ SINGH
 ED DEV KUMAR
 PA PREM KUMAR
 ATP PREEMA SINGH

PROJECT TITLE:
 APPROVAL OF REVISED BUILDING PLAN OF GROUP HOUSING SCHEME ON AREA MEASURING 10.462 ACRES (License No. 14 of 2011 Dated 16.04.2011) IN SEC-11(A)/11, GURGAON MANESAR URBAN COMPLEX BEING DEVELOPED BY K.N.S INFRACON PVT.LTD.AND OTHERS

DRAWING TITLE:-
 SECTIONS (TOWER -B&C) (Slab / Ground +13)


DRG NO.
 S-22

SCALE: 1:100
DATE: 2013/01/29
DEALT:
JOB NO.: V\Comp\TD\TAS\EE\SUBM\SS\ON\2013\11_SUBM\SS\ON\PHASE-L_CLUSTERS

DEEPAK MEHTA & ASSOCIATES
 ARCHITECTS, PLANNERS, VALUERS, LANDSCAPE & INTERIORS PLOT NO. 16 ABHISHEK PLAZA L.S.C. MAYUR V/V11HAR PH II DELHI 91 PH: 65272180 TELEFAX: 22770180

(RAM SUTAR BASSI) (BALWANT SINGH)
 Architect Deepak Mehta
 DEEPAK MEHTA & ASSOCIATES LSC
 Mayur Vihar Ph-II, Delhi-91
 ARCHITECT'S SIGN OWNERS SIGN

ELEVATIONS

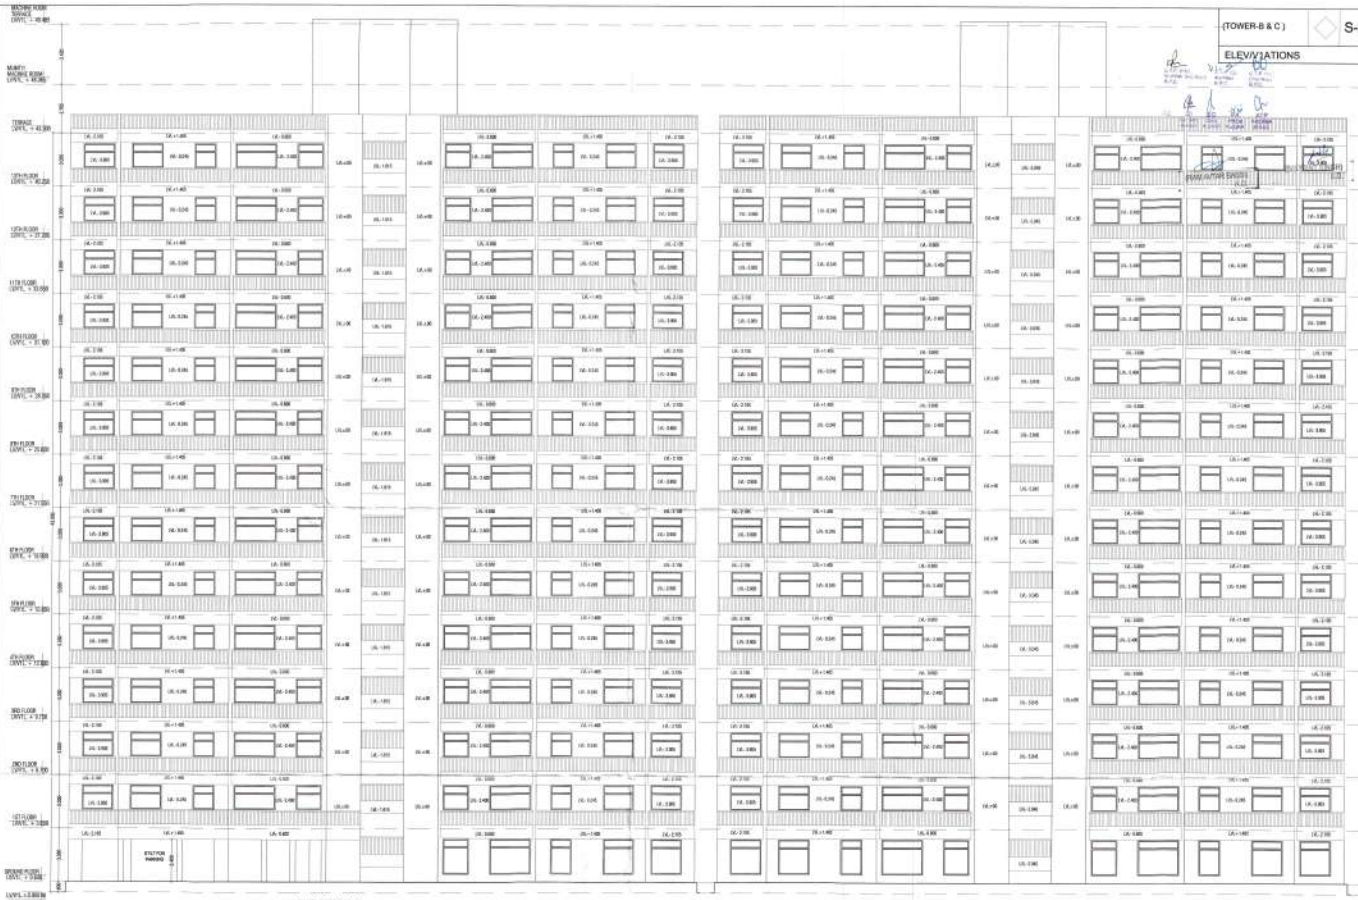

ELEVATION - 1

ELEVATION - 2

PROJECT TITLE:

APPROVAL OF REQUIRED BUILDING PLAN OF GROUP HOUSING SCHEME ON AREA MEASURING 10.462 ACRES/Licence No. 34 of 2011 Dated 18.04.2011 JKSR-18A/11, DUNGUN MANEKAR URBAN COMPLEX BEING DEVELOPED BY M.N.S. INTRACON PVT.LTD AND OTHERS

DRAWING TITLE:

ELEVATIONS (TOWER - B&C) (S/R / Ground +13)

S-23

DRG NO.

SCALE: 1/100

DATE: 20/07/19

DEALT


JOB NO: C:\p\2019\20190720\SUBMISSION\PHASE-1\041719

DEEPAK MEHTA & ASSOCIATES

ARCHITECTS, PLANNERS, VISUALISERS, LANDSCAPE & INTERIORS. PLOT NO. 16, BRIDGE PLAZA, L.C. MAYER V/VI/19/47 PH II, DELHI 91. PH: 65272160 TEL/FAX: 22770160

Approved by
COMMISSIONER
MUNICIPALITY
ARCHITECTS SIGN

For M.N.S. INTRACON PVT. LTD.
OWNERS SIGN

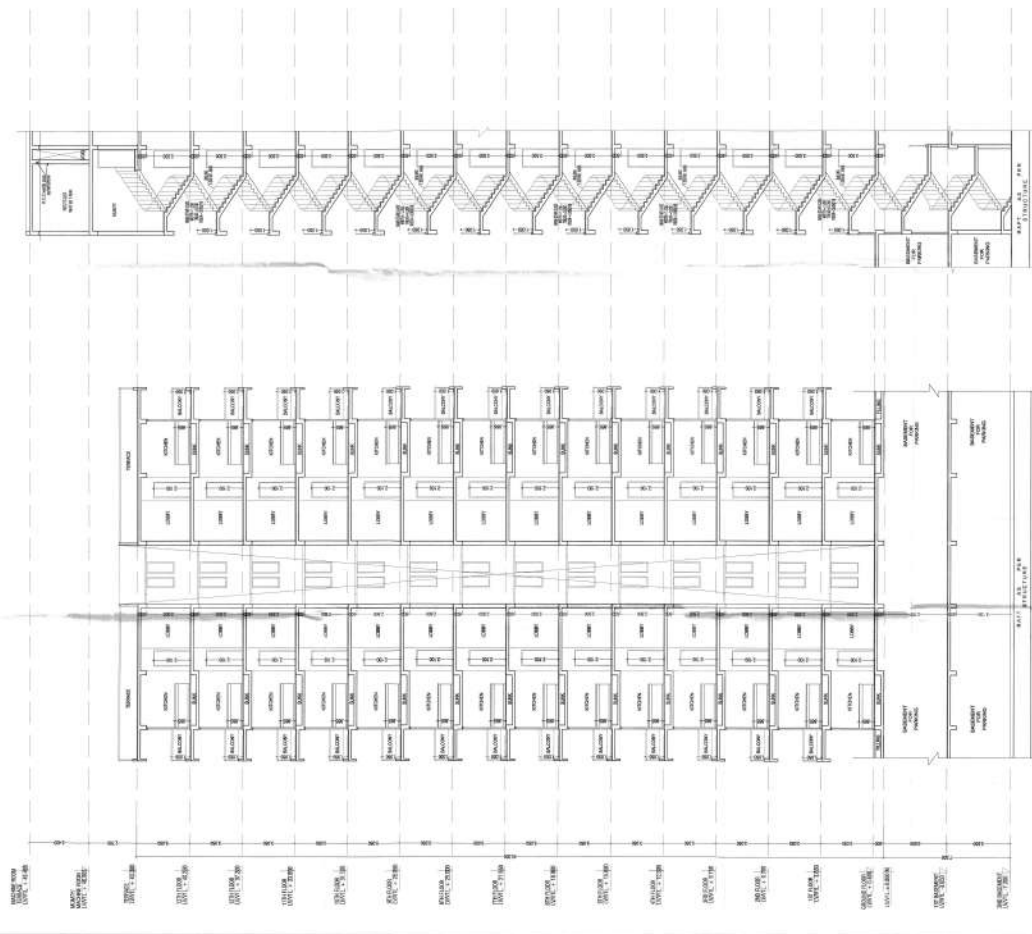

SECTION AT B-B

SECTION AT A-A

APPROVED FOR CONSTRUCTION
DATE: 20/03/20
BY: [Signature]

<p>PROJECT TITLE: APPROVAL OF ADVISED BUILDING PLAN OF GROUP APPROVAL NO. 14 OF 2019 UNDER THE BUILDING REGULATIONS, 1947 AND THE BUILDING CONTROL REGULATIONS, 1975 COMPILED BY: [Name]</p>	<p>DRAWING TITLE: (TOWER 2/FAS) (SEE COLUMN #1)</p>	<p>SCALE: 1/30 DATE: 20/03/20</p>	<p>DESIGNER: S-26</p>	<p>PROJECT NO: [Number]</p>
<p>APPROVED FOR CONSTRUCTION DATE: 20/03/20 BY: [Signature]</p>	<p>DEEPAK MEHTA & ASSOCIATES ARCHITECTS ARCHITECTS & INTERIORS ADDRESS: P-24, L-2, K. V. ROAD, V/VIHAR INDIA - 110016 PHONE: 011-26271180 TELE: 011-26271182</p>	<p>PROJECT NO: [Number]</p>	<p>PROJECT NO: [Number]</p>	<p>PROJECT NO: [Number]</p>



ELEVATION -1

ELEVATION -2


PROJECT TITLE:
APPROVAL OF REVISED BUILDING PLAN OF GROUP
HOUSING SCHEME ON AREA MEASURING 10.462
ACRES (Scheme No. 34 of 2013 dated 18.04.2013) IN
SEC-11B/111, DURGAM MANIKHAR URBAN COMPLEX BEING
DEVELOPED BY K.S.S INFRACON PVT.LTD. AND OTHERS

DRAWING TITLE:
ELEVATIONS
(TOWER-H)
(S/R / Ground +12)

S-29
SCALE: 1/30
DATE: 20/10/20
DRAWN BY: [Signature]
JOB NO: [Number]

DEEPAK MEHTA & ASSOCIATES
ARCHITECTS, PLANNERS, ENGINEERS,
LANDSCAPE & INTERIORS PLOT NO. 10
ADITHYAN PUNJ, U.S.C. WAZIRpur ROAD, PH
8, DELHI 91 PH: 83272180 TELEFAX:
22770186

APPROVED BY: [Signature]
DATE: [Date]
FOR K.S.S INFRACON PVT. LTD.
ARCHITECT'S SIGN: [Signature]

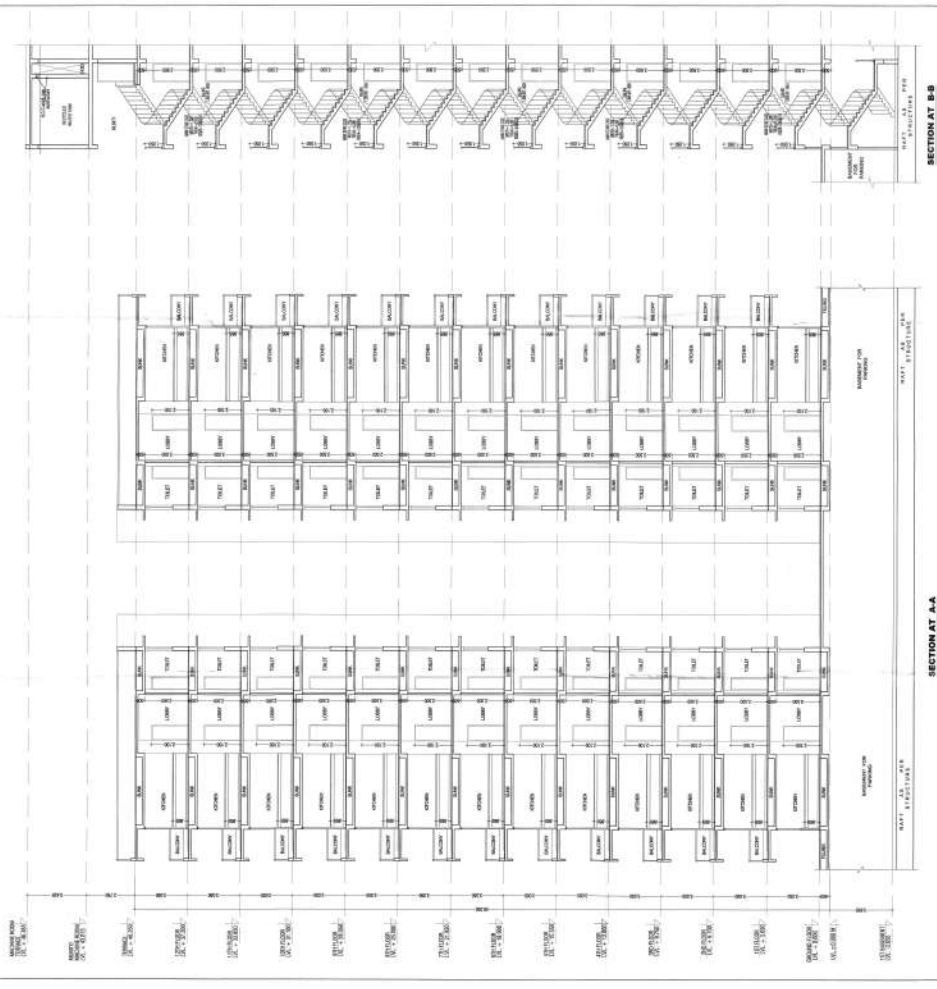

SECTION AT B-B

SECTION AT A-A

APPROVED BY: [Signature]
DATE: 15/08/2019
SCALE: AS SHOWN
PROJECT: [Project Name]

<p>PROJECT TITLE: APPROVAL OF REVISED BUILDING PLAN OF GROUP HOUSING SCHEME ON AREA OF 23.12 Ha at 104/44/2011/10 SEC. (I) & (II), SHENG DEVELOPED BY K. S. INFRACON PVT. LTD. AND OTHERS</p>	<p>DRAWING TITLE: SECTIONS TOWER-I (Part of S-30)</p>	<p>DATE: 28/08/2019 SCALE: 1/30 JOB NO: [Job No.]</p>	<p>DESIGNED BY: [Name] CHECKED BY: [Name] DATE: 15/08/2019</p>	<p>DEEPAK NEHTA & ASSOCIATES ARCHITECTS & INTERIORS LANDINGS, 1ST FLOOR, WALKER ROAD, ANANDAPURAM, CHENNAI - 600 029 PH: 044-26222222 FAX: 044-26222222 WWW.DNAARCHITECTS.COM</p>
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PROJECT TITLE:
APPROVAL OF REVISED BUILDING PLAN OF GROUP
HOUSING SCHEME ON AREA MEASURING 10.462
ACRES (G.O.No. 24 of 2011 Dated 16.04.2011) IN
SEC-11(A/II), GURGAON MANESAR URBAN COMPLEX BEING
DEVELOPED BY E.N.S INFRACON PVT. LTD AND OTHERS

DRAWING TITLE:
ELEVATIONS
(TOWER-1)
(S/8 / Ground +12)

S-31
SCALE: 1/50
DATE: 2010/02
DRAFTER: [Signature]
CHECKER: [Signature]

DEEPAK MEHTA & ASSOCIATES
ARCHITECTS, PLANNERS, INTERIORS,
LANDSCAPE & INTERIORS. FLOOR NO. 10,
AMBODIA PLAZA, I.I.C.T., MAJAPUR, PH
8 DELHI 91. PH: 85272190 TEL: 7442
22779780

ARCHITECTS SIGN: [Signature]
ENGINEER SIGN: [Signature]
PROJECT TITLE: APPROVAL OF REVISED BUILDING PLAN OF GROUP HOUSING SCHEME ON AREA MEASURING 10.462 ACRES (G.O.No. 24 of 2011 Dated 16.04.2011) IN SEC-11(A/II), GURGAON MANESAR URBAN COMPLEX BEING DEVELOPED BY E.N.S INFRACON PVT. LTD AND OTHERS



PROJECT TITLE:
APPROVAL OF REVISED BUILDING PLAN OF GROUP
HOUSING SCHEME ON AREA MEASURING 10.442
ACRES/REGULATIONS No. 24 of 2017 DATED 10.04.2017 IN
SEC-11A/II/11, GURGAON MANESAR URBAN COMPLEX BEING
DEVELOPED BY K.N.S INFRACON PVT.LTD AND OTHERS



DRAWING TITLE:
ELEVATIONS
(TOWER-J)
(SIB / Ground +12)

S-33
DATE: 20170228
SCALE: 1:50
DRAWN BY: [Signature]
CHECKED BY: [Signature]

DEEPAK MEHTA & ASSOCIATES
ARCHITECTS, PLANNERS, VALUERS,
LANDSCAPE & INTERIORS. PLOT NO. 18
AMBNEY PLAZA, S.C.C. MANSAR VILLAGE PH
B DELHI 81 PH: 80271180 TELEFAX:
22770180

ARCHITECTS SIGN: [Signature]
OWNER'S SIGN: [Signature]

S-34

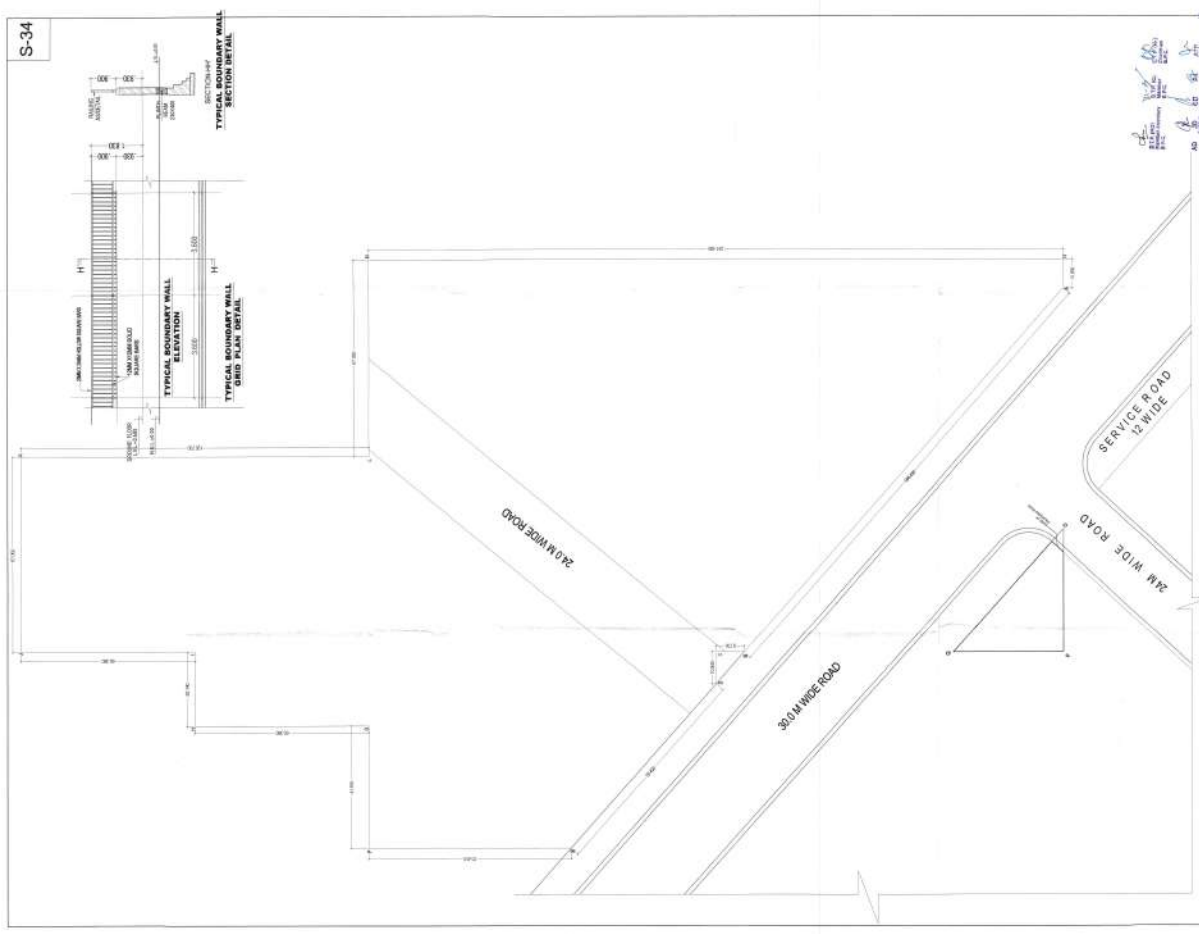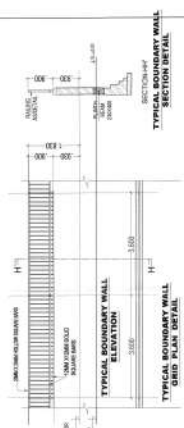

PROJECT TITLE: APPROVAL OF REVISED BUILDING PLAN FOR THE PROPOSED 4-STOREY RESIDENTIAL BUILDING WITH COMMERCIAL USE AT GURDWAR NANAKI URBAN COMPLEX BEHIND PVT LTD AND OTHERS	DRAWING TITLE: BOUNDARY WALL	SHEET NO: S-34	SCALE: 1:100	DATE: 20/08/2021
	PROJECT NO: 2021/08/01	DRAWING NO: 01	NORTH 	SHEET NO: 48/60

ARCHITECT: **DEEPAK SETHI & ASSOCIATES**
 ARCHITECTS, PLANNERS, INTERIORS, SCULPTURE,
 LANDSCAPE ARCHITECTS, CIVIL ENGINEERS,
 L.L.C. MAYAPUR, KANAK P. II COLLEGE ST. PH.
 152775 INDIA TEL: 91-11-22170101
 WWW.DSAS.COM