

GRAPHICAL SCALE

1:1000

DATE: 30/09/2018

REVISION: 01

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DRAWN BY: [Signature]

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OWNER'S SIGNATURE: [Signature]

(FOR SEWER)

SITE PLAN

CLIENT: [Name]

PROJECT: [Name]

ADDRESS: [Address]



DATE: [Date]

SCALE: 1:1000

REVISION: 01

NO.	DESCRIPTION	UNIT	QTY	REMARKS
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NO.	DESCRIPTION	UNIT	QTY	REMARKS
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SEWER LEGEND

- 1. 3000 SEWER PIPE (LINE 1.50)
- 2. 1500 SEWER PIPE (LINE 1.50)
- 3. 750 SEWER PIPE (LINE 1.50)

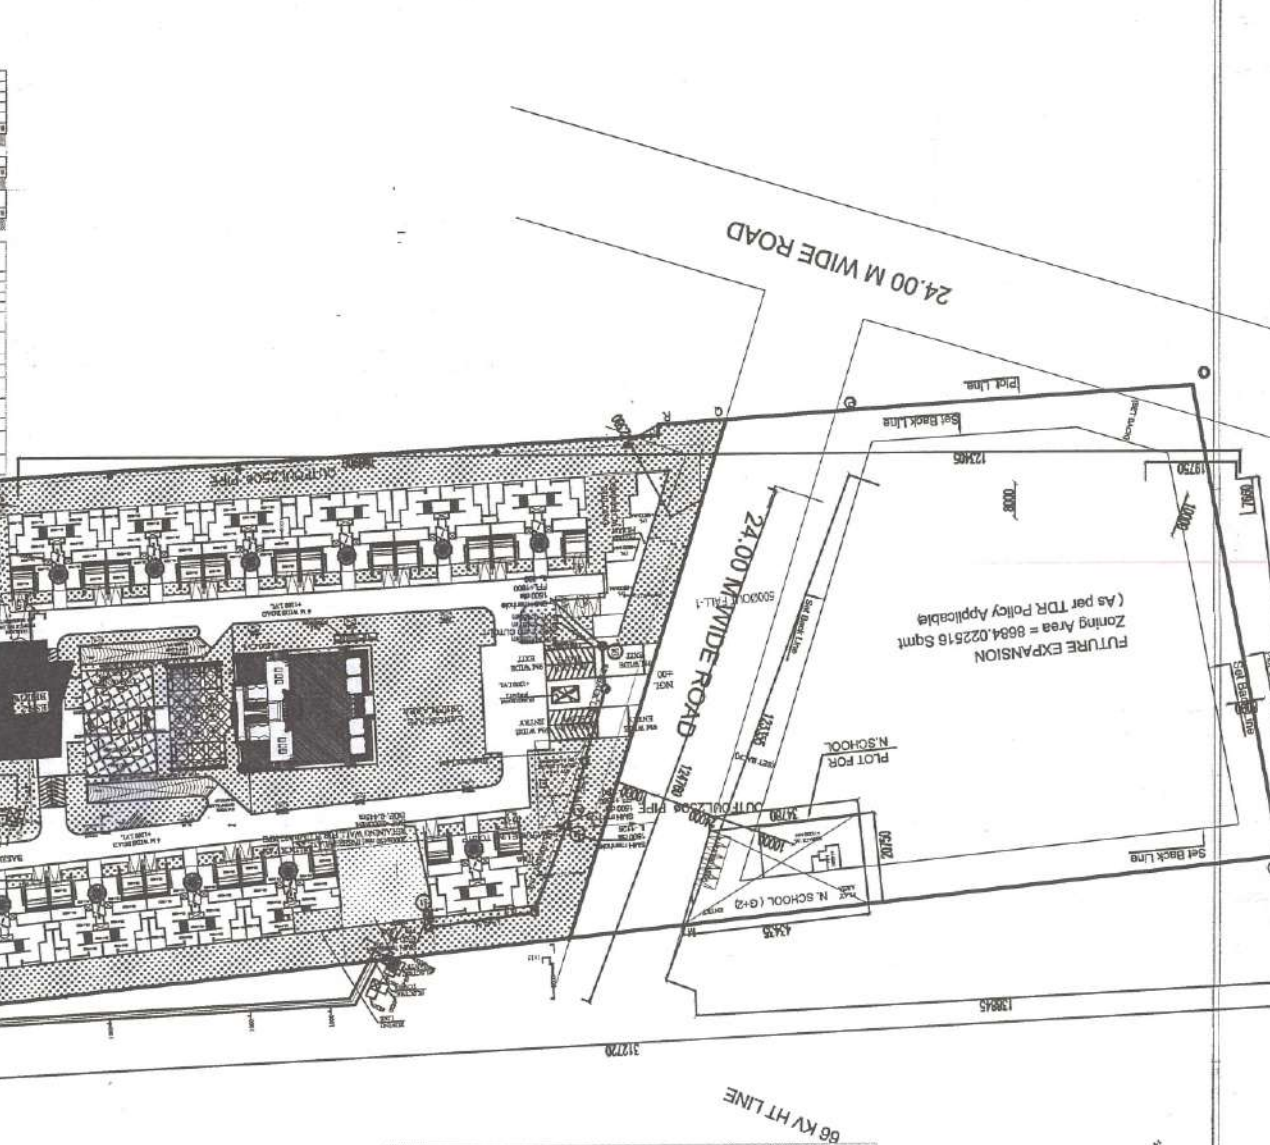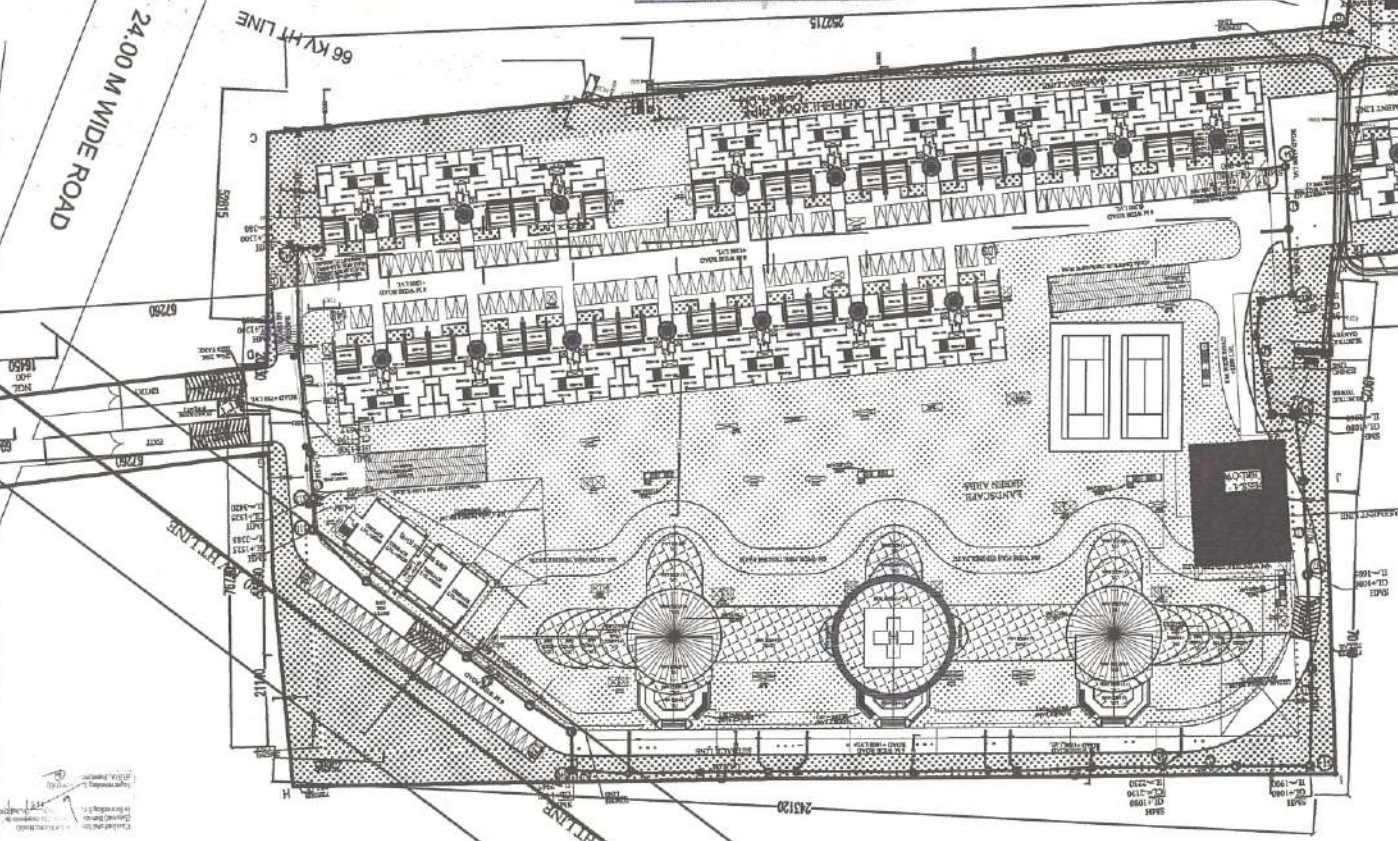PROJECT: MAHELA-REWANTA
SECTOR: 78, GUHRGAM (HARVANA)
MATERIAL STATEMENT SEWER LINES

LINE NO.	START (M)	END (M)	SIZE OF SEWER (DIA)	SIZE OF SEWER (DIA)	LENGTH (M)
1	44	44	300	300	0
2	44	44	300	300	0
3	44	44	300	300	0
4	44	44	300	300	0
5	44	44	300	300	0
6	44	44	300	300	0
7	44	44	300	300	0
8	44	44	300	300	0
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10	44	44	300	300	0
11	44	44	300	300	0
12	44	44	300	300	0
13	44	44	300	300	0
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93	44	44	300	300	0
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95	44	44	300	300	0
96	44	44	300	300	0
97	44	44	300	300	0
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99	44	44	300	300	0
100	44	44	300	300	0

NOTE:

1. ALL DIMENSIONS ARE IN MILLIMETERS.

2. LEVELS IN METERS AND

SL.NO	LENGTH OF PIPE (M)	DI. OF PIPE LINE	MA. TRICAL OF PIPE
1	2	100	PVC Pipes
2	20	100	PVC Pipes
3	25	100	PVC Pipes
4	55	100	PVC Pipes
5	800	100	PVC Pipes

SL.NO	LENGTH OF PIPE (M)	DI. OF PIPE LINE	MATERIAL OF PIPE
1	2	100	PVC Pipes
2	20	100	PVC Pipes
3	25	100	PVC Pipes
4	55	100	PVC Pipes
5	800	100	PVC Pipes

PROJECT: Group Housing RAHEJA-REVAANTA
 SECTOR-79, GURUGRAM (HARYANA)
 MATERIAL STATEMENT FOR IRRIGATION WATER SUPPLY LINE
 FROM STP.

PROJECT: Group Housing RAHEJA-REVAANTA
 SECTOR-79, GURUGRAM (HARYANA)
 MATERIAL STATEMENT FOR TUBEWELL WATER SUPPLY


SITE PLAN
 FOR DOMESTIC WATER SUPPLY
 DRAWING NO. 101
 DATE: 25.02.2015
 SCALE: 1:500
 DRAWING BY: [Signature]
 CHECKED BY: [Signature]
 APPROVED BY: [Signature]

CLIENT: GROUP HOUSING SITE MEASURING 18/211
 GROUP HOUSING SITE MEASURING 18/211
 GROUP HOUSING SITE MEASURING 18/211
 GROUP HOUSING SITE MEASURING 18/211

NO.	DESCRIPTION	QTY.	UNIT
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NO.	DESCRIPTION	QTY.	UNIT
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NOTE:
 1. ALL DIMENSIONS ARE IN METRE.
 2. DO NOT SCALE THE DRAWING WORK TO
 3. ALL DIMENSIONS SHOULD BE REVERSED
 4. FOR EXACT MEASUREMENTS
 5. ALL DIMENSIONS SHOULD BE REVERSED
 6. FOR ALL DIMENSIONS CONNECTION REFER SITE
 7. MAIN



SL.NO	LENGTH OF PIPE (M)	DIAM. OF PIPE (MM)	MATERIAL OF PIPE
1	3	25	PVC Pipes
2	230	25	PVC Pipes
3	91	25	PVC Pipes
4	557	80	PVC Pipes
5	630	100	PVC Pipes

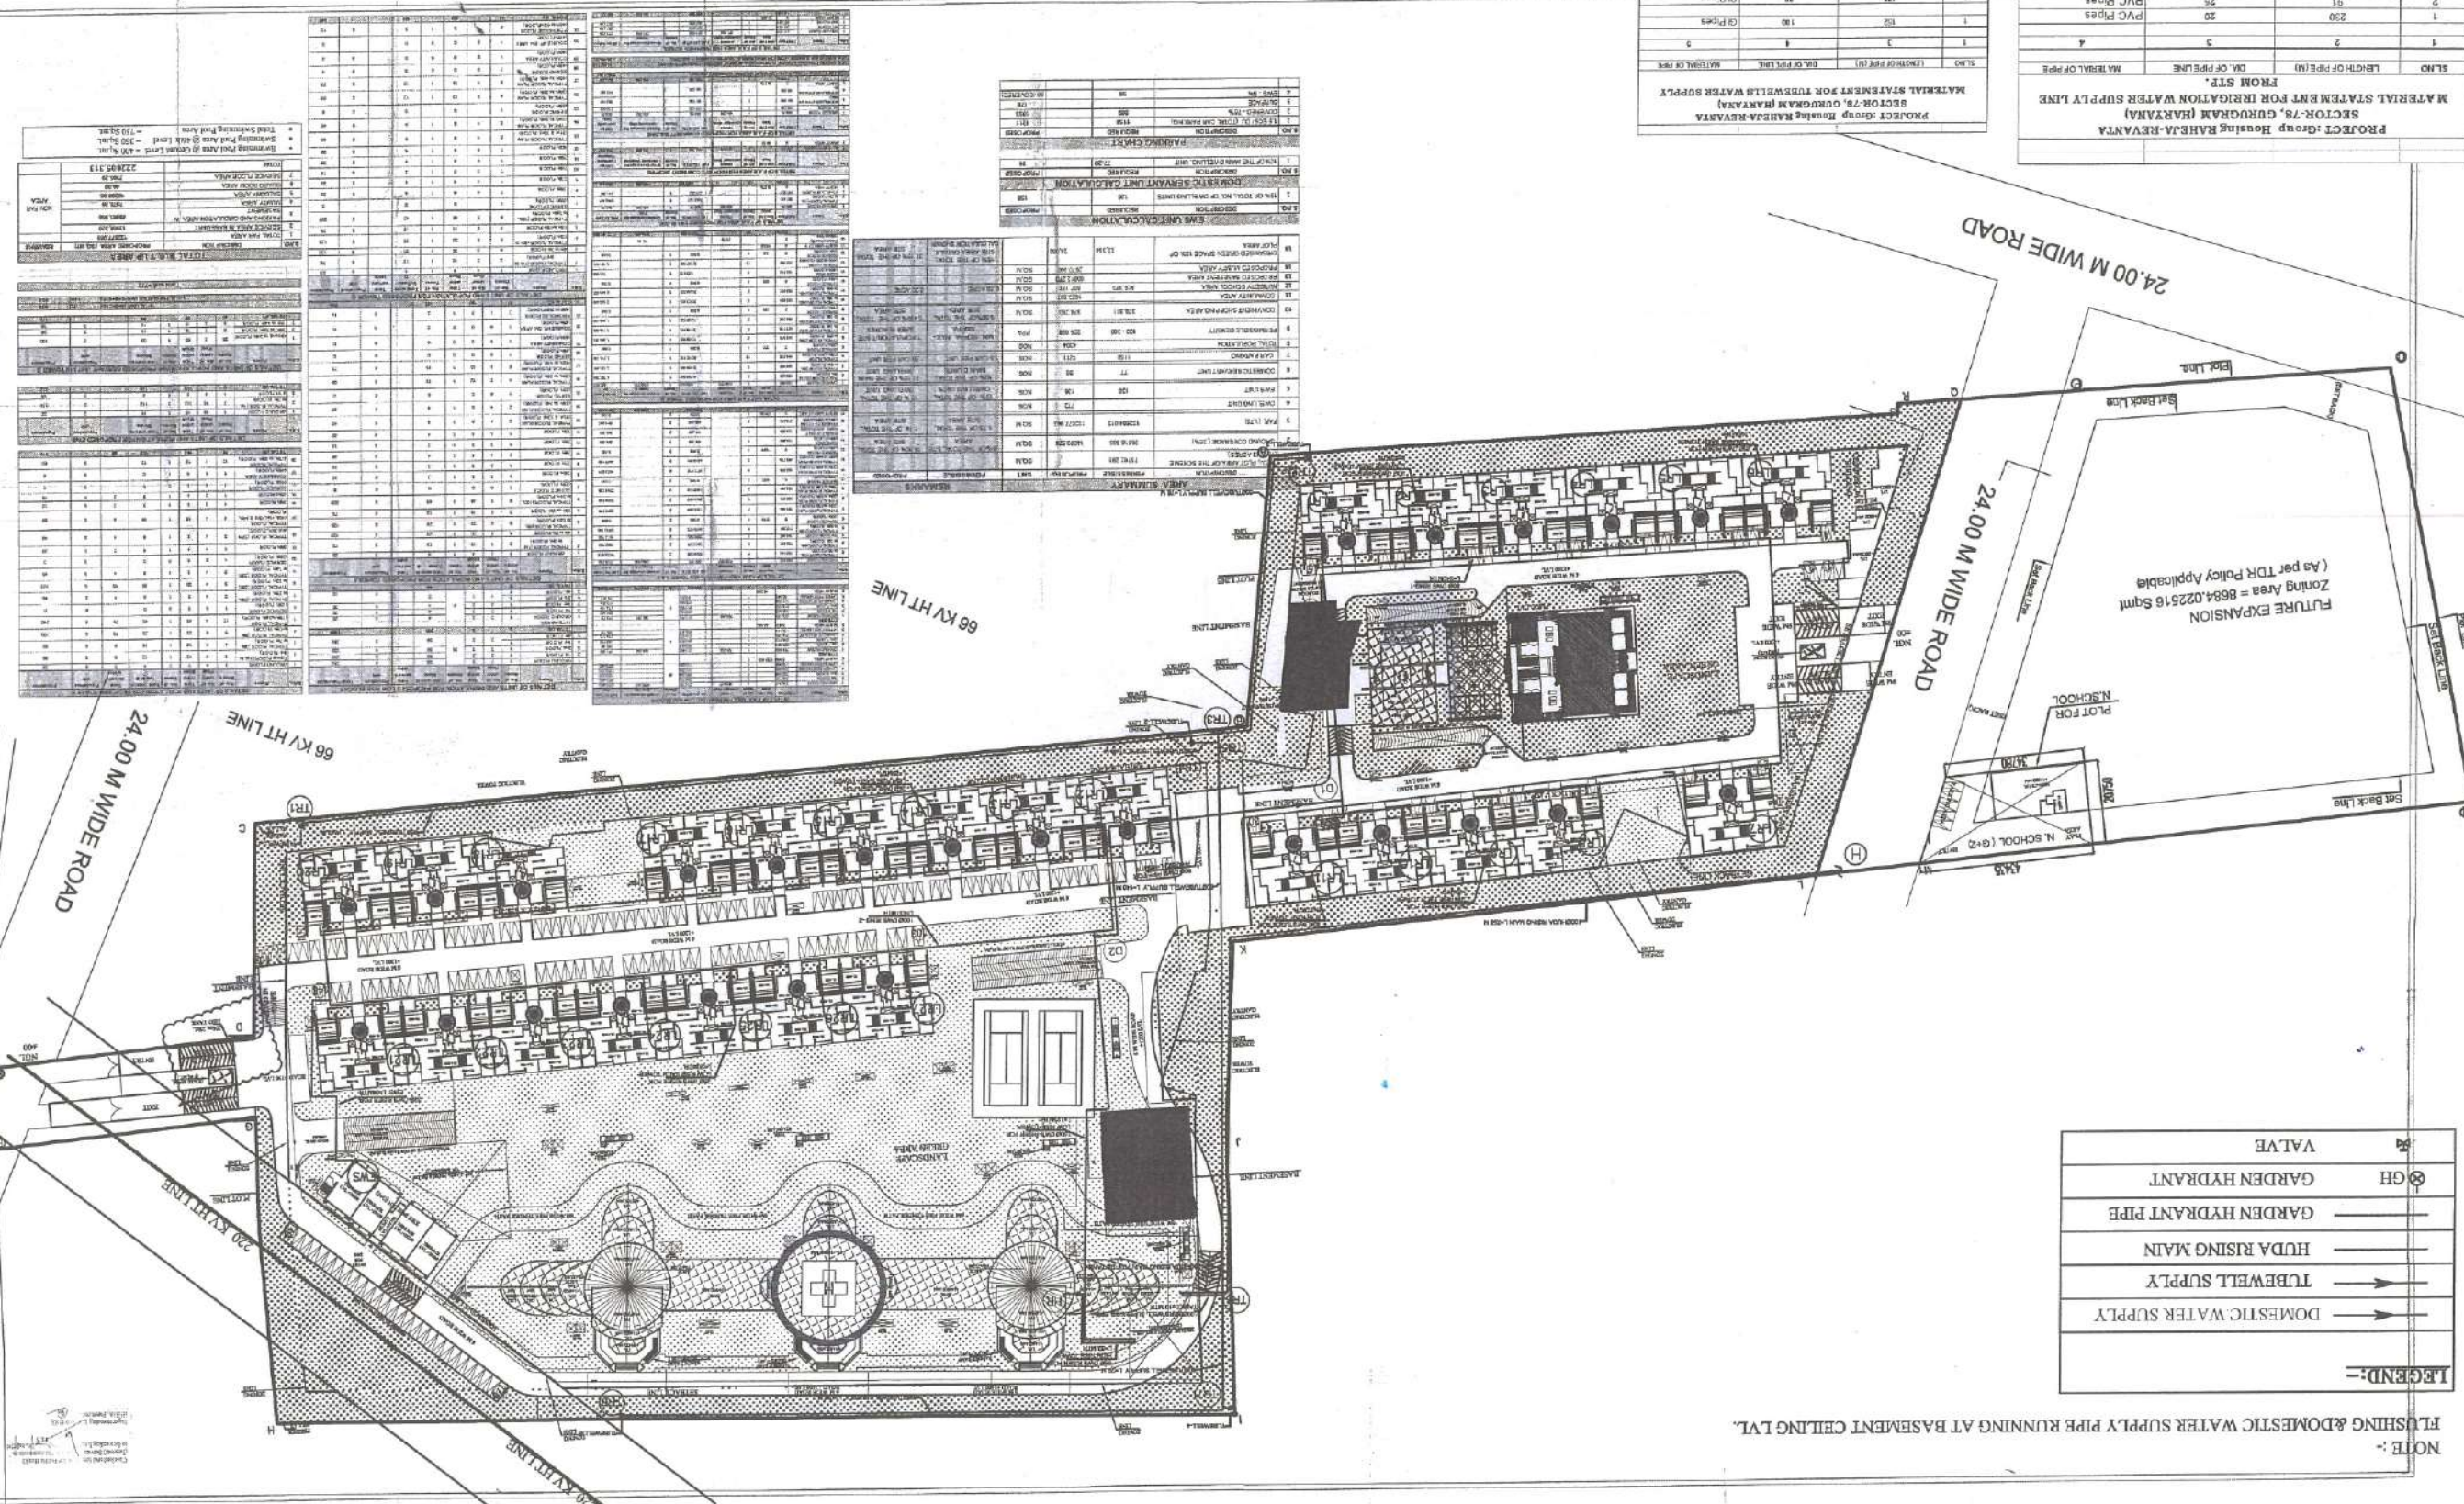SL.NO	LENGTH OF PIPE (M)	DIAM. OF PIPE (MM)	MATERIAL OF PIPE
1	3	25	PVC Pipes
2	188	100	PVC Pipes
3	275	80	PVC Pipes

PROJECT: Group Housing RAHJA-REVANTA
 SECTOR-78, GURUGRAM (HARYANA)
 MATERIAL STATEMENT FOR IRRIGATION WATER SUPPLY LINE
 FROM STP.


PROJECT: Group Housing RAHJA-REVANTA
 SECTOR-78, GURUGRAM (HARYANA)
 MATERIAL STATEMENT FOR TUBEWELL WATER SUPPLY

FUTURE EXPANSION
 (As per TDR Policy Applicable)
 Zoning Area = 8684.022516 Sqmt

LEGEND

⊕	VALVE
⊙	GARDEN HYDRANT
—	GARDEN HYDRANT PIPE
—	HDDA RISING MAIN
—	TUBEWELL SUPPLY
—	DOMESTIC WATER SUPPLY
—	FLUSHING WATER SUPPLY

NOTE: FLUSHING DOMESTIC WATER SUPPLY PIPE RUNNING AT BASEMENT CEILING LVL.

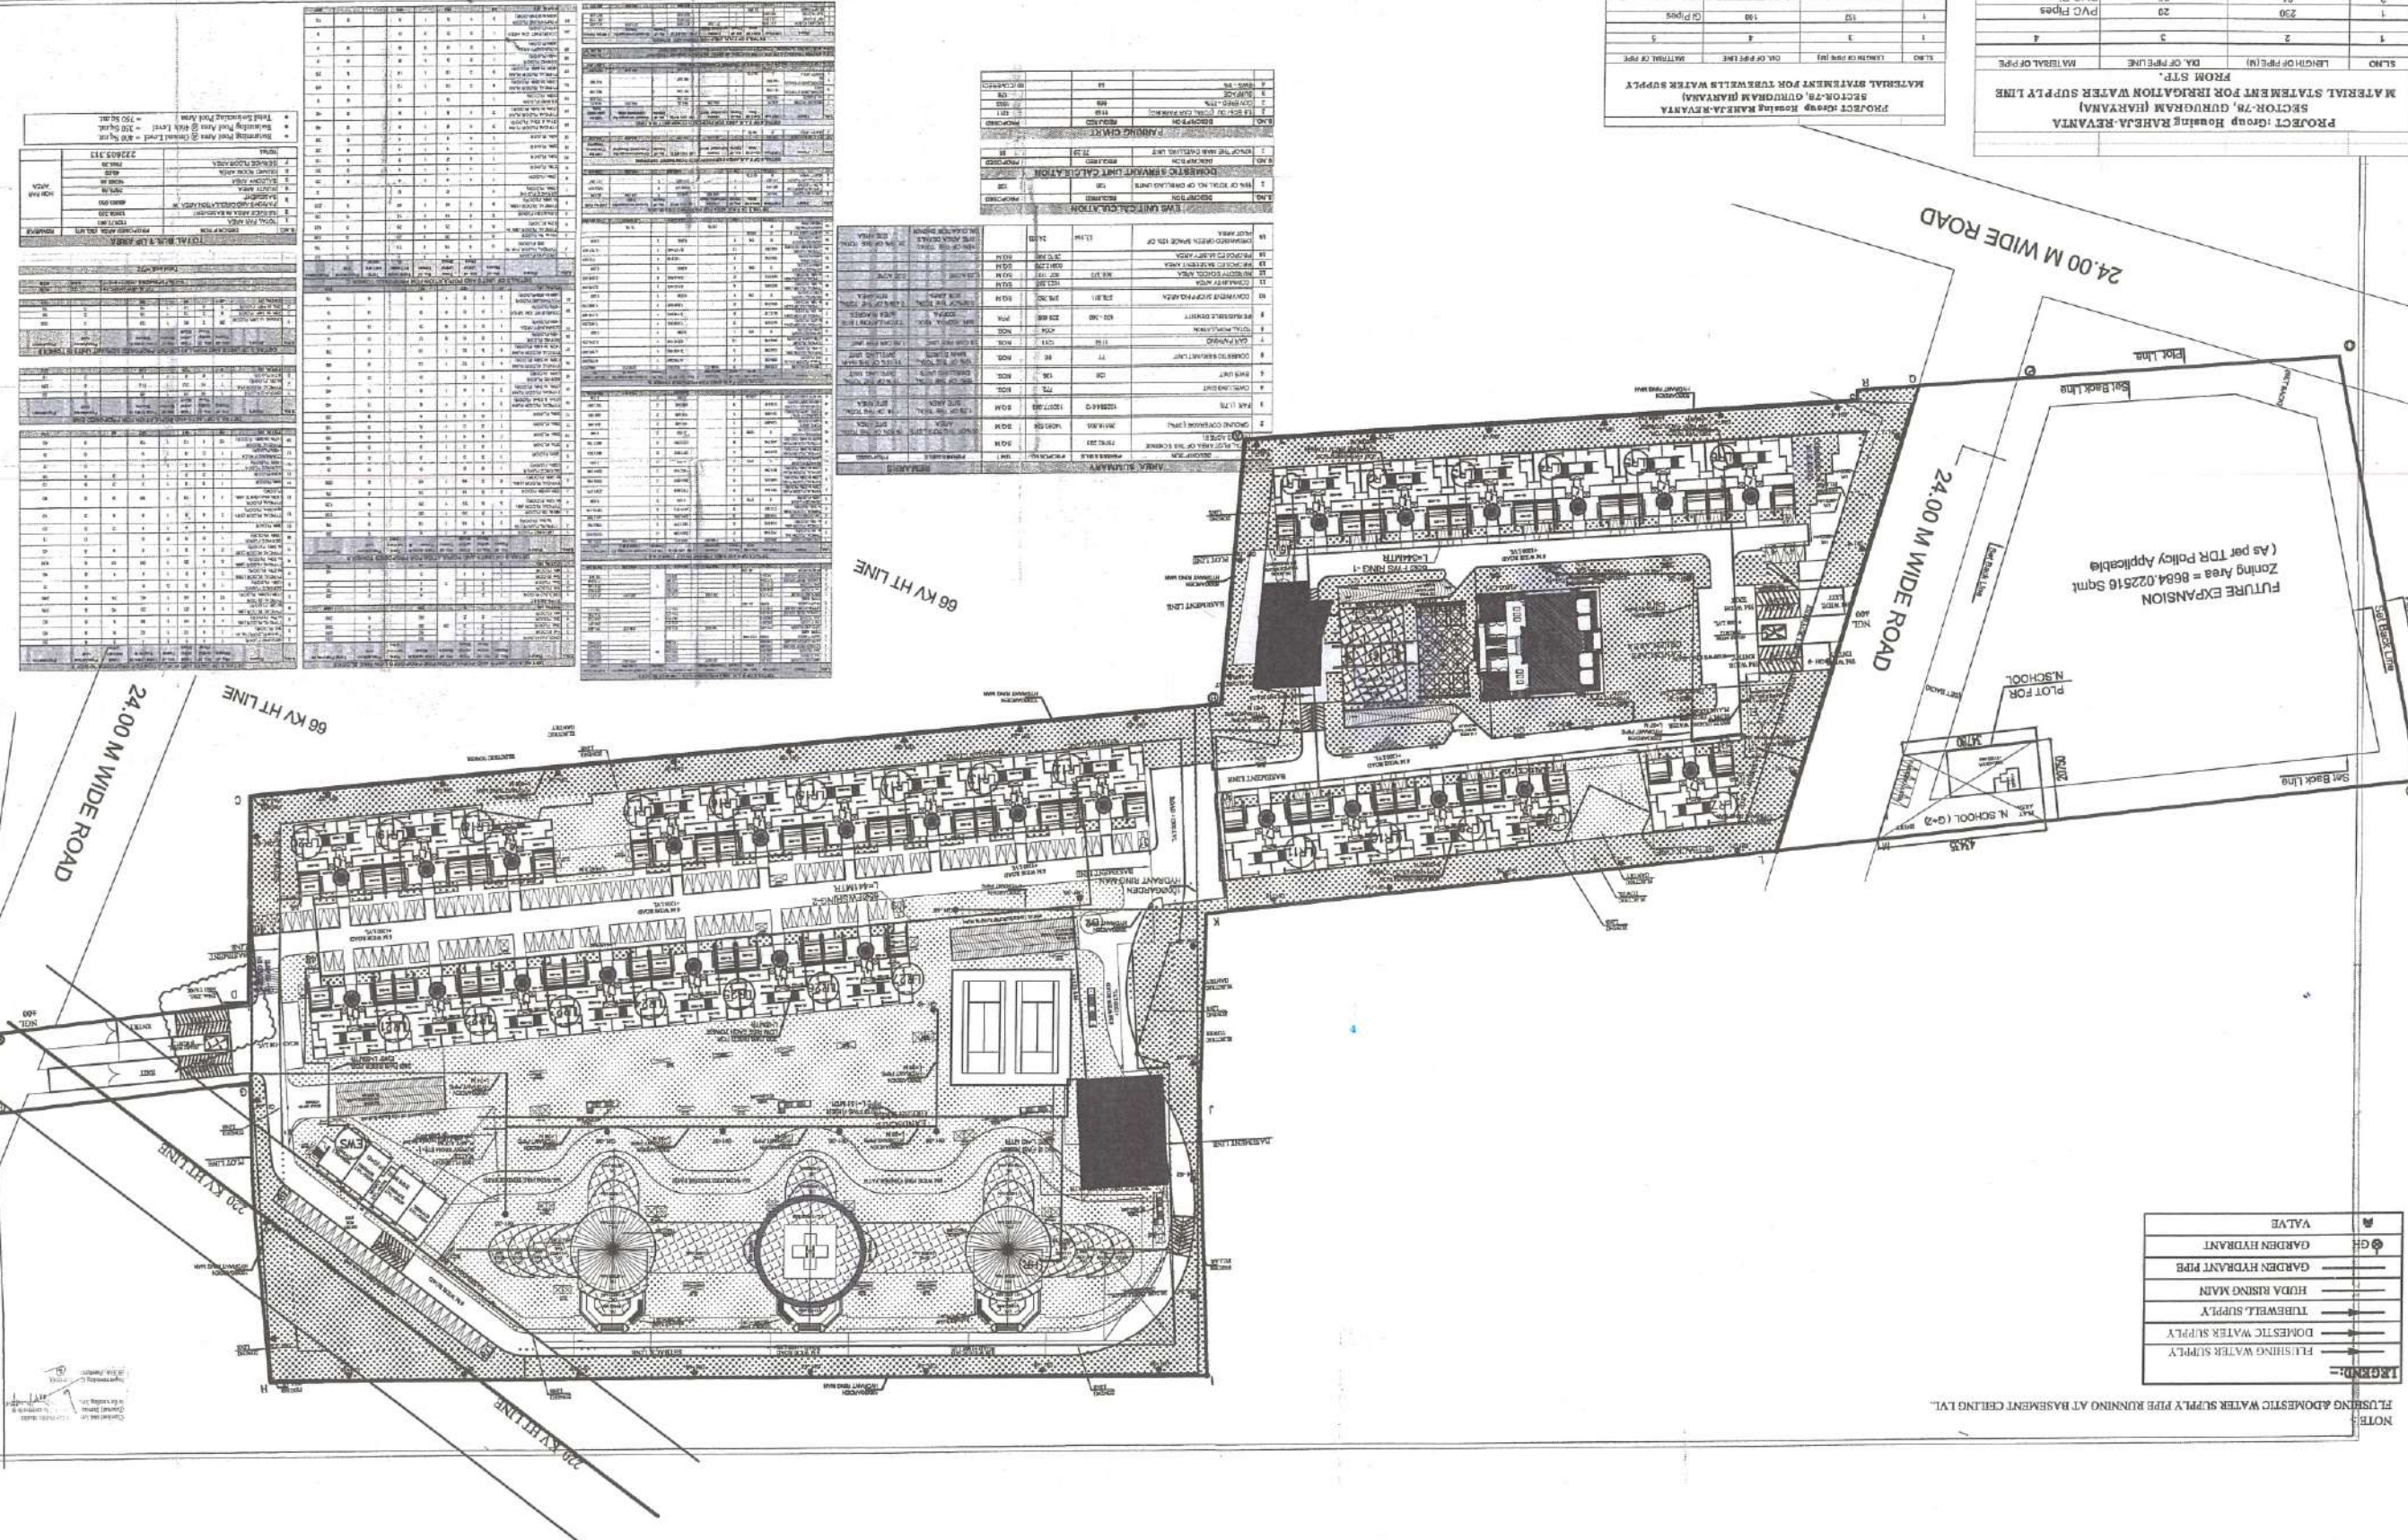

NO.	DESCRIPTION	UNIT	QTY	REMARKS
1	CONCRETE WORK	M ³	1000	
2	BRICKWORK	M ³	2000	
3	ROOFING WORK	M ²	5000	
4	PAINTING WORK	M ²	10000	
5	PLUMBING WORK	M	500	
6	ELECTRICAL WORK	M	1000	
7	LANDSCAPING WORK	M ²	2000	
8	CONCRETE WORK	M ³	1500	
9	BRICKWORK	M ³	3000	
10	ROOFING WORK	M ²	6000	
11	PAINTING WORK	M ²	12000	
12	PLUMBING WORK	M	600	
13	ELECTRICAL WORK	M	1200	
14	LANDSCAPING WORK	M ²	2500	
15	CONCRETE WORK	M ³	1800	
16	BRICKWORK	M ³	3500	
17	ROOFING WORK	M ²	7000	
18	PAINTING WORK	M ²	14000	
19	PLUMBING WORK	M	700	
20	ELECTRICAL WORK	M	1400	
21	LANDSCAPING WORK	M ²	3000	
22	CONCRETE WORK	M ³	2000	
23	BRICKWORK	M ³	4000	
24	ROOFING WORK	M ²	8000	
25	PAINTING WORK	M ²	16000	
26	PLUMBING WORK	M	800	
27	ELECTRICAL WORK	M	1600	
28	LANDSCAPING WORK	M ²	3500	
29	CONCRETE WORK	M ³	2200	
30	BRICKWORK	M ³	4500	
31	ROOFING WORK	M ²	9000	
32	PAINTING WORK	M ²	18000	
33	PLUMBING WORK	M	900	
34	ELECTRICAL WORK	M	1800	
35	LANDSCAPING WORK	M ²	4000	
36	CONCRETE WORK	M ³	2500	
37	BRICKWORK	M ³	5000	
38	ROOFING WORK	M ²	10000	
39	PAINTING WORK	M ²	20000	
40	PLUMBING WORK	M	1000	
41	ELECTRICAL WORK	M	2000	
42	LANDSCAPING WORK	M ²	4500	
43	CONCRETE WORK	M ³	2800	
44	BRICKWORK	M ³	5500	
45	ROOFING WORK	M ²	11000	
46	PAINTING WORK	M ²	22000	
47	PLUMBING WORK	M	1100	
48	ELECTRICAL WORK	M	2200	
49	LANDSCAPING WORK	M ²	5000	
50	CONCRETE WORK	M ³	3000	
51	BRICKWORK	M ³	6000	
52	ROOFING WORK	M ²	12000	
53	PAINTING WORK	M ²	24000	
54	PLUMBING WORK	M	1200	
55	ELECTRICAL WORK	M	2400	
56	LANDSCAPING WORK	M ²	5500	
57	CONCRETE WORK	M ³	3200	
58	BRICKWORK	M ³	6500	
59	ROOFING WORK	M ²	13000	
60	PAINTING WORK	M ²	26000	
61	PLUMBING WORK	M	1300	
62	ELECTRICAL WORK	M	2600	
63	LANDSCAPING WORK	M ²	6000	
64	CONCRETE WORK	M ³	3500	
65	BRICKWORK	M ³	7000	
66	ROOFING WORK	M ²	14000	
67	PAINTING WORK	M ²	28000	
68	PLUMBING WORK	M	1400	
69	ELECTRICAL WORK	M	2800	
70	LANDSCAPING WORK	M ²	6500	
71	CONCRETE WORK	M ³	3800	
72	BRICKWORK	M ³	7500	
73	ROOFING WORK	M ²	15000	
74	PAINTING WORK	M ²	30000	
75	PLUMBING WORK	M	1500	
76	ELECTRICAL WORK	M	3000	
77	LANDSCAPING WORK	M ²	7000	
78	CONCRETE WORK	M ³	4000	
79	BRICKWORK	M ³	8000	
80	ROOFING WORK	M ²	16000	
81	PAINTING WORK	M ²	32000	
82	PLUMBING WORK	M	1600	
83	ELECTRICAL WORK	M	3200	
84	LANDSCAPING WORK	M ²	7500	
85	CONCRETE WORK	M ³	4200	
86	BRICKWORK	M ³	8500	
87	ROOFING WORK	M ²	17000	
88	PAINTING WORK	M ²	34000	
89	PLUMBING WORK	M	1700	
90	ELECTRICAL WORK	M	3400	
91	LANDSCAPING WORK	M ²	8000	
92	CONCRETE WORK	M ³	4500	
93	BRICKWORK	M ³	9000	
94	ROOFING WORK	M ²	18000	
95	PAINTING WORK	M ²	36000	
96	PLUMBING WORK	M	1800	
97	ELECTRICAL WORK	M	3600	
98	LANDSCAPING WORK	M ²	8500	
99	CONCRETE WORK	M ³	4800	
100	BRICKWORK	M ³	9500	
101	ROOFING WORK	M ²	19000	
102	PAINTING WORK	M ²	38000	
103	PLUMBING WORK	M	1900	
104	ELECTRICAL WORK	M	3800	
105	LANDSCAPING WORK	M ²	9000	
106	CONCRETE WORK	M ³	5000	
107	BRICKWORK	M ³	10000	
108	ROOFING WORK	M ²	20000	
109	PAINTING WORK	M ²	40000	
110	PLUMBING WORK	M	2000	
111	ELECTRICAL WORK	M	4000	
112	LANDSCAPING WORK	M ²	9500	
113	CONCRETE WORK	M ³	5200	
114	BRICKWORK	M ³	10500	
115	ROOFING WORK	M ²	21000	
116	PAINTING WORK	M ²	42000	
117	PLUMBING WORK	M	2100	
118	ELECTRICAL WORK	M	4200	
119	LANDSCAPING WORK	M ²	10000	
120	CONCRETE WORK	M ³	5500	
121	BRICKWORK	M ³	11000	
122	ROOFING WORK	M ²	22000	
123	PAINTING WORK	M ²	44000	
124	PLUMBING WORK	M	2200	
125	ELECTRICAL WORK	M	4400	
126	LANDSCAPING WORK	M ²	10500	
127	CONCRETE WORK	M ³	5800	
128	BRICKWORK	M ³	11500	
129	ROOFING WORK	M ²	23000	
130	PAINTING WORK	M ²	46000	
131	PLUMBING WORK	M	2300	
132	ELECTRICAL WORK	M	4600	
133	LANDSCAPING WORK	M ²	11000	
134	CONCRETE WORK	M ³	6000	
135	BRICKWORK	M ³	12000	
136	ROOFING WORK	M ²	24000	
137	PAINTING WORK	M ²	48000	
138	PLUMBING WORK	M	2400	
139	ELECTRICAL WORK	M	4800	
140	LANDSCAPING WORK	M ²	11500	
141	CONCRETE WORK	M ³	6200	
142	BRICKWORK	M ³	12500	
143	ROOFING WORK	M ²	25000	
144	PAINTING WORK	M ²	50000	
145	PLUMBING WORK	M	2500	
146	ELECTRICAL WORK	M	5000	
147	LANDSCAPING WORK	M ²	12000	
148	CONCRETE WORK	M ³	6500	
149	BRICKWORK	M ³	13000	
150	ROOFING WORK	M ²	26000	
151	PAINTING WORK	M ²	52000	
152	PLUMBING WORK	M	2600	
153	ELECTRICAL WORK	M	5200	
154	LANDSCAPING WORK	M ²	12500	
155	CONCRETE WORK	M ³	6800	
156	BRICKWORK	M ³	13500	
157	ROOFING WORK	M ²	27000	
158	PAINTING WORK	M ²	54000	
159	PLUMBING WORK	M	2700	
160	ELECTRICAL WORK	M	5400	
161	LANDSCAPING WORK	M ²	13000	
162	CONCRETE WORK	M ³	7000	
163	BRICKWORK	M ³	14000	
164	ROOFING WORK	M ²	28000	
165	PAINTING WORK	M ²	56000	
166	PLUMBING WORK	M	2800	
167	ELECTRICAL WORK	M	5600	
168	LANDSCAPING WORK	M ²	13500	
169	CONCRETE WORK	M ³	7200	
170	BRICKWORK	M ³	14500	
171	ROOFING WORK	M ²	29000	
172	PAINTING WORK	M ²	58000	
173	PLUMBING WORK	M	2900	
174	ELECTRICAL WORK	M	5800	
175	LANDSCAPING WORK	M ²	14000	
176	CONCRETE WORK	M ³	7500	
177	BRICKWORK	M ³	15000	
178	ROOFING WORK	M ²	30000	
179	PAINTING WORK	M ²	60000	
180	PLUMBING WORK	M	3000	
181	ELECTRICAL WORK	M	6000	
182	LANDSCAPING WORK	M ²	14500	
183	CONCRETE WORK	M ³	7800	
184	BRICKWORK	M ³	15500	
185	ROOFING WORK	M ²	31000	
186	PAINTING WORK	M ²	62000	
187	PLUMBING WORK	M	3100	
188	ELECTRICAL WORK	M	6200	
189	LANDSCAPING WORK	M ²	15000	
190	CONCRETE WORK	M ³	8000	
191	BRICKWORK	M ³	16000	
192	ROOFING WORK	M ²	32000	
193	PAINTING WORK	M ²	64000	
194	PLUMBING WORK	M	3200	
195	ELECTRICAL WORK	M	6400	
196	LANDSCAPING WORK	M ²	15500	
197	CONCRETE WORK	M ³	8200	
198	BRICKWORK	M ³	16500	
199	ROOFING WORK	M ²	33000	
200	PAINTING WORK	M ²	66000	
201	PLUMBING WORK	M	3300	
202	ELECTRICAL WORK	M	6600	
203	LANDSCAPING WORK	M ²	16000	
204	CONCRETE WORK	M ³	8500	
205	BRICKWORK	M ³	17000	
206	ROOFING WORK	M ²	34000	
207	PAINTING WORK	M ²	68000	
208	PLUMBING WORK	M	3400	
209	ELECTRICAL WORK	M	6800	
210	LANDSCAPING WORK	M ²	16500	
211	CONCRETE WORK	M ³	8800	
212	BRICKWORK	M ³	17500	
213	ROOFING WORK	M ²	35000	
214	PAINTING WORK	M ²	70000	
215	PLUMBING WORK	M	3500	
216	ELECTRICAL WORK	M	7000	
217	LANDSCAPING WORK	M ²	17000	
218	CONCRETE WORK	M ³	9000	



SITE PLAN
ROAD LAYOUT PLAN
 DRAWING NO. 001
 DATE: 25.02.2018
 SCALE: 1:1000
 REVISION: NORTH
 DRAWN BY: [Signature]
 CHECKED BY: [Signature]
 OWNER'S SIGNATURE: [Signature]
 ARCHITECT: [Signature]

CLIENT:
 REVISED BUILDING PLAN OF RESIDENTIAL GROUP HOUSING SITE MEASURING 18,727 SQ. METERS (LICENCE NO. - 49 OF 2011 DATED 01-06-2013) FOR 3NH- MANA AND OTHERS IN SWAPUR & BAHINI MANA AND OTHERS IN COLLABORATION WITH M/s. MANASA GROUP, MANASA URBAN COMPLEX.

NO.	DESCRIPTION	UNIT	AREA	VOLUME	HEIGHT	REMARKS
1	Low-Rise Typical Building Blocks - 27 no.	sq. m.	1,39,50	13,950	10	As per TDR Policy
2	Tower A: 6-10 Floors with 19x20 ML Height	sq. m.	1,20,00	12,000	10	As per TDR Policy
3	Tower B: 6-10 Floors with 19x20 ML Height	sq. m.	1,20,00	12,000	10	As per TDR Policy
4	Proposed Dwelling Units = 670 No.	No.	670			
5	Community Building	sq. m.	1,000			
6	Commercial Shopping Building	sq. m.	1,000			
7	EVGS Building with 120 Units	sq. m.	1,000			
8	Double level Basement in Ph-1 only	sq. m.	1,000			

NO.	DESCRIPTION	UNIT	AREA	VOLUME	HEIGHT	REMARKS
1	Low-Rise Typical Building Blocks - 27 no.	sq. m.	1,39,50	13,950	10	As per TDR Policy
2	Tower A: 6-10 Floors with 19x20 ML Height	sq. m.	1,20,00	12,000	10	As per TDR Policy
3	Tower B: 6-10 Floors with 19x20 ML Height	sq. m.	1,20,00	12,000	10	As per TDR Policy
4	Proposed Dwelling Units = 670 No.	No.	670			
5	Community Building	sq. m.	1,000			
6	Commercial Shopping Building	sq. m.	1,000			
7	EVGS Building with 120 Units	sq. m.	1,000			
8	Double level Basement in Ph-1 only	sq. m.	1,000			

Sanctioned Building Plans (16/2014)
 Group Housing at sector-7B, Gurgaon

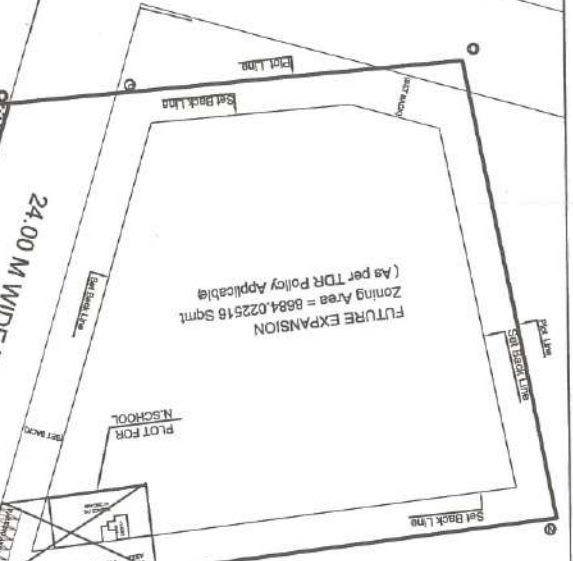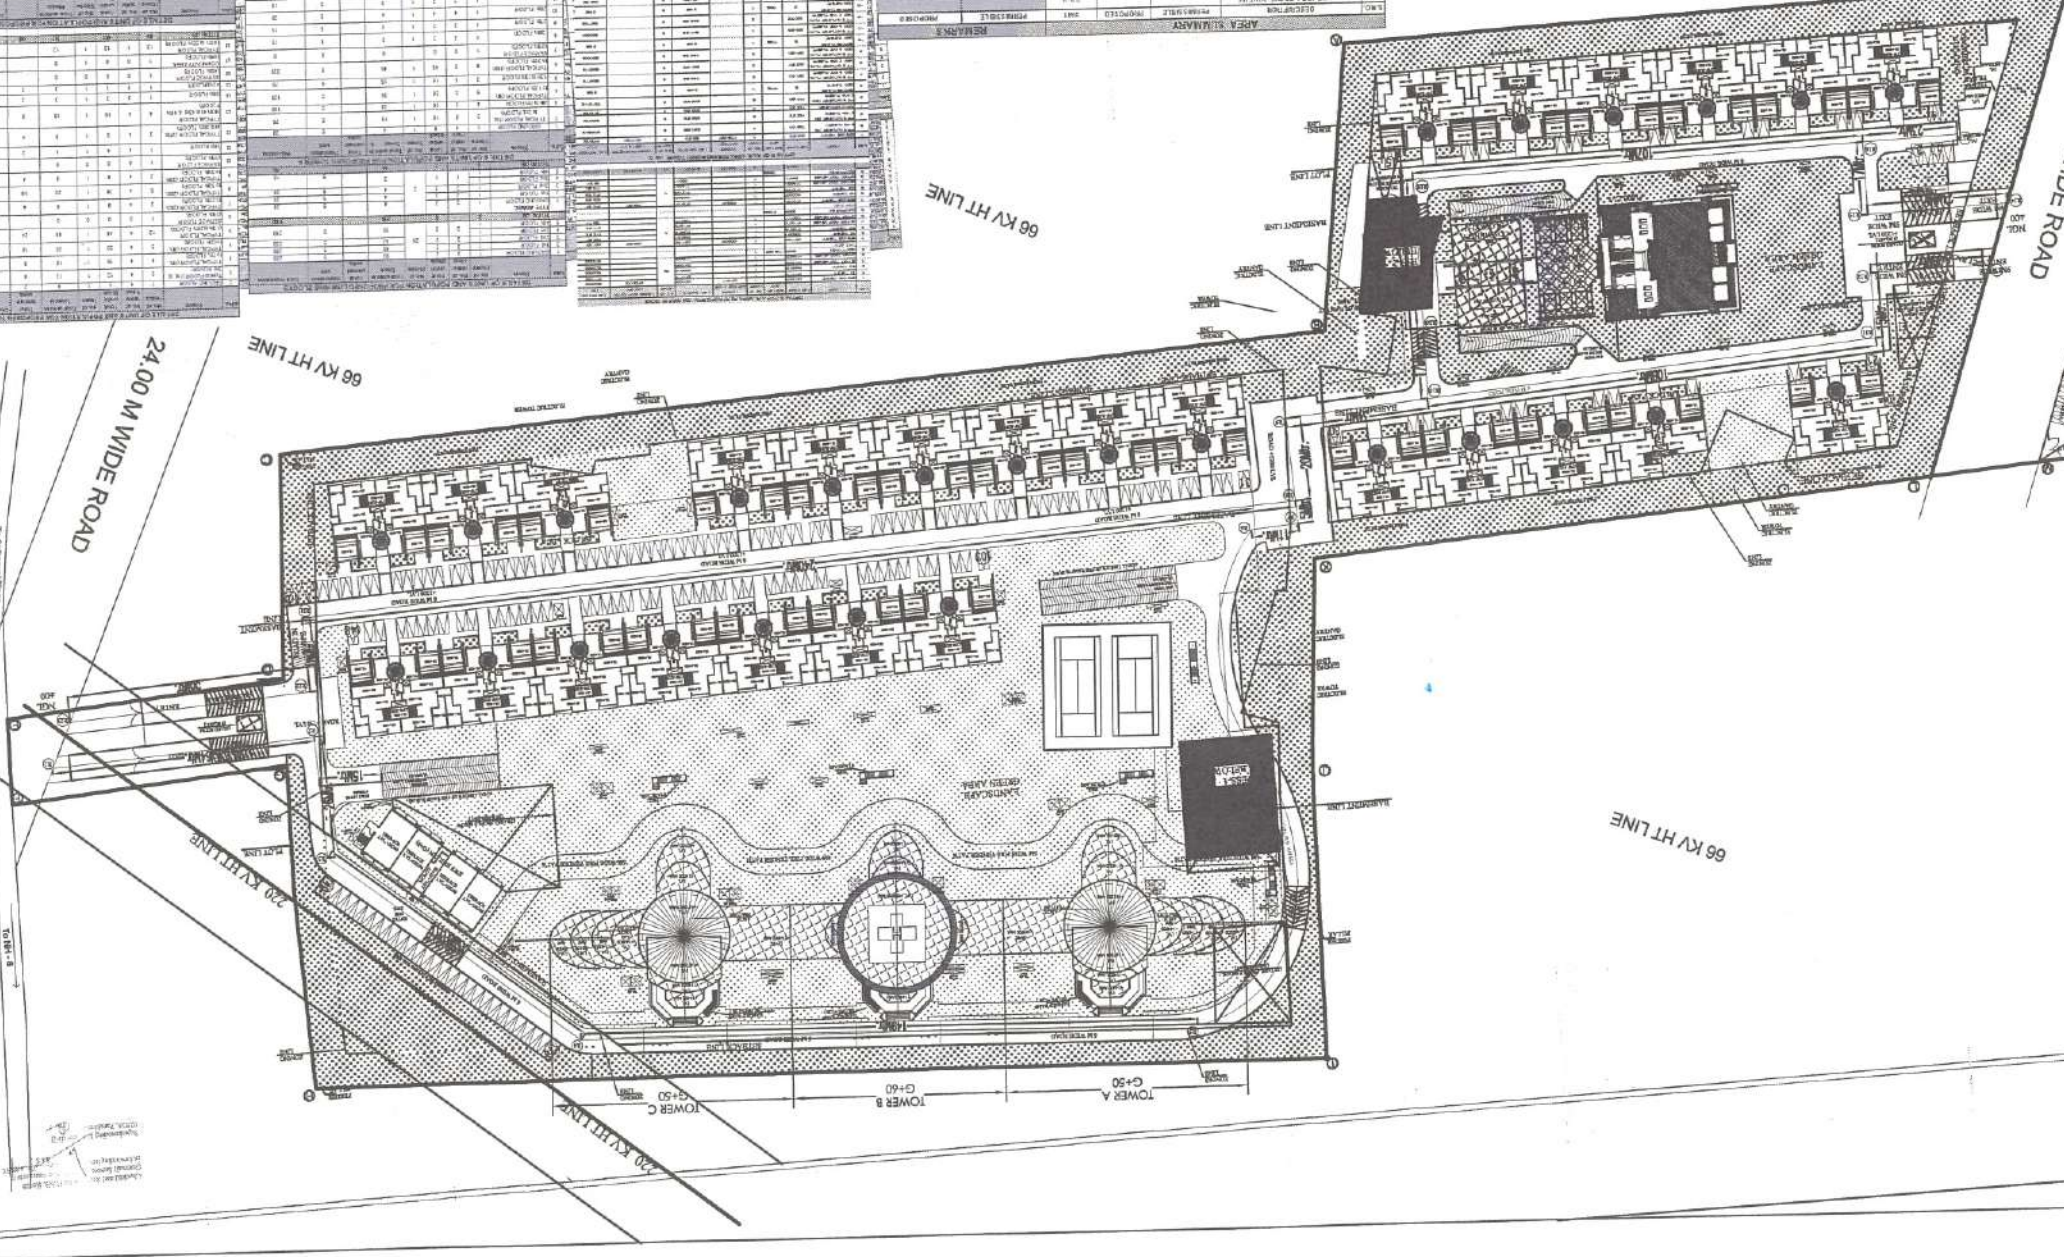

NOTE:-
 1. ALL DIMENSIONS ARE IN METERS.
 2. ALL STRUCTURAL MEMBERS ARE INDICATED BY WHITE BOLD LINES.
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