

MASTER BEDIAKON 5 58 J. 4.75 MASTER BED 900M 5.08 X 4.04 <u>UPPER LEVEL PENT HOUSE PLAN</u> (24TH FLOOR ) FOR TOWER-1, TYPE-A +75000 MM LVL


# LIPPERIEVEL PENTHOLISE AREA

AREA = (XXY) 34540 x 19890

687.00

ADDITION A	AREA =	687.00		SQMI
	EDUCTION DET			
1	11152 X	9536,	< 2	123.45
2	5773 X	2940)	_	33.95
3	1743 X	4150)	_	14.47
4	1820 X	1208)	< 2	4.40
5	15313 X	2415	₹ 2	73.96
e	581D X	3350)	<u> </u>	38.98
7	4950 X	1155		5.72
8	8050 X	1525		12.29
9	3000 X	1900)	<b>~ 2</b>	11.40
10	1500 X	1372	<b>(2</b>	412
10a	70 X	730)	<b>~</b> 2	0.10
11	1442 X	1430)	<b>~ 2</b>	412
11a	70 X	672	₹2	0.09
12	2440 X	4275		10.43
13	2880 X	4275		12.31
14	10500 X	2690		28.14
15	1170 X	1290)	< Z	3.02
16	3454 X	2300		7.94
17	6415 X	665)	< 2	8.53
18	115 X	2595)	< 2	0.60
19	6370 X	3630		23.12
7	OTAL		一	421.09

UPPERLEVEL PENT HOLISE AREA ADDITIONAREA-DEDUCTION AREA 687-421.09 = 255.91.5QMT

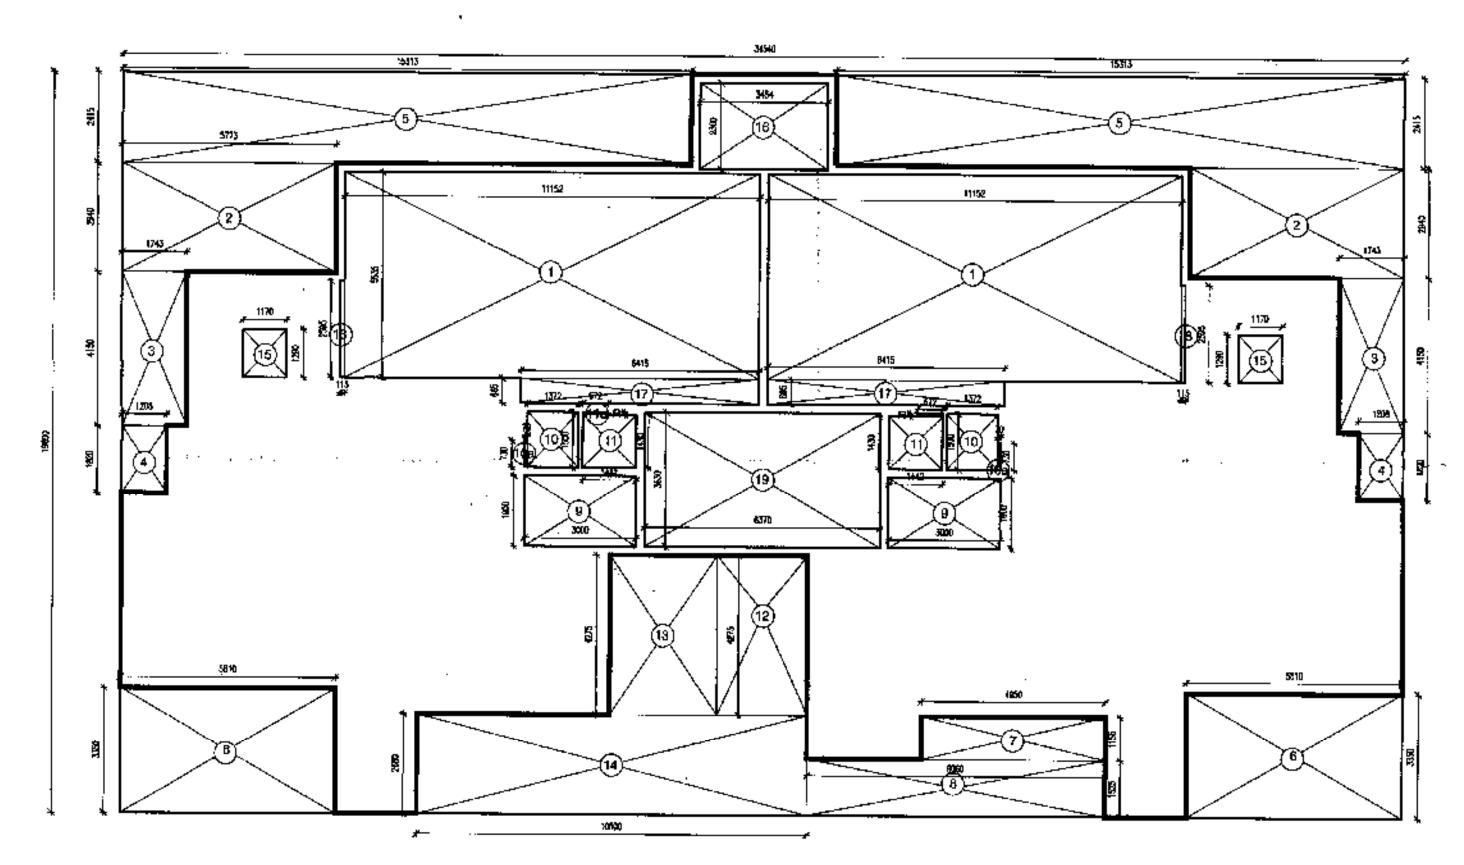

BLOCK DIAGRAM TOWER -1, TYPE-A (24TH FLOOR) (PENT HOUSE UPPER LEVEL) +75000 MM LVL

PLUMB<u>ing Notes:</u> WASH BASIN TO FLOOR THAT OFT 328 GI WASTE PIPE. NITCHEN SINK TO FLOOR TRAP FLEORILE PIPE. RLOGR DRAIN (FD) TO FLOOR TRAP (F1) 508 DI WASTE PIPE 1000 CLIPIPE USED FOR BOIL & WASTE 1008 CI PIPE USED FOR INTCHEN WASTE. SCHEDULE OF PIPES :-1 100% C 600L & VENT PIPE 1009 CI WASTE & VENT PIPE (A) | 1 750 AN A SYPHONAGE AFT DOMESTIC WATER SUPPLY DAY TAKE PIPE (7) RLUSPING WATER SUPPLY ON TAKE HIPE (8) DOMESTIC WATER SUPPLY RISER PIPE\* (A) | FLUSHING WATER SUPPLY RISER P.P.E. (10) HIT WATER SUPPLY ON TAKE PPE FROM SOLAR PANEL DOMESTIC WATER SUPPLY DAY TAKE THE FOR PENTIROUSE FT | FLOOR TRAP (1-00x.110) MM FO FLOOR DRAIN (100x/\$0) MAN - 788 ж.Тыз<u>ур-</u>бажі в мев. --- 1008 CI WASTE PUPE FIRE LEGEND :-A .... 1509 MLS TIRE WEY PISSA PIPE B ..... 1503 M.S SPHINKLER RESCH PIPE C ..... BOR M.S SPRINKLER LIKAN PETE PHC FIRE HESS CAMPLE ROW SWITCH \* PENDENT TYPE STYLINGUER KIÇ SIDE WALL TYPE SPRIKKI ER SPRINKLER FEEDER (JAE IMPORTANT NOTES:-1300 x 500 (ram CLIT CUT IN FIRE) () 1500 WET PASER. 2.) 1500 SPRINGER RIGER. 3.) 800 DRVM PIPS.

Checked and found ak for Public Health (Internal) Services only subject to comments in

# OPENING SCHEDULE OF DOORS & WINDOWS

SR. NO	SIZE	<u> </u>	SILL	<u>LI</u> NTEL	TYPE
1	800	X		2400	D1
2	900	х	ı	2400	D2
3	1050	Х	,	2400	D3
4	1465	X		2400	DW1
5	1500	Х	_	2400	DW2
6	1800	X	-	2400	DW3
7	2100	X	-	2400	DW4
8	2750	X		2400	DW5
9	1615	X	_	2400	DW6
10	2400	X	-	2400	DW7
11	600	X	1200	2400	W1
12	1000	X	900	2400	W2
13	1070	X	900	2400	W3
14	2100	Х	900	2400	W4
15	2750	Х	900	2400	W5
16	1500	Х	900	2400	W6
17	2400	Х	900	2400	W7
18	800	Х	900	2400	W8
MATER			"		

 DIMENSIONS ARE NOT TO BE SCALED. 2. ALL DIMENSIONS ARE IN MM .

ALL DIMENSIONS ARE IN MM ,
 ALL ELECTRICAL INSTALLATIONS SHALL BE AS PER PROVISIONS OF NBC.
 FIRE FIGHTING SAFETY PROVISIONS WILL BE AS PER RELEVANT NBC PROVISIONS.
 BOUNDARY WALL AND GATE AS PER STANDARDS.
 ALL WALLS ARE 230/115 MM THK. BRICK WALL.
 RAIN WATER HARVESTING SYSTEM SHALL BE PROVIDED AS PER CENTRAL GROUND WATER AUTHORITY NORMS/HARYANA GOVT.

8. ALL WINDOWS & VENTILATORS ARE OPENABLE.
9. ALL MECHANICALLY VENTILATED & ARTIFICIALLY LÍT TOILET PROVIDED WITH 24hr POWER BACKUP.


DEVELOPED BY:

# PROJECT:

PROPOSED BUILDING PLAN OF GROUP HOUSING FOR AREA MEASURING 11.875 + 8.294 = 20.169 ACRES(LICENCE NO. 250 OF 2007 DATED 02.11.2007 AND LICENCE NO. 50 OF 2012 DATED 17 / 5/ 2012 IN SECTOR 109, GURGAON MANESAR URBAN COMPLEX BEING DEVELOPED BY RAJ KIRAN PVT. LTD. AND OTHERS IN COLLABORATION WITH CHINTELS INDIA LTD.

DRAWING TITLE: TOWER-1,TYPE-A,UPPER LEVEL PENT HOUSE FLOOR PLAN & AREA DIAGRAM(PHASE-1)+75000MM DEALTBY Kaushik Modi CHECKED BY 1-A-2.6 Manish Kr. Gupta

THROUGH: AUTHORISED SIGNATORY

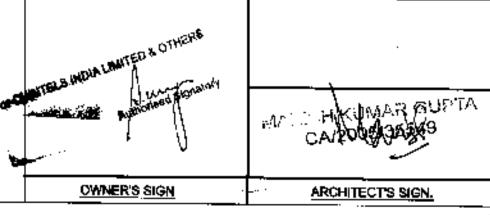

TERRACE LEVEL PENT HOUSE AREA ADDITION

AREA CALCULATION

 $AREA = (X \times Y)$ 

32124 x 305.82

ADDITION A	rea =	305.82	SQ.MT
DE	DUCTION DET	AIL	•
1	32124 X	<b>5</b> 810	218.76
2	22536 X	<b>2</b> 050	46.20
3	32124 X	,660	21,20
то	TAL	:	286.17

TERRACE LEVEL PENT HOUSE AREA

ADDITION AREA-DEDUCTION AREA 305.82 - 286.17 19.66 SQ.MT

BLOCK DIAGRAM TOWER -1, TYPE-A (PENT HOUSE TERRACE LEVEL ) + 78350 MM LVL

TERRACE LEVEL PENT HOUSE
PLAN FOR TOWER-1, TYPE-A +78350 MM LVL

PLUMBING NOTES:-WASH BASIN TO PLOOF TRAP (FT) \$20 60 WASTE PIPE. FLOOR DRAIN (FO) TO FLOOR TRAP (FT) 500 61 WASTE PIPE. 1008 OF PPE USED FOR SOIL & WASTE 1000 CI PIPE USED FOR KITCHEN WASTE SCHEDULE OF PIPES :-1 1000 CL SOIL & VENT PAPE (2) 1009 CI WASTE & VENT PIPE (3) SAMPETHIONAGE OF (6) DOMESTIC WATER SUPPLY DAY TAKE PIPS (7); FLUSHING WATER SUPPLY ON YAKE PIPE (II) DOMESTIC WATER SUPPLY PASED PIPEA (13) HOT MATER SUPPLY DAY TAKE PIPE FROM SOLAR PAREL (11) DOMESTIC WATER SUPPLY ON TAKE PIPE FOR PENSIMBLISE FT FLOOR TRAP (100x110) MM FD REDOR DRAIN (100m/00) NIM WASH BASIN
WALL
BIR GI WASTE PIPE F991 4 (24/0 <u>/Hy</u> 3 (26/0 € 1991 L- 150mm THOX LEDGE WALL 1006 CI SOL PIPE -1000 CFWASTE PIPE FIRE LEGEND : A ..... 1808 M.S FIRE WET RISER PAPE B ..... 1508 M.S SPRINKLER RISER PAR C ..... 903 M.S SFRINKLER DRAIN PIPE FIRE HOSE CARMEY GOOD FLOW SWITCH AENDENT TYPE SPRINKLER #\$ SECE WALL TYPE SPR#WILES SPRINKLER FEEDER LINE IMPORTANT NUTES:-<u>¢\$00 x 800)mm</u> CUT 0a1 ix FHb. 1.J 1500 NET AJBER 2.) 150**6 SPRIMULHI KIS**EH. 3.) BOD DRAW PEG.

(Internal) Services only subject to comments in forwarding letter tin. 9 (10) 244-74 OPENING SCHEDULE OF DOORS & WINDOWS SR. NO SIZE SILL LINTEL TYPE 1 800 2400 D1 2 900 **240**0 D2 2400 D3 2400 DW1 2400 DW2 |1500 | X 6|1800 [X| 2400 DW3 7 2100 X 2400 DW4 8 2750 X 2400 DW5 9 1615 2400 DW6 10 2400 2400 DW7 11 600 2400 W1 12 1000 2400 W2 13 1070 2400 W3 2400 W4 14 2100 15 2750 2400 W5 16 1500 2400 W6 17 2400 2400 W7 18 800 900 2400 W8

1. DIMENSIONS ARE NOT TO BE SCALED.
2. ALL DIMENSIONS ARE IN MM.

3. ALL ELECTRICAL INSTALLATIONS SHALL BE AS PER PROVISIONS OF NBC.

4. FIRE FIGHTING SAFETY PROVISIONS WILL BE AS PER RELEVANT NBC PROVISIONS. 5. BOUNDARY WALL AND GATE AS PER STANDARDS.


6. ALL WALLS ARE 230/115 MM THK. BRICK WALL. 7. RAIN WATER HARVESTING SYSTEM SHALL BE PROVIDED AS PER CENTRAL GROUND WATER AUTHORITY NORMS/HARYANA


8. ALL WINDOWS & VENTILATORS ARE OPENABLE,
9. ALL MECHANICALLY VENTILATED & ARTIFICIALLY LIT TOILET PROVIDED WITH 24hr POWER BACKUP.

DEVELOPED BY:

PROPOSED BUILDING PLAN OF GROUP HOUSING FOR AREA MEASURING 11.875 + 8.294 = 20.169 ACRES(LICENCE NO. 250 OF 2007 DATED 02.11.2007 AND LICENCE NO. 50 OF 2012 DATED 17 / 5/ 2012 IN SECTOR 109, GURGAON MANESAR URBAN COMPLEX BEING DEVELOPED BY RAJ KIRAN PVT. LTD. AND OTHERS IN COLLABORATION WITH CHINTELS INDIA LTD.

DRAWING TITLE : TOWER-1,TYPE-A,TERRACE LEVEL PENT HOUSE PLAN & AREA DIAGRAM (PHASE-1)+78350 MM Kaushik Modl 1-A-2.7 CHECKED BY Martish Kr. Gupta THROUGH: AUTHORISED SIGNATORY

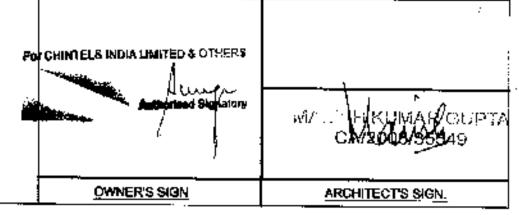

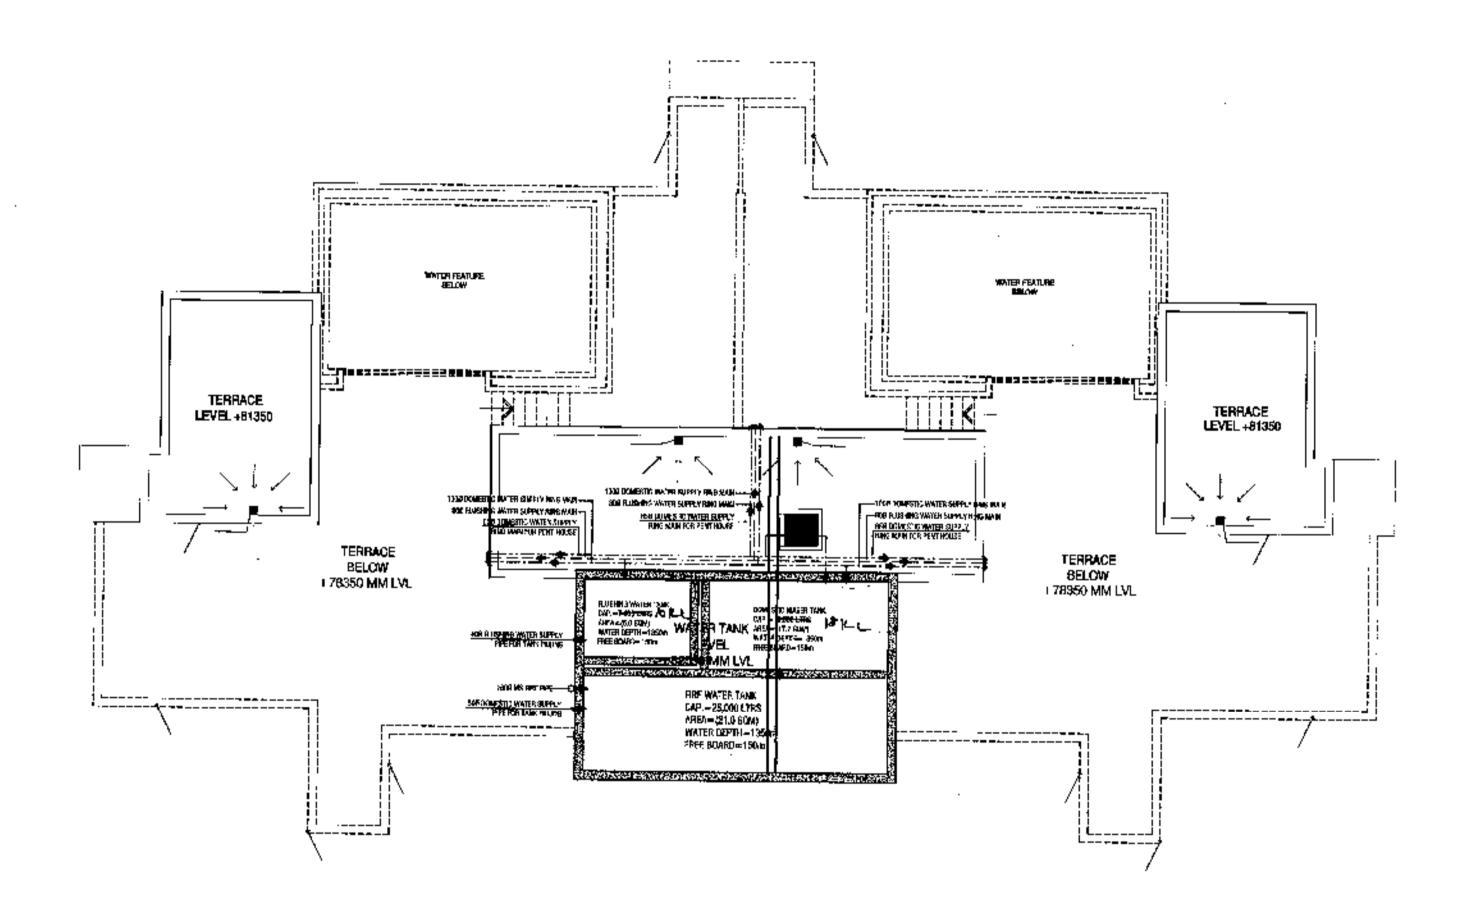


WATER TANK LEVEL PLAN
TOWER -1,TYPE-A +82550 MM LVL


PLUMBING NOTES: WASH SASIN TO PLOOR TRAP 9T) \$25 65 WASHE PIPE. Checked and lound of for Pupire Hearts
(Internal) Services only subject to comments in
forwarding letter for for the Hearts


And the Pupire Hearts

And the Pupi WITCHEN SMIN TO FLOOR TRAP FLESSLE PIPE, . PLOOR DRAIN (FD) TO FLOOR THAP (FT) 509 GI WASTE PIPE. 1000 CUPPE USED FOR SOIL & WASTE. 1000 CI PIPE USED FOR KITCHEN WASTE, SCHEDULE OF PIPES :-1008 CL SOLL & VENT PIPE 2 1000 CI WASTE & VENT PIPE 750 ANR SPRINGSASS FIFE DOMESTIC WATER SUPPLY DAN TAKE PIE FLUSHENG WATER SUPPLY DAN TAKE PIPE DOMESTIC WATER SUPPLY RISER PIPE\* BLUSHING WATER SUPPLY RISER PIPE\* (10) HOT WATER SUPPLY INN TAKE FIRE FROM SQ: AR PANEL DOMESTIC WATER SUPPLY DW TAKE PIPE FOR PEN HOUSE CT RUSSET TRAP (106/116) MM FD REDOR ORAIN (100650) AM 1. DIMENSIONS ARE NOT TO BE SCALED.
2. ALL DIMENSIONS ARE IN MM. 3. ALL ELECTRICAL INSTALLATIONS SHALL BE AS PER WASH BASIN
WALL
WASH BASIN PROVISIONS OF NBC. 4. FIRE FIGHTING SAFETY PROVISIONS WILL BE AS PER RELEVANT NBC PROVISIONS. 5. BOUNDARY WALL AND GATE AS PER STANDARDS. ALL WALLS ARE 230/115 MM THK. BRICK WALL.
 RAIN WATER HARVESTING SYSTEM SHALL BE PROVIDED AS **П 0———** Ю -508 BY WASTE PIPE PER CENTRAL GROUND WATER AUTHORITY NORMS/HARYANA 8. ALL WINDOWS & VENTILATORS ARE OPENABLE.
9. ALL MECHANICALLY VENTILATED & ARTIFICIALLY LIT TOILET PROVIDED WITH 24hr POWER BACKUP. ----- 1000 CI \$00 PIPE DEVELOPED BY: 1000 CHWASTE PIPE PINE LESEND :-PROJECT: A ...... 1500 M.S FINE WITT RESER PARE B ...... 1500 M,S SPRINKLEN RESER PIPE PROPOSED BUILDING PLAN OF GROUP HOUSING FOR AREA MEASURING 11.875 + 8.294 = 20.169 C ..... 800 M.S SPRINKLER DAWN PIFE ACRES(LICENCE NO. 250 OF 2007 DATED FIND ARE HOSE CABINET 02.11.2007 AND LICENCE NO. 50 OF 2012 DATED 17 GOO FLOW SANTCH / 5/ 2012 IN SECTOR 109, GURGAON MANESAR URBAN COMPLEX BEING DEVELOPED BY RAJ PENDENT TYPE SPRINKLER KIRAN PVT. LTD. AND OTHERS IN COLLABORATION NS SIDE WALL TYPE SPRINKLER WITH CHINTELS INDIA LTD. SPRINKLEA REEDER UME DRAWING TITLE : IMPORTANT NOTES:-(300 x 800) war gut out in fac. TOWER-1, TYPE-A, WATER TANK LEVEL PLAN (PHASE-1)+82550 MM LVL 2) 1536 SPENNKLER RISER. 13.) ASSI DRAIN PIPE DEALT BY DRG, NO. Kaushik Modi 1:100 CHECKED BY Manish Kr. Gupta THROUGH: AUTHORISED SIGNATORY FOR CHINTELS INDIA LIMITED & CHINES OWNER'S SIGN ARCHITECT'S SIGN.

OHT UPPER FFL +85550 OHT LOWER FFL +82550 1050 HIGH-230 THICK PARAPET TERRACE +78350 EFL BEDROOM 24 th(PHU)FFL +75000 BEDROOM BEDROOM 22nd FFL +68600 BEDROOM 21st FFL +65550 LIFT BEDROOM 20th FFL +62500 BEDROOM 19th FFL +59450 LIFT BEDROOM \_18th FFL-\\_+56400 BEDROOM 17th FFL +53350 BEDROOM 16th FFL +50300 BEDROOM 15th FFL +47250 BEDROOM 14th FFL +44200 LIFT BEDROOM LJFT BEDROOM 12th FFL \(\frac{+38100}{2}\) BEDROOM 11th FFL +35050 BEDROOM 10th FFL +32000 9th\_FFL\_\+28950 BEDROOM 8th\_FFL\_\(\frac{+25900}{-25900}\) BEDROOM 7th FFL +22850 BEDROOM 6th FFL +19800 BEDROOM 5th FFL +16750 BEDROOM 4th FFL +13700 BEDROOM 3rd/FFL\_+10650 ... 1050 HBGH ---DEVELOPED BY: BEDROOM AREA MEASURING 11.875 + 8.294 = 20.169 ACRES (LICENCE NO.250 OF 2007 DATED 02.11.2007 AND LICENCE NO. 50 OF 2012 DATED 17/ 5 /2012) IN SECTOR-109, GURGAON MANESAR URBAN COMPLEX BEING DEVELOPED BY RAJ KIRAN PVT. LTD. AND OTHERS IN COLLABORATION WITH CHINTELS INDIA LTD. ENTRANCE LOBBY TOWER-1, TYPE-A SECTION-AA ( .....i-1 (PHASE-1) CHECKED BY -2550 MM U.BAS
-11FT L LVL
-3000 MM UPPER
BASEMENT FLR LVL R=163.63 T=300 W=1250 SECTION - AA -8100 MM RAFT-\(\sigma\) BOTTOM LVL ARCHITECT'S SIGN.

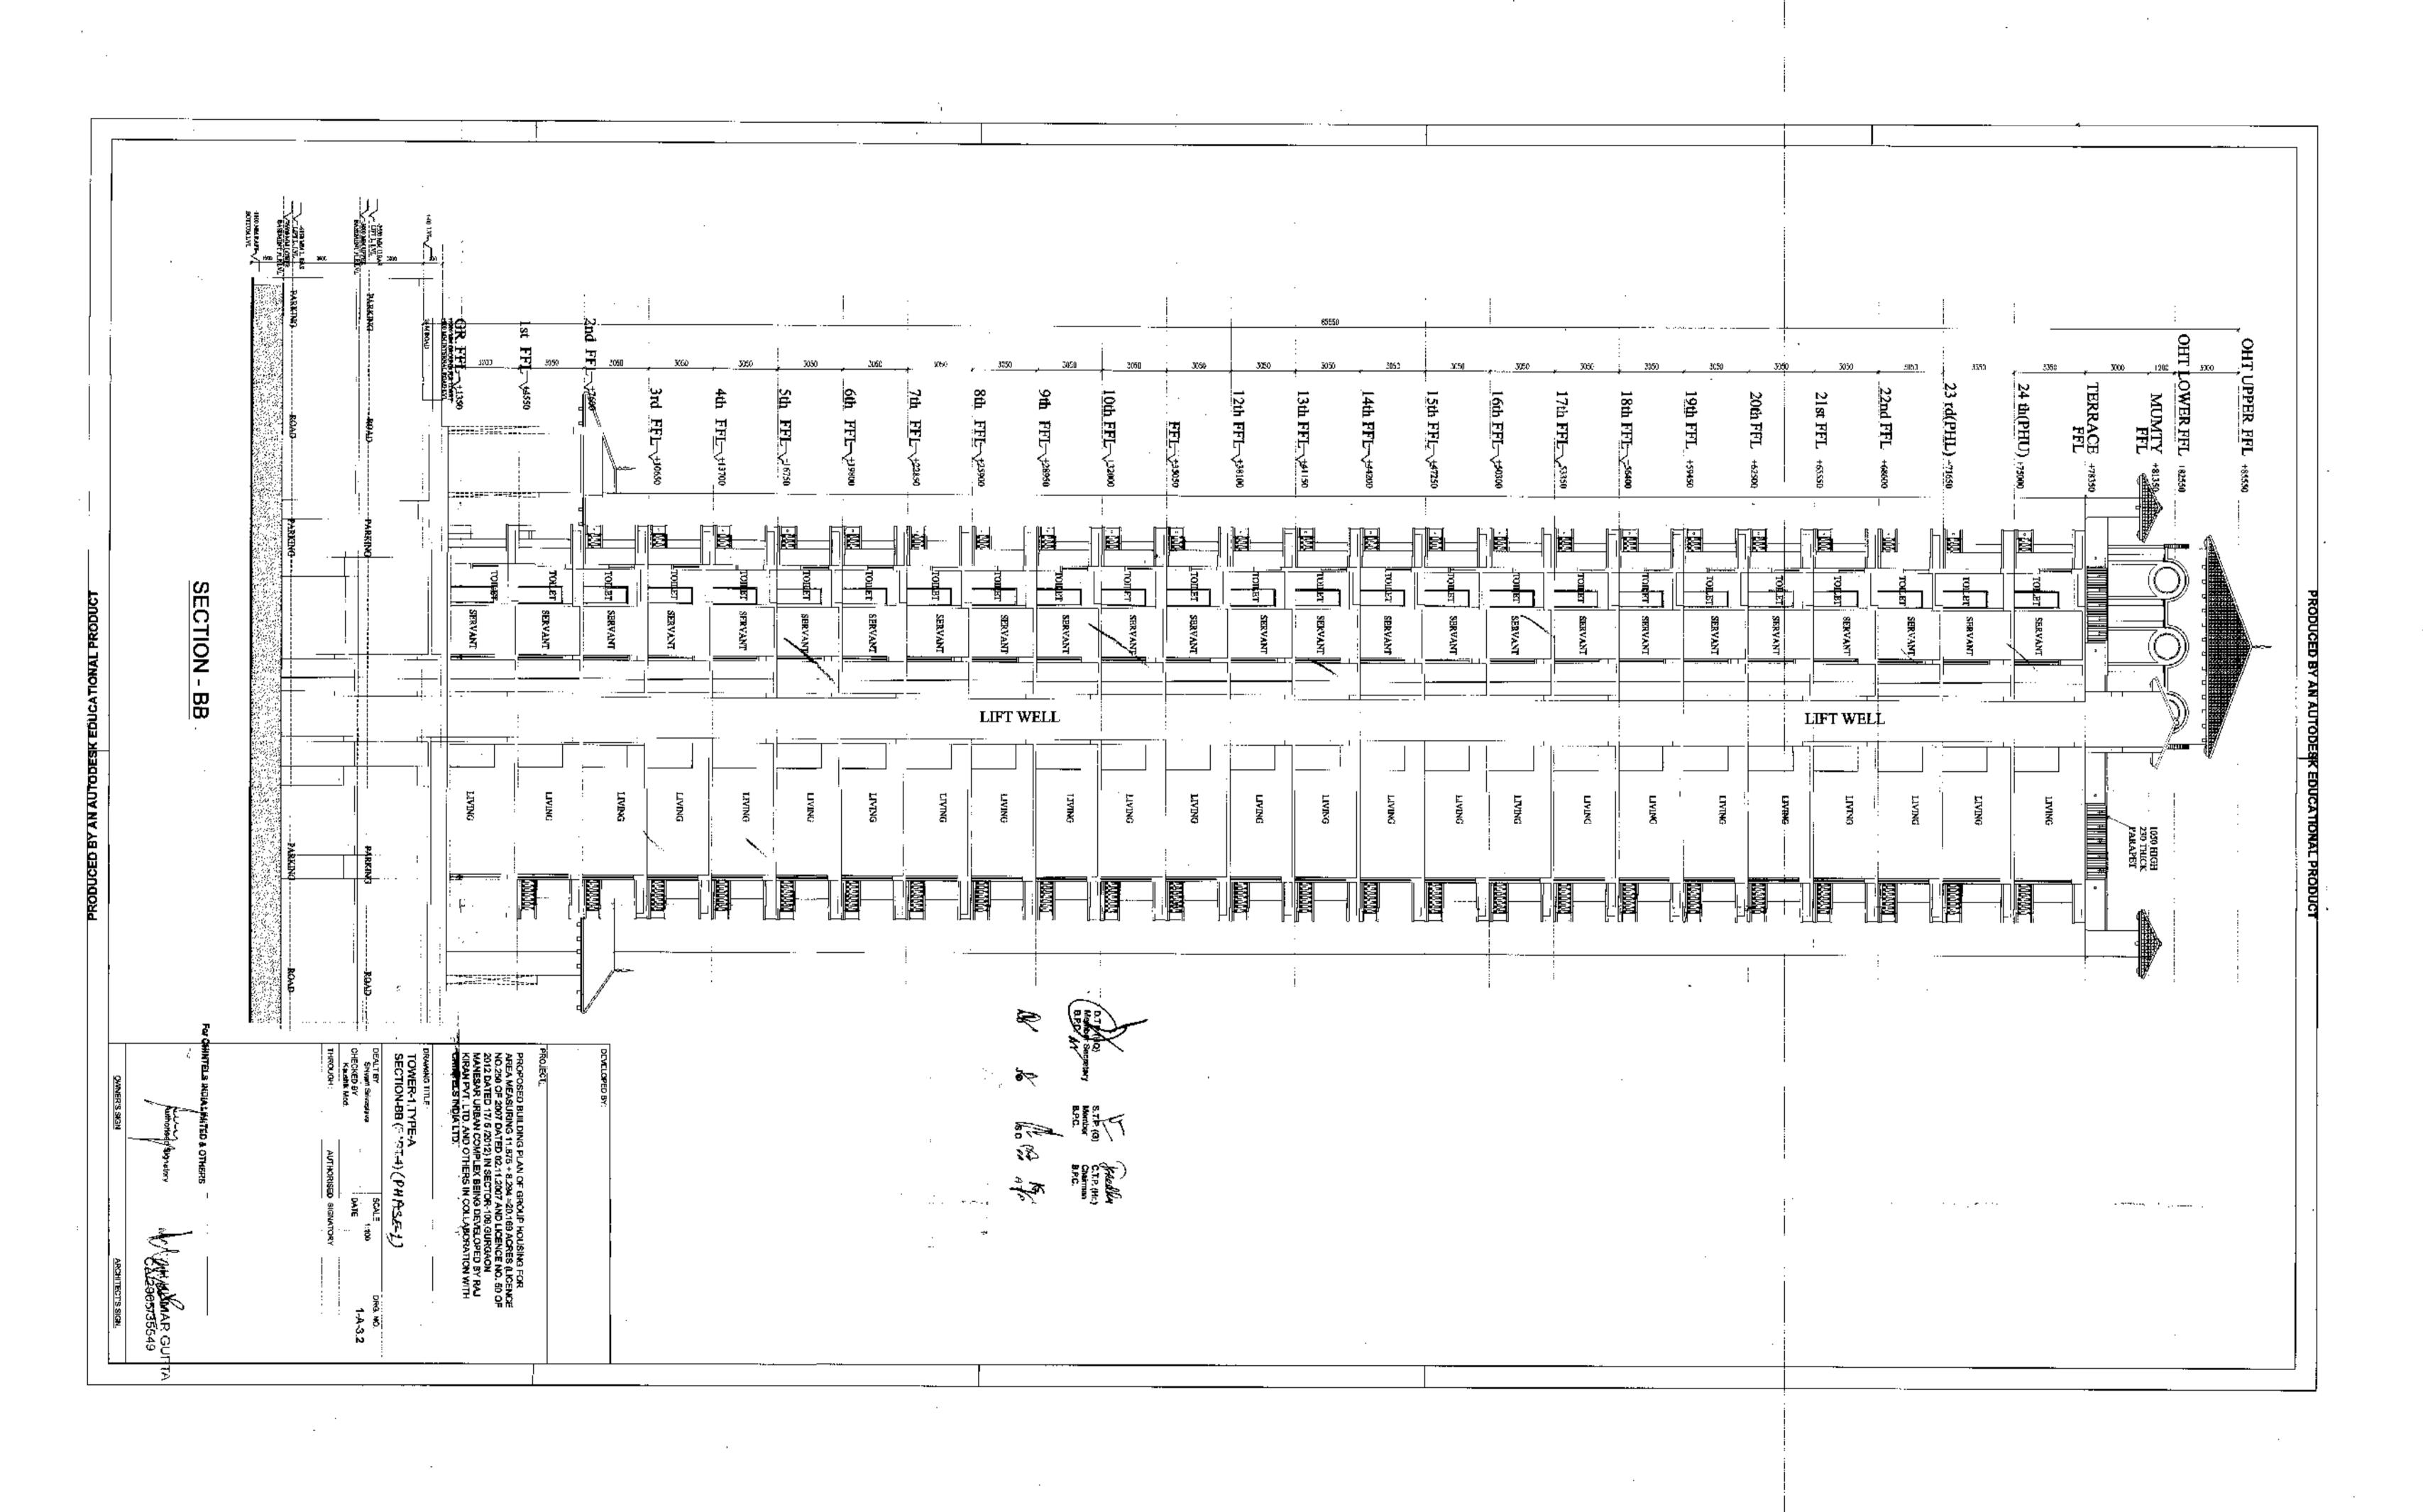

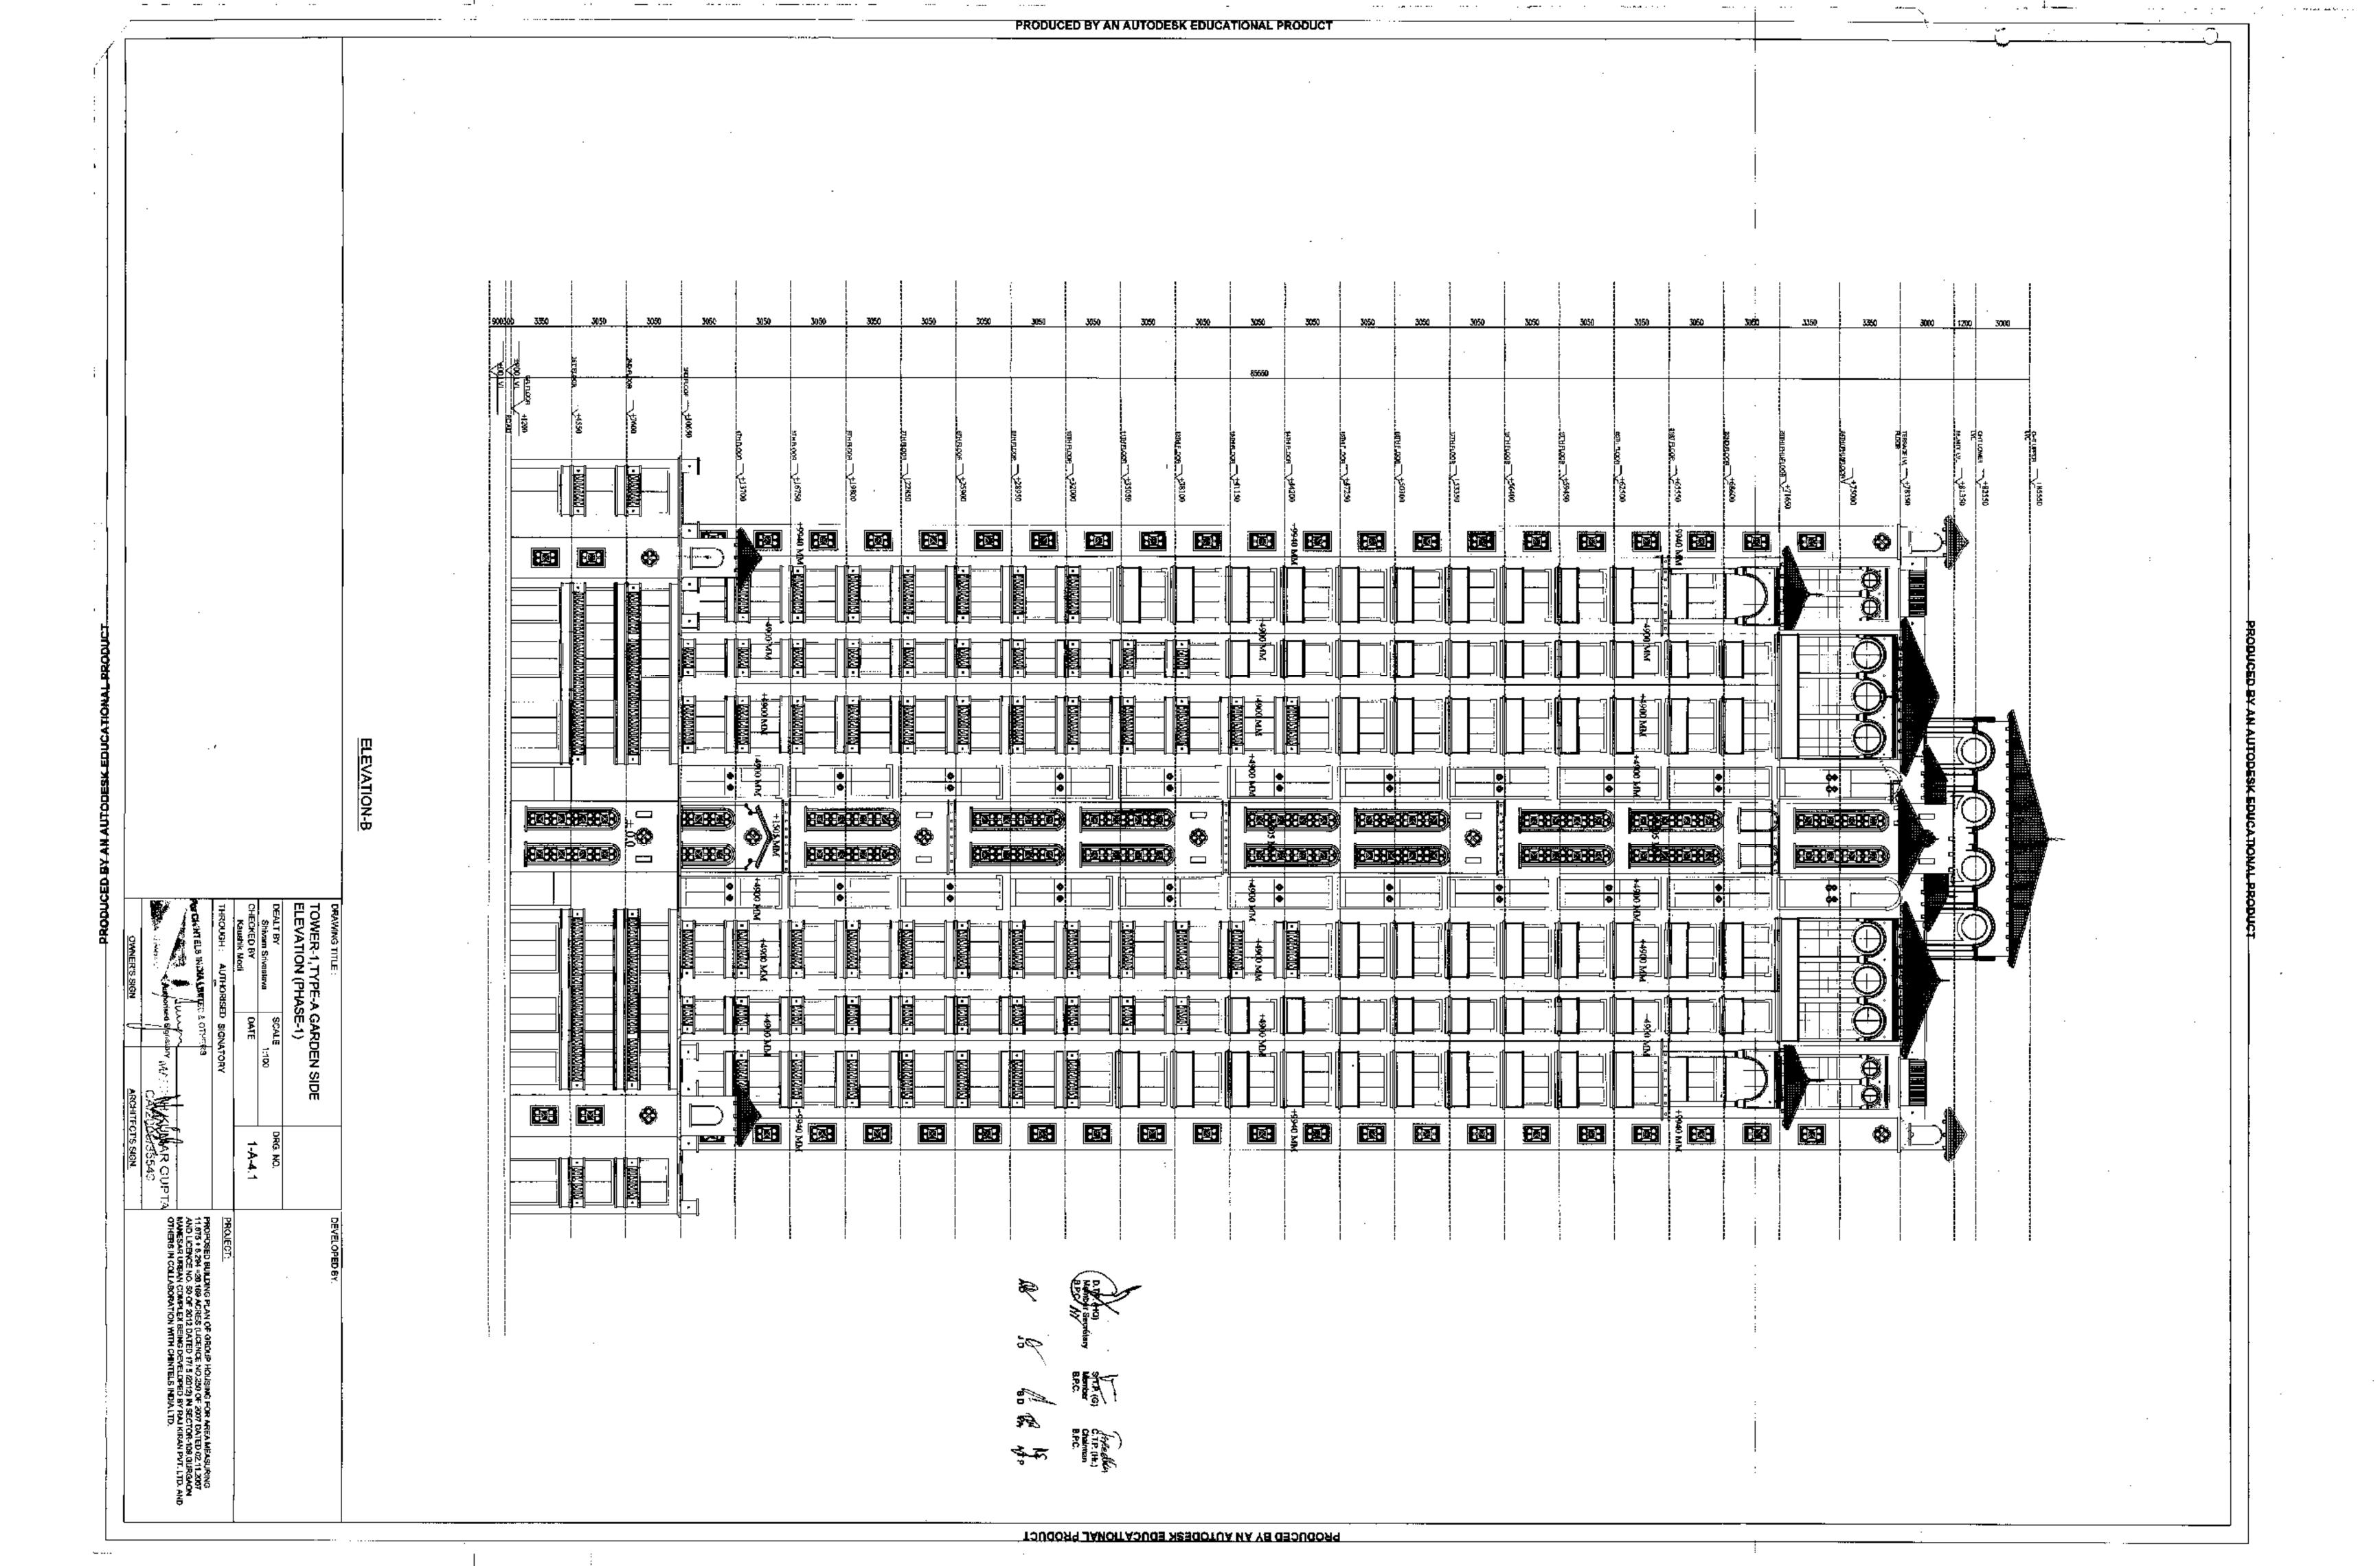

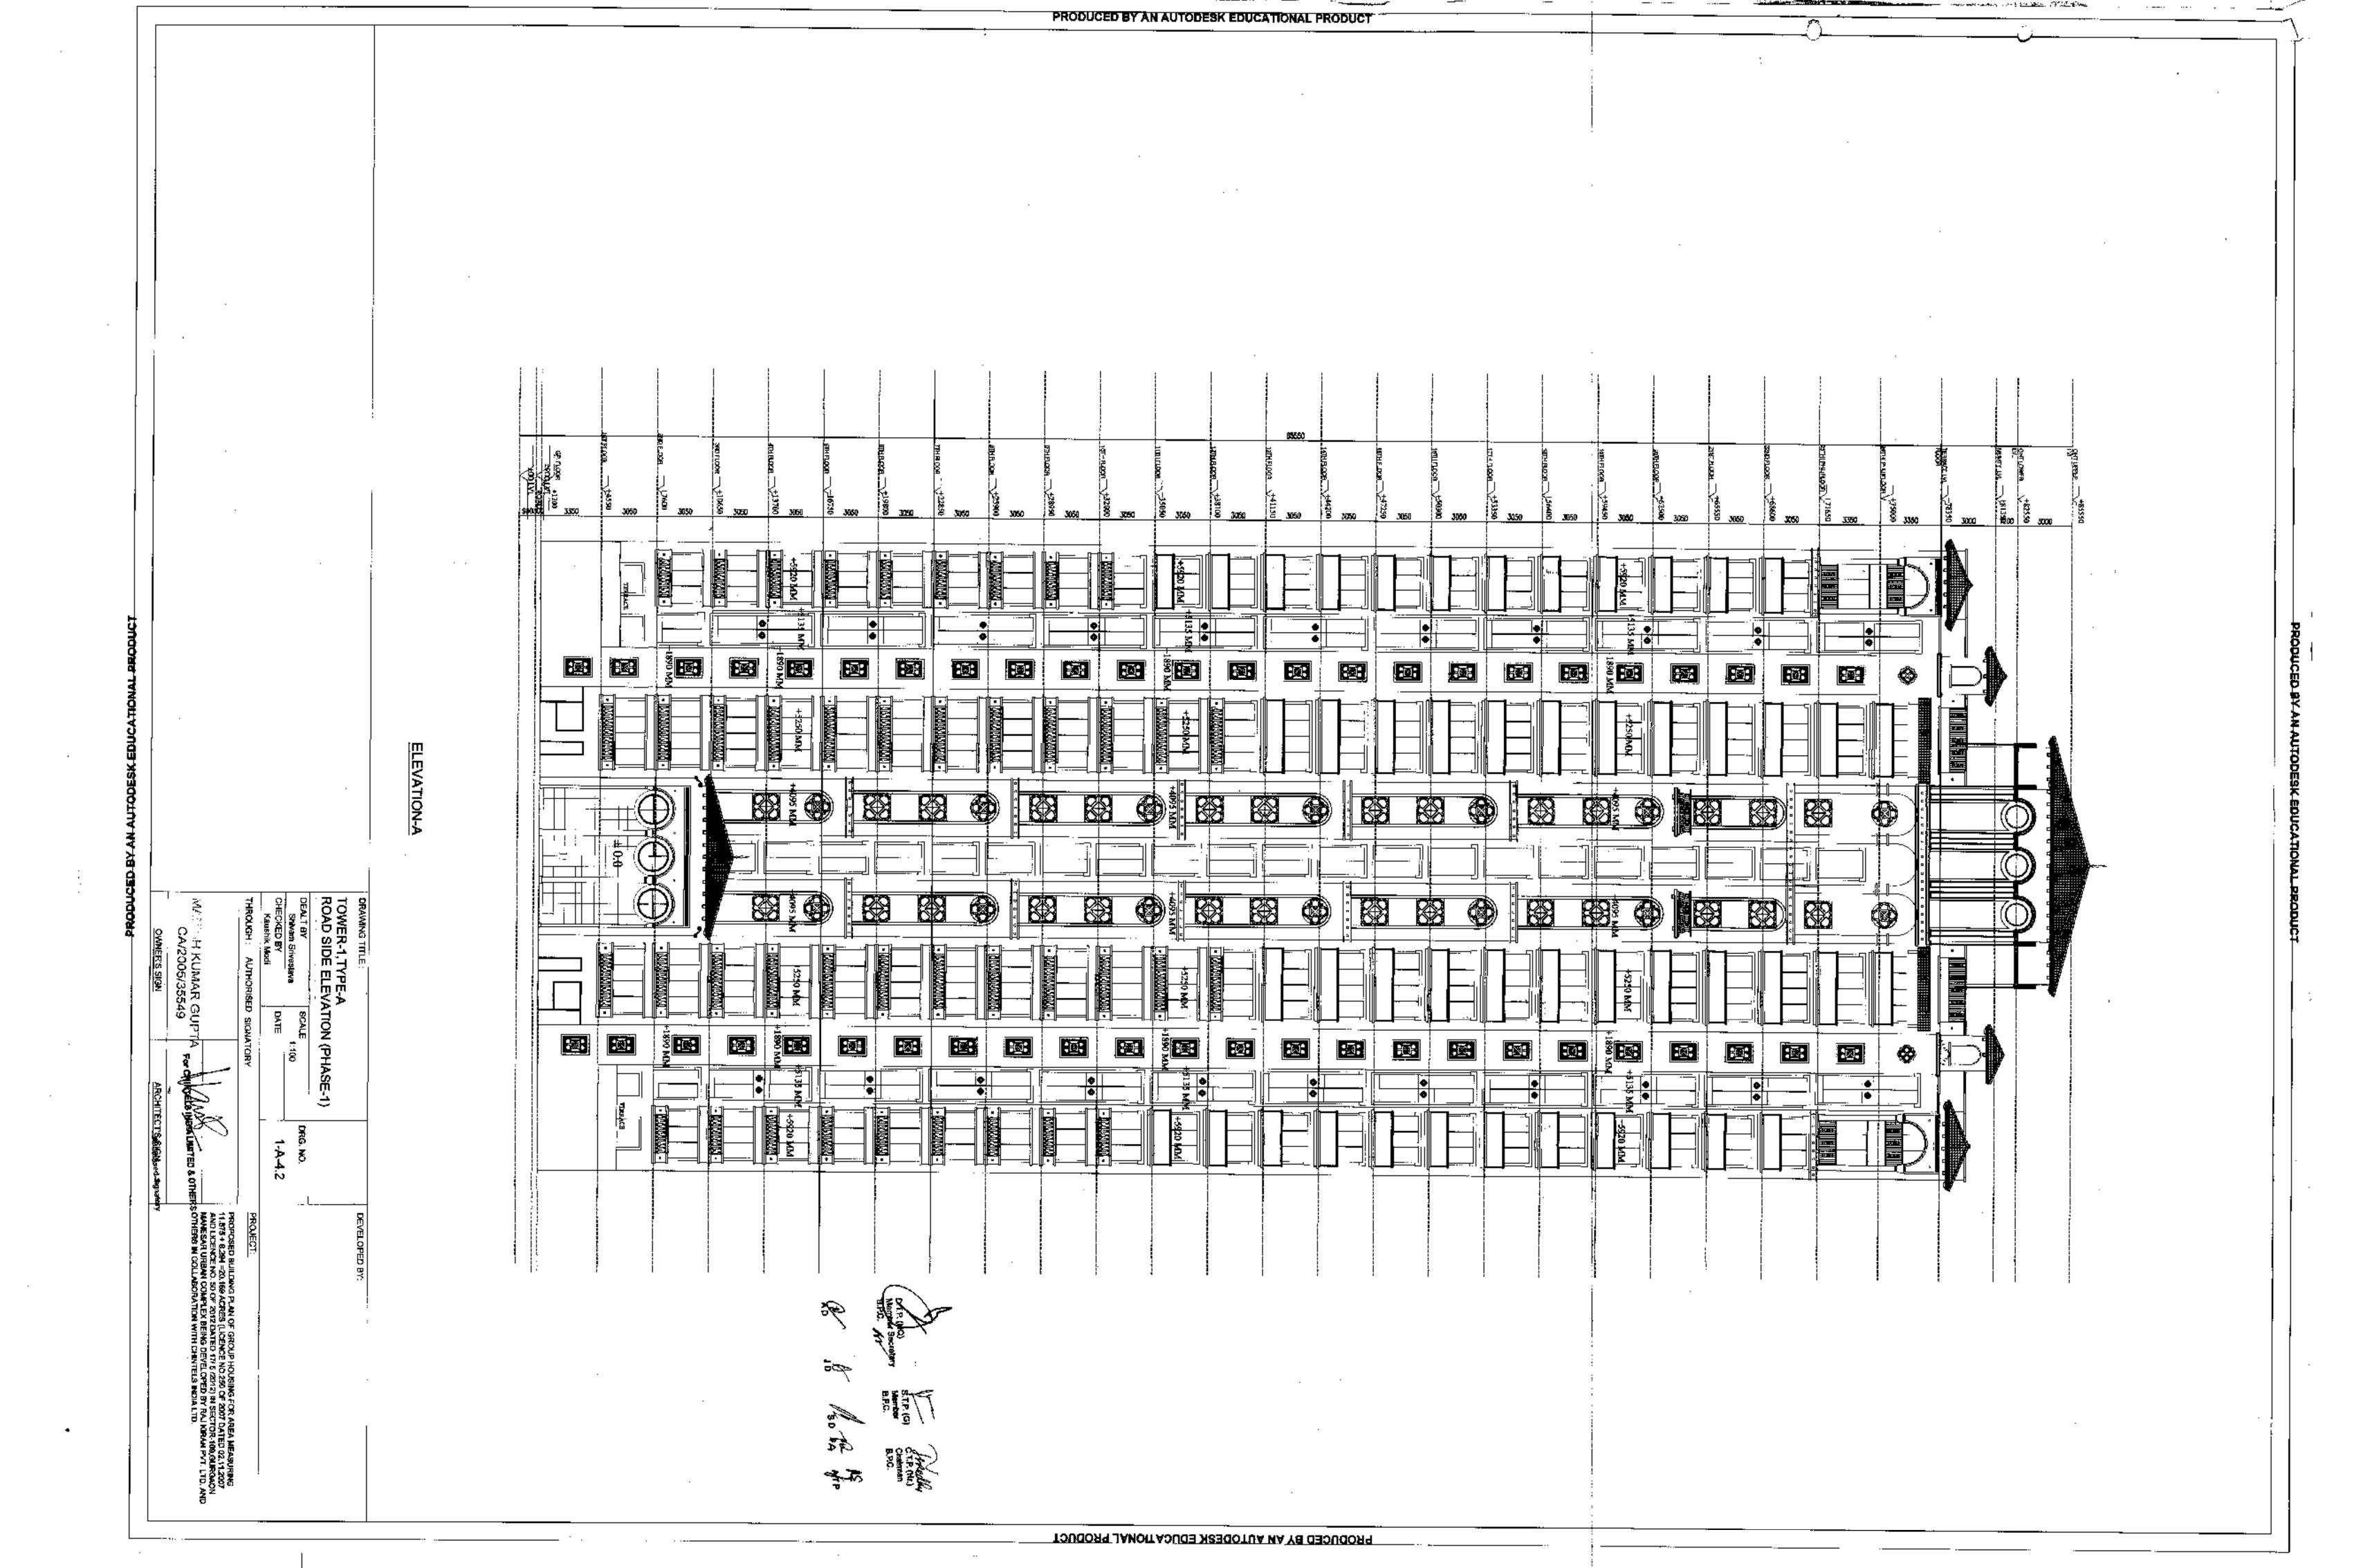

22ND FLOOR -+68600 +450 MM 3RD FLOOR — +10650 ISTELOOR +4550 000 10000 <del>....±</del>900<u>LV</u>L\,∠---V .:...

DEVELOPED BY:

PROJECT: PROPOSED BUILDING PLAN OF GROUP HOUSING FOR AREA MEASURING 11.875 + 8.294 = 20.169 ACRES (LICENCE NO.250 OF 2007 DATED 02.11.2007 AND LICENCE NO. 50 OF 2012 DATED 17/ 5 /2012)
IN SECTOR-109,GURGAON MANESAR URBAN COMPLEX BEING
DEVELOPED BY RAJ KIRAN PVT. LTD. AND OTHERS IN

COLLABORATION WITH CHINTELS INDIA LTD. DRAWING TITLE :

TOWER-1, TYPE-A, LEFT & RIGHT SIDE ELEVATION (PMASE-1)

DEALT BY SCALE Shivam Srivastava 1:100 CHECKED BY DATE

Kaushik Modi THROUGH: AUTHORISED SIGNATORY

For CHRETELS INDIA LIMITED & OTHER

OWNER'S SIGN


MALILUH KUMAR GUPTA CA/2005/35549 ARCHITECT'S SIGN.


DRG. NO.

1-A-4.3

PRODUCED BY AN AUTODESK EDUCATIONAL PRODUCT

**ELEVATION-C & D** a 4 - 4

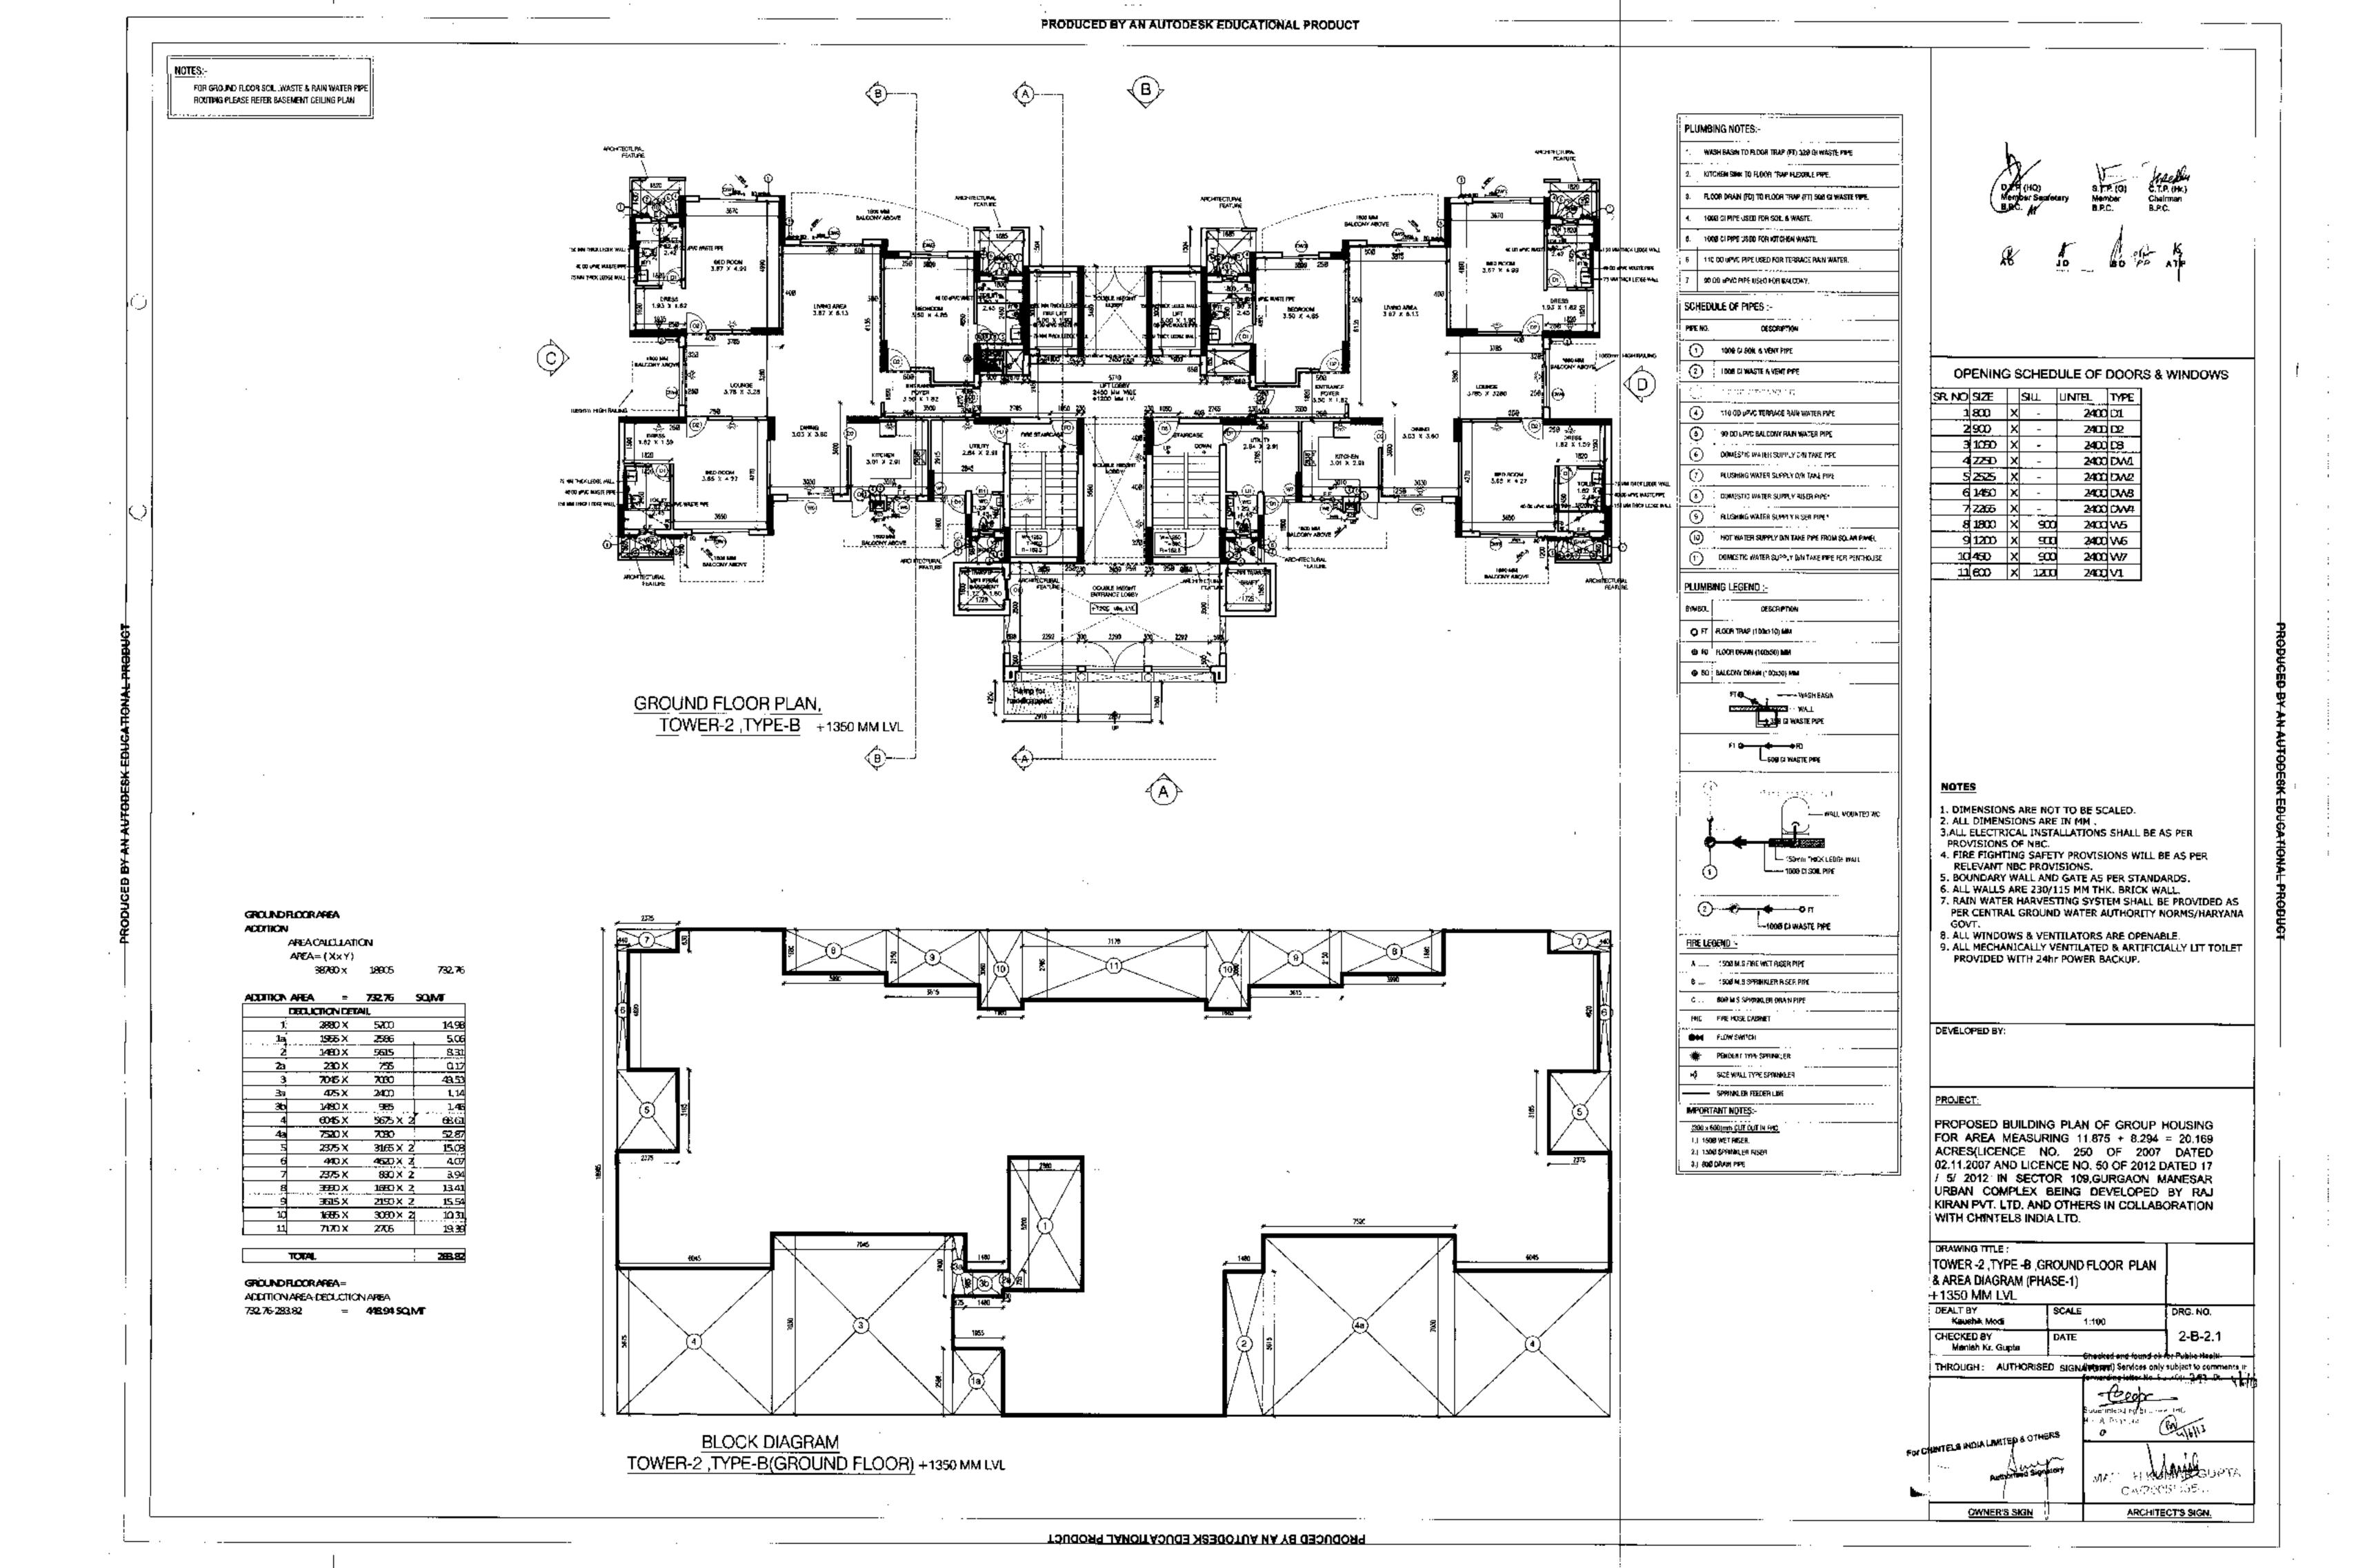

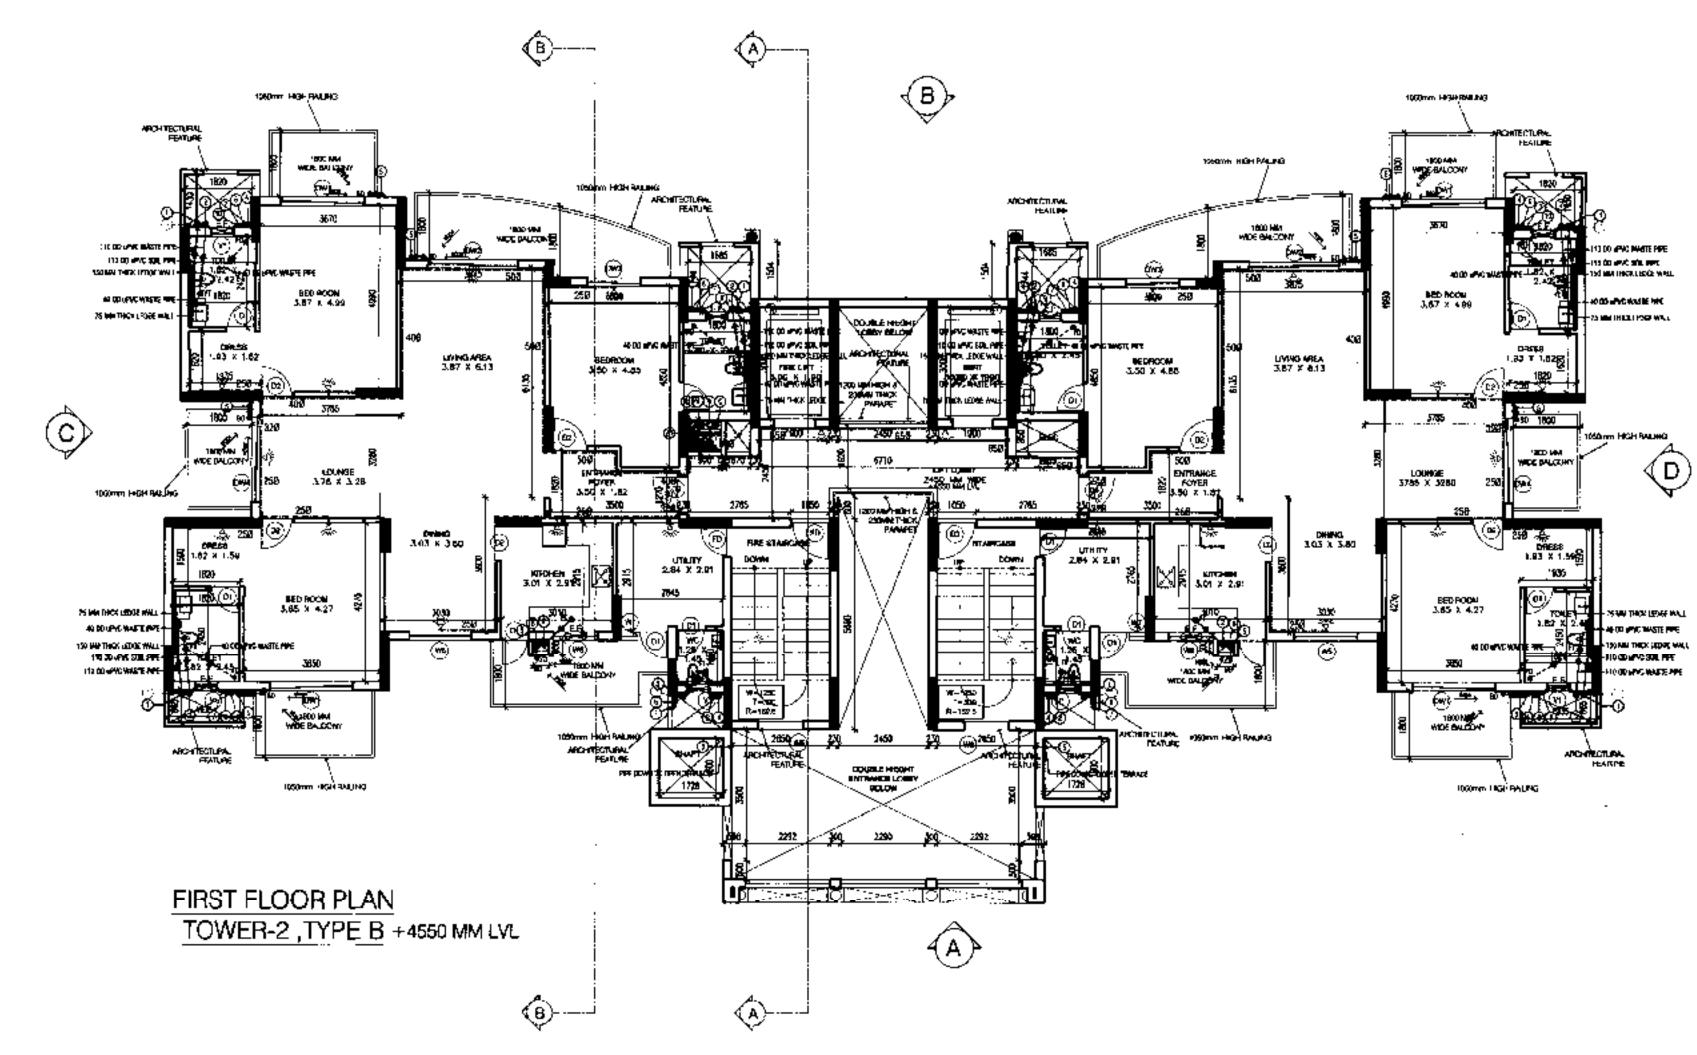

FIRST FLOOR AREA

AREA CALCULATION


AREA = ( X x Y )

38760 x 14275 55


ADDITION A	AREA :	= 553.30		SQ.MT
	DEDUCTION	DETAIL		
1	5330	x 5430		28.9
1a	2450	X 830		2.03
2	1480	X 985		1.4
2a	1710 3	X 985		1.69
3	7520 3	X 2400	X 2	36.1
4	6045 3	X 1045	X 2	12.6
5	2375	X 3165	χ 2	<b>1</b> 5.03
6	440	X 4620	X 2	4.0
7	2375	x 830	X 2	3.9
8	3990	X 1680	X 2	13.4
9	3615	X 2150	ΧZ	15.5
10	10540	X 2705		<b>28</b> .5
11	1685	X 355	X 2	1.2
12	1900	X 3000	X 2	11,4
13	900	X 850		0.7
14	570	x 850		0.5
15	1685	X 850		1.4
16	2450	X 3230		7.9
l 1	OTTAL			186 6

FIRST FLOOR AREA =

ADDITION AREA-DEDUCTION AREA 553.30-186.63 = **366.67 SQ.M**T

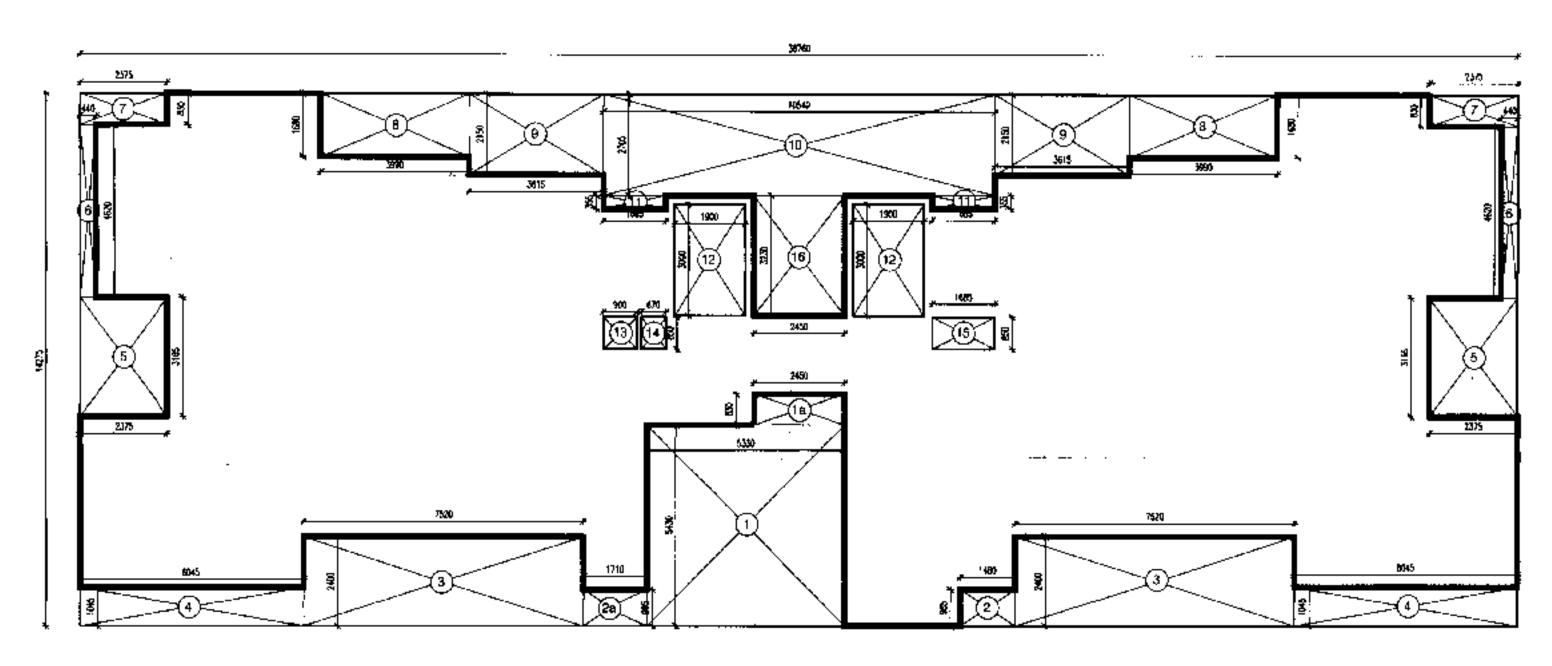

BLOCK DIAGRAM TOWER -2, TYPE-B FIRST FLOOR PLAN +4550 MM LVL

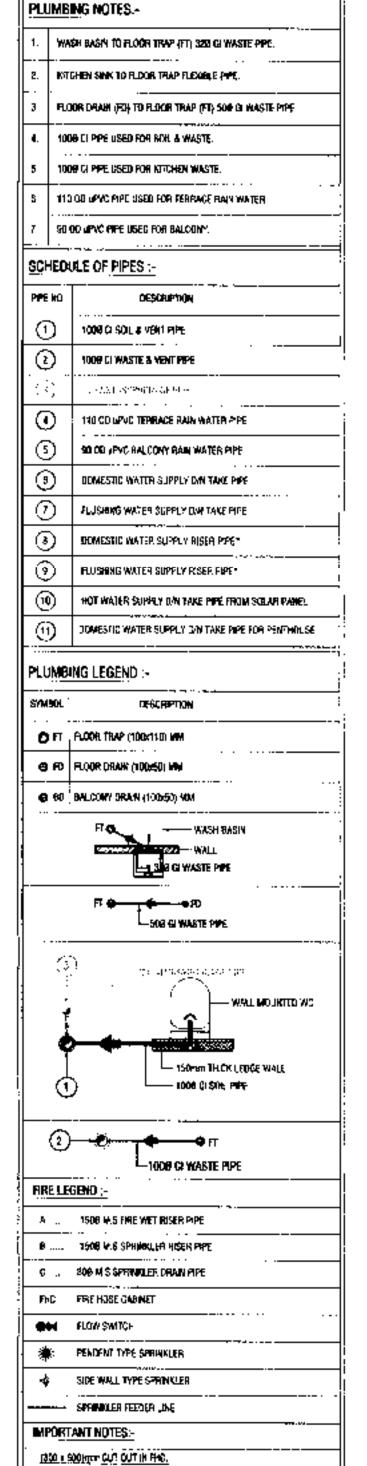

1.) 1508 WET RISER

3] BOB DRAW HTFE.

2) 1908 SPHINKLER PISEIL

D.T.P (HC)

Member Secretary

B.P.C.

B.P.C.

S.D. F. A.T.

A. S.D. F. A.T

OPENING SCHEDULE OF DOORS & WINDOWS

r No	SIZE		SILL	UNTEL	TYPE		
1	800	×	_	2400	ដ		
2	900	X	1	2400	2		
3	1050	×	ı	2400	8		
4	2250	×	1	2400	DV1		
. 5	8	X	-	2400	DW2		
6	1450	х	-	2400	DM8		
7	2265	×	-	2400	DV4		
8	1800	×	900	2400	Wδ		
9	1200	×	900	2400	W6		
10	450	Х	900	2400	W7		
11	88	×	1200	2400	<b>V</b> 1		

NOTES

- 1. DIMENSIONS ARE NOT TO BE SCALED.
- 2. ALL DIMENSIONS ARE IN MM . 3.ALL ELECTRICAL INSTALLATIONS SHALL BE AS PER
- PROVISIONS OF NBC.
  4. FIRE FIGHTING SAFETY PROVISIONS WILL BE AS PER
- RELEVANT NBC PROVISIONS.

  5. BOUNDARY WALL AND GATE AS PER STANDARDS.

  6. ALL WALLS ARE 230/115 MM THK, BRICK WALL.
- 6. ALL WALLS ARE 230/115 MM THK, BRICK WALL.
  7. RAIN WATER HARVESTING SYSTEM SHALL BE PROVIDED AS
- PER CENTRAL GROUND WATER AUTHORITY NORMS/HARYANA
- 8. ALL WINDOWS & VENTILATORS ARE OPENABLE.


  9. ALL MECHANICALLY VENTILATED & ARTIFICIALLY LIT TOILET PROVIDED WITH 24hr POWER BACKUP.


DEVELOPED BY:

PRO IECT

PROPOSED BUILDING PLAN OF GROUP HOUSING FOR AREA MEASURING 11.875 + 8.294 = 20.169 ACRES(LICENCE NO. 250 OF 2007 DATED 02.11.2007 AND LICENCE NO. 50 OF 2012 DATED 17 / 5/ 2012 IN SECTOR 109,GURGAON MANESAR URBAN COMPLEX BEING DEVELOPED BY RAJ KIRAN PVT. LTD. AND OTHERS IN COLLABORATION WITH CHINTELS INDIA LTD.

THROUGH: AUTHORISED SIGNATURATED Services only subject to comments in

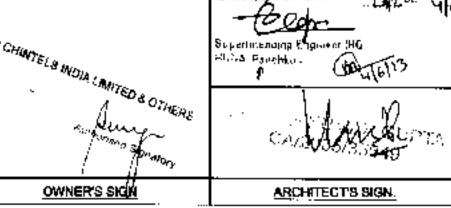

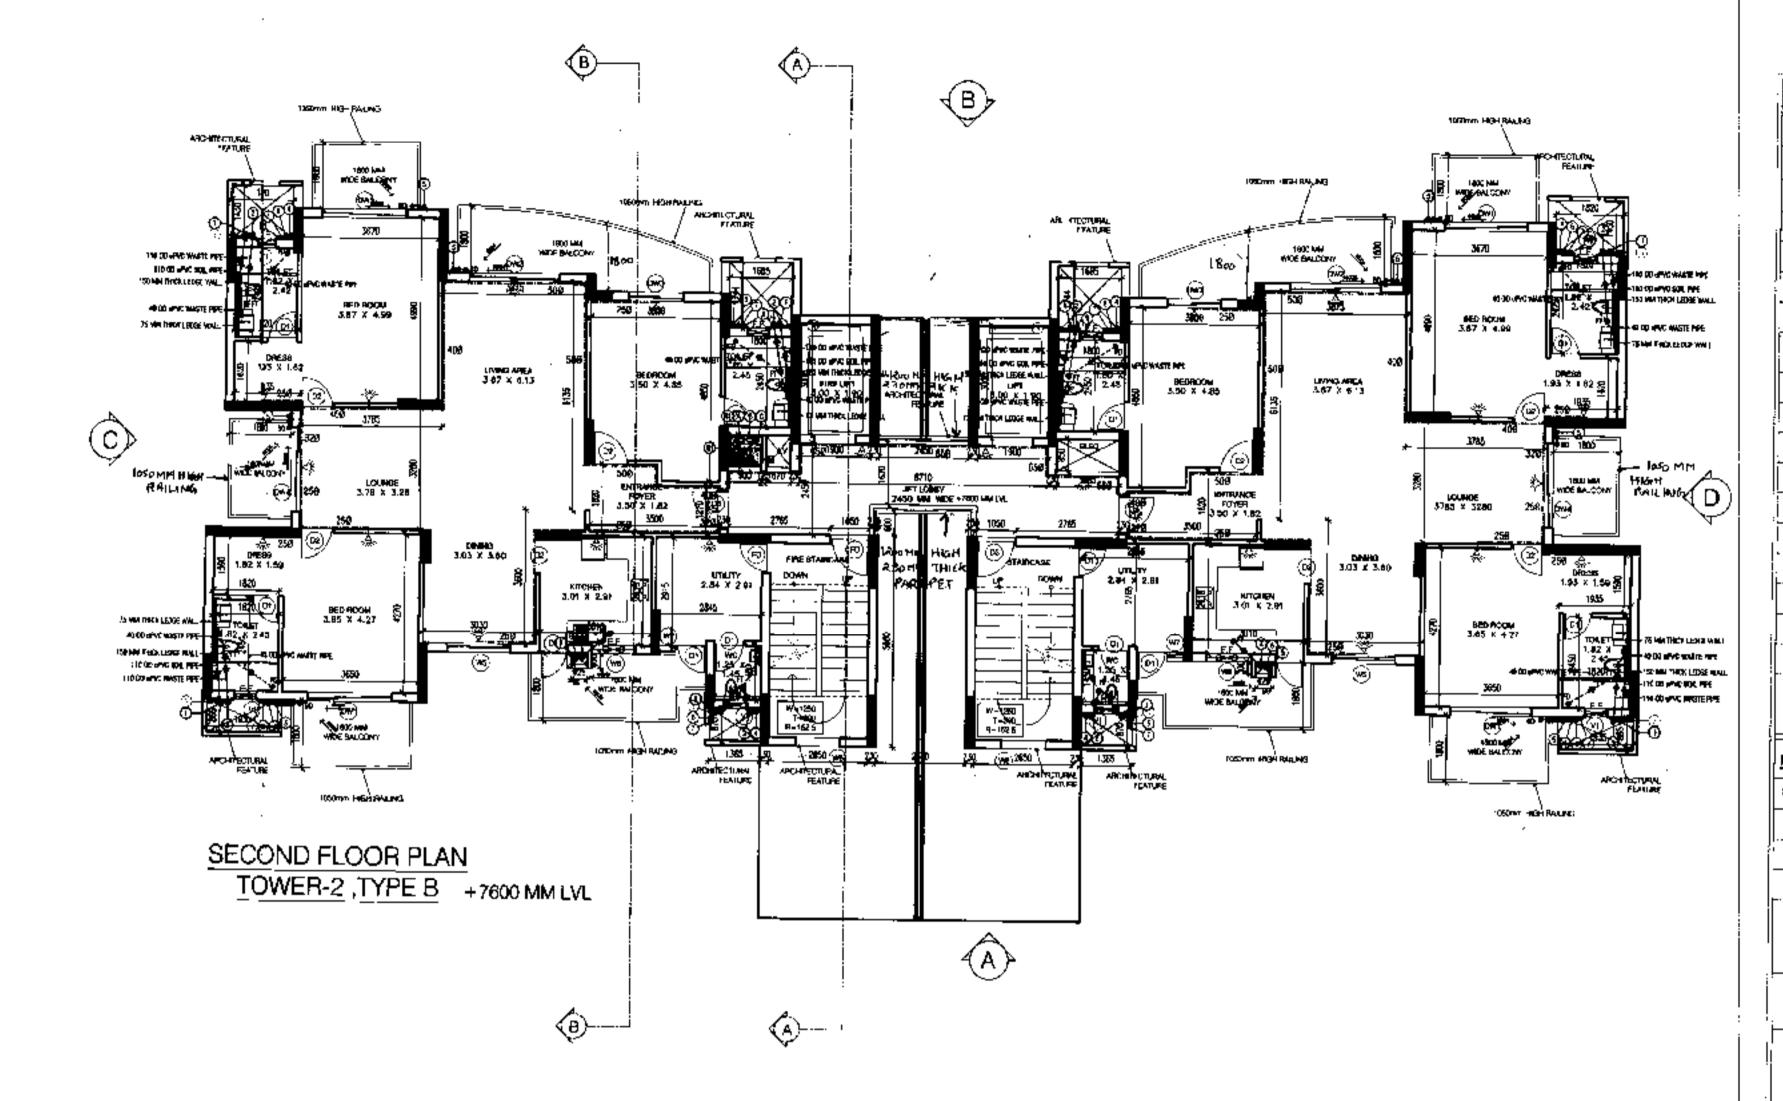

SECOND FLOOR AREA

AREA CALCULATION

38760 x 14275 553.30

<u>ADDITION A</u>	AREA =	553.30	SQ.MT
0	EDUCTION DET	AIL	
1_	5330 X	5430	28.9
1a	2450 X	830	2.0
	1480 X	985	1,4
2a	1710 X	985	1.6
3	7520 X	2400 X	36.1
4	6045 X	1045 X 2	12.6
5	2375 X	3165 X 2	
6	440 X	4620 X 2	4.0
7	2375 X	830 X 2	3.9
8	3990 X	1680 X 2	13.4
9	3615 X	2150 X 2	15.5
10	10540 X	2705	28.5
11	1685 X	355 X 2	1.20
12	1900 X	3000 X Z	11.40
13	900 X	850	0.7
14	670 X	850	0.57
15	1685 X	850	1.43
1.6	2450 X	3230	7.91


SECOND FLOOR AREA =

TOTAL

ADDITION AREA-DEDUCTION AREA

553.30-186.63 = **366.67 SQ.MT** 

BLOCK DIAGRAM TOWER -2, TYPE-B SECOND FLOOR PLAN +7600 MM LVL

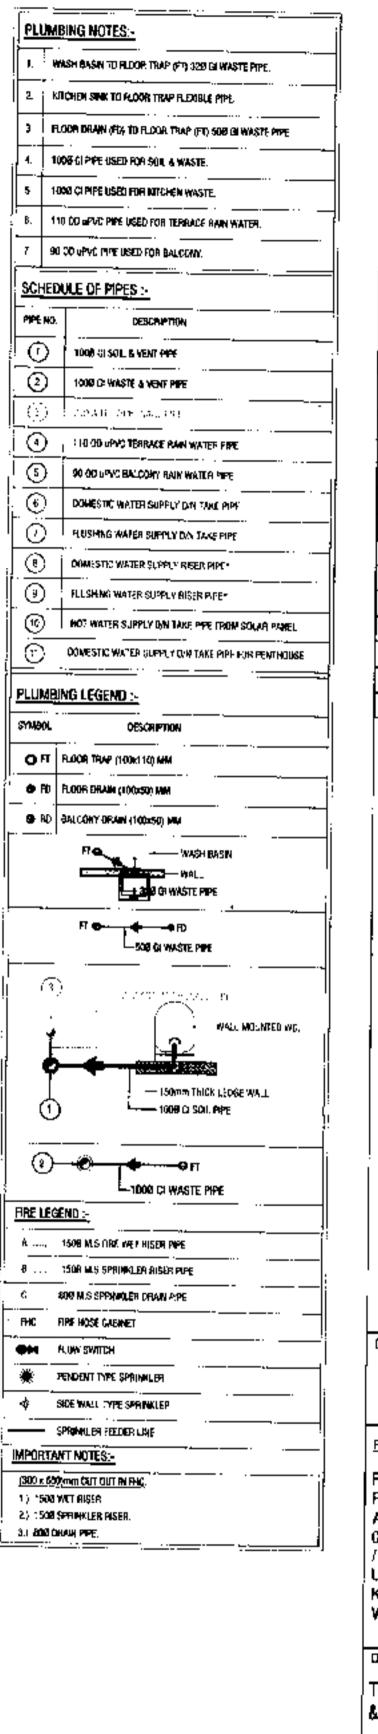

OPENING SCHEDULE OF DOORS & WINDOWS

· <del>-</del> -			<u></u>		
SR NO	SIZE		SIT	<b>UNTEL</b>	TYPE
1	8000	X	_	2400	C1
2	900	X	_	2400	D2
3	1050	X		2400	D3
_ 4	2250	X		2400	DW1
5	2525	Х		2400	DVZ
6	1450	×		2400	DWB
7	2265	×	1	2400	D\\4
8	1800	Х	900	2400	Мδ
9	1200	X	900	2400	W6
10	<b>45</b> 0	X	900	2400	W7
11	ഞ	X	1200	2400	V1

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RELEVANT NBC PROVISIONS. 5. BOUNDARY WALL AND GATE AS PER STANDARDS. 6. ALL WALLS ARE 230/115 MM THK. BRICK WALL.

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8. ALL WINDOWS & VENTILATORS ARE OPENABLE. 9. ALL MECHANICALLY VENTILATED & ARTIFICIALLY LIT TOILET PROVIDED WITH 24hr POWER BACKUP.

DEVELOPED BY:

PROJECT:


PROPOSED BUILDING PLAN OF GROUP HOUSING FOR AREA MEASURING 11.875 + 8.294 = 20.169 ACRES(LICENCE NO. 250 OF 2007 DATED 02.11.2007 AND LICENCE NO. 50 OF 2012 DATED 17 / 5/ 2012 IN SECTOR 109, GURGAON MANESAR URBAN COMPLEX BEING DEVELOPED BY RAJ KIRAN PVT. LTD. AND OTHERS IN COLLABORATION WITH CHINTELS INDIA LTD.

DRAWING TITLE

TOWER -2 , TYPE -B , SECOND FLOOR PLAN & AREA DIAGRAM (PHASE-1)+7600 MM LVL

DEALT BY DRG. NO. Keushik Modii 1:100 CHECKED BY Manish Kr. Gupta

THROUGH: AUTHORISED SIGNATOR Public Services only subject to comme 0742005/35549 ARCHITECT'S SIGN.

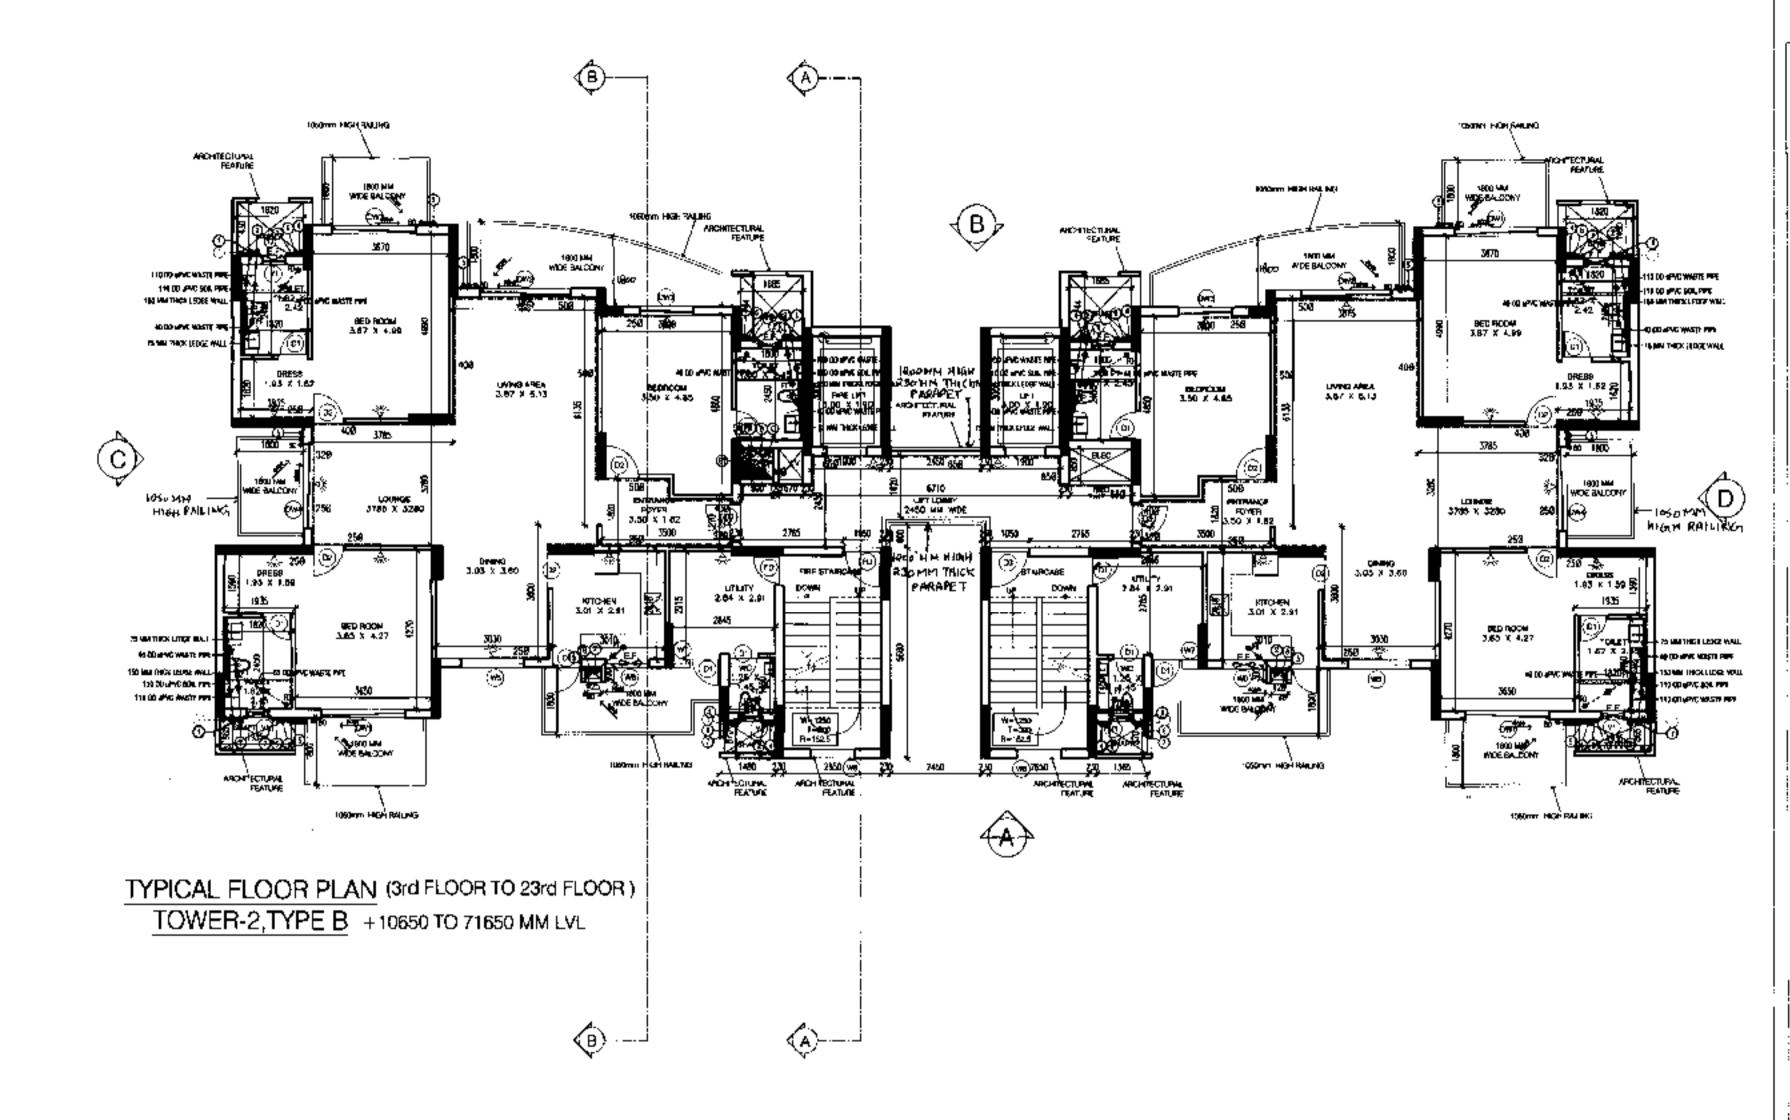

TYPICAL FLOOR AREA ADDITION

> AREA CALCULATION  $AREA = \{X \times Y\}$ 38760 x 14275 553.30


NOTICO	AREA =	553.30	SQ.MT
	DEDUCTION DET	AIL	
. 1	5330 X	5430	28.94
1a	2450 X	830	2.03
2	1480 X	985	1.46
2a	1710 X	985	1.68
3	7520 X	2400 X	35.10
4	6045 X	1045 X 3	12.63
. 5	2375 X	3165 X 2	15.03
6	, 440 X	4620 X	2 4.07
7.	2375 X	830 X 2	3.94
8	3990 X	1680 X	13.41
9	3615 X	2150 X	2 15,54
10	10540 X	2705	28.51
11	1685 X	355 X	2 1.20
12	1900 X	3000 X 3	2 11.40
13	900 X	850	0.77
14	670 X	<b>85</b> 0	0.57
15	1685 X	850	1,43
16.	2450 X	3230	7.91

186.63


TYPICAL FLOOR AREA = ADDITION AREA-DEDUCTION AREA

553.30-186.63


= 366.67 SQ.MT

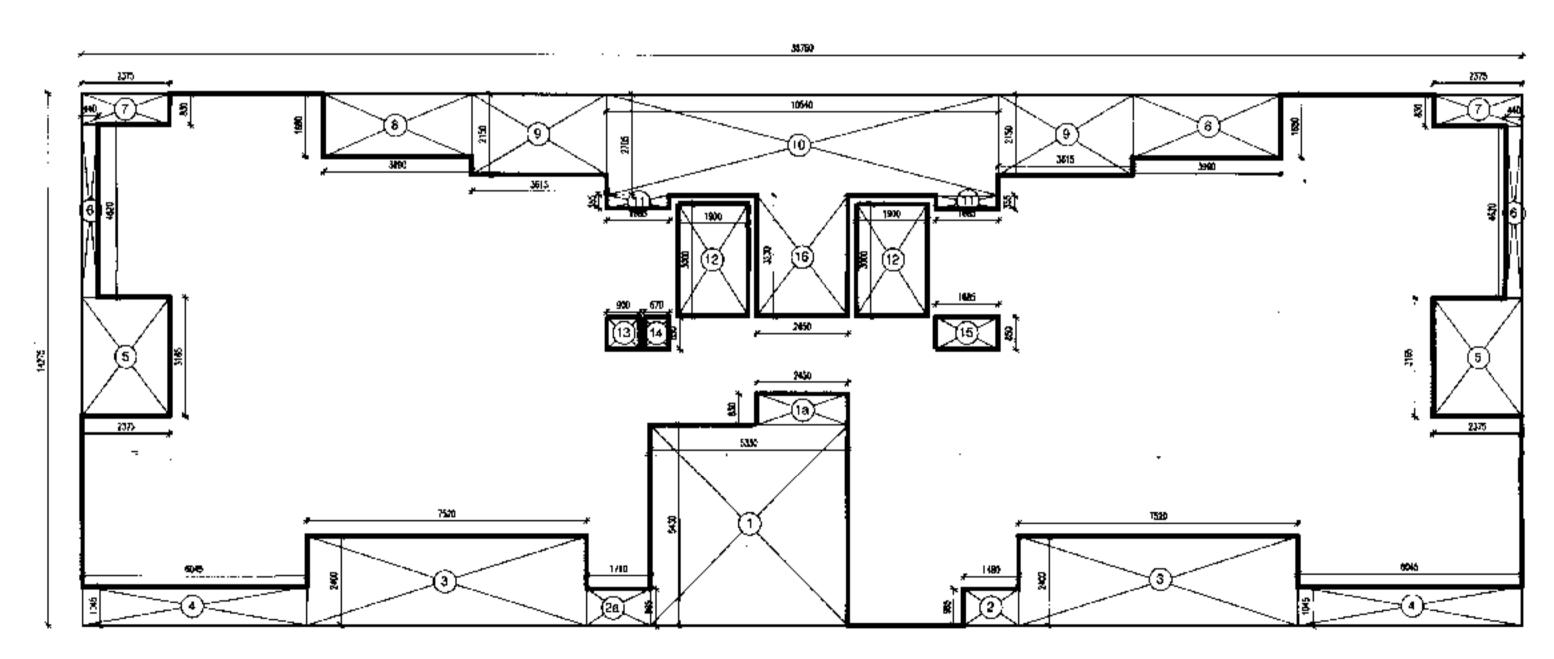

BLOCK DIAGRAM TOWER -2, TYPE-B (3rd FLOOR TO 23rd FLOOR) TYPICAL FLOOR PLAN +10650 TO 71650 MM LVL

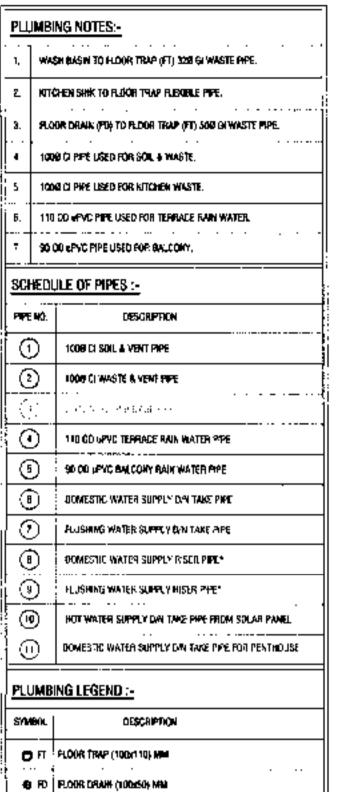

-508 GI WASTE PIPE 150mm THICK LEDGE WALL

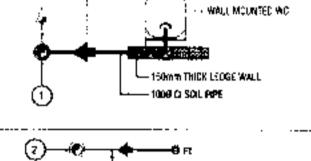


4 3 8 DE WASTE PIPE

	FIRE LEG	¥ND:-	
	Α	1506 M.S.FRE WET RUSER PPE	
	B	1500 M.S SPR NICLEA RISEN INPE	
	G	808 M.S SPRIMKLER ORAIN PIPE	
	пис	FIRE HOSE CABBNET	
ı		U AMERICAN	

49 BD BALCONY DRAIN (10050) WM

# ACMOBINE TYPE SPRIMALER 4 SEDE WALL TYPE SPRINKLER ----- SPRINKLER REEDER LINE

**EMPORTANT NOTES:** (300 x 800) with CUT OUT IN FAC. 1.1 1509 WET PISCH. 7.) 1500 SPHINKLER RISER 3) 808 ORAN PIPE 

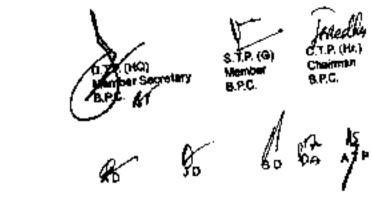

# OPENING SCHEDULE OF DOORS & WINDOWS

SR NO	SIZE		SILL	UNTEL	TYPE
1	<b>8</b> 80	Х		2400	ם
2	$\infty$	×	-	2400	C2
3	1050	X	-	2400	DB
4	2250	X	-	2400	DM1
<b>15</b>	2525	X		2400	DN2
6	1450	×	-	2400	DWB
7	2245	×	•	2400	DV4
. 8	1200	X	900	2400	W5
9	1200	×	900	2400	W6
10	450	X	900	<b>240</b> 0	W7
11	ecco	×	1200	2400	V1

- 1. DIMENSIONS ARE NOT TO BE SCALED.
  2. ALL DIMENSIONS ARE IN MM .
- 3.ALL ELECTRICAL INSTALLATIONS SHALL BE AS PER PROVISIONS OF NBC.
- 4. FIRE FIGHTING SAFETY PROVISIONS WILL BE AS PER RELEVANT NBC PROVISIONS.
- 5. BOUNDARY WALL AND GATE AS PER STANDARDS. 6. ALL WALLS ARE 230/115 MM THK, BRICK WALL. 7. RAIN WATER HARVESTING SYSTEM SHALL BE PROVIDED AS PER CENTRAL GROUND WATER AUTHORITY NORMS/HARYANA
- 8. ALL WINDOWS & VENTILATORS ARE OPENABLE. 9. ALL MECHANICALLY VENTILATED & ARTIFICIALLY LIT TOLLET PROVIDED WITH 24hr POWER BACKUP.


DEVELOPED BY:

# PROJECT:

PROPOSED BUILDING PLAN OF GROUP HOUSING FOR AREA MEASURING 11.875 + 8.294 = 20,169 ACRES(LICENCE NO. 250 OF 2007 DATED 02.11.2007 AND LICENCE NO. 50 OF 2012 DATED 17 / 5/ 2012 IN SECTOR 109, GURGAON MANESAR URBAN COMPLEX BEING DEVELOPED BY RAJ KIRAN PVT. LTD. AND OTHERS IN COLLABORATION WITH CHINTELS INDIA LTD.

70WER -2 ,TYPE -B & AREA DIAGRAM (F + 10650 TO 71650	r	AN
DEALT BY Kaushik Modi	SCALE 1:100	DRQ. NO.
CHECKED BY Manish Kr. Gupta	DATE	2-B-2.4

THROUGH: AUTHORISED SIGNATURATION OF THE STATE OF THE STA FOR CHINTELS INDIALIMITED & OTHERS OWNER'S SIGN ARCHITECT'S SIGN.

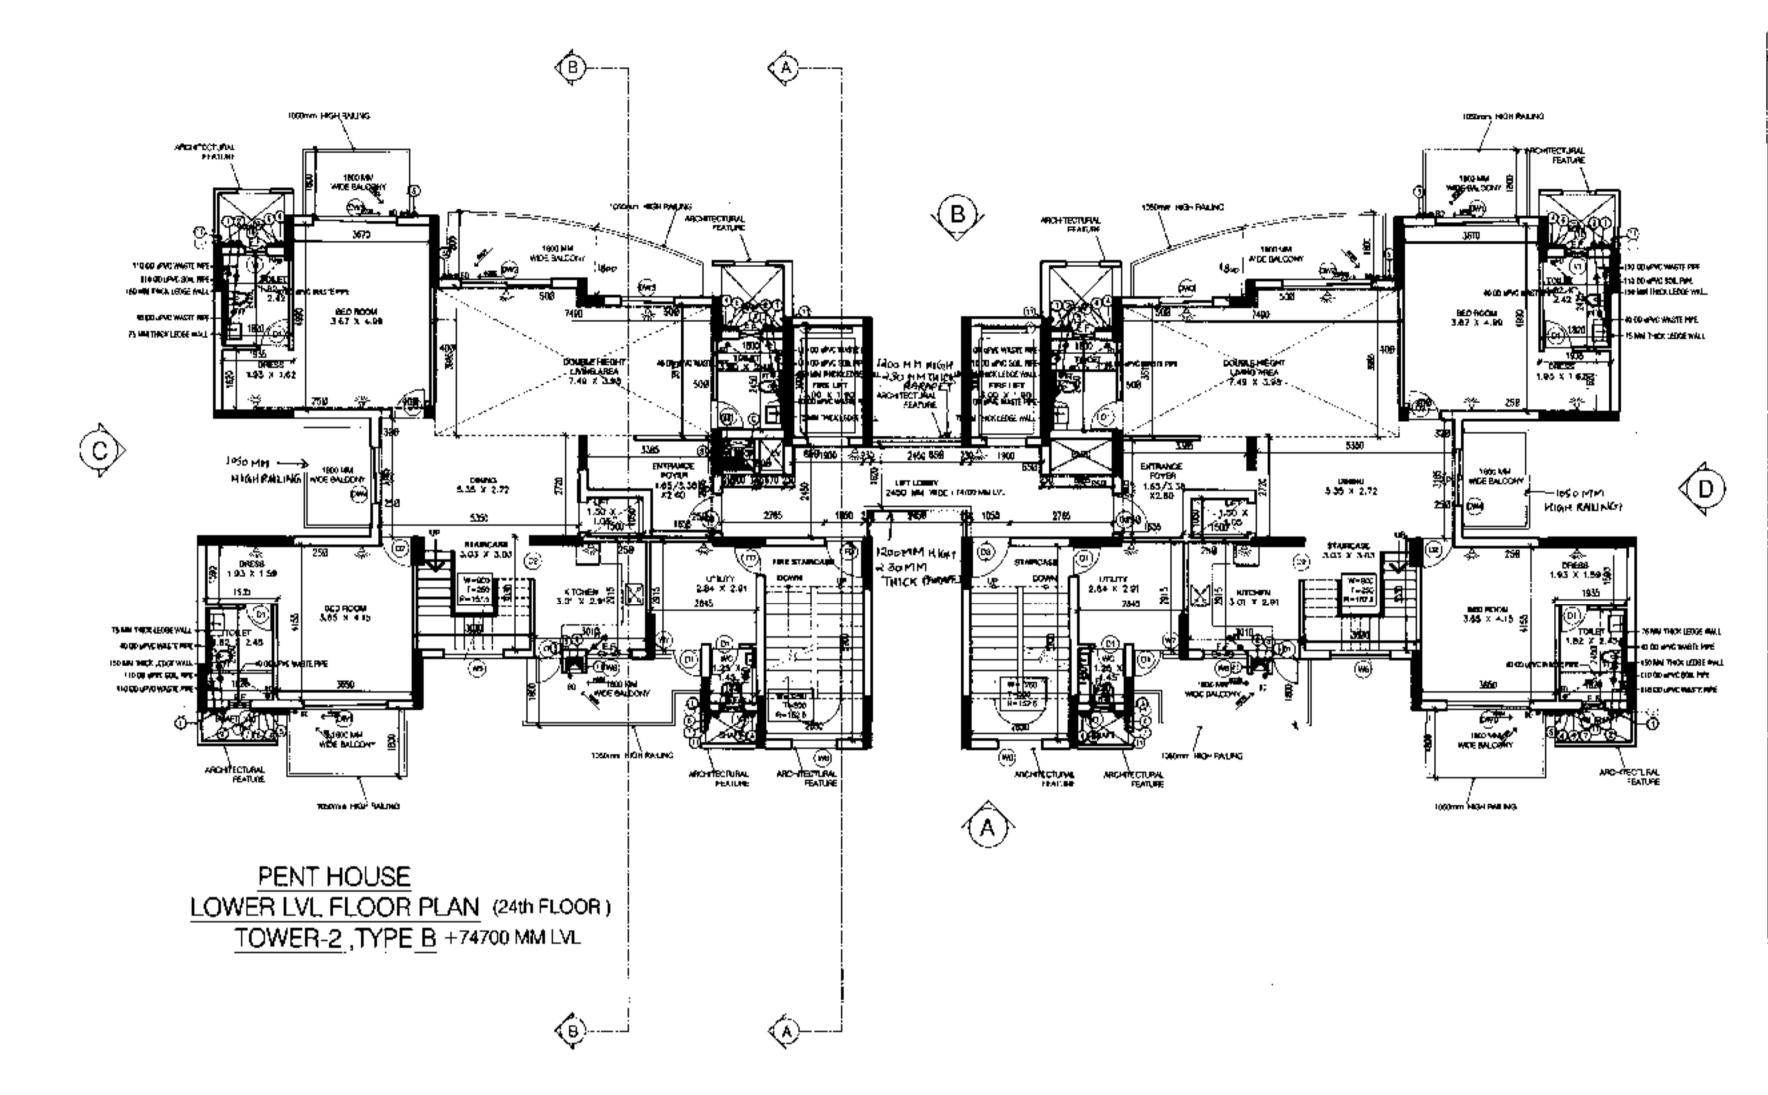


LOWER LEVEL PENT HOUSE FLOOR AREA

AREA CALCULATION  $AREA = (X \times Y)$ 


38760 x 14275 553.30

ADDITION AREA	A =	553.30	SQ.MT
<del></del>			344.WH
UEDL	ICTION DET	AIL	<del></del>
1	5330 X	5430	28.94
1ə	2450 X	830	2.03
2	1480 X	985	1.46
2a	1710 X	985	1.68
3	7520 X	2400 X	2 36.10
4	6045 X	1045 X	2 12 63
5	4685 X	3165 X	2 29.66
6	440 X	4620 X	2 4.07
ל'	2375 X	830 X	2 3.94
8	3990 X	1680 X	2 13 41
9	3615 X	2150 X	2 15.54
10,	10540 X	2705	28.51
11	1685 X	355 X	2 1.20
12	1900 X	3000 X	2 11.40
13	900 X	850	0.77
14	670 X	850	0.57
15	1685 X	850	1.43
16	2450 X	3230	7.91
TOTA	TT.		201.25

LOWER LEVEL PENT HOUSE FLOOR AREA = ADDITION AREA-DEDUCTION AREA 553.30-201.25 = **352.05 SQ.MT** 

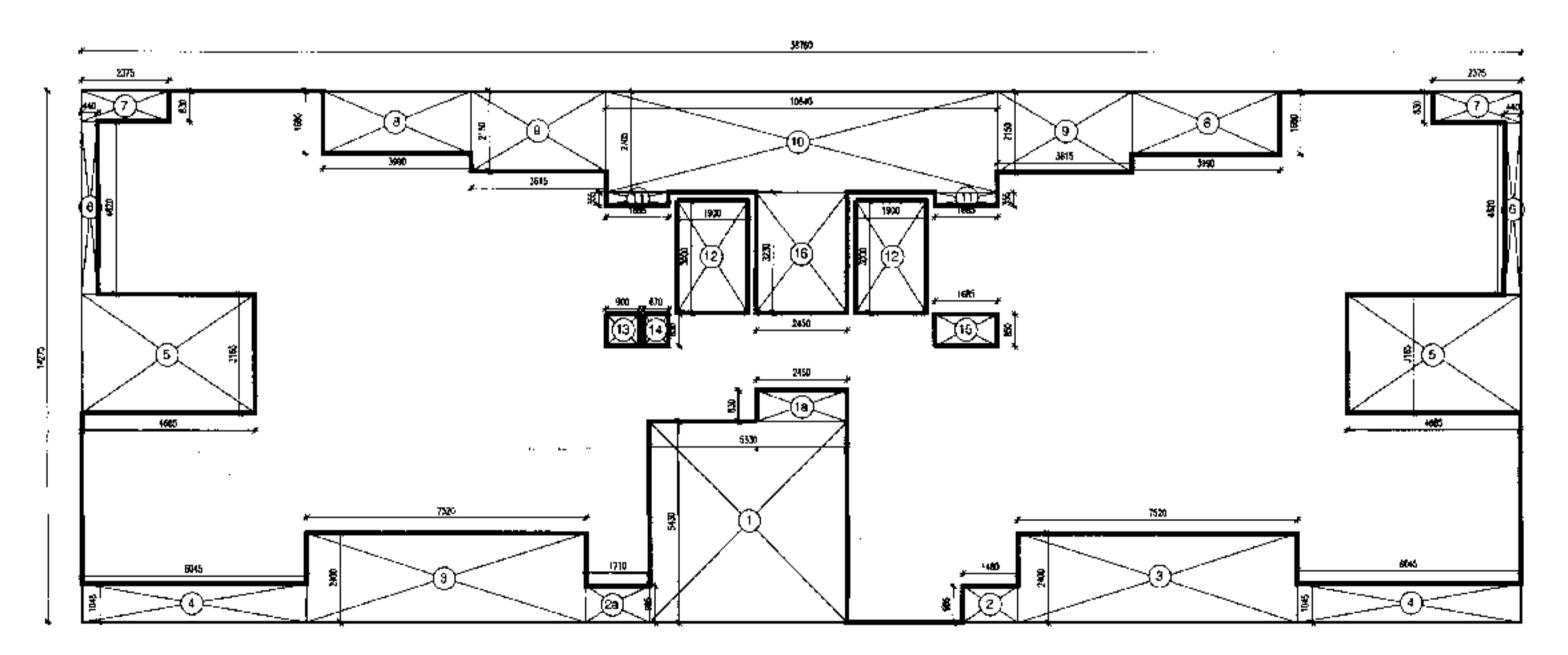

BLOCK DIAGRAM TOWER -2, TYPE-B PENT HOUSE (24th FLOOR) LOWER LEVEL FLOOR PLAN +74700 MM LVL

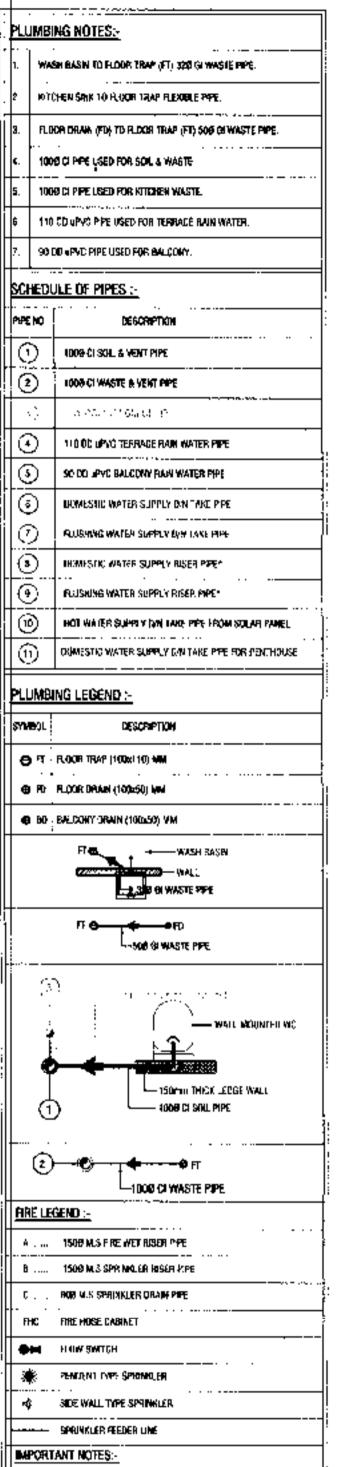

(305 x 650)mm CST QUT (N AHC.

1) 1508 WET RISER.

3) 909 PRAN 29E.

2 ) 1**500 sprim**kler alser |

OPENING SCHEDULE OF DOORS & WINDOWS

SR NO	SIZE.		SILL	뎔	TYPE
1	<b>æ</b>	×	_	2400	Ď1
2	900	X	-	2400	D2
	1050	х	_	2400	<b>D8</b>
4	250	×	ı	2400	DW1
5	2525	×	-	2400	<b>□</b> \$2:
6	1450	×	-	2400	28
7	2265	×	•	2400	<u>*</u>
Ø	1800	×	900	2400	W5
g	1200	X	900	2400	W6
10	450	x	900	2400	W7
11	നോ	Х	1200	2400	VI

- 1. DIMENSIONS ARE NOT TO BE SCALED.
- 3.ALL ELECTRICAL INSTALLATIONS SHALL BE AS PER
- PROVISIONS OF NBC. 4. FIRE FIGHTING SAFETY PROVISIONS WILL BE AS PER
- RELEVANT NBC PROVISIONS.
  5. BOUNDARY WALL AND GATE AS PER STANDARDS.
- 6. ALL WALLS ARE 230/115 MM THK. BRICK WALL. 7. RAIN WATER HARVESTING SYSTEM SHALL BE PROVIDED AS PER CENTRAL GROUND WATER AUTHORITY NORMS/HARYANA
- 8. ALL WINDOWS & VENTILATORS ARE OPENABLE.
- 9. ALL MECHANICALLY VENTILATED & ARTIFICIALLY LIT TOILET PROVIDED WITH 24hr POWER BACKUP.

DEVELOPED BY:

# PROJECT:


PROPOSED BUILDING PLAN OF GROUP HOUSING FOR AREA MEASURING 11.875 + 8.294 = 20.169 ACRES(LICENCE NO. 250 OF 2007 DATED 02.11.2007 AND LICENCE NO. 50 OF 2012 DATED 17 / 5/ 2012 IN SECTOR 109, GURGAON MANESAR URBAN COMPLEX BEING DEVELOPED BY RAJ KIRAN PVT. LTD. AND OTHERS IN COLLABORATION WITH CHINTELS INDIA LTD.

DRAWING TITLE : TOWER -2 , TYPE -B , LOWER LVL PENT HOUSE PLAN & AREA DIAGRAM (PHASE-1) +74700 MM LVL

DRG. NO. Kaushik Modi 1:100 2-B-2.5 CHECKED BY Manish Kr. Gupta

THROUGH: AUTHORISED SIGNATORY of Services and in the comments

OWNER'S SIGN ARCHITECT'S SIGN.

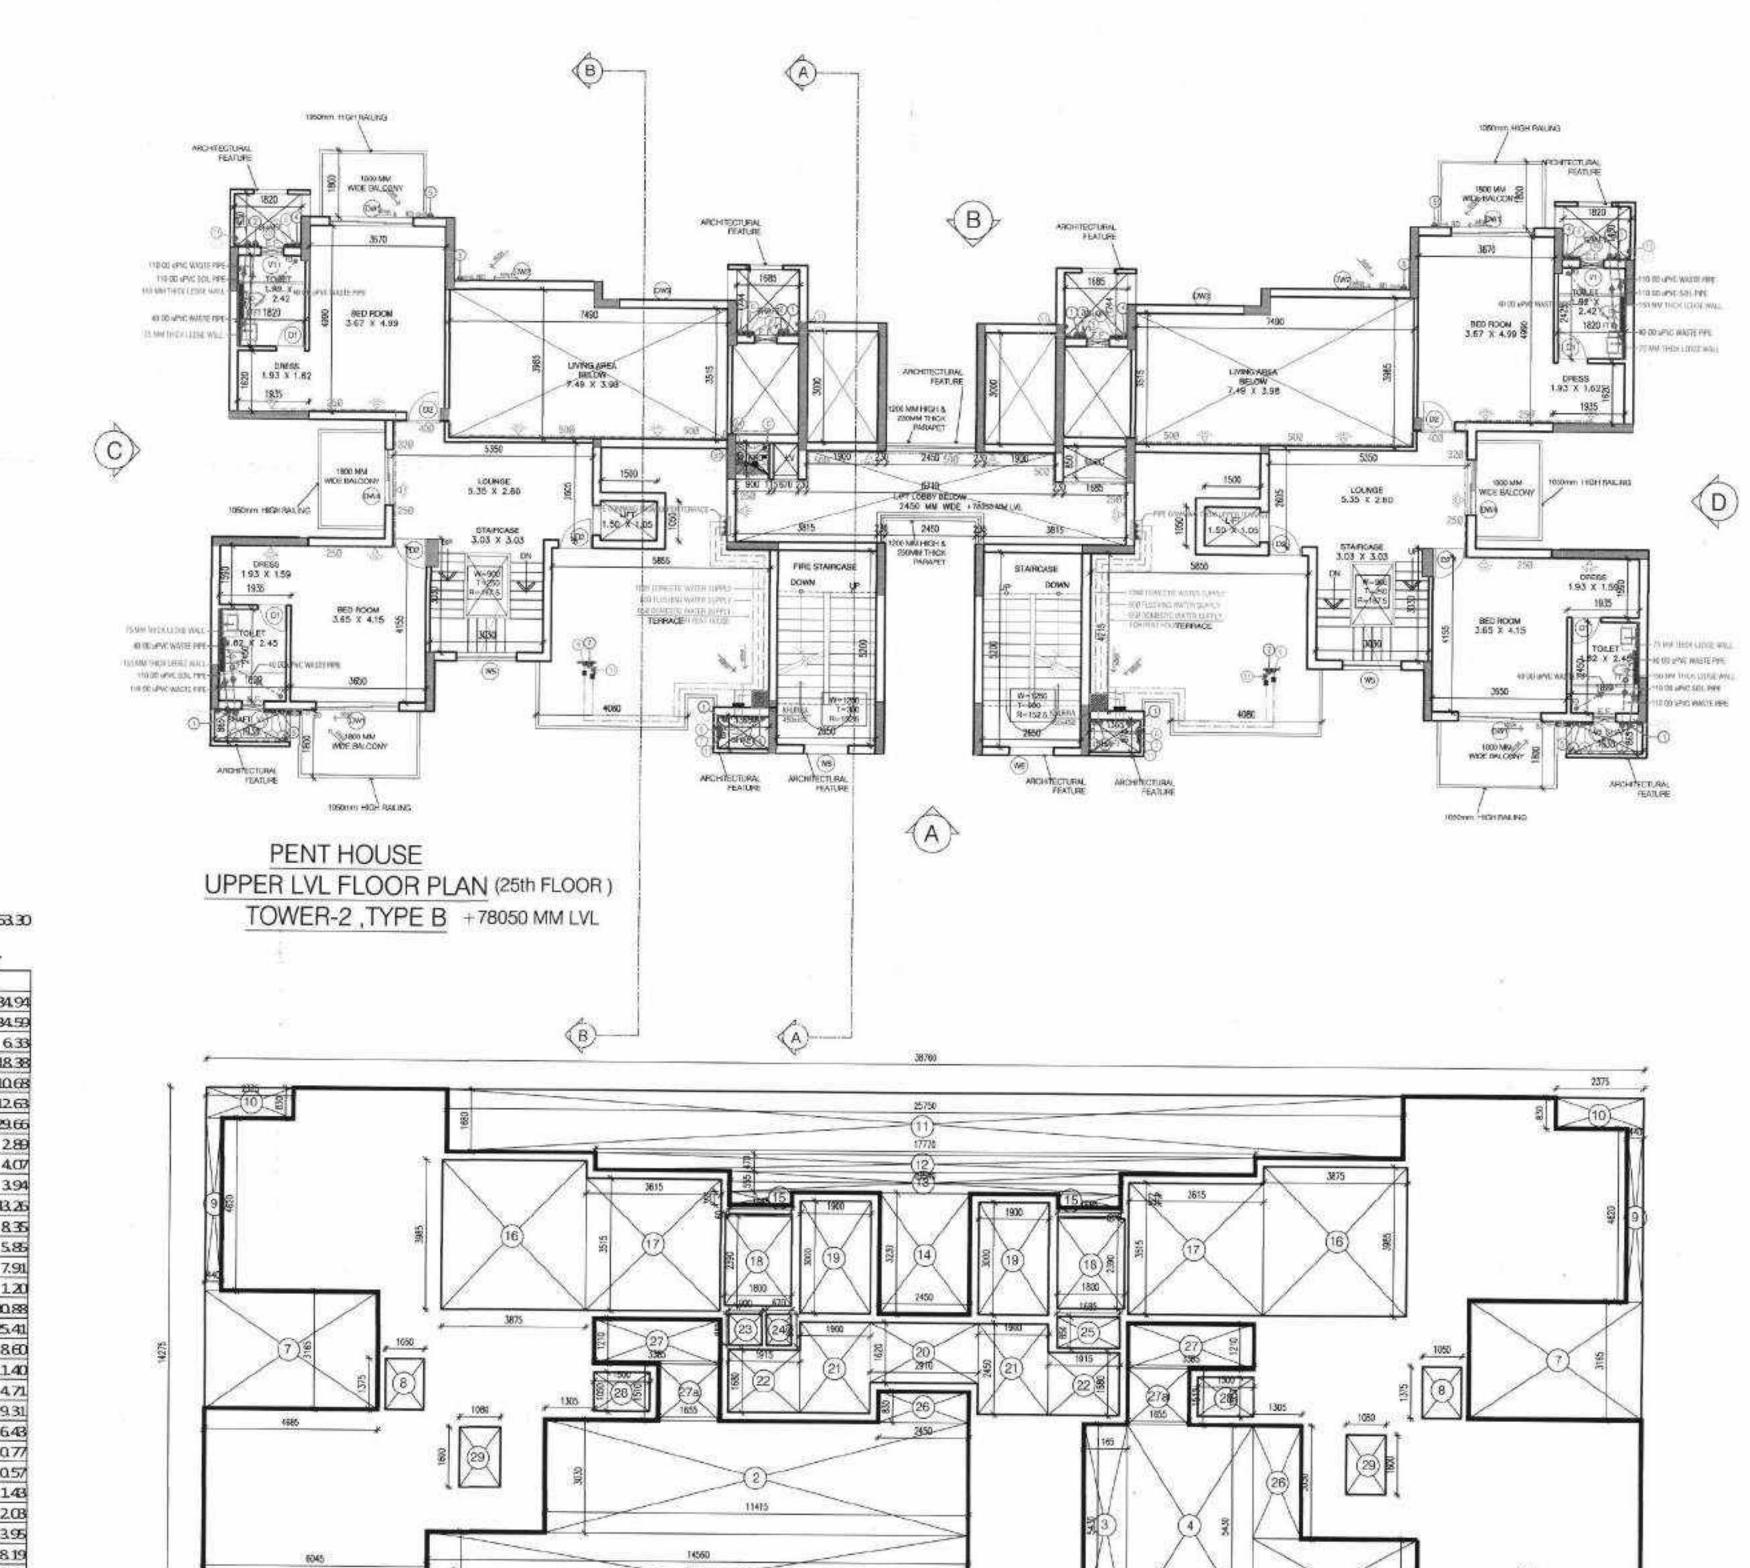

KITCHEN SINK TO FLOOR TRAP REDOBLE PIPE FLOOR DRAIN (FD) TO FLOOR TRAF (FT) 500 (I WASTE PIPE. 1000 OF PIPE USED FOR SOIL & WASTE. 1900 CLPPE USED FOR KITCHEN WASTE. THI GO IPNO PIPELISED FOR TERRACE RAIN WATER. 90 OO UPVC PIPE IISEB FOR BALCONY. SCHEDULE OF PIPES :-DESCRIPTION 1008 OLSOIL & VENT PIRE 1000 OF WASTE'S VENT PIPE (4) \$10.00 IPVE TERRAGE RAIN WATER PIPE 10 OD UPING MALCONY RAIN WATER PIPE DOMESTIC WATER SLAVEY DAY TAKE PRE-FLUENING WATER SUPPLY DW TAKE FITT DUNKSHIE WATER SUPPLY FROM PING\* -PLUSHING WATER SEPREY BASER PIPE-HOT WATER SUPPLY DAY TAKE PIPE FROM SIN AR PAYEL DOMESTIC WATER SUPPLY DAY THEE PER FOR PENTHOUSE PLUMBING LEGEND :-O FT FLOOR TRAP (100x110) MW (D) FU FLOOR-DRAIN (100-60) MM Φ BD BALCONY BRAIN (100±50) MM FI O OF - 500 GI WASTE PAPE - TROWN THICK (EDGE WIN) - 1000 C) SOIL PIPE 2 - P - OF -1008 CHWASTE PIPE FIRE LEGEND :-II \_\_\_\_\_ 1TARE M.S SPRINKLER RISSER PIPE THIS FIRE HOSE CABBET **Opd** TLOW SWITCH PENCENT TYPE SPENKLER FOR WALL TYPE SPRINGER ---- SPERVICER FEEDER LINE IMPORTANT NOTES:-(200 x 600 mm CUT OUT IN FRIC. 1.) 1500 WET RIGER 2.) 1508 SPRINGLEB WISER.

3.) BOD DRAIN PPE

PLUMBING NOTES:-

WASH BASIN TO FLOOR TRAP (FT) 320 SI WASTE PIPE

Member Secretary Member B.P.C. B.P.G. S.D. PA ATS

# OPENING SCHEDULE OF DOORS & WINDOWS

SR. NO	SIZE		SILL	UNIEL	TYPE
1	800	X	~	2400	D1
2	900	×	4	2400	D2
3	1050	×	-	2400	D3
4	2250	X	1	2400	DW
5	2525	×	3	2400	DV2
6	1450	X	9	2400	DWB
7	2265	X		2400	DW4
8	1800	×	900	2400	WБ
9	1200	X	900	2400	V/5
10	450	Х	900	2400	W7
11	600	X	1200	2400	V1

### NOTES

DIMENSIONS ARE NOT TO BE SCALED.
 ALL DIMENSIONS ARE IN MM .

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4. FIRE FIGHTING SAFETY PROVISIONS WILL BE AS PER

RELEVANT NBC PROVISIONS.

5. BOUNDARY WALL AND GATE AS PER STANDARDS.

 ALL WALLS ARE 230/115 MM THK. BRICK WALL.
 RAIN WATER HARVESTING SYSTEM SHALL BE PROVIDED AS PER CENTRAL GROUND WATER AUTHORITY NORMS/HARYANA GOVT.


8. ALL WINDOWS & VENTILATORS ARE OPENABLE.
9. ALL MECHANICALLY VENTILATED & ARTIFICIALLY LIT TOILET PROVIDED WITH 24hr POWER BACKUP.

DEVELOPED BY:

# PROJECT:

PROPOSED BUILDING PLAN OF GROUP HOUSING FOR AREA MEASURING 11.875 + 8.294 = 20.169 ACRES(LICENCE NO. 250 OF 2007 DATED 02.11.2007 AND LICENCE NO. 50 OF 2012 DATED 17 / 5/ 2012 IN SECTOR 109, GURGAON MANESAR URBAN COMPLEX BEING DEVELOPED BY RAJ KIRAN PVT. LTD. AND OTHERS IN COLLABORATION WITH CHINTELS INDIA LTD.

TOWER -2 ,TYPE -B HOUSE PLAN & ARE +78050 MM LVL	, UPPER LVL PENT A DIAGRAM (PHASE-	.1)
DEALT BY Kaushik Modi	SCALE 1:100	DRG. NO.
CHECKED BY Manish Kr. Gupta	DATE	2-B-2.6

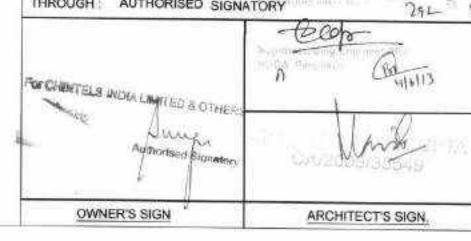

ADDITIONAREA-DEDUCTIONAREA

553.30-349.99 = 203.31 SQ.MF

TOTAL

UPPERLEVEL PENT HOUSE PLOOR AREA

AREA = (XXY)

ADDITION AREA = 553.30

DEDUCTION DETAIL

3385 X 5430

4450 X 2400 6045 X 1045 X 2

4685 X 3165 X 2

1050 X 1375 X 2

440 X 4620 X 2

2375 X 830 X 2

3875 X 3985 X 2 3635 X 3615 X 2

1800 X 2390 X 2

1900 X 3000 X 2

2910 X 1620

1900 X 2450 X

1915 X 1680 X

2450 X 830

1305 X 3080

1655 X 1510 X :

1050 X 1500 X 2

1090 X 1600 X 2

3385 X 1210 X 2

900

670

850

349.99

470

555

355 X

3230

25750 X 1680

1777OX

10540 X

2450 X

1695 X


850 X

850 X

1685 X

AREA CALCLLATION

BLOCK DIAGRAM TOWER -2 , TYPE-B
PENT HOUSE (25th FLOOR)
UPPER LEVEL FLOOR PLAN +78050 MM LVL

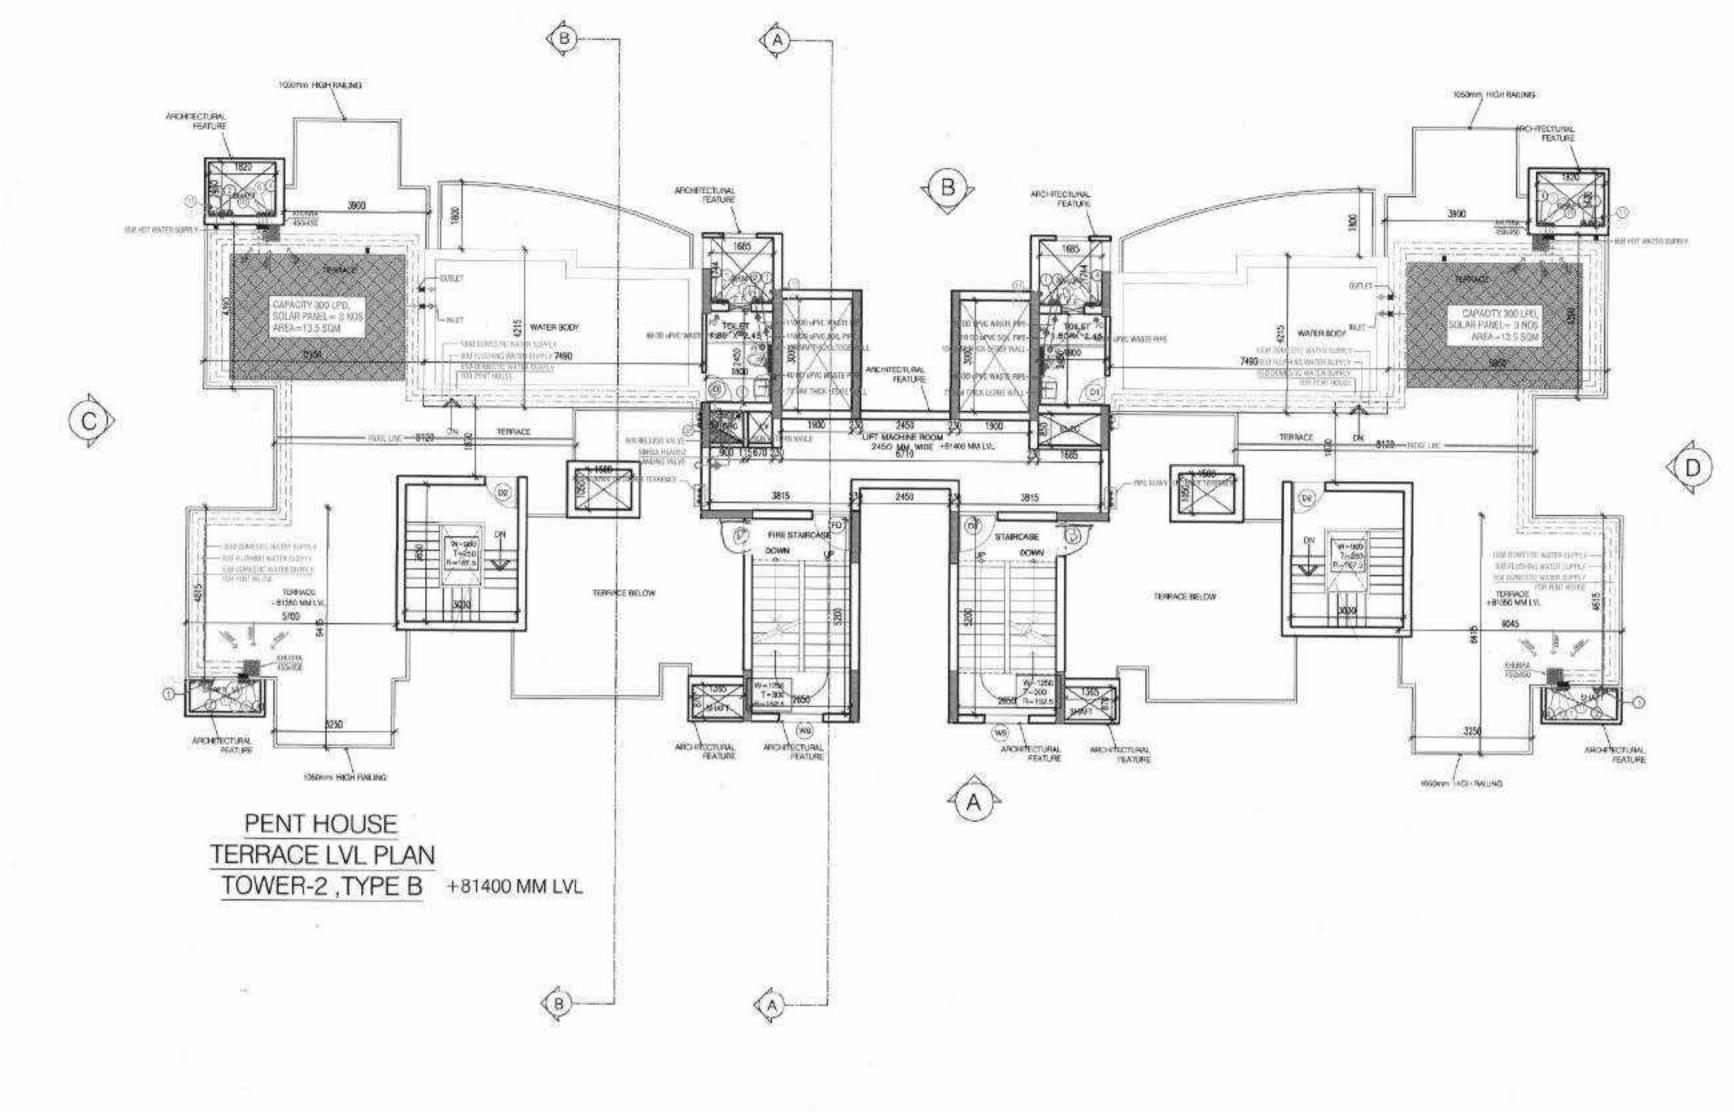

TERRACELEVEL PENT HOUSE AREA


AREA CALCULATION AREA = (X x Y)

32.01

ADDITION AR	EA =	32.01	SQ.MT
DEI	DUCTION DET	AIL	
1	6710 X	2910	19.53
то	TAL		19.53

11000 x 2910


TERRACE LEVEL PENT HOUSE AREA =
ADDITION AREA-DEDUCTION AREA
32.01-19.53 = 12.48 SQ.MT

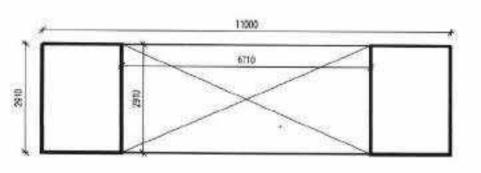

TO DESCRIPTION OF THE RESERVE OF THE

BLOCK DIAGRAM TOWER -2, TYPE-B
PENT HOUSE
TERRACE LEVEL PLAN +81400 MM LVL



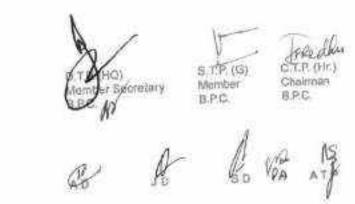

# OPENING SCHEDULE OF DOORS & WINDOWS

SR NO	SIZE		SILL	UNTEL	TYPE
1	800	X		2400	Di
2	900	X		2400	D2
3	1050	×	-	2400	D8
4	2250	X	-	2400	DWI
5	2525	×	12/1	2400	DV2
6	1450	X	130	2400	DVB
7	2265	X	-	2400	DAV4
8	1800	×	900	2400	W5
9	1200	X	900	2400	W6
10	450	X	900	2400	V/7
11	600	X	1200	2400	VI

### NOTES

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- FIRE FIGHTING SAFETY PROVISIONS WILL BE AS PER RELEVANT NBC PROVISIONS.
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   ALL WALLS ARE 230/115 MM THK. BRICK WALL.
- RAIN WATER HARVESTING SYSTEM SHALL BE PROVIDED AS PER CENTRAL GROUND WATER AUTHORITY NORMS/HARYANA GOVT.
- 8. ALL WINDOWS & VENTILATORS ARE OPENABLE.
  9. ALL MECHANICALLY VENTILATED & ARTIFICIALLY LIT TOILET PROVIDED WITH 24hr POWER BACKUP.

DEVELOPED BY:

# PROJECT:

PROPOSED BUILDING PLAN OF GROUP HOUSING FOR AREA MEASURING 11.875 + 8.294 = 20.169 ACRES(LICENCE NO. 250 OF 2007 DATED 02.11.2007 AND LICENCE NO. 50 OF 2012 DATED 17 / 5/ 2012 IN SECTOR 109,GURGAON MANESAR URBAN COMPLEX BEING DEVELOPED BY RAJ KIRAN PVT. LTD. AND OTHERS IN COLLABORATION WITH CHINTELS INDIA LTD.

TOWER -2 ,TYPE -B , TERRACE LVL PENT HOUSE PLAN & AREA DIAGRAM (PHASE-1) +81400 MM LVL


DEALT BY SCALE DRG: NO.

Kaushik Modi 1:100

CHECKED BY DATE 2-B-2.7

Manish Kr. Gupta Checked and fourth or for Problet Health

THROUGH: AUTHORISED SIGNATORY warding letter for Data and Tolerance of the State of Control of

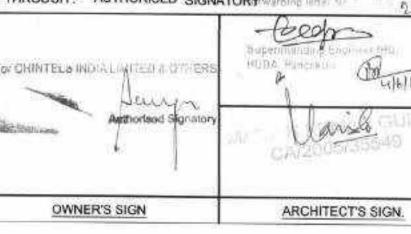


PRODUCED BY AN AUTODESK EDUCATIONAL PRODUCT

PRODUCED BY AN AUTODESK EDUCATIONAL PRODUCT

RAM TOW


2.) 1500 SPRINKLER RISER. 3.) BOS DRAIN PIPE.

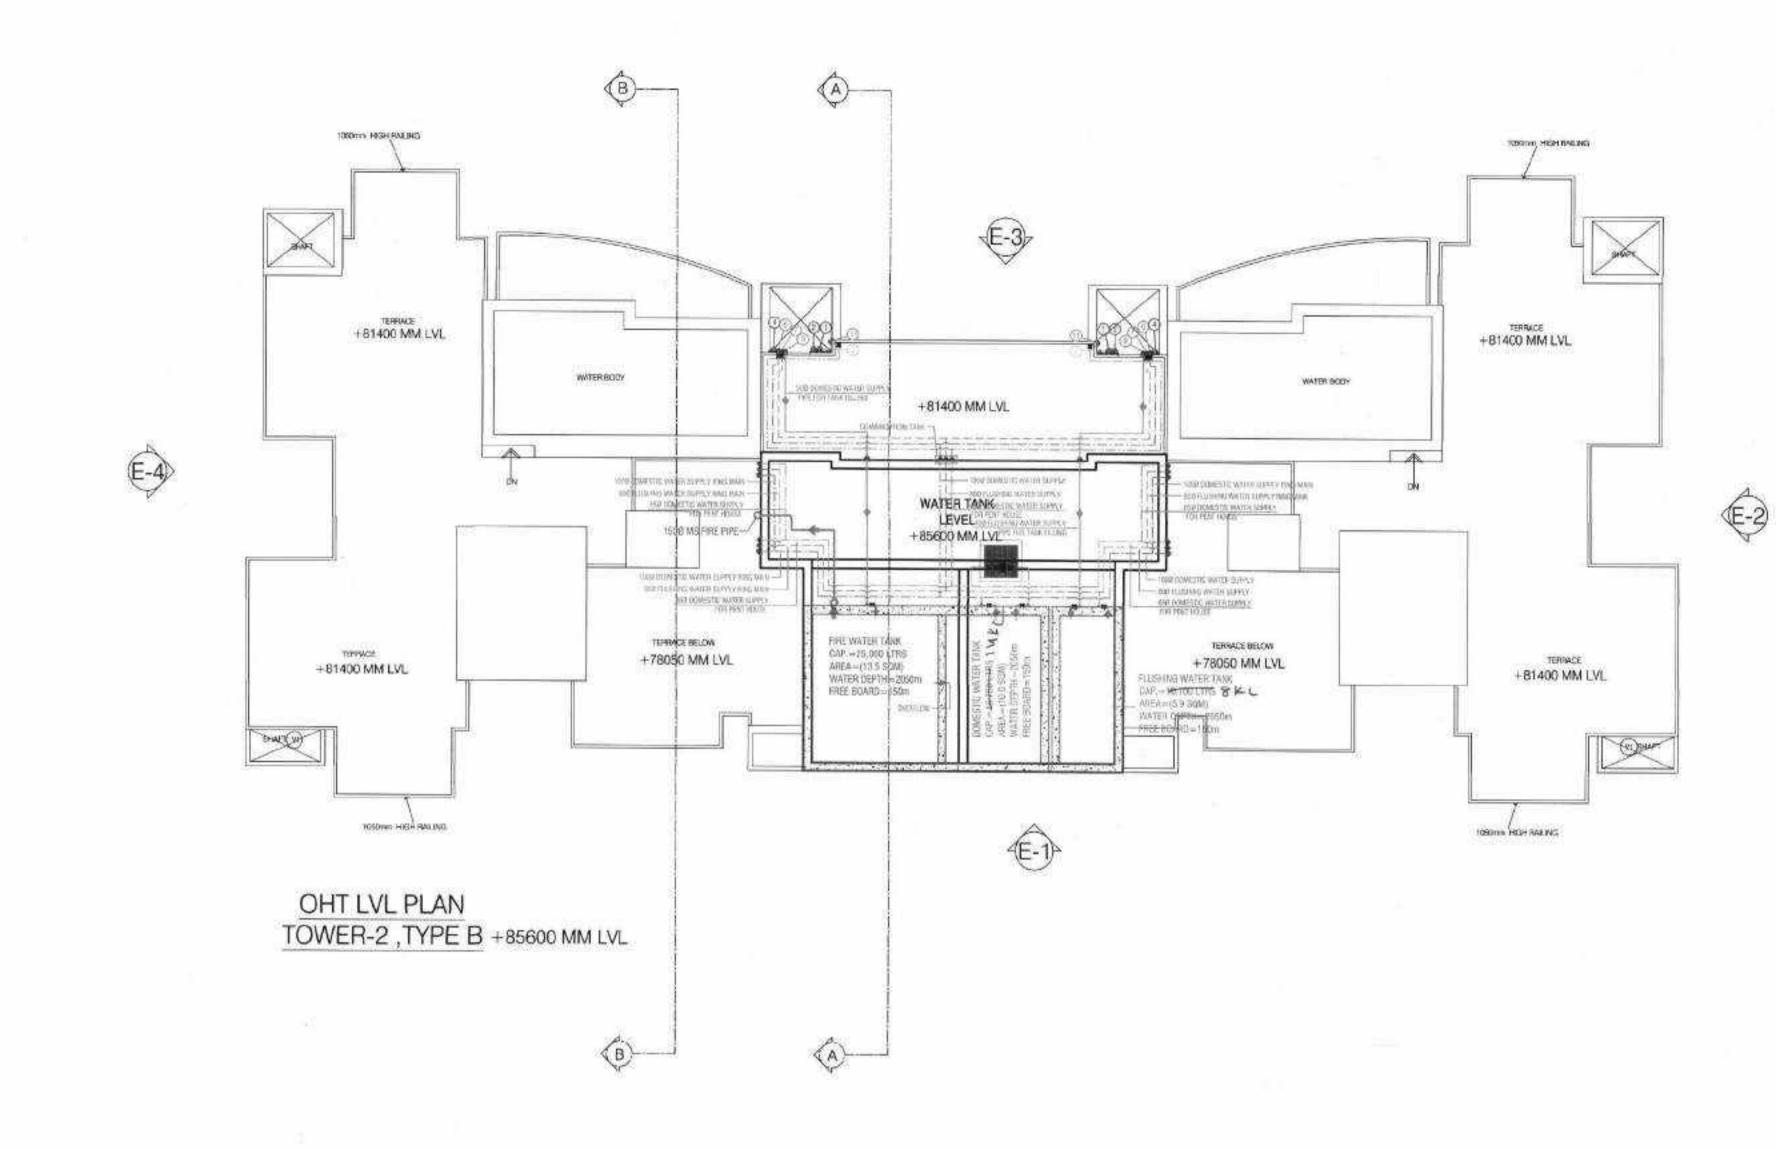

# WATER TANK LEVEL AREA


TOTAL

DE	DUCTION DETA	AIL.	
1	8670 X	5430	47.08
2	6710 X	2910	19.53
3	2145 X	3105 X 2	13.32

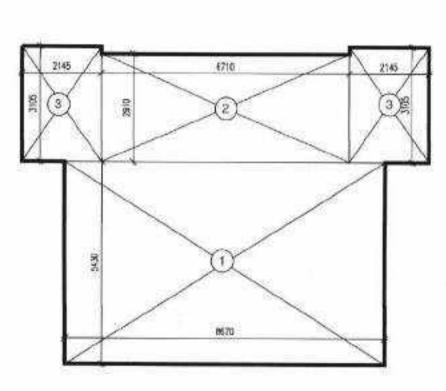


BLOCK DIAGRAM TOWER -2, TYPE-B OHT LEVEL PLAN +85600 MM LVL

79.92

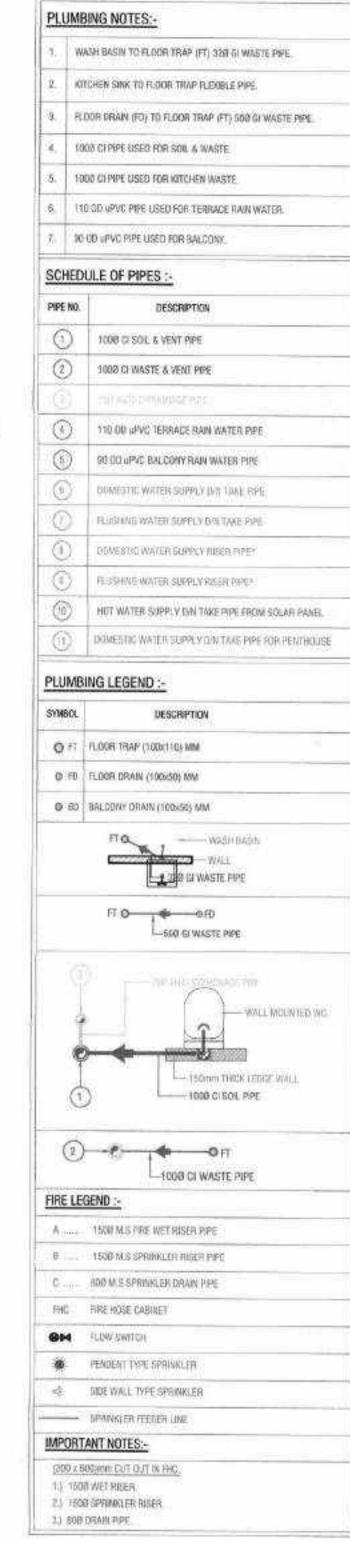

Checked and found oil for Public Health (Internal) Services only subject to distribute in

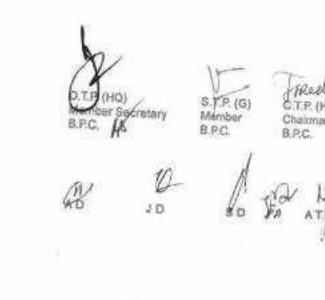

# OPENING SCHEDULE OF DOORS & WINDOWS

SR NO	SIZE	1.	SILL	UNIEL	TYPE
1	800	X	2	2400	D1
2	900	X	(23)	2400	D2
3	1050	X	(4)	2400	D3
4	2250	X	171	2400	DWI
5	2525	X	-	2400	DV/2
6	1450	X	2	2400	DVB
7	2265	Х	525	2400	DW4
8	1800	X	900	2400	W5
9	1200	X	900	2400	W6
10	450	X	900	2400	W7
11	600	X	1200	2400	VI.

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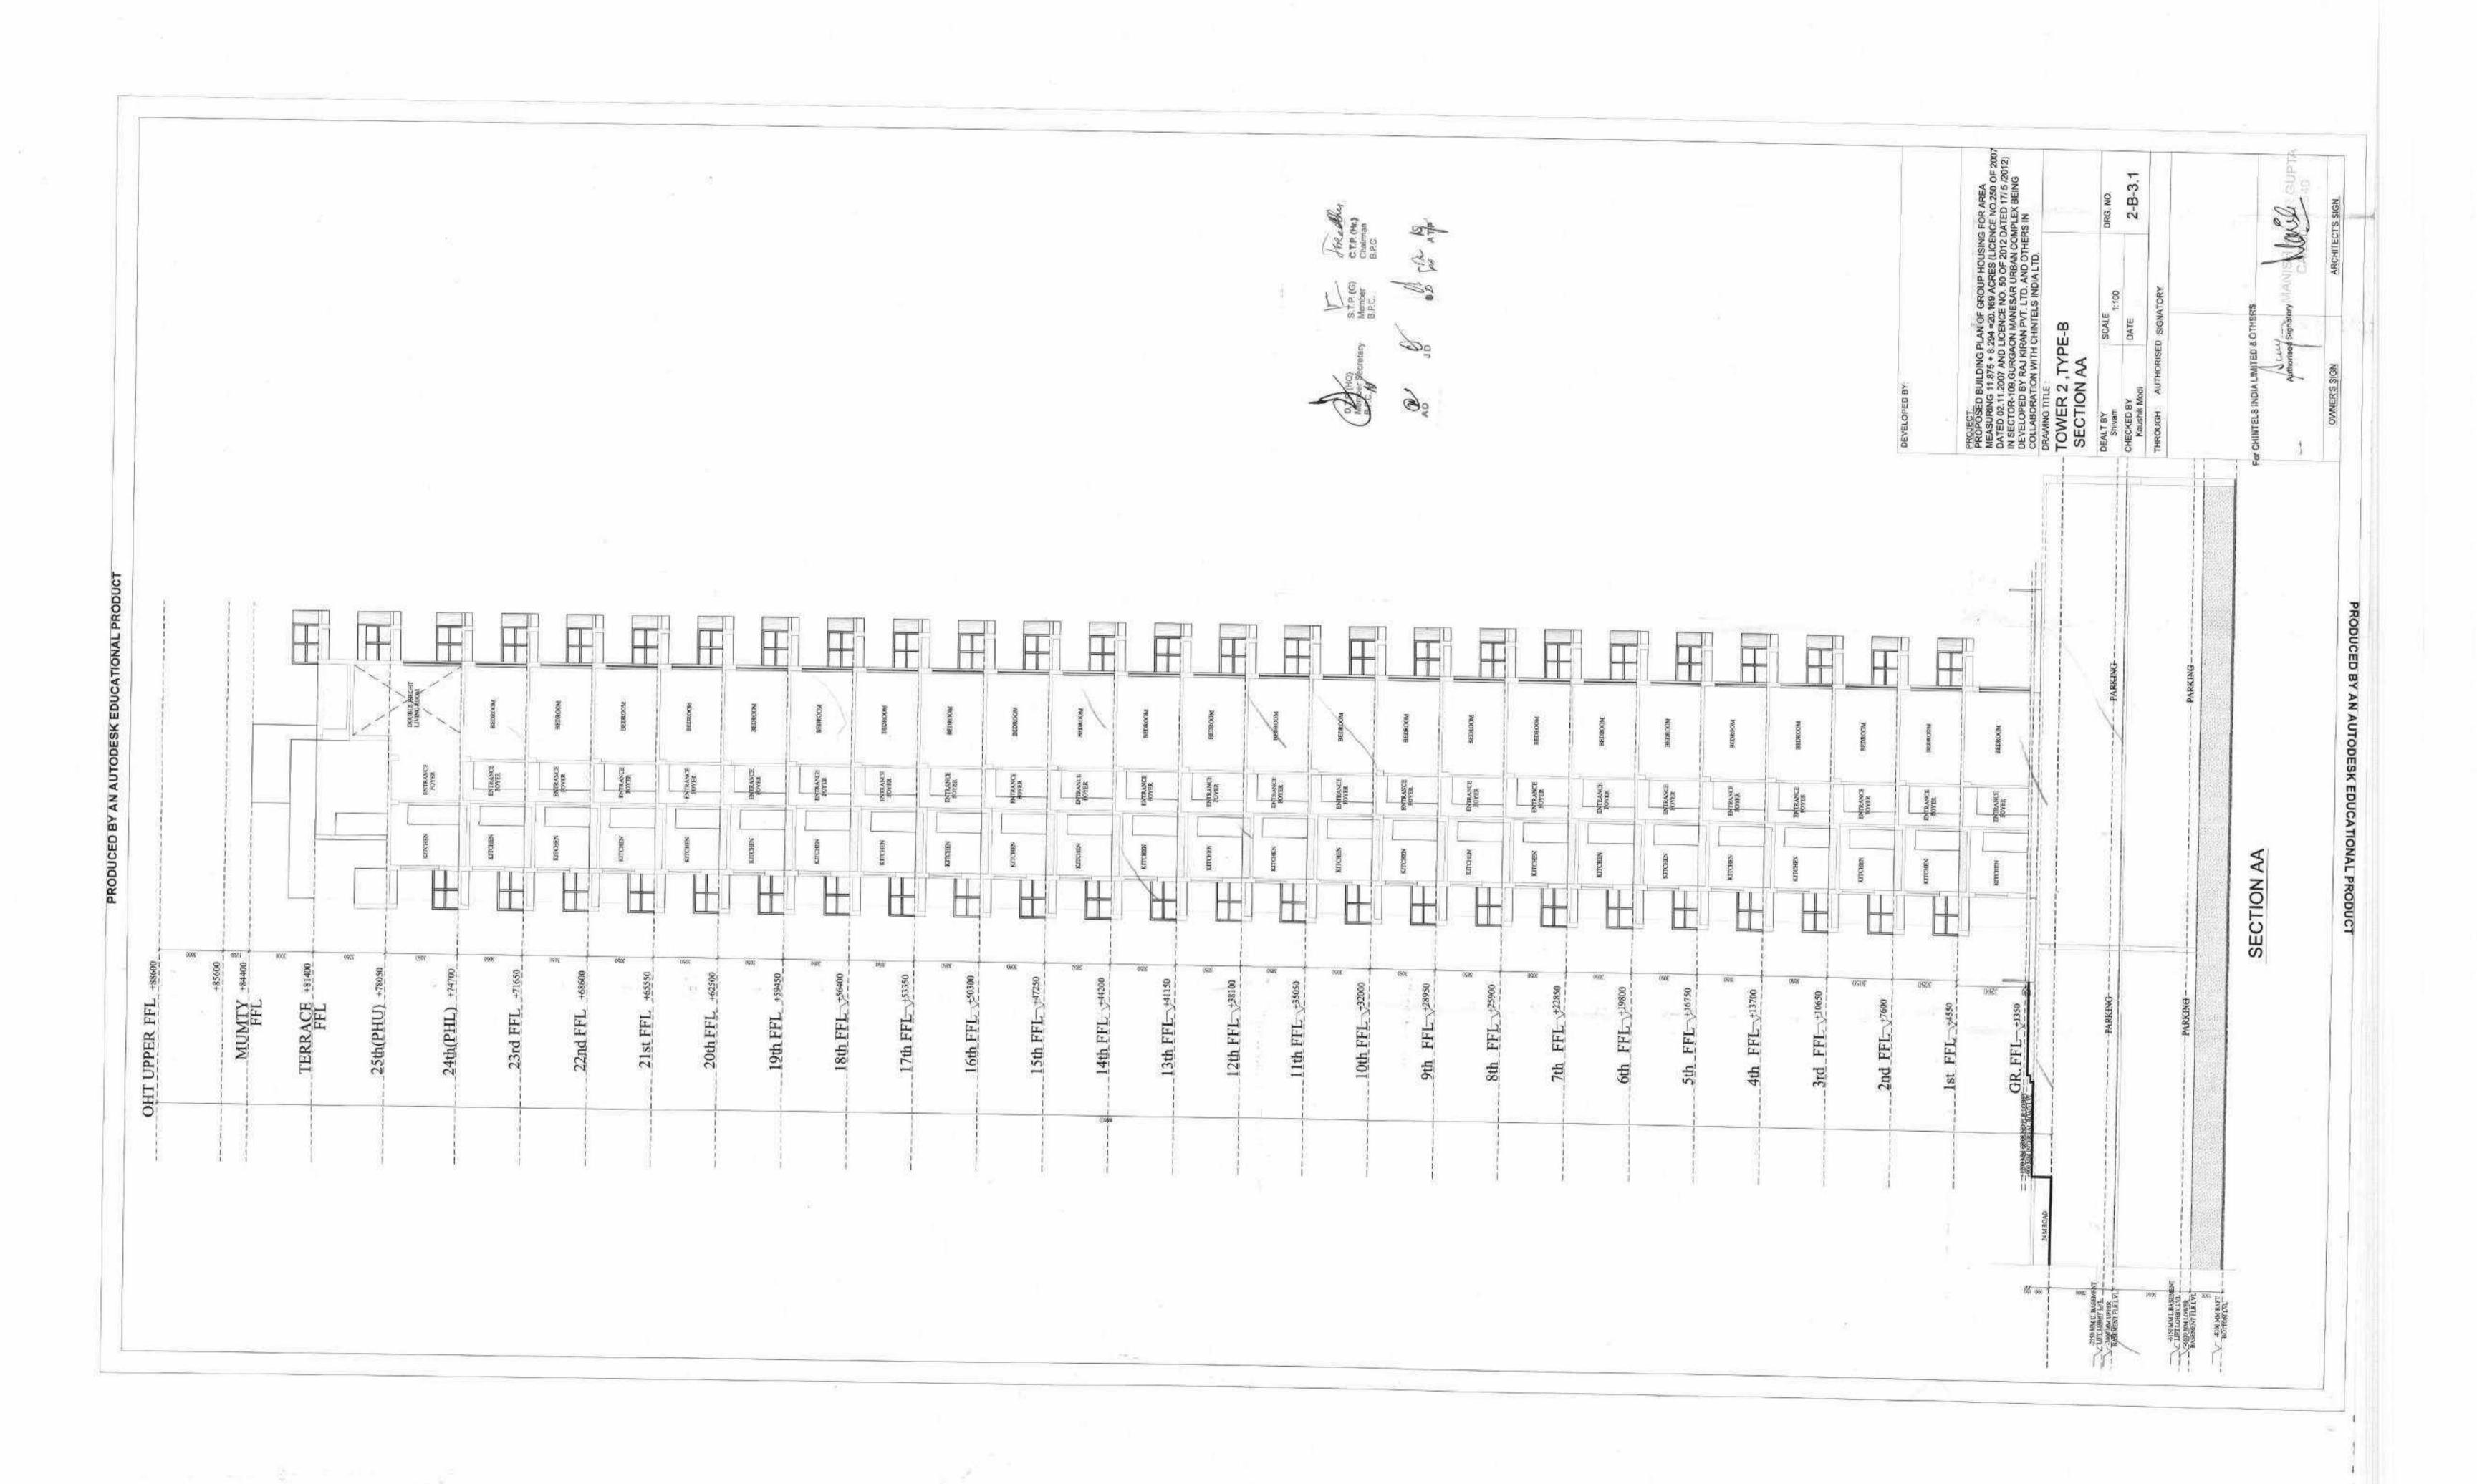
DEVELOPED BY:

### PROJECT:


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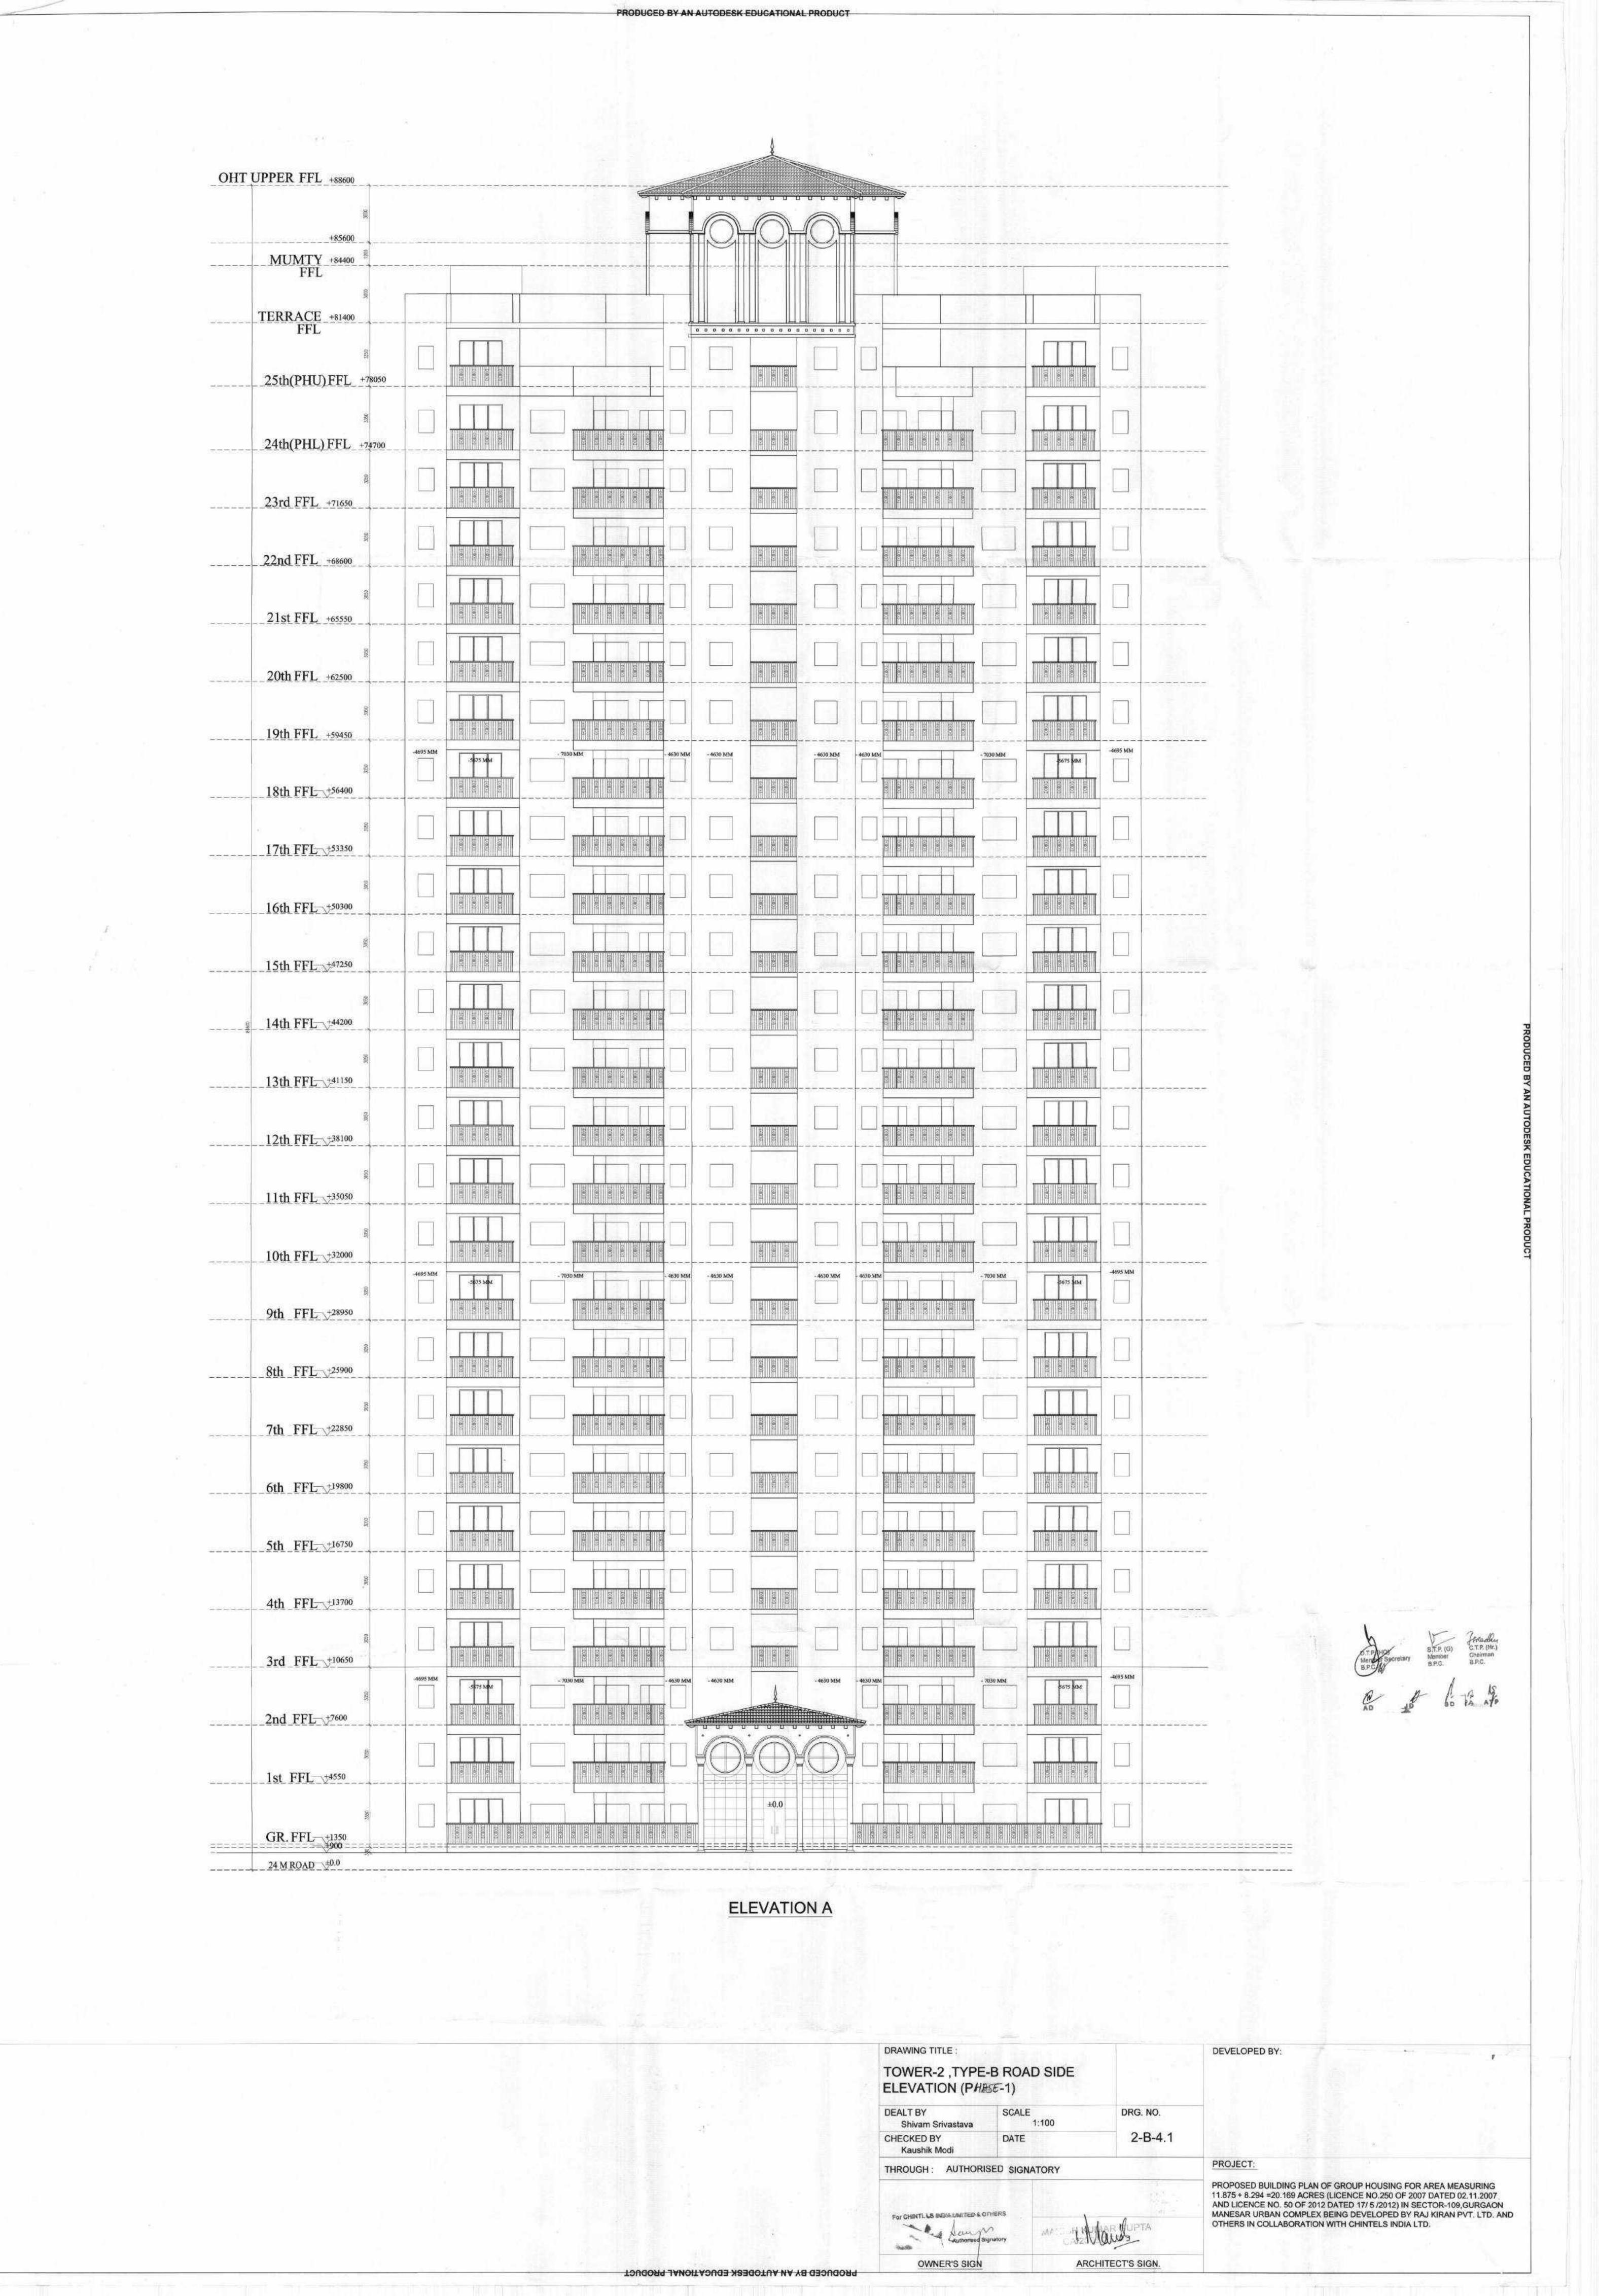
EALT BY Kaushik Modi	SCALE 1:100	DRG. NO.
CHECKED BY Manish Kr. Gupta	DATE	2-B-2.8
THROUGH: AUTHOR	ISED SIGNATORY	

OWNER'S SIGN ARCHITECT'S SIGN.



Q



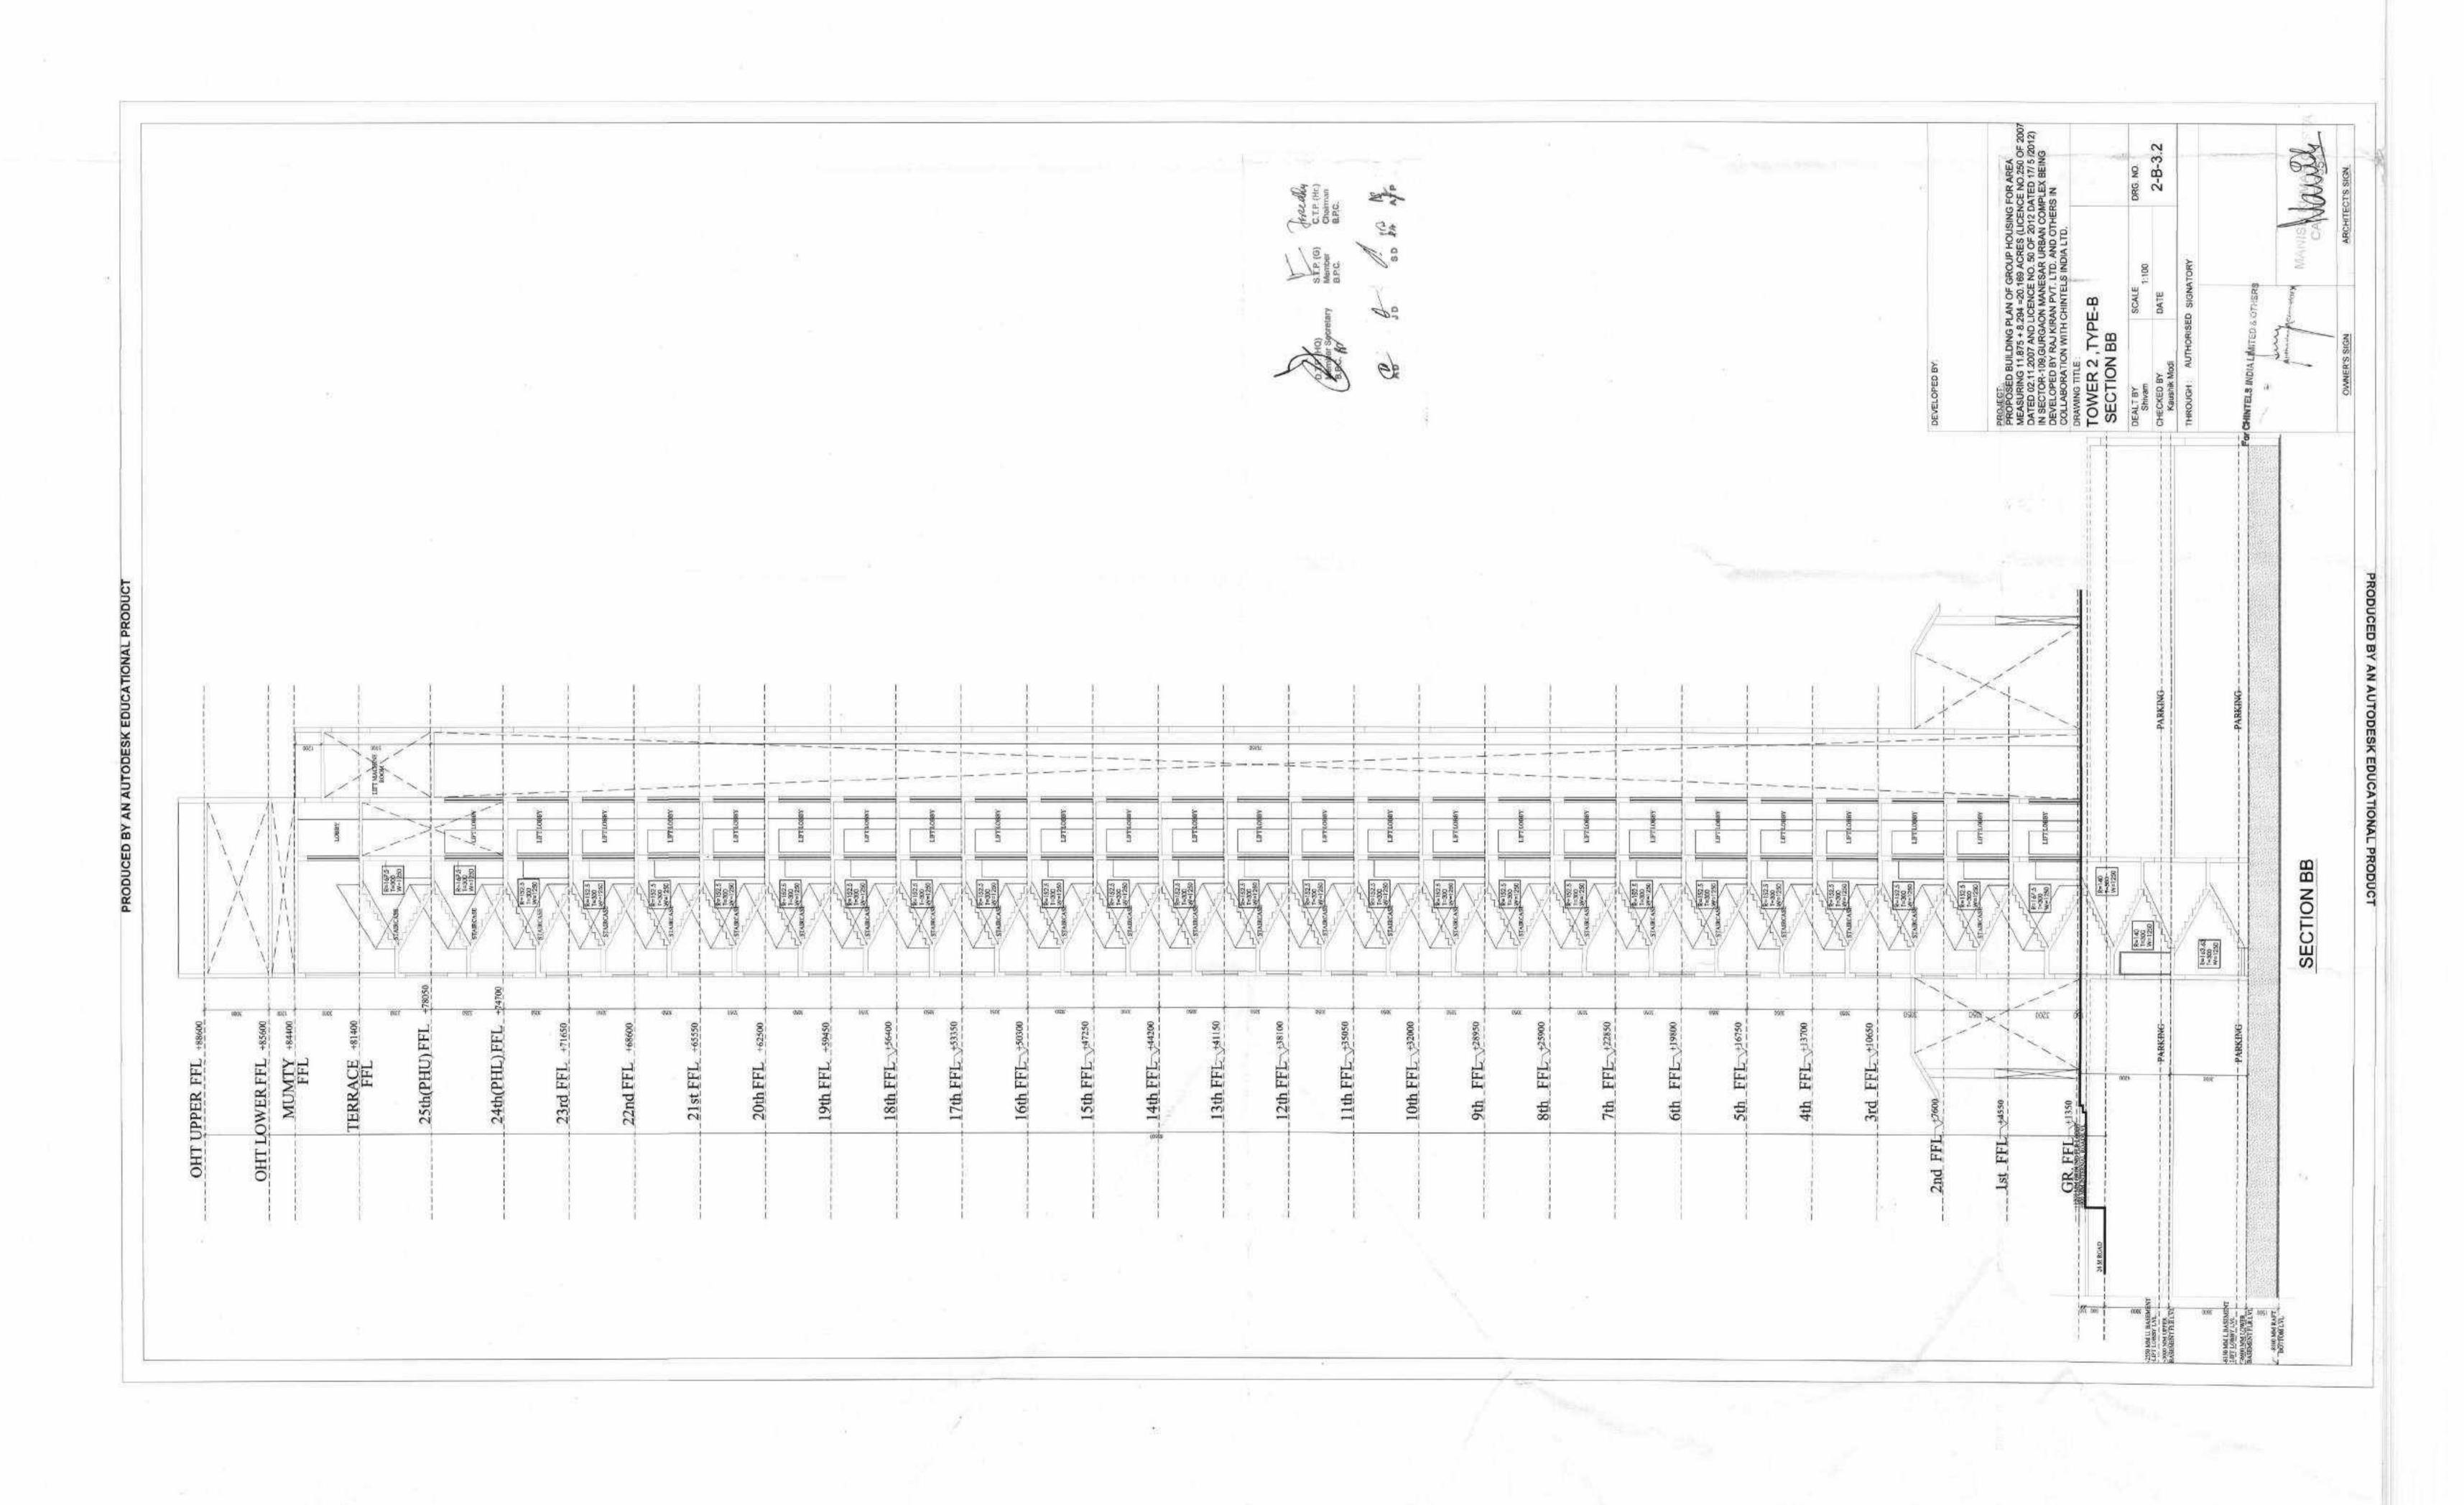


TERRACE +81400 FFL . . . . . . . . . . . . . . . . . 25th(PHU)FFL +78050 24th(PHL) FFL +74700 \_\_\_\_\_23rd FFL +71650 22nd FFL +68600 21st FFL +65550 20th FFL +62500 19th FFL +59450 18th FFL +56400 17th FFL +53350 16th FFL +50300 \_\_\_\_\_15th FFL +47250 14th FFL +44200 13th FFL +41150 12th FFL +38100 \_\_\_\_\_11th\_FFL\_\_+35050 10th FFL +32000 9th FFL +28950 \_8th\_FFL\_+25900 \_\_\_\_\_7th\_FFL\_+22850 6th FFL +19800 4th FFL +13700 3rd\_FFL\_+10650 2nd FFL +7600 1st FFL +4550 GR. FFL +1350 **ELEVATION B** DRAWING TITLE : DEVELOPED BY: TOWER-2, TYPE-B GARDEN SIDE ELEVATION (P. HAST-1) DEALT BY SCALE DRG. NO. Shivam Srivastava 1:100 CHECKED BY DATE 2-B-4.2 Kaushik Modi THROUGH: AUTHORISED SIGNATORY PROJECT: PROPOSED BUILDING PLAN OF GROUP HOUSING FOR AREA MEASURING 11.875 + 8.294 =20.169 ACRES (LICENCE NO.250 OF 2007 DATED 02.11.2007 For CHINTELS INDIA LIMITED & OTHERS AND LICENCE NO. 50 OF 2012 DATED 17/ 5 /2012) IN SECTOR-109, GURGAON MANESAR URBAN COMPLEX BEING DEVELOPED BY RAJ KIRAN PVT. LTD. AND OTHERS IN COLLABORATION WITH CHINTELS INDIA LTD.

OWNER'S SIGN

PRODUCED BY AN AUTODESK EDUCATIONAL PRODUCT


ARCHITECT'S SIGN.

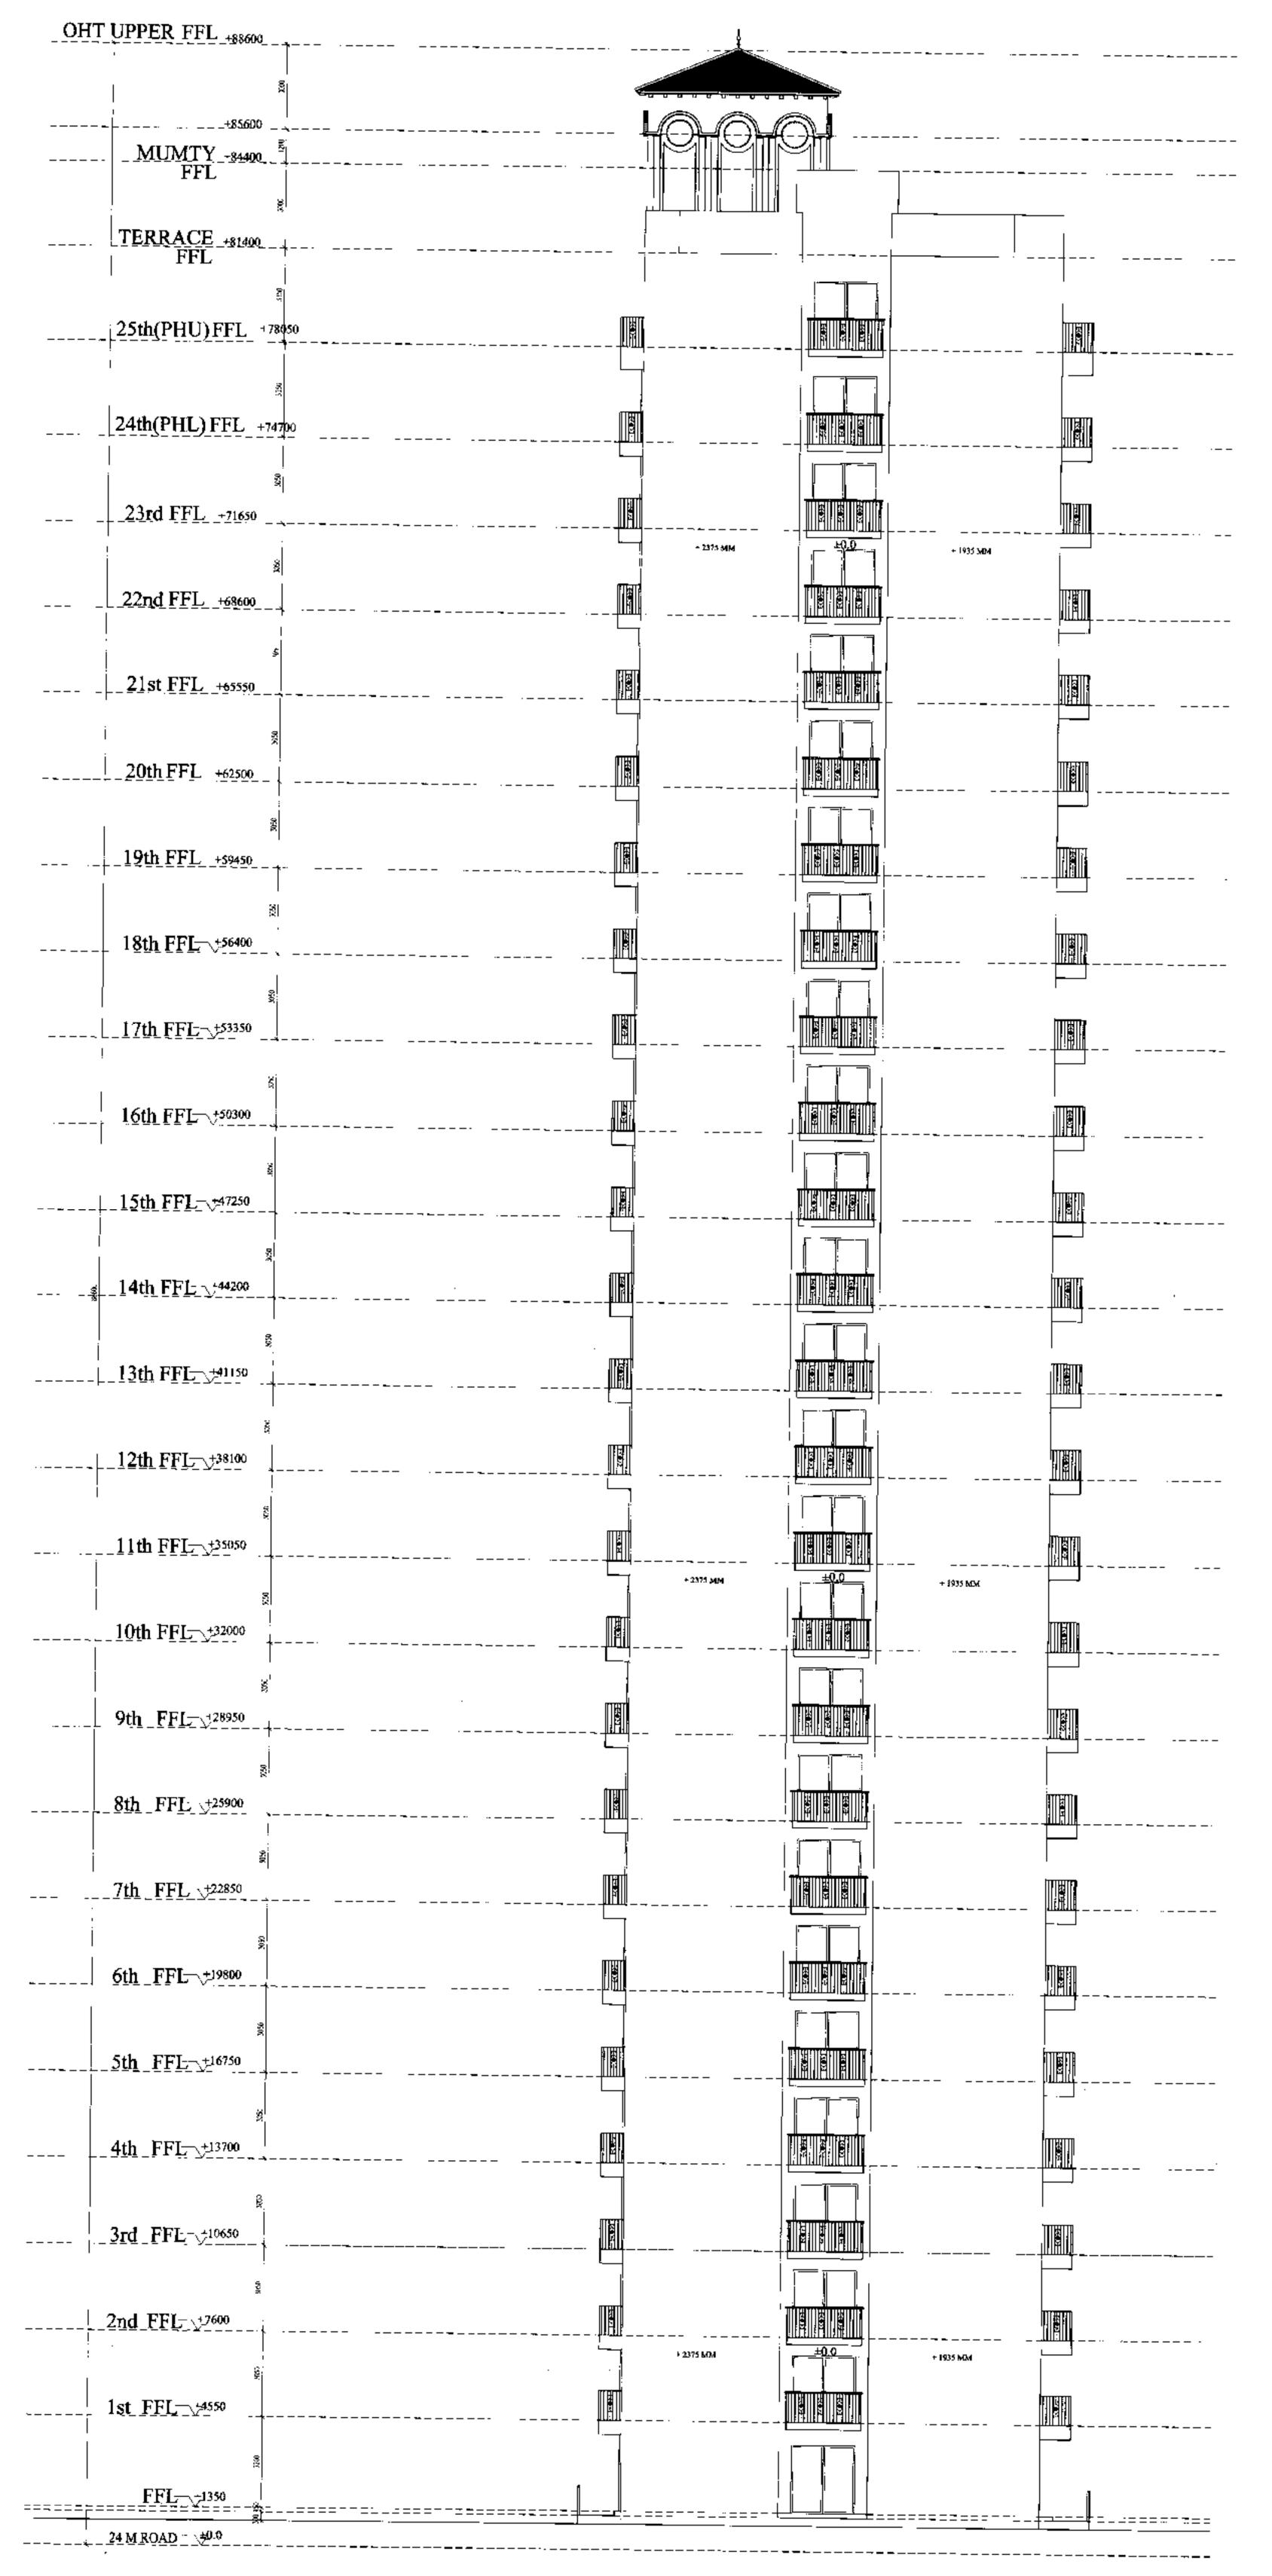


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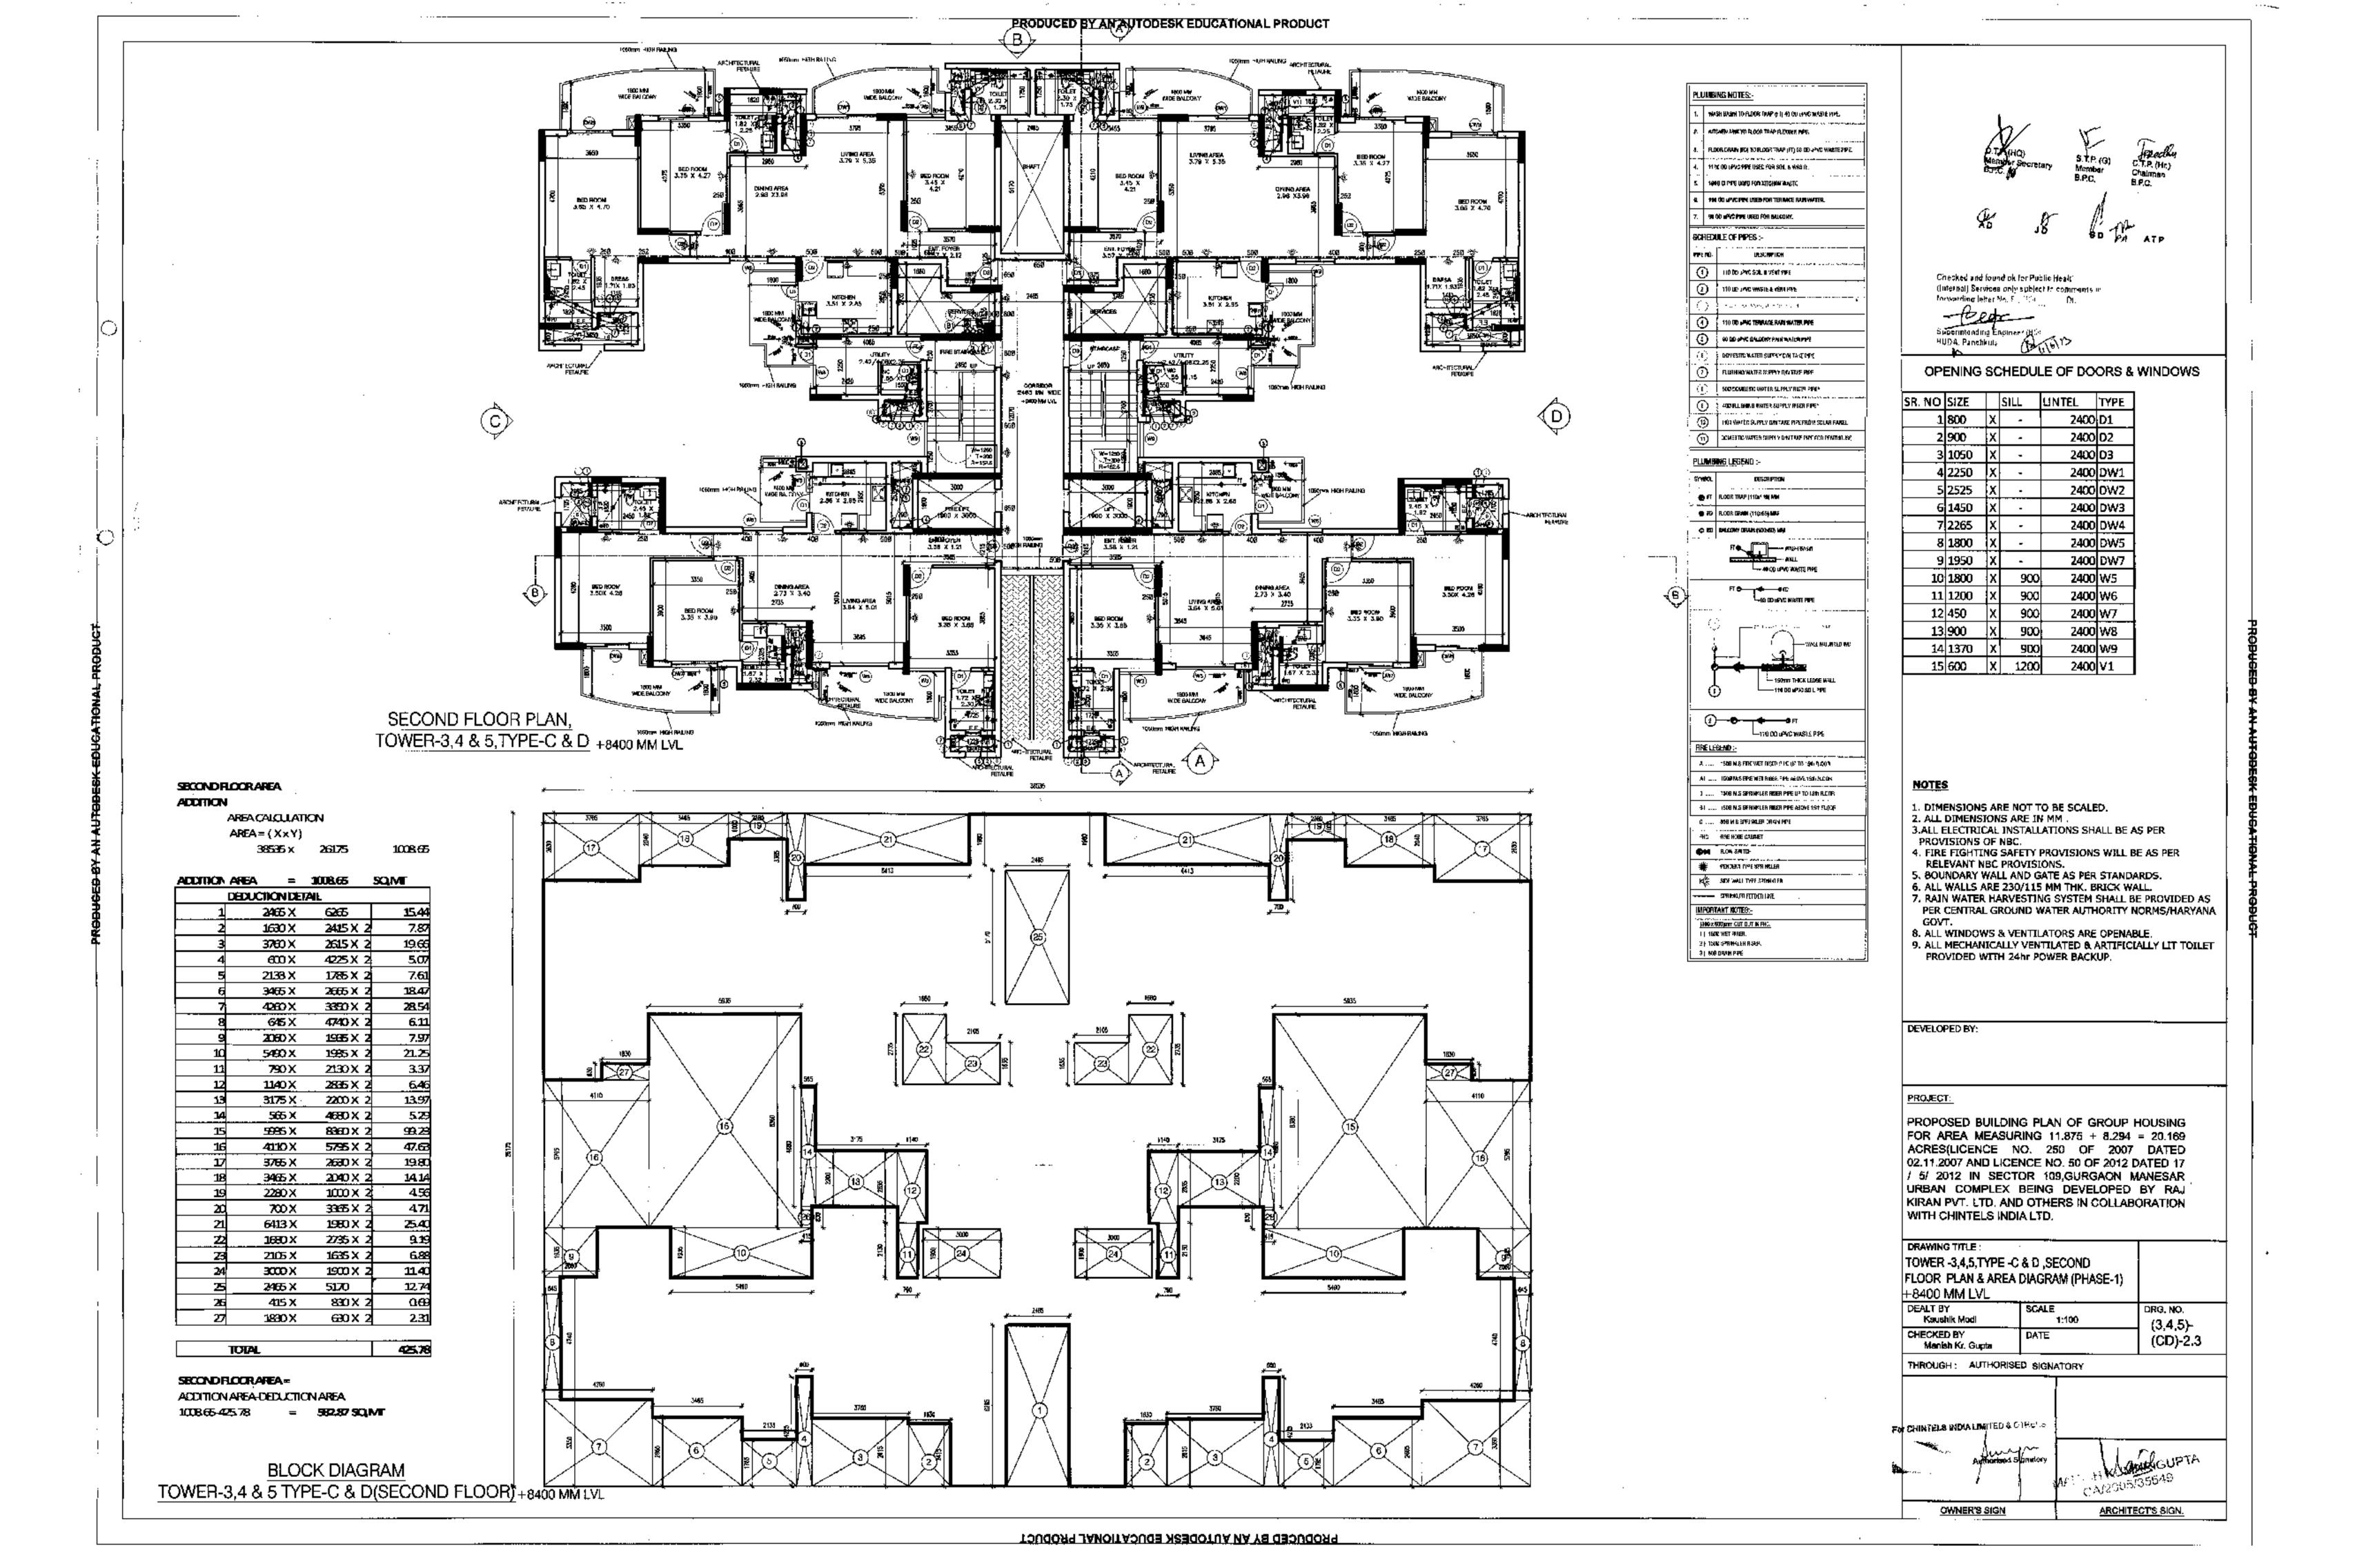
ELEVATION C & D


			DEVELOPED BY:
TOWER-2 ,TYPE ELEVATION (P#8	•	<u> </u> 	
DEALT BY Shivam Srivastava	SCALE 1:100	DRG. NO.	
CHECKED BY Kaushik Modi	DATE	2-B-4.3	· :
HROUGH: AUTHORI	SED SIGNATORY	_ <del></del>	PROJECT:
FOI CHINTELS IN ENA LITERAL STATES		MAR CHILL	PROPOSED BUILDING PLAN OF GROUP HOUSING FOR AREA MEASURING 11.875 + 8.294 = 20.189 ACRES (LICENCE NO.250 OF 2007 DATED 02.11.2007 AND LICENCE NO. 50 OF 2912 DATED 17/5/2012) IN SECTOR-109, GURGAON MANESAR URBAN COMPLEX BEING DEVELOPED BY RAJ KIRAN PVT. LTD. AND OTHERS IN COLLABORATION WITH CHINTELS INDIA LTD.

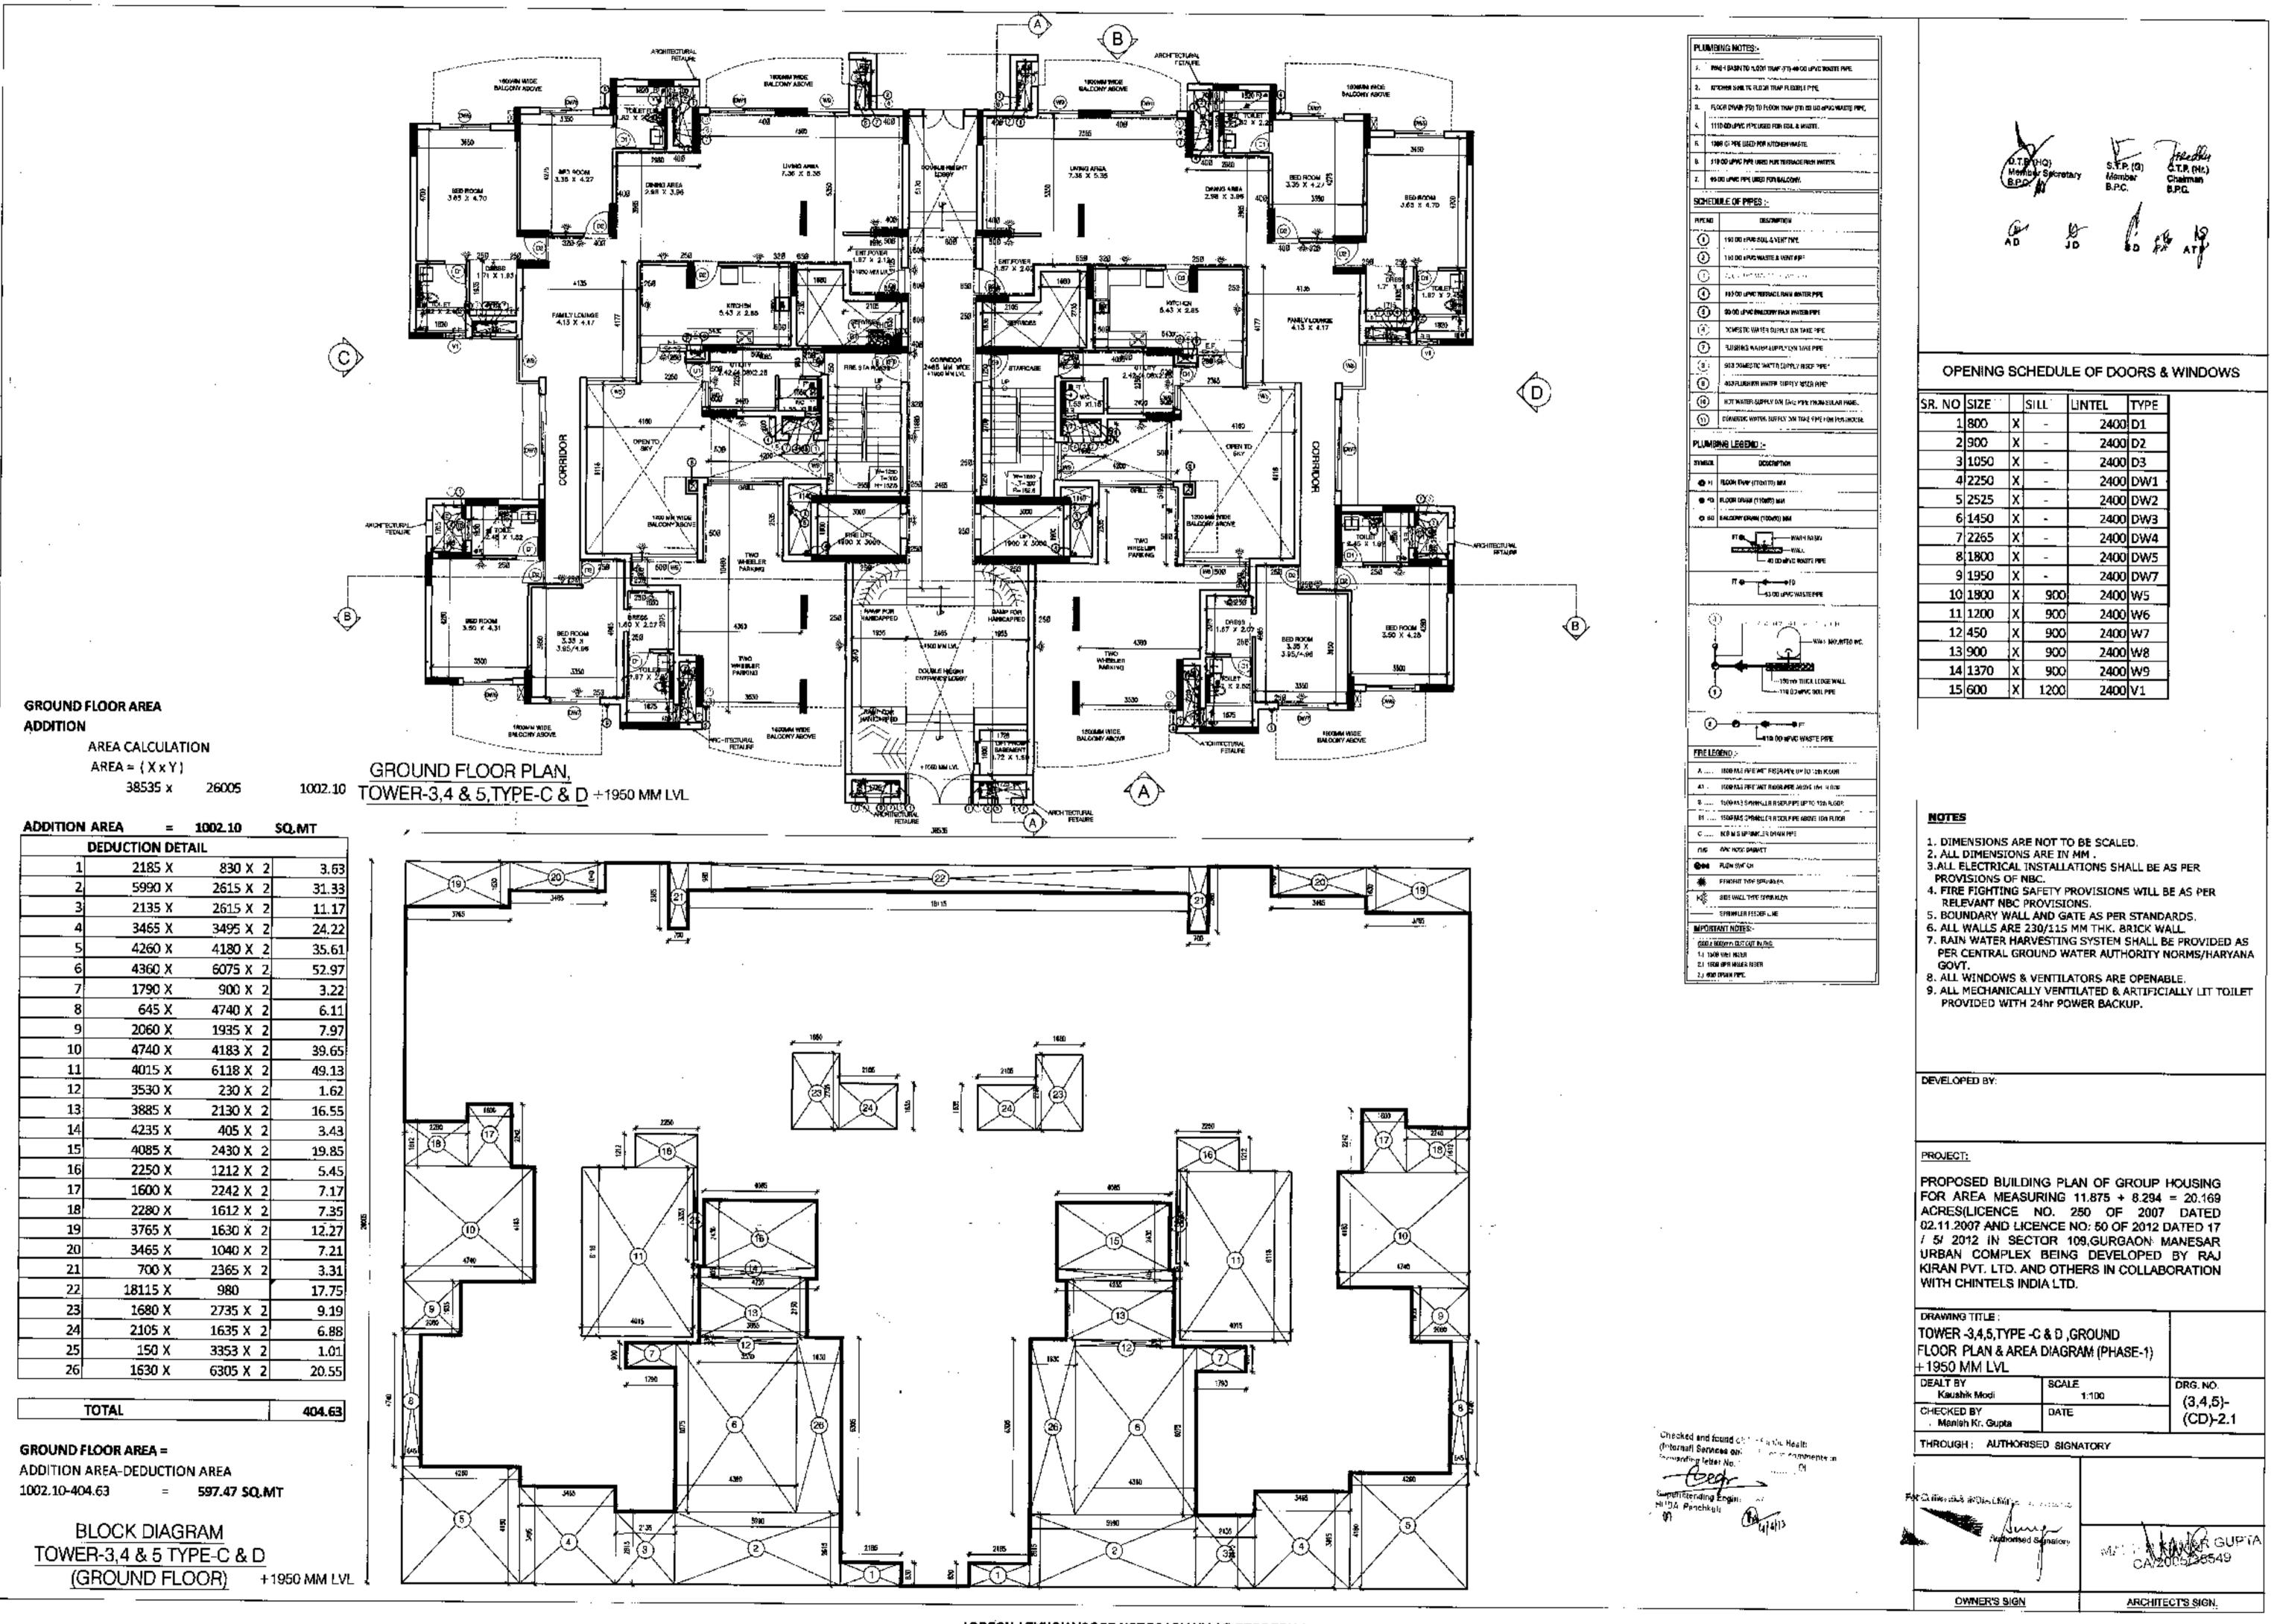


PRODUCED BY AN AUTODESK EDUCATIONAL PRODUCT



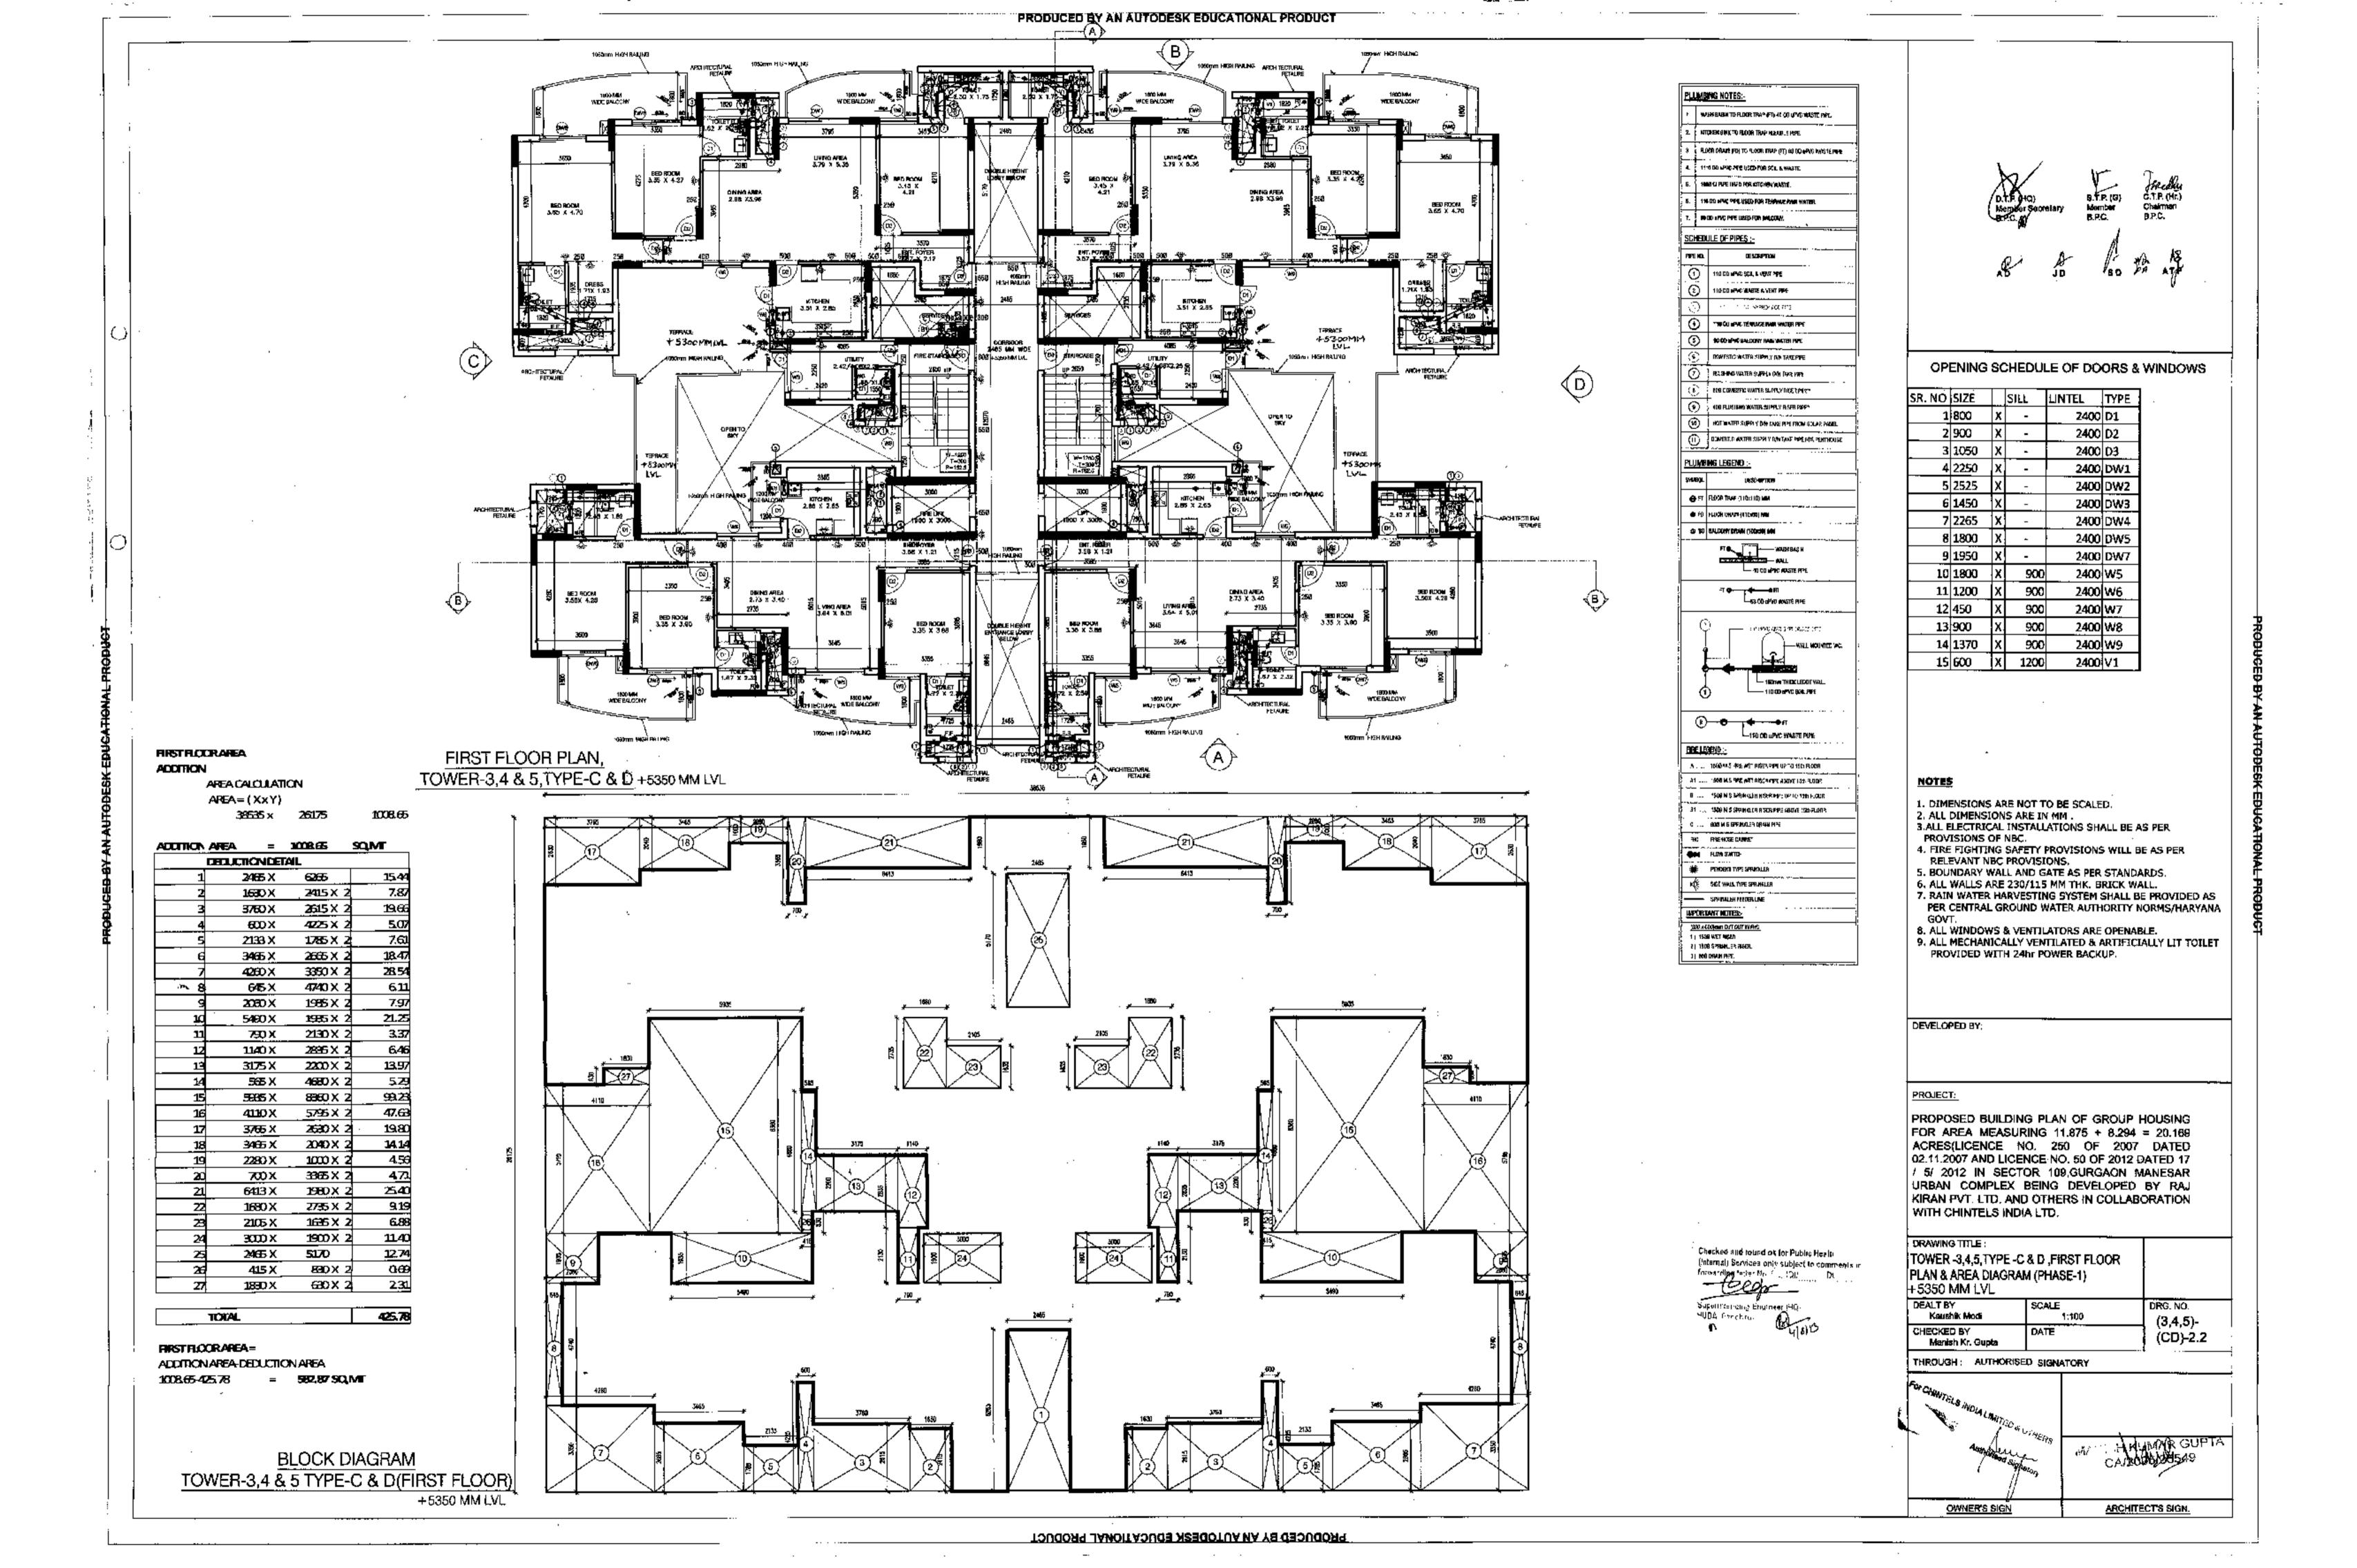

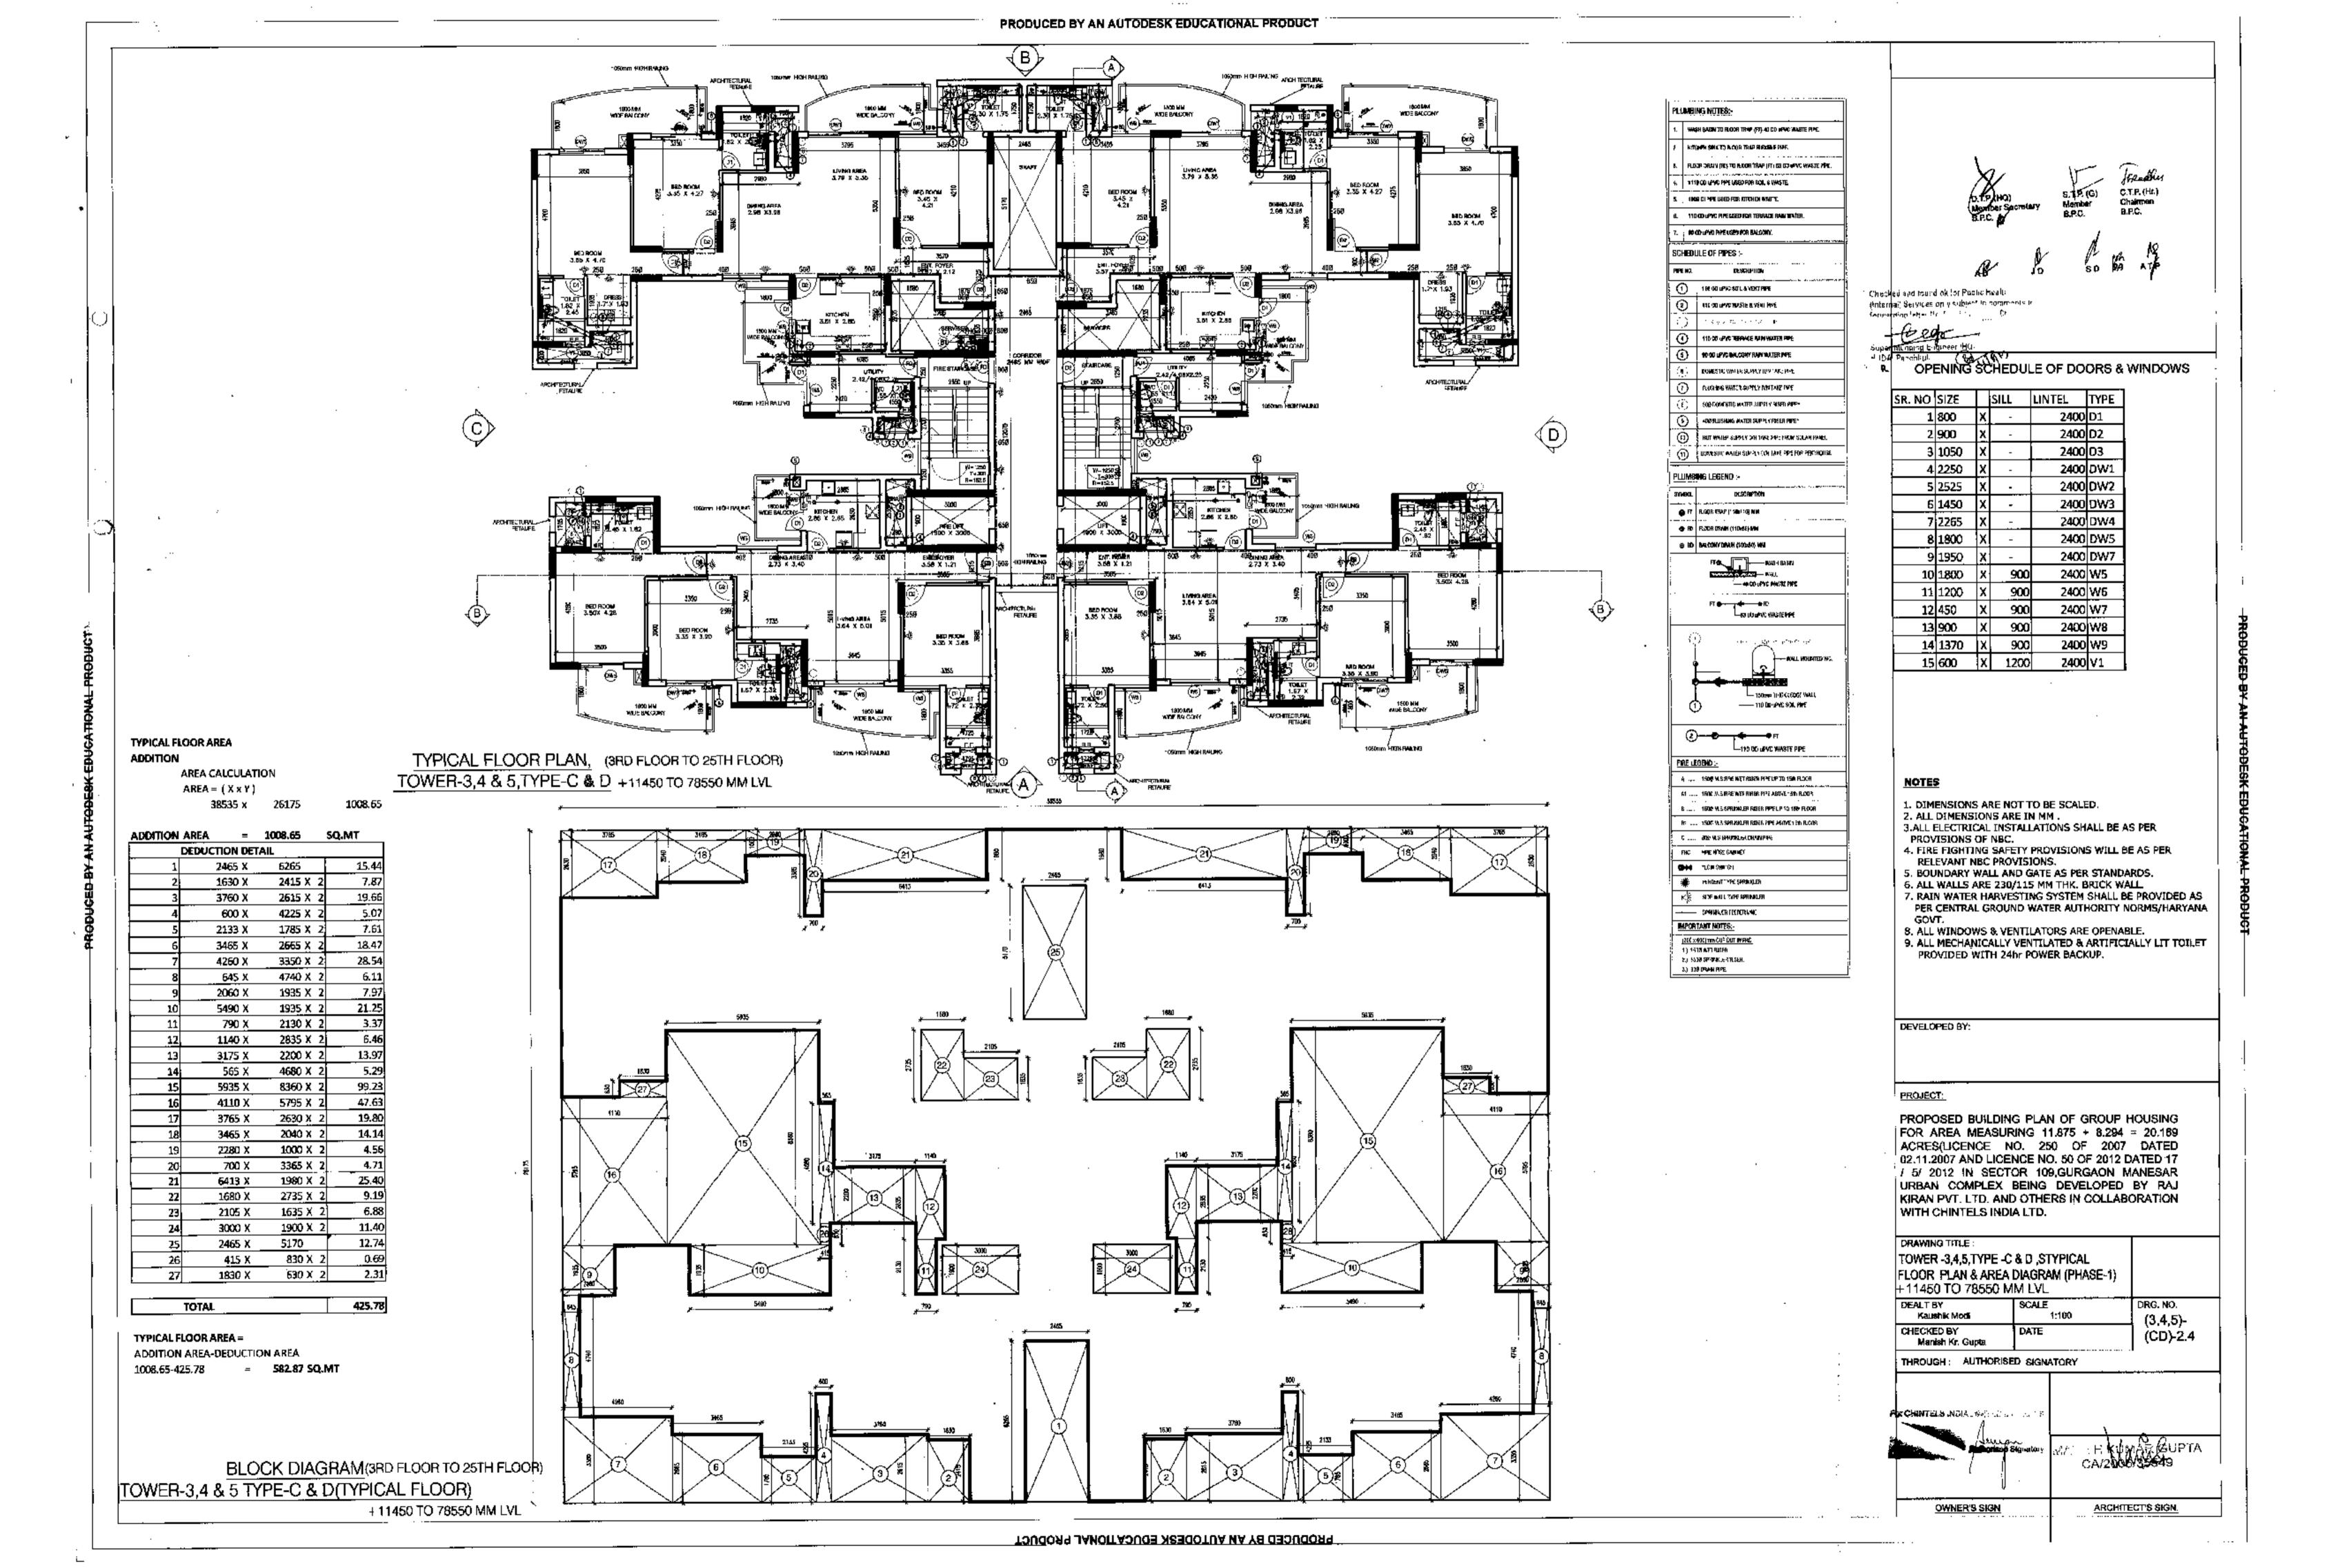

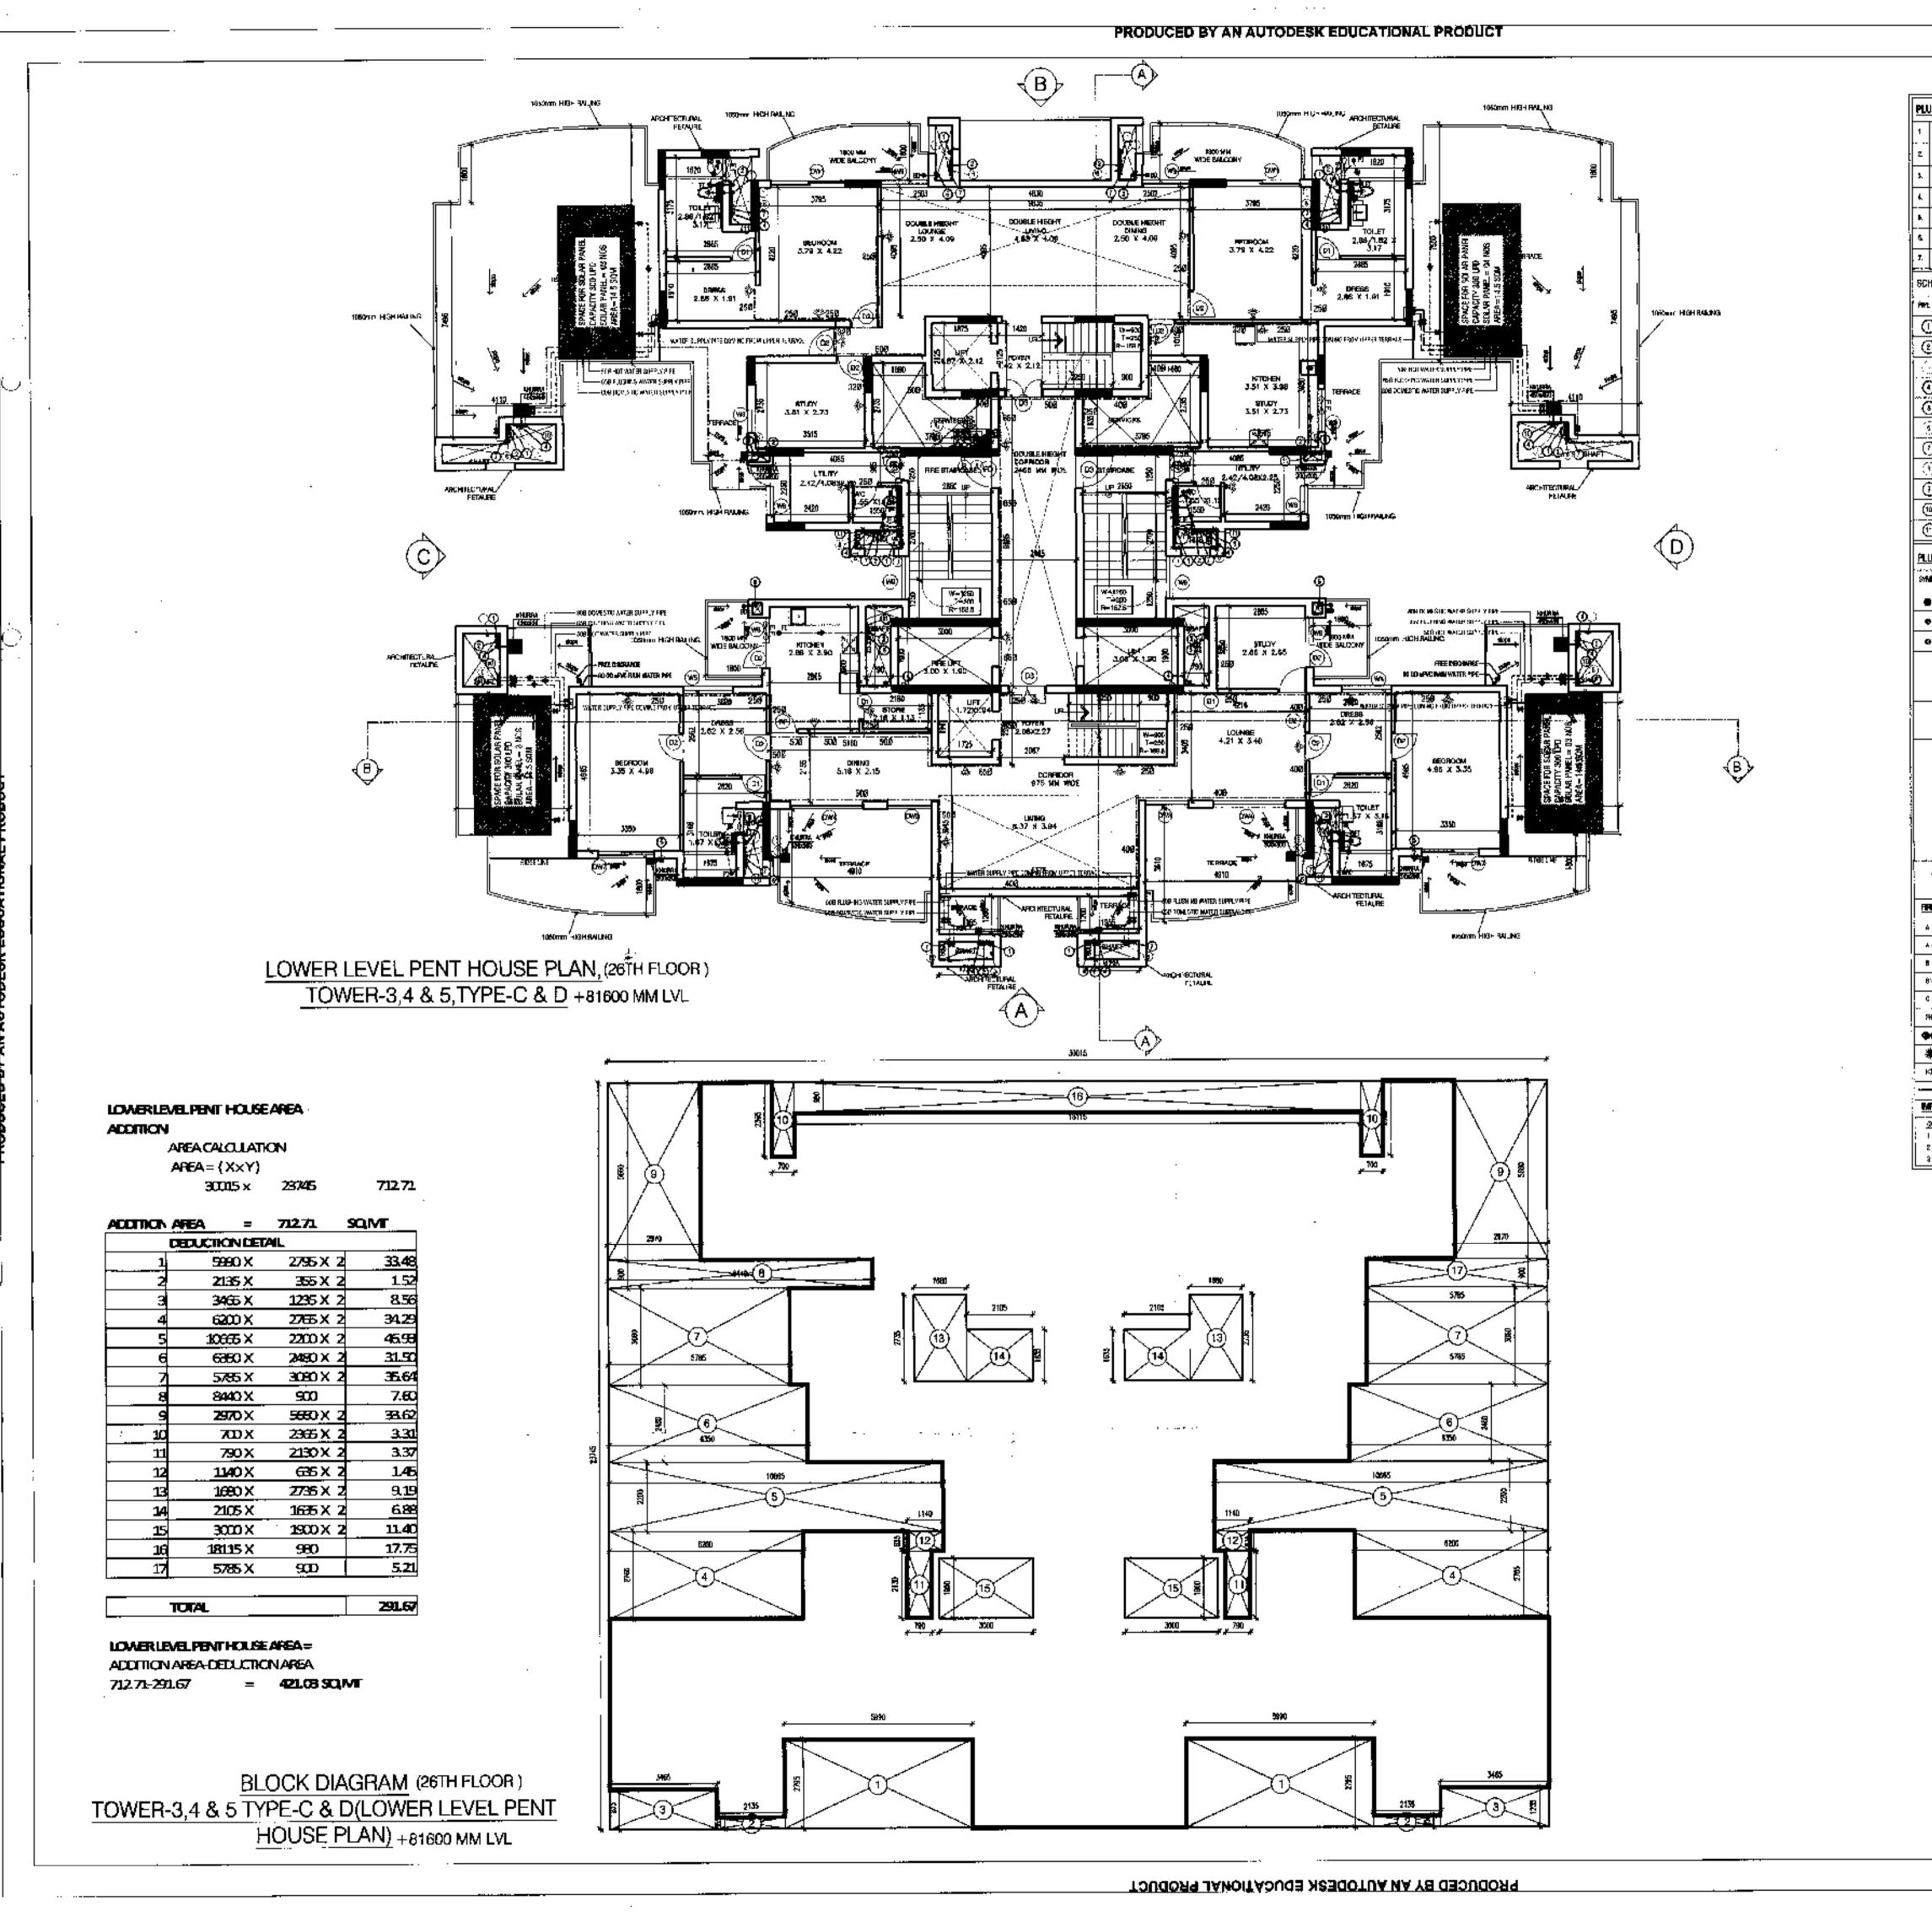

WASH BASH TO PLOCE TRAP (FT) 48 OD MYC WASTE PIPE. ROTTCHÉM SANK TO FLODA TRAP FLODBLE PAPE. THE CO WAS PIPE USED FOR BOIL & WASTE. 1000 LEHRE USED FOR RITCHEN WARTE. 11000 MAG PIPE USED FOR TERRACE RAN MATER. SOCO-PAG PIPE USED FOR INJUCORY HOUD INCOME AND THE 110 OU PAC WASTE & FOR PIPE THE COLUMN TERRACE RAIN WATER PER 90 CD LEVICEAECONY RULH WATER PEFE - AUVIESI DI AMTER SUPPLY DIN TAKE PIPE FLUSHING YM TER SUPPLY ON TAKEPIPE STATION STOWNS IN SUPPLY RISER PIPE. HOT WATER SUPPLY ON TAKE APE FROM SOLAR PAREL DOMESTIC WATER BLIPPLY CONTAKE INFEROR PORTHOUSE. <u> Plumbang legend :-</u> FT RUGRTEWP (HOSHID) VW O BO BALCON SRAM (MANO) MM FT <del>● - - ◆ ----- F</del>II LAS OD LEVIS WASTE MPC 14|1370 |X| 900| 2400|W9 15 600 X 1200 2400 V1 (2) <del>- 0 - 1 ← - 0</del># -110 GE UPVE WASTE PIPE ... 1998 M.B RIFE WET RISER PRPEUR TO 1926 FLOKA ... 1500 MS 679MK, \$946568 PIPE UP TO 15th 9UKIP rang mis samankilin tasera para nuove tsimpluoda THE PREMISE CAPIET TUDWSMITCH \* NAMIGAL AND SHAMKTER KIÉ SIDENNIL TYPESVA HALER ----- SPNAMEN HOOF LINE IMPORTANT NOTES:-2-File TUOTILE mm (2)33 + 000 I | 1508 WET REVEN 2 | 1908 SP-WACERMEEN 31 500 DAAN PIPE.

Checked and found ok for Public Hear. <sup>A P</sup>OPENING SCHEDULE OF DOORS & WINDOWS SR. NO SIZE 2400 D1 2 900 X 3 1050 X 2400 D3 4 2250 X 2400 DW1 5 2525 X 2400 DW2 6 1450 X 2400 DW3 2400 DW4 8 1800 X 2400 DW5 12|450 |X| 900| 2400|W7

- 1. DIMENSIONS ARE NOT TO BE SCALED.
- 2. ALL DIMENSIONS ARE IN MM. 3.ALL ELECTRICAL INSTALLATIONS SHALL BE AS PER PROVISIONS OF NBC.

2400 W8


- 4. FIRE FIGHTING SAFETY PROVISIONS WILL BE AS PER RELEVANT NBC PROVISIONS.
- 5. BOUNDARY WALL AND GATE AS PER STANDARDS. 5. ALL WALLS ARE 230/115 MM THK. BRICK WALL.
- 7. RAIN WATER HARVESTING SYSTEM SHALL BE PROVIDED AS PER CENTRAL GROUND WATER AUTHORITY NORMS/HARYANA
- 8. ALL WINDOWS & VENTILATORS ARE OPENABLE.
  9. ALL MECHANICALLY VENTILATED & ARTIFICIALLY LIT TOILET PROVIDED WITH 24hr POWER BACKUP.


DEVELOPED BY:

### PROJECT:

PROPOSED BUILDING PLAN OF GROUP HOUSING FOR AREA MEASURING 11.875 + 8.294 = 20.169 ACRES(LICENCE NO. 250 OF 2007 DATED 02.11.2007 AND LICENCE NO. 50 OF 2012 DATED 17 / 5/ 2012 IN SECTOR 109, GURGAON MANESAR URBAN COMPLEX BEING DEVELOPED BY RAJ KIRAN PVT. LTD. AND OTHERS IN COLLABORATION WITH CHINTELS INDIA LTD.

DEALT BY	) +81600 MM LVL Tecale	DRG. NO.
Kaushik Modi	1:100	(3,4,5)-
CHECKED BY Menish Kr. Gupta	DATE	(CD)-2.5

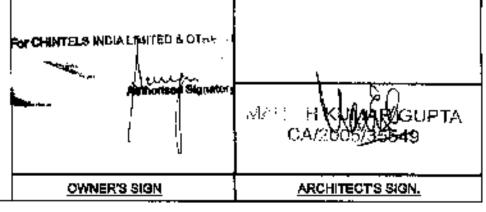

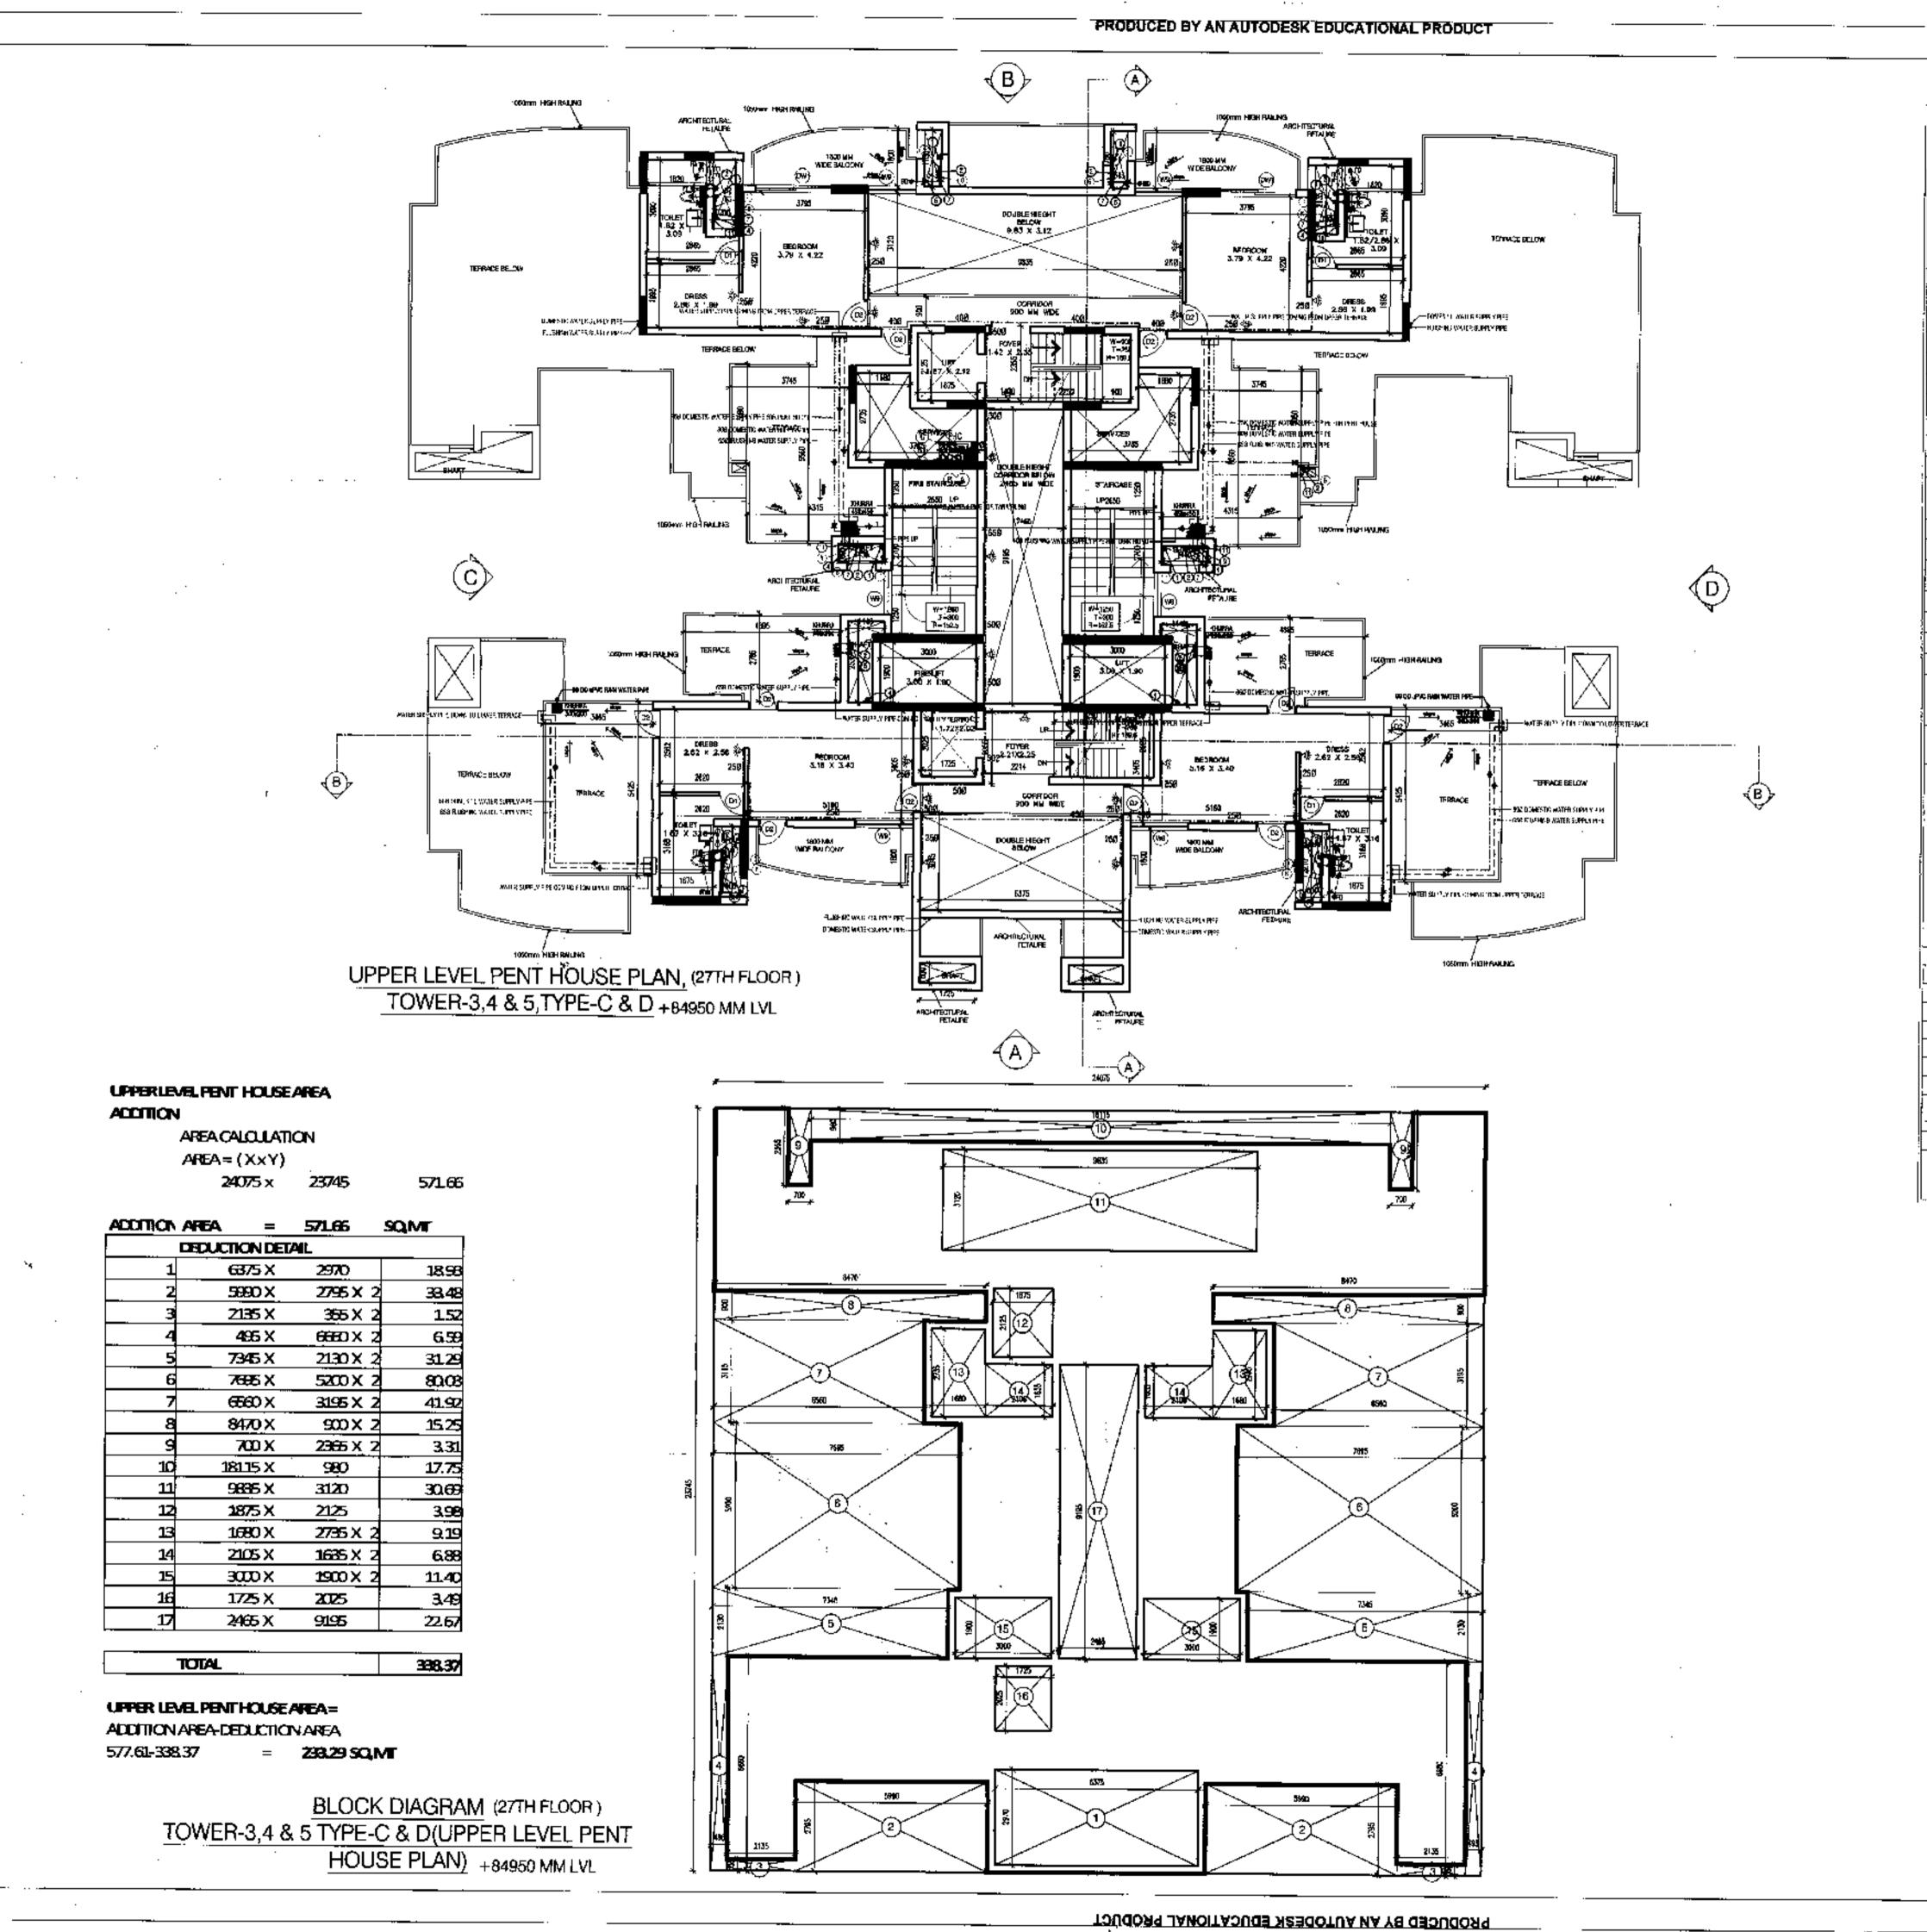

WASH INSINTO PLOCE TRUP (FT) 40 (III) PAYS VALSTE PIPE. " NTORRI SUKTO RUGO ITALO O ENGLE POR RUNGE OF ANY ITEM TO FLOOR TRAP (FT) AS NO WAY WASTE PAPE. PPRODUPYO PPELESED FOR SOM ELYMETE 10 MB AT PIPE USED FOR HTTCHEN WARTING 190 DD LPAG PPE LINCO FOR TEATHER SMART WATER SO COMPACIFIED FOR BALCON 110 DELWANDERN, & WENT PAPE HID OD MPNO YWSTE A YEAR PIPE Copia at Anni 2006/Associa di \$10 CO MPAG TEMPAGE FAMIL WACHER PROF DO THE MAKE BALLOCKY GAIN WASTER PLACE COVESTICING INVESTIGATION FOR PARAMAMETER SAFFLY (LANGE PARE STO COMESTIC WATER, SHAPLY GISHA PAGE! ACO FLUSHAG WATER BUPPLY RESER PIVE" HOT WATER SUPPLY DISTORE PIPE FROM SOLAR, PARKEL SOMESTIC WATER SUPPLY LEW TAKE RIPE FOR PENTHOUSE <u>Plumeing</u> legend :-OF EDUSTRACION MA MU PARATO MARKETOCAT. 07 M O NO SALCOUN DEADS (100-SH) MIN ---- መጠውያለ WSM PA FT**¢———→**#D L-83-00 APAC MASTE PPE -- SFORM THICK LEDGE WALL - 41000 uPV2SDL PPE **҈————** өн LING CO UPVE WASTE PAYE A ... 1909 VLS HEE INFT 235ER PITE UP TO 15th FLOOR AT ...... 1509 N 6 FTAS WET RISER PSPEARONE 1544 HUNCH . I IDDO SALS SPRINKLEN RIGHT PRO UP TO 16th FLOCK B1 .... 1507M 5.3P0 AULB RISSER P125 ASSUME 150 (AULD) 5 FINC RESERVED CARRIED CMARWET STORY # PENDENTTYPESPANALER HIS SOEWALL TAYS SPRINGER ----- SHAPULHI HELIKE LITE PAPORTANT HOTEE: 1800 x 600 mm 0.7 007 to 9-0. 21 1900 SPONILER NIER 3 ) 600 DIVAN PIPE.

B.P.C. Secretary S.F.P. (G) F.R.e. Chalman B.P.C.

Checked and found ok for Public Healti (internal) Services only subject to comments in forwarding offer No. 5 (1.27.17) Dr

paerinterdina Engineer (HC)

OPENING SCHEDULE OF DOORS & WINDOWS

SR. NO	SIZE		SILL	LINTEL	TYPE
1	800	X		2400	D <b>1</b>
2	900	X.		2400	D2
3	1050	Х		2400	D3
4	2250	Х	1	2400	DW1
5	2525	Х		2400	DW2
- 6	1450	Χ		2400	DW3
7	2265	X	-	2400	DW4
8	1800	Х	_ <b>.</b>	2400	DW5
9	1950	Х	-	2400	DW7
10	1800	Х	900	2400	W5
11	1200	Х	900	2400	W6
12	450	X	900	2400	W7
13	900	Х	900	2400	W8
14	1370	х	900	2400	W9
15	600	Х	1200	2400	V1

1. DIMENSIONS ARE NOT TO BE SCALED.

PROVISIONS OF NBC.

2, ALL DIMENSIONS ARE IN MM . 3.ALL ELECTRICAL INSTALLATIONS SHALL BE AS PER

4. FIRE FIGHTING SAFETY PROVISIONS WILL BE AS PER

RELEVANT NBC PROVISIONS.

5. BOUNDARY WALL AND GATE AS PER STANDARDS.

 ALL WALLS ARE 230/115 MM THK. BRICK WALL.
 RAIN WATER HARVESTING SYSTEM SHALL BE PROVIDED AS PER CENTRAL GROUND WATER AUTHORITY NORMS/HARYANA

8. ALL WINDOWS & VENTILATORS ARE OPENABLE.

 ALL MECHANICALLY VENTILATED & ARTIFICIALLY LIT TOILET PROVIDED WITH 24hr POWER BACKUP.

DEVELOPED BY:

PROJECT

PROPOSED BUILDING PLAN OF GROUP HOUSING FOR AREA MEASURING 11.875 + 8.294 = 20.169 ACRES(LICENCE NO. 250 OF 2007 DATED 02.11.2007 AND LICENCE NO. 50 OF 2012 DATED 17 / 5/ 2012 IN SECTOR 109, GURGAON MANESAR URBAN COMPLEX BEING DEVELOPED BY RAJ KIRAN PVT. LTD. AND OTHERS IN COLLABORATION WITH CHINTELS INDIA LTD.

DRAWING TITLE:
TOWER -3,4,5,TYPE -C & D ,UPPER LVL
PENT HOUSE FLOOR PLAN & AREA
DIAGRAM (PHASE-1)+84950 MM LVL

DEALT BY
Kaushik Mode 1:100
CHECKED BY
Manish Kr. Gupta

DRG. NO.
(3,4,5)(CD)-2.6

THE TUGH: AUTHORISED SIGNATORY


Per CHRITELS INCIA LIMITED & OTHERS

Authorised Signator

CAACOUS SIGN

OWNER'S SIGN

ARCHITECT'S SIGN.

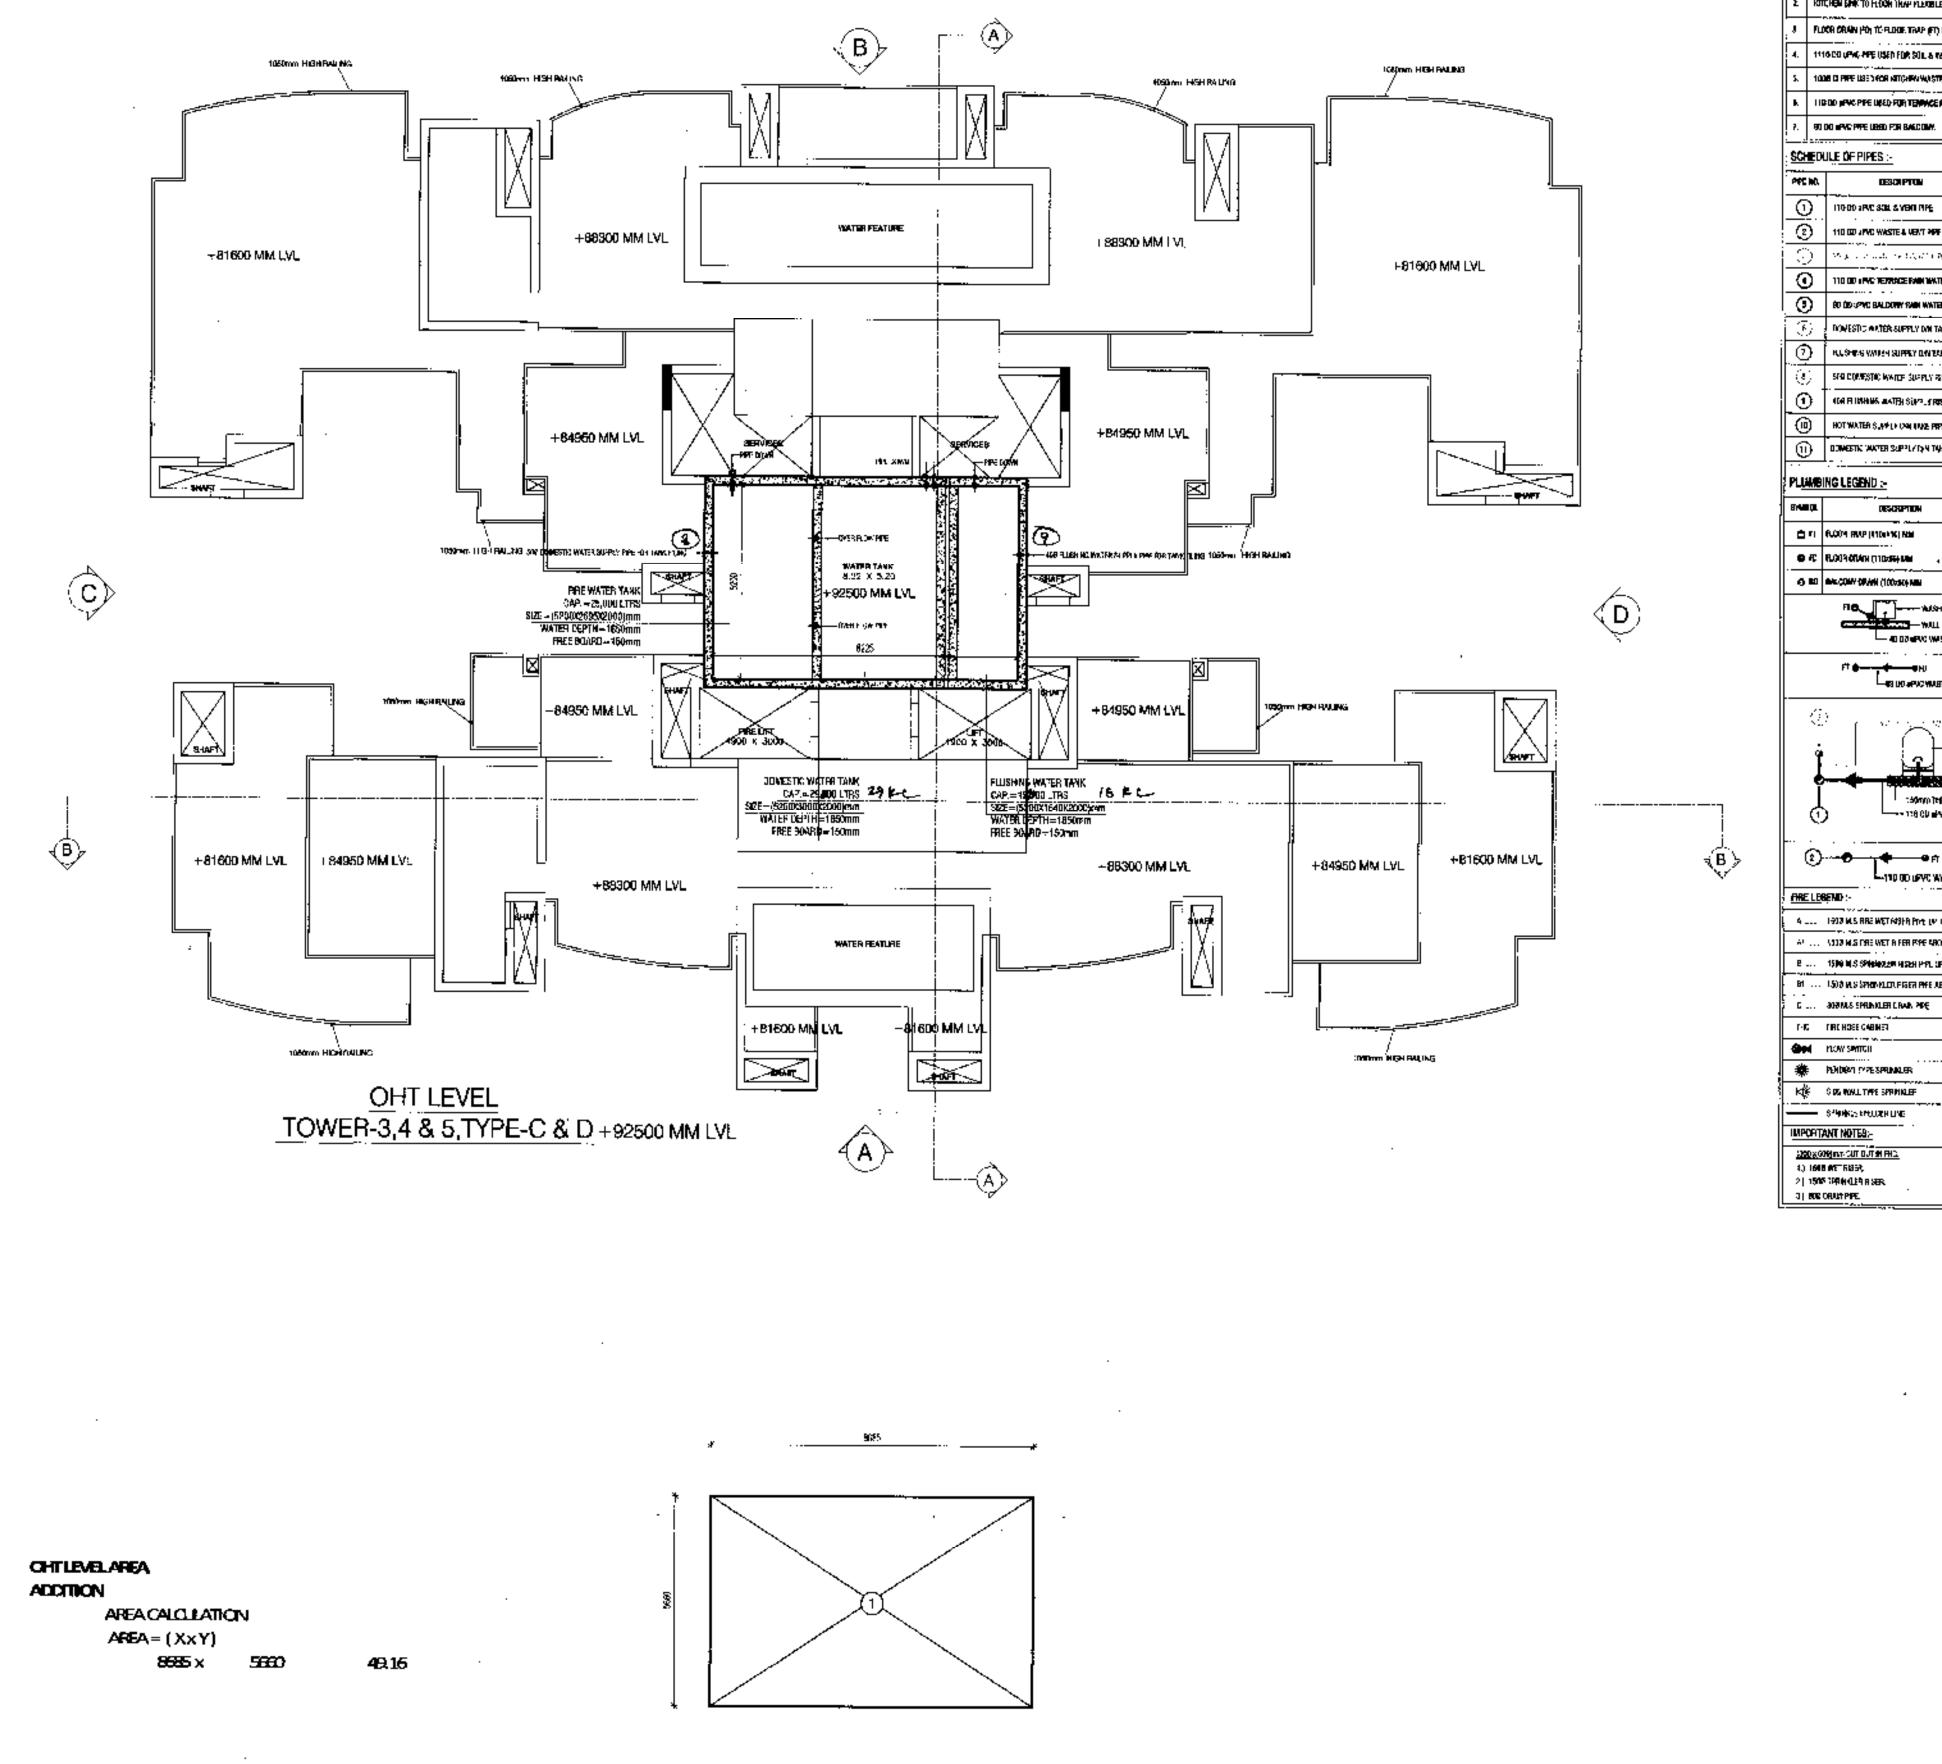

PLUMBING NOTES:-MASSIERAN TO FLOOR TRAP (FT) 49 QQ UPVC WASTE MPL KTTCHEN SHK TO H-DON THAN MENDELEPRINE FLOCE CRAIN (FO) TO FLORE THAT (FT) ES SO (FFAC MASTE MAS. 1110 CO UPAG APPE USEN FOR SOIL & MAGTE. 1008 DEPRE USED FOR ATTOHER WASTE HID DO JEWS PER LIKED FOR TEMPACE AND WANTE. 90 DO MANO PARE LIBED FOR BANCOLAN. 110 00 APAC WASTE & VENT HPF Mark the material Application (A) 110 00 IPAC TERROCE FAMILIANT (SAPE) (3) 80 00:24C BALDOWY FAM WATER PIPE DOMESTIC ANTER-SUPPLY DAY TAKES PE HULSHING VANDER SUPPLY DAVIESE PAPE STO COMPSTIC WATER SUPPLY ISSEN PIPE" COM PRIMARIA MATTER SINFE, SPESSER PIPE" HOT WATER SUPPLY CAN HAVE PRPE PROMISSION PASSES. DOWNER WATER SUPPLYING THE PRE-KIP HER HOUSE FIG. WILL 40 00 MPVC WASTE PIPE :50mm]telCk (LD60 eULL ②···<del>··••</del>•• LATED DO LEVIC WASTE PIPE 4 .... 1937 M.S. RRE WET KRIFFE (P. III. 1937 VLUUS AT .... 1337 M.S. FRE WET BIFER PRE NROVE 19N BI (00). .. 1599 M.S. SPHENDER HISCH PPL UP TO 1609 FLOOR B1 ... 1508 W.S SPHINKLETLEIGER PHE ABOVE 15th FLOOR AND RELIGIOUS SPREAK PER

Guedked and found ok for Public Healt (Internal) Survices only agained to commence in PROOF Pagets in OPENING SCHEDULE OF DOORS & WINDOWS

				<b>-</b>	_
SR. NO	SIZE		SILL	LINTEL	TYPE
1	800	Х	-	2400	D1
2	900	X	-	2400	D2
3	1050	Х	•	2400	D3
4	2250	X	-	2400	DW1
5	2525	X	-	2400	DW2
6	1450	Х	1	2400	DW3
7	2265	X	-	2400	DW4
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11	1200	X	900	2400	W6
12	450	Χ	900	2400	W7
13	900	X	900	2400	W8
14	1370	Χ	900	2400	W9
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DEVELOPED BY:

PROJECT:


PROPOSED BUILDING PLAN OF GROUP HOUSING FOR AREA MEASURING 11.875 + 8,294 = 20,169 ACRES(LICENCE NO. 250 OF 2007 DATED 02.11.2007 AND LICENCE NO. 50 OF 2012 DATED 17 / 5/ 2012 IN SECTOR 109, GURGAON MANESAR URBAN COMPLEX BEING DEVELOPED BY RAJ KIRAN PVT. LTD. AND OTHERS IN COLLABORATION WITH CHINTELS INDIA LTD.

DRAWING TITLE : TOWER -3,4,5,TYPE -C & D OHT LEVEL PLAN & AREA DIAGRAM (PHASE-1) +92500 MM LVL DEALT BY DRG. NO. Keushik Modi (3,4,5)-CHECKED BY (CD)-2.8 Manish Kr. Gupta THROUGH: AUTHORISED SIGNATORY


ARCHITECTS SIGN.


OWNER'S SIGN

BLOCK DIAGRAM TOWER-3,4 & 5 TYPE-C & D (OHT LEVEL) +92500 MM LVL

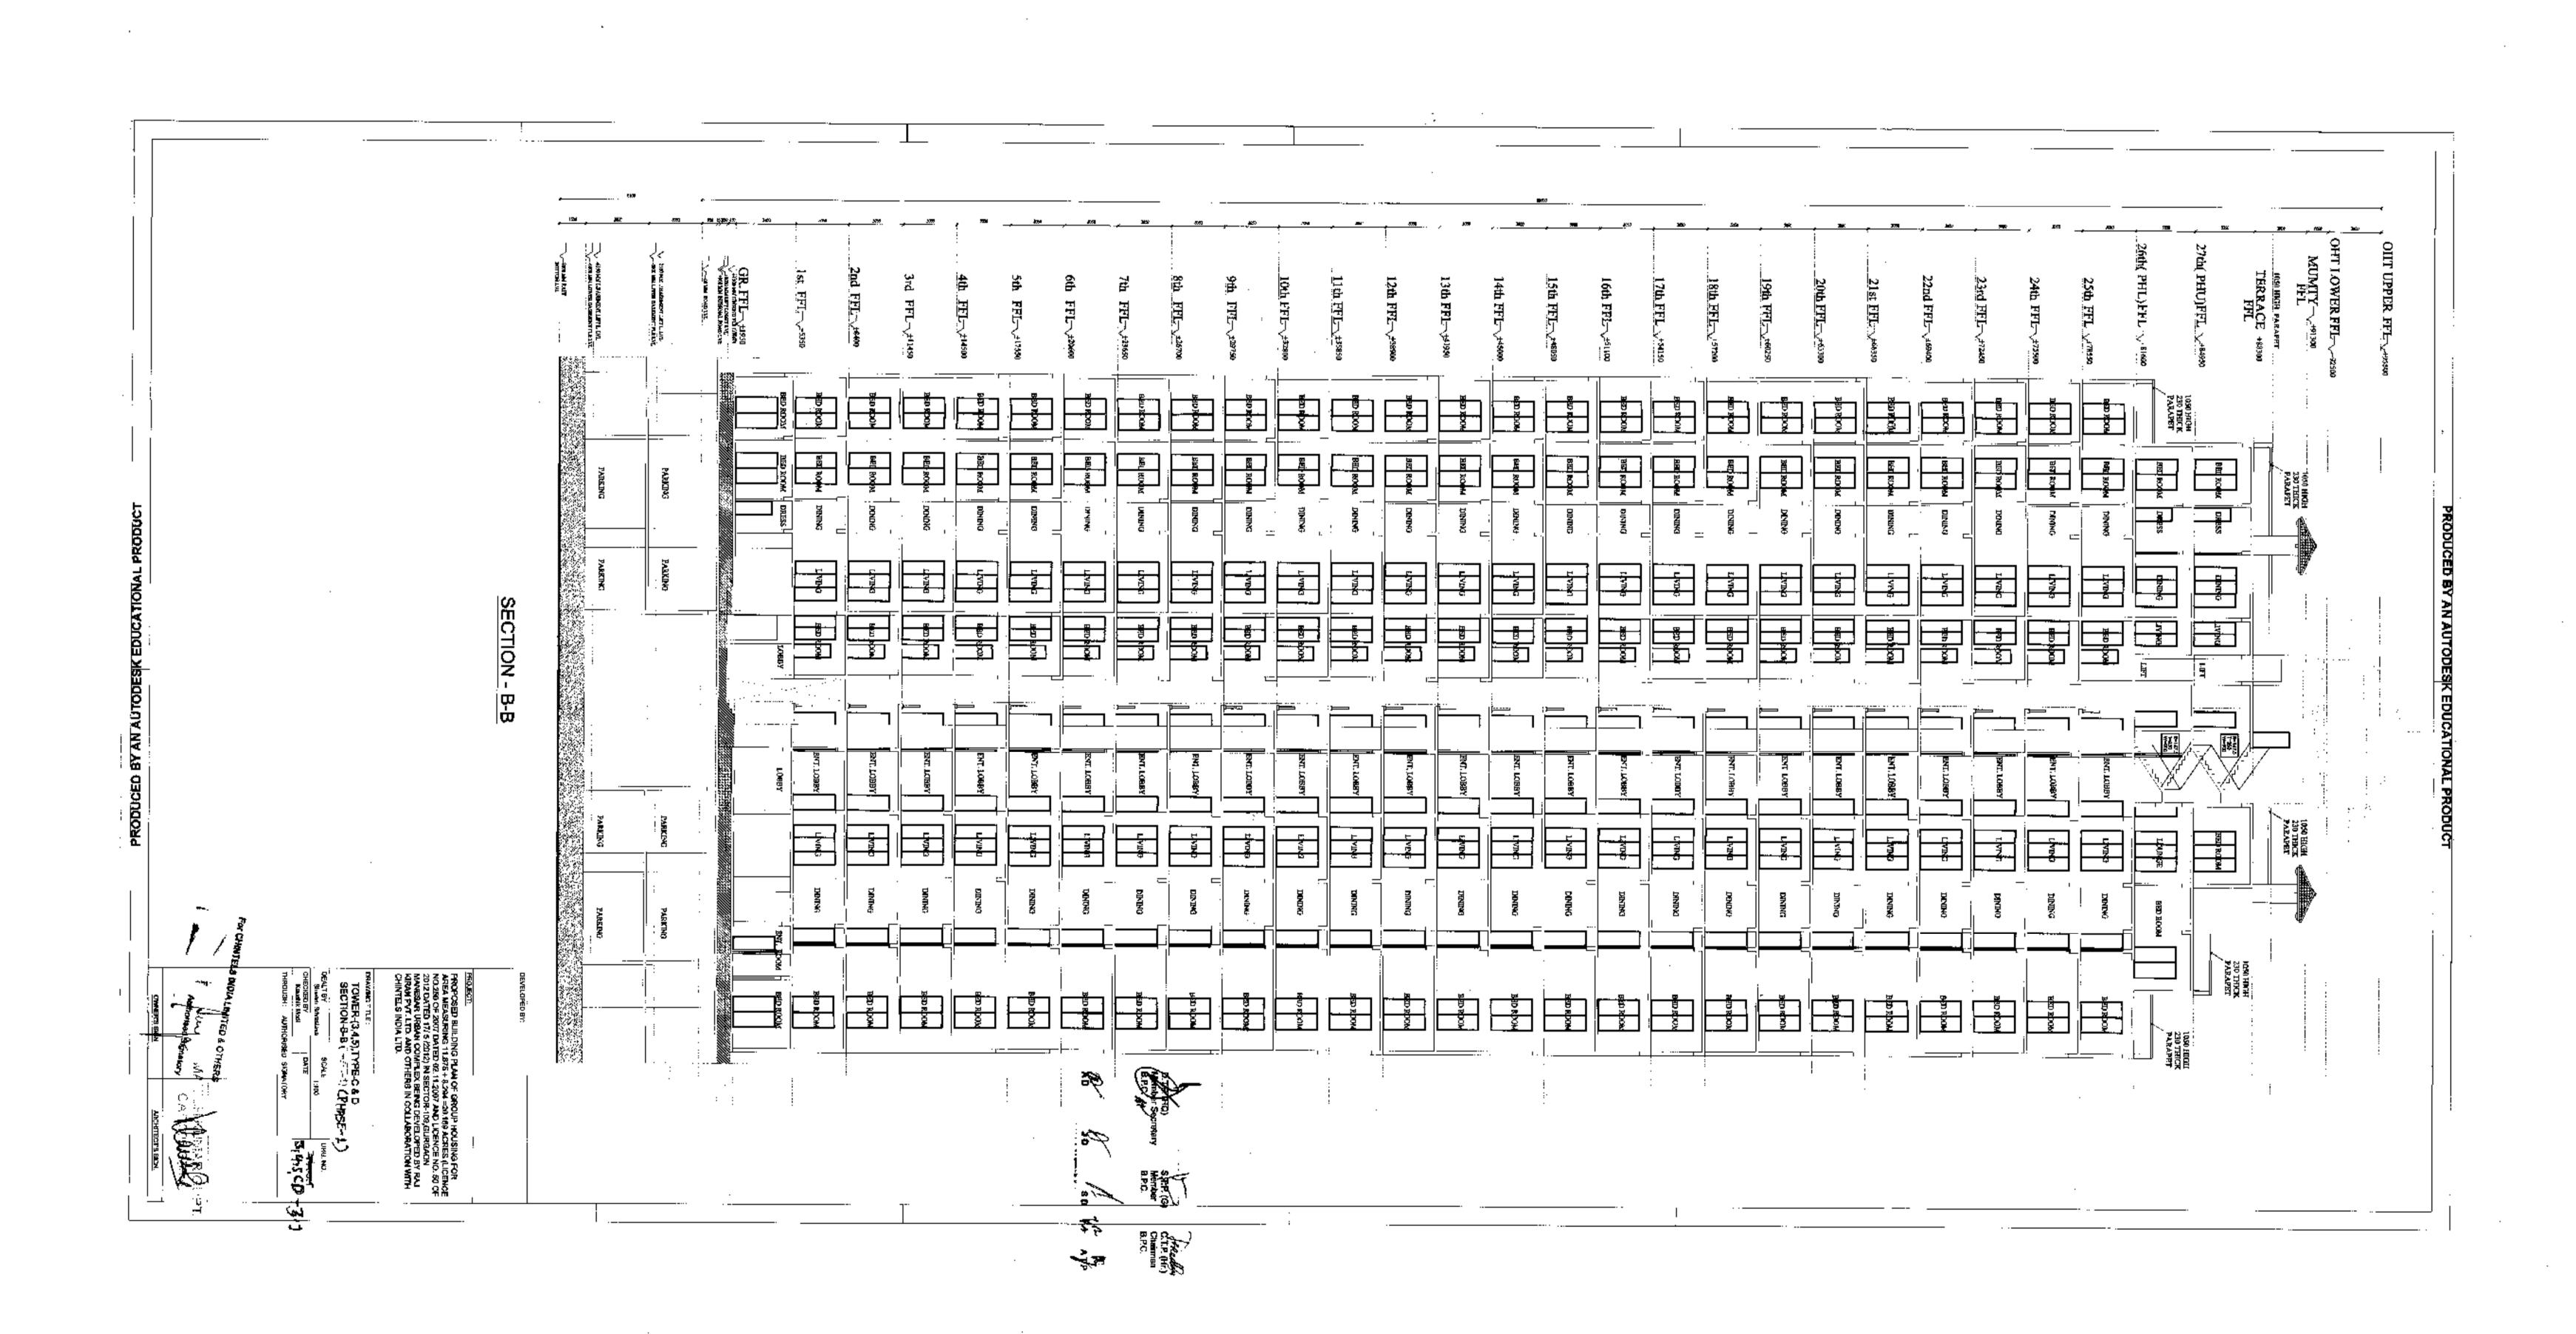



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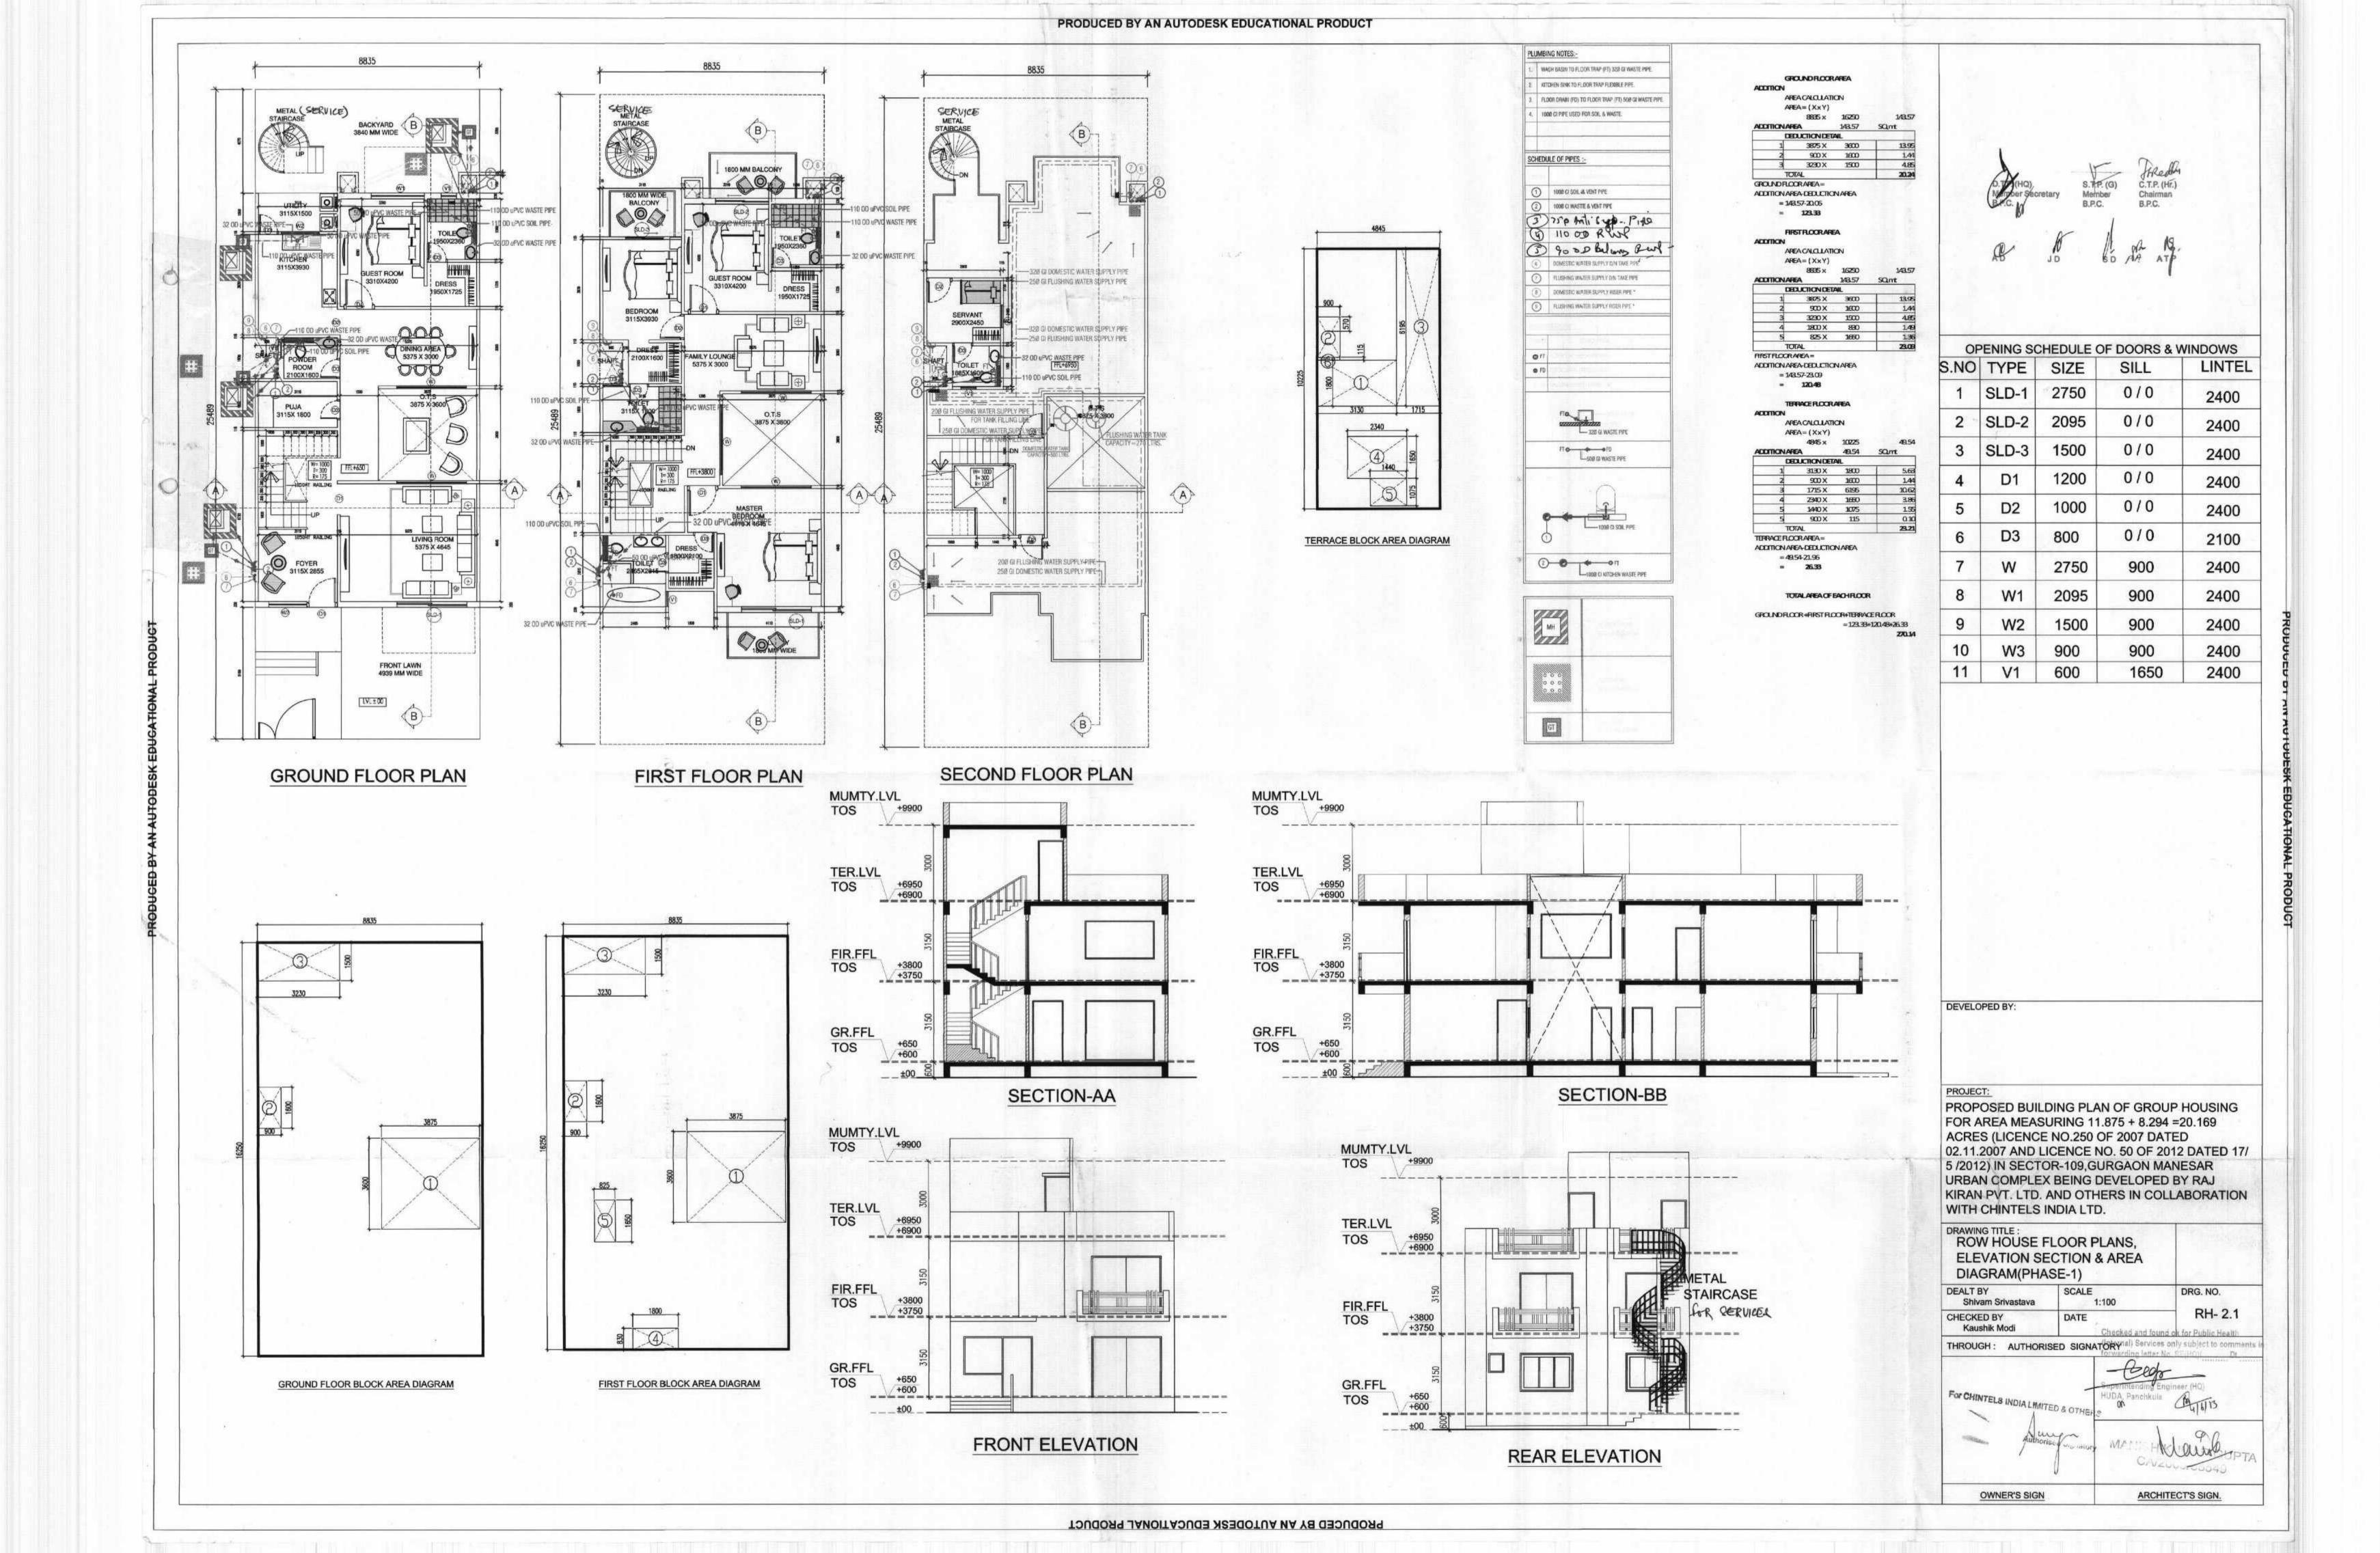


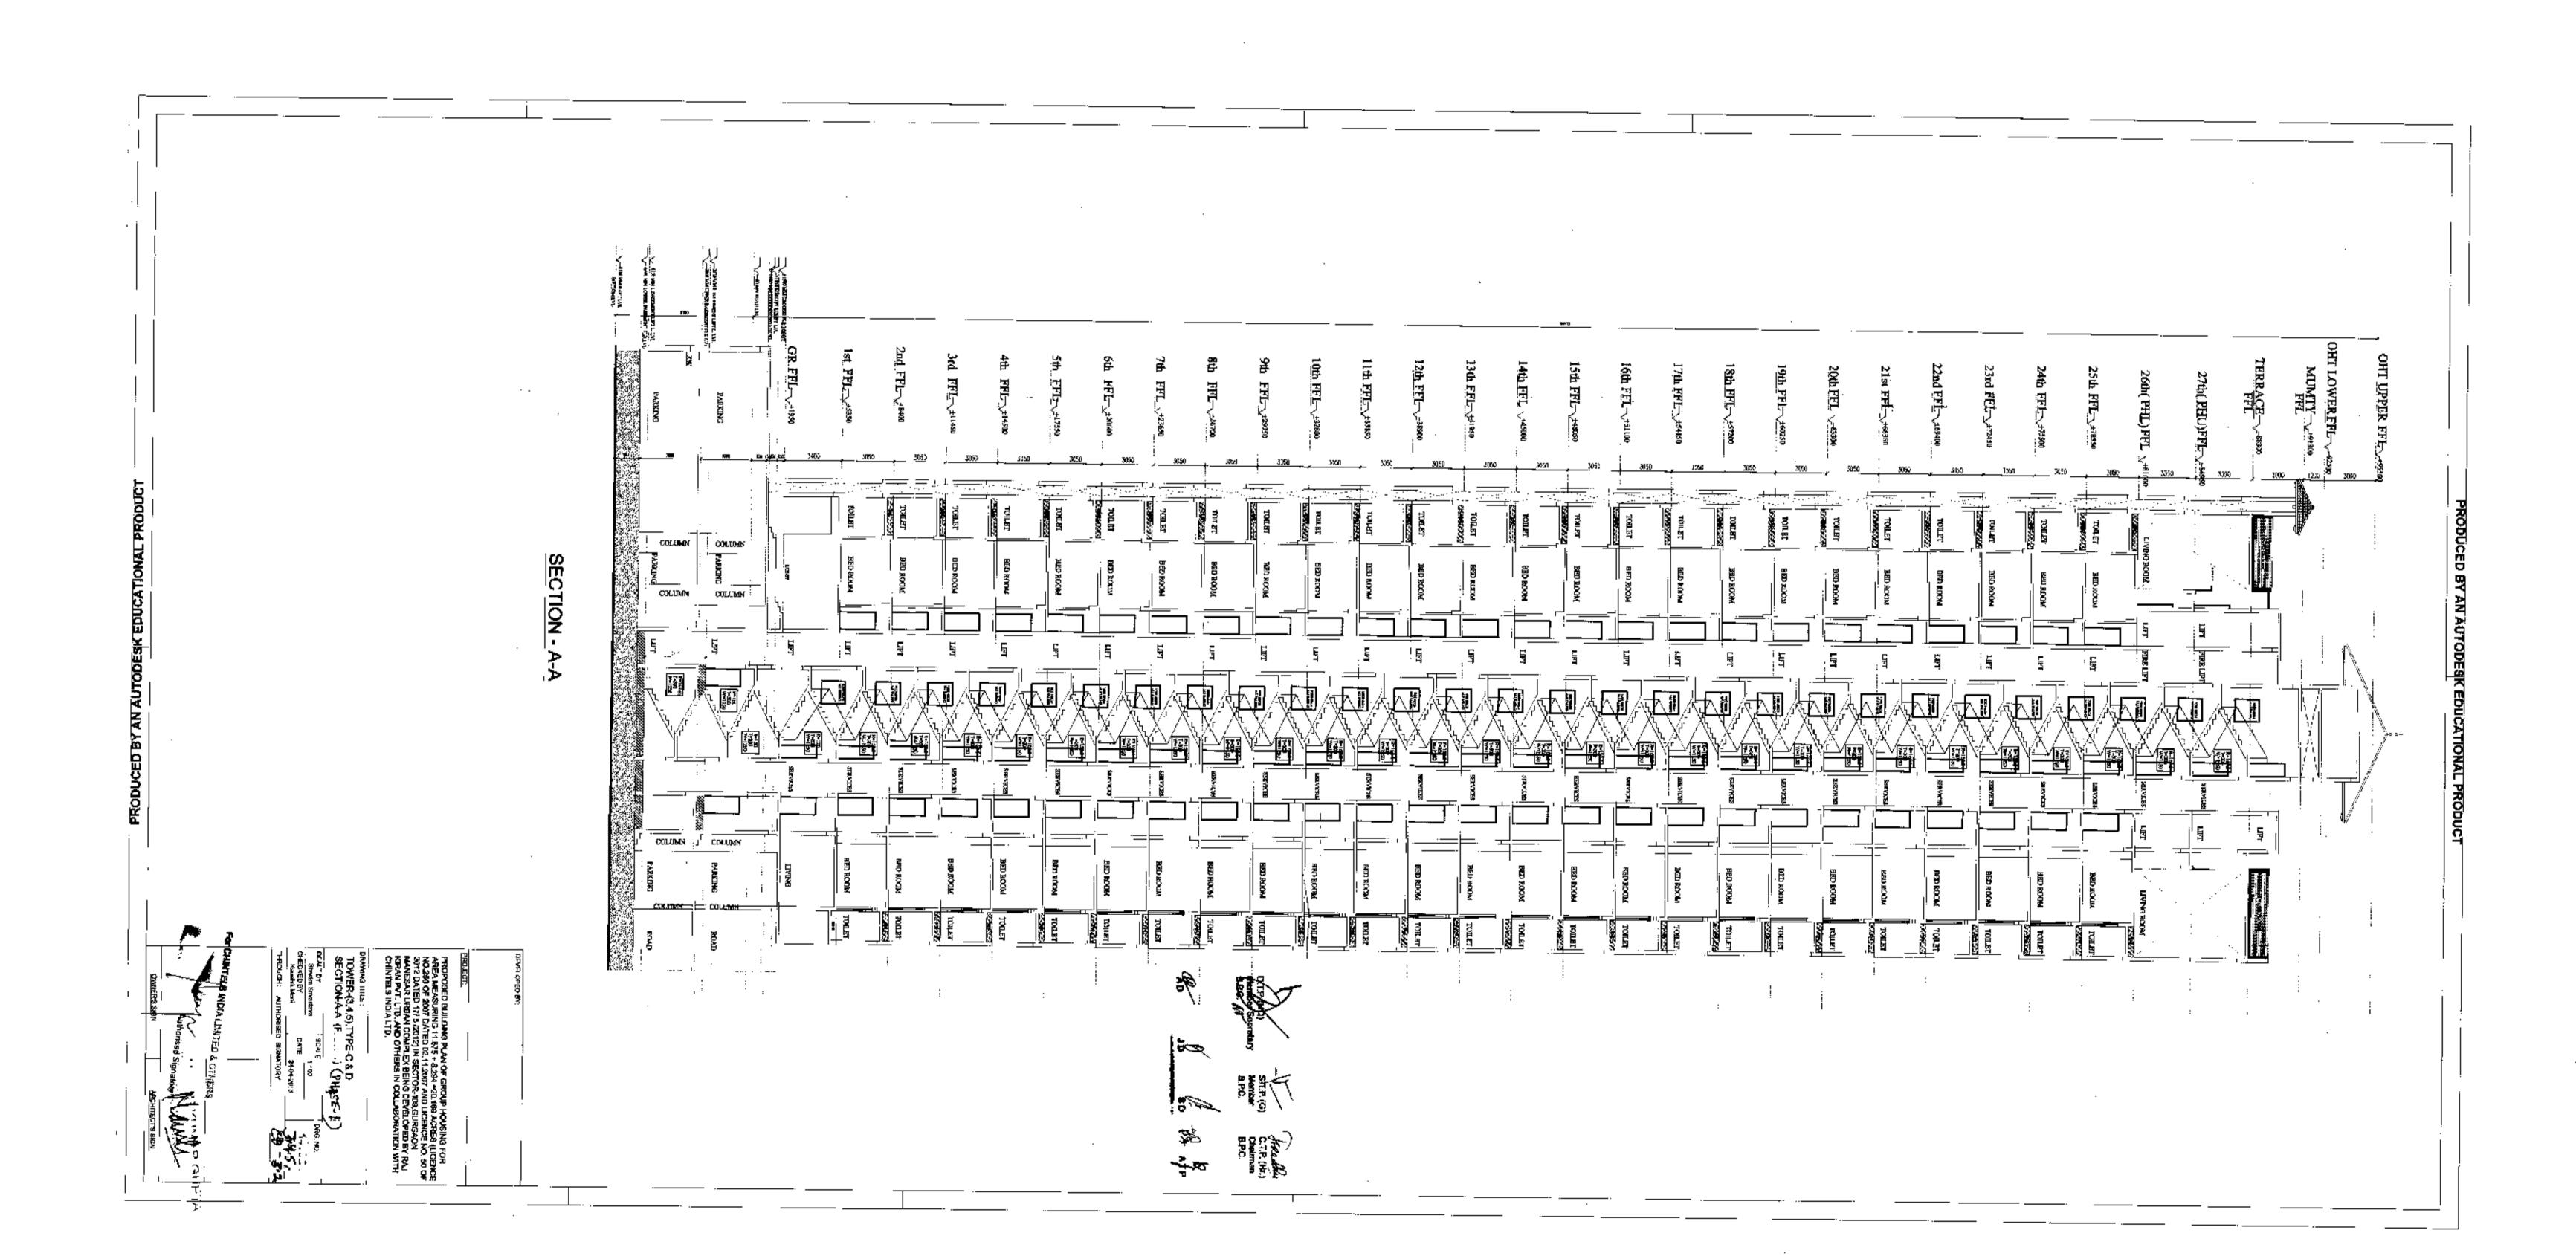


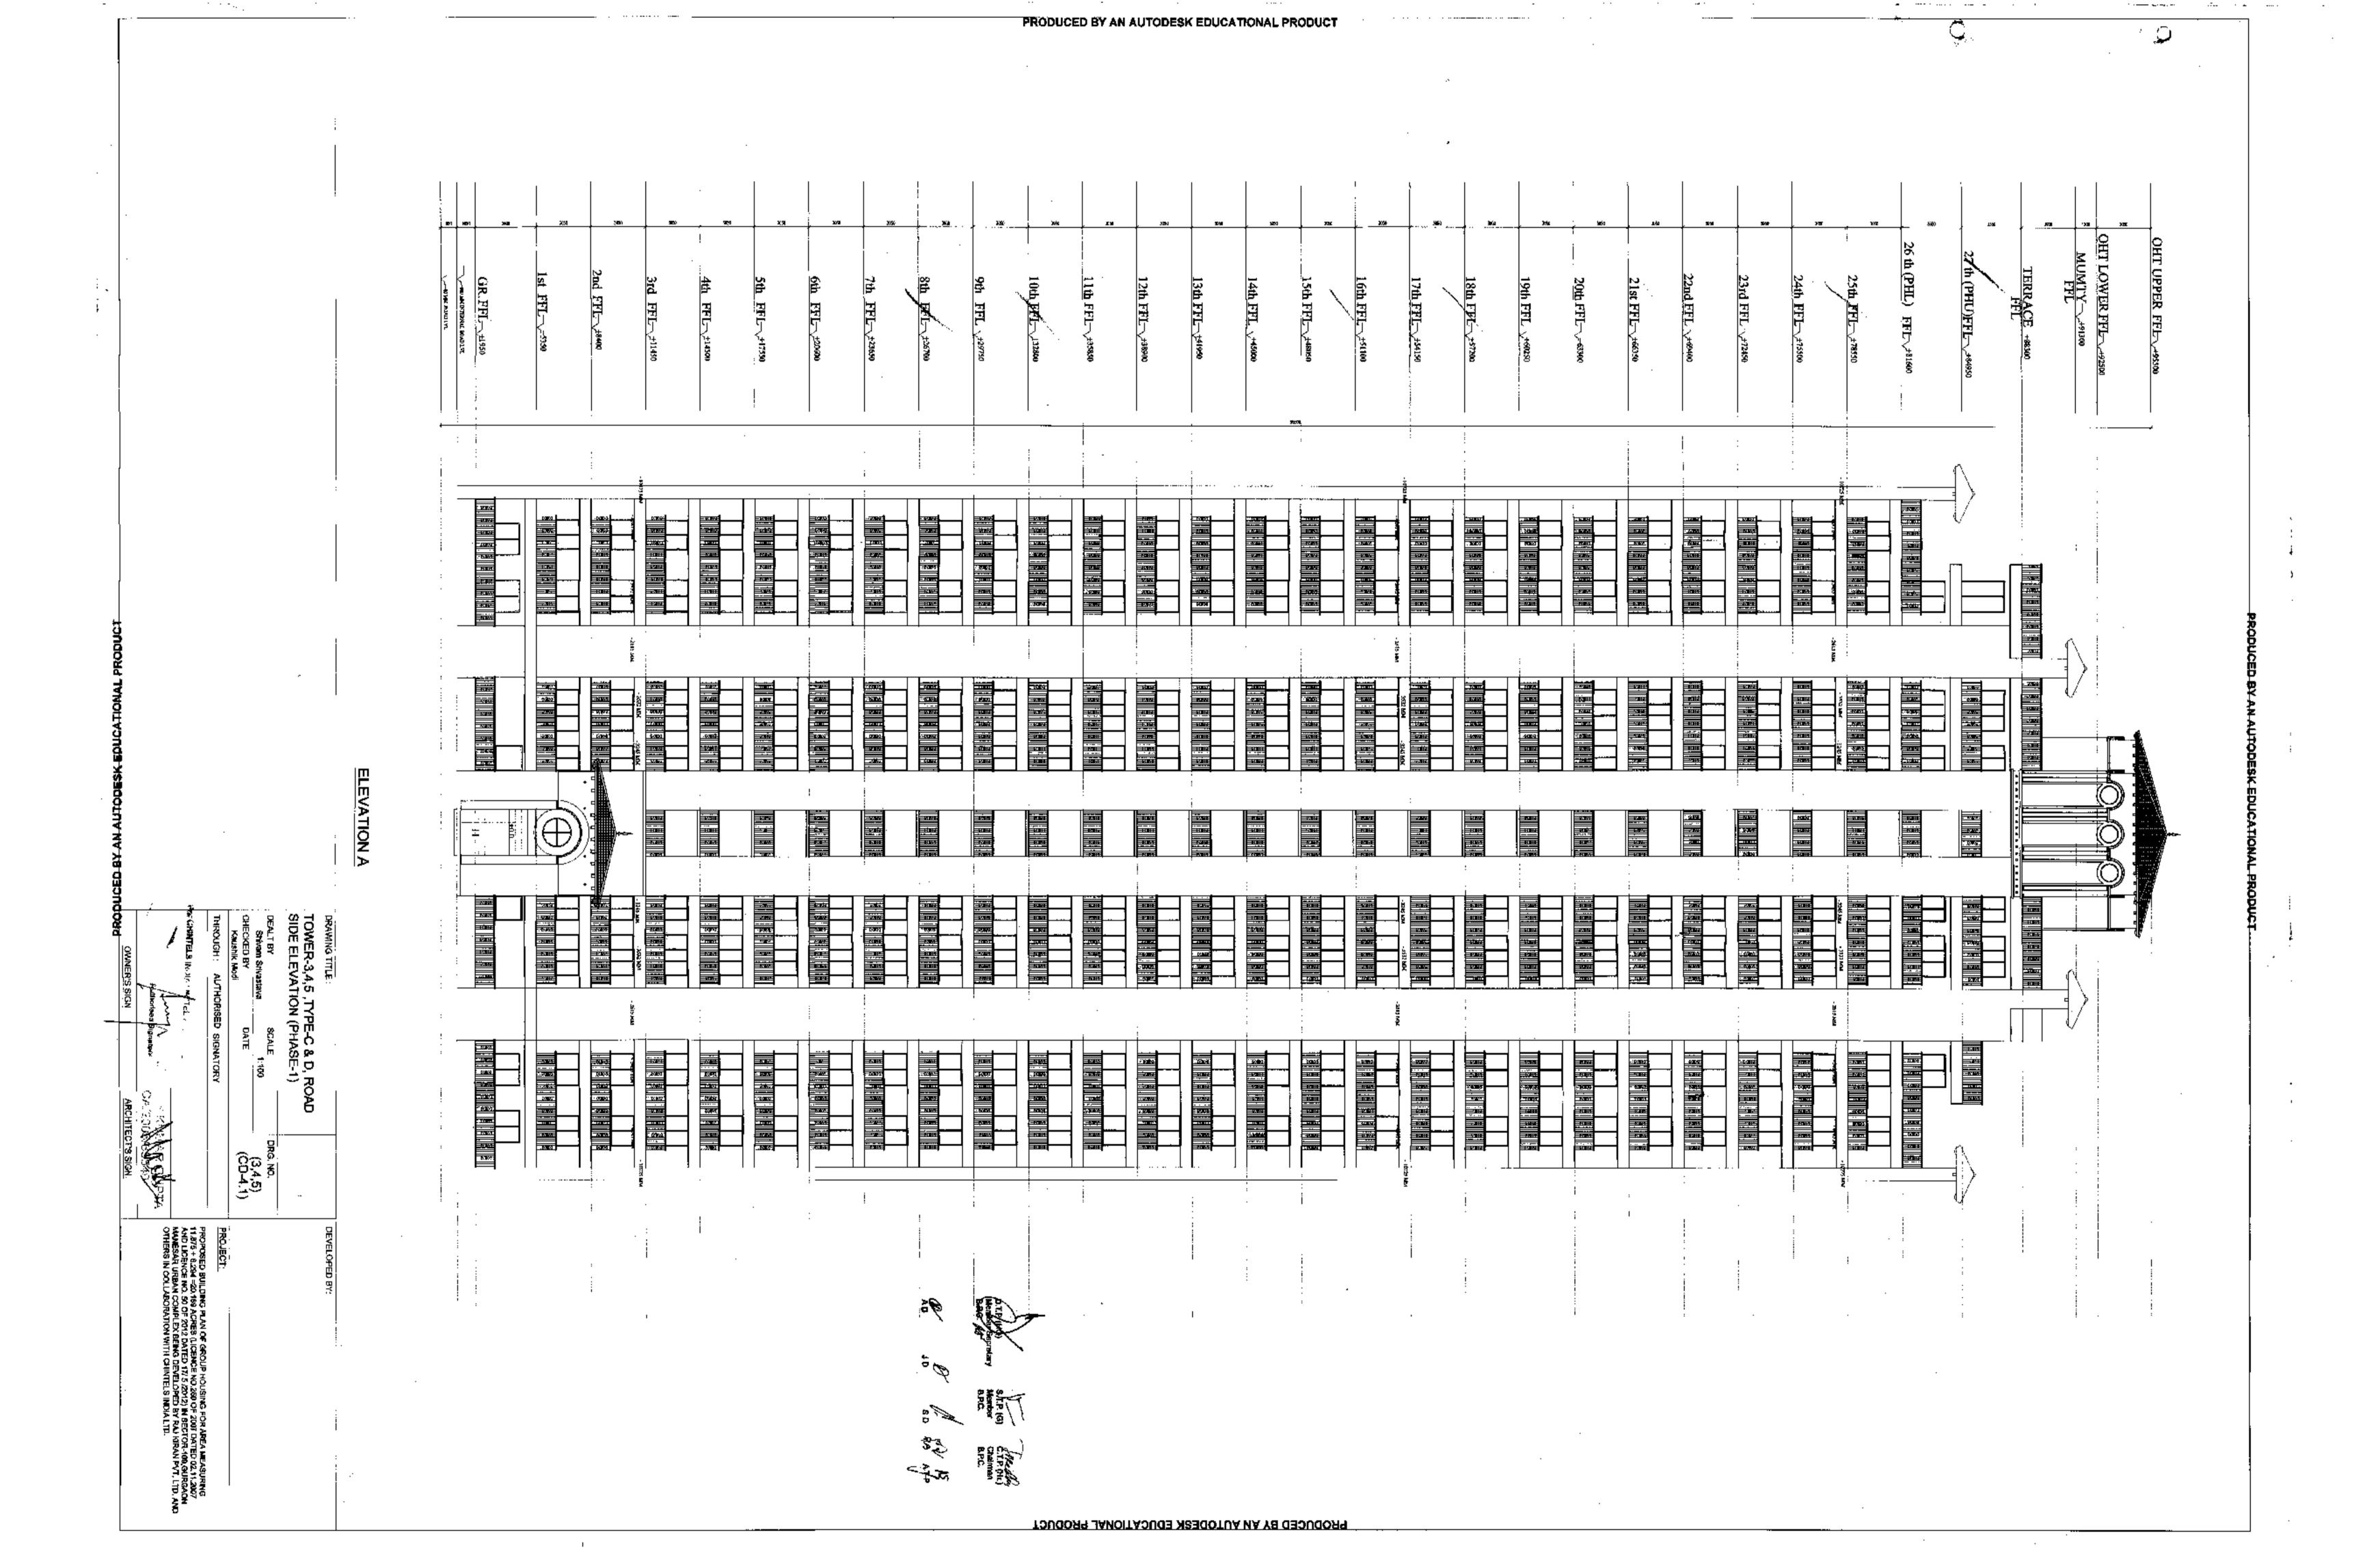17/A PROPOSED BUILDING PLAN OF GROUP HOUSING FOR AREA MEASURING
11.875 + 8.294 = 20.189 ACRES (LICENCE NO.250 OF 2007 DATED 02.11.2007
AND LICENCE NO. 50 OF 2012 DATED 17/5 2012) IN SECTIOR-109,GURGAON
MANESAR URBAN COMPLEX BEING DEVELOPED BY RAJ KIRAN PVT. LTD. AND
OTHERS IN COLLABORATION WITH CHINTELS INDIALTD.
ARCHITECT'S SIGN. (3,4,5) (CD-4.2) 88 \$ 3 C.T.P. (Hr.) Chairman B.P.C.




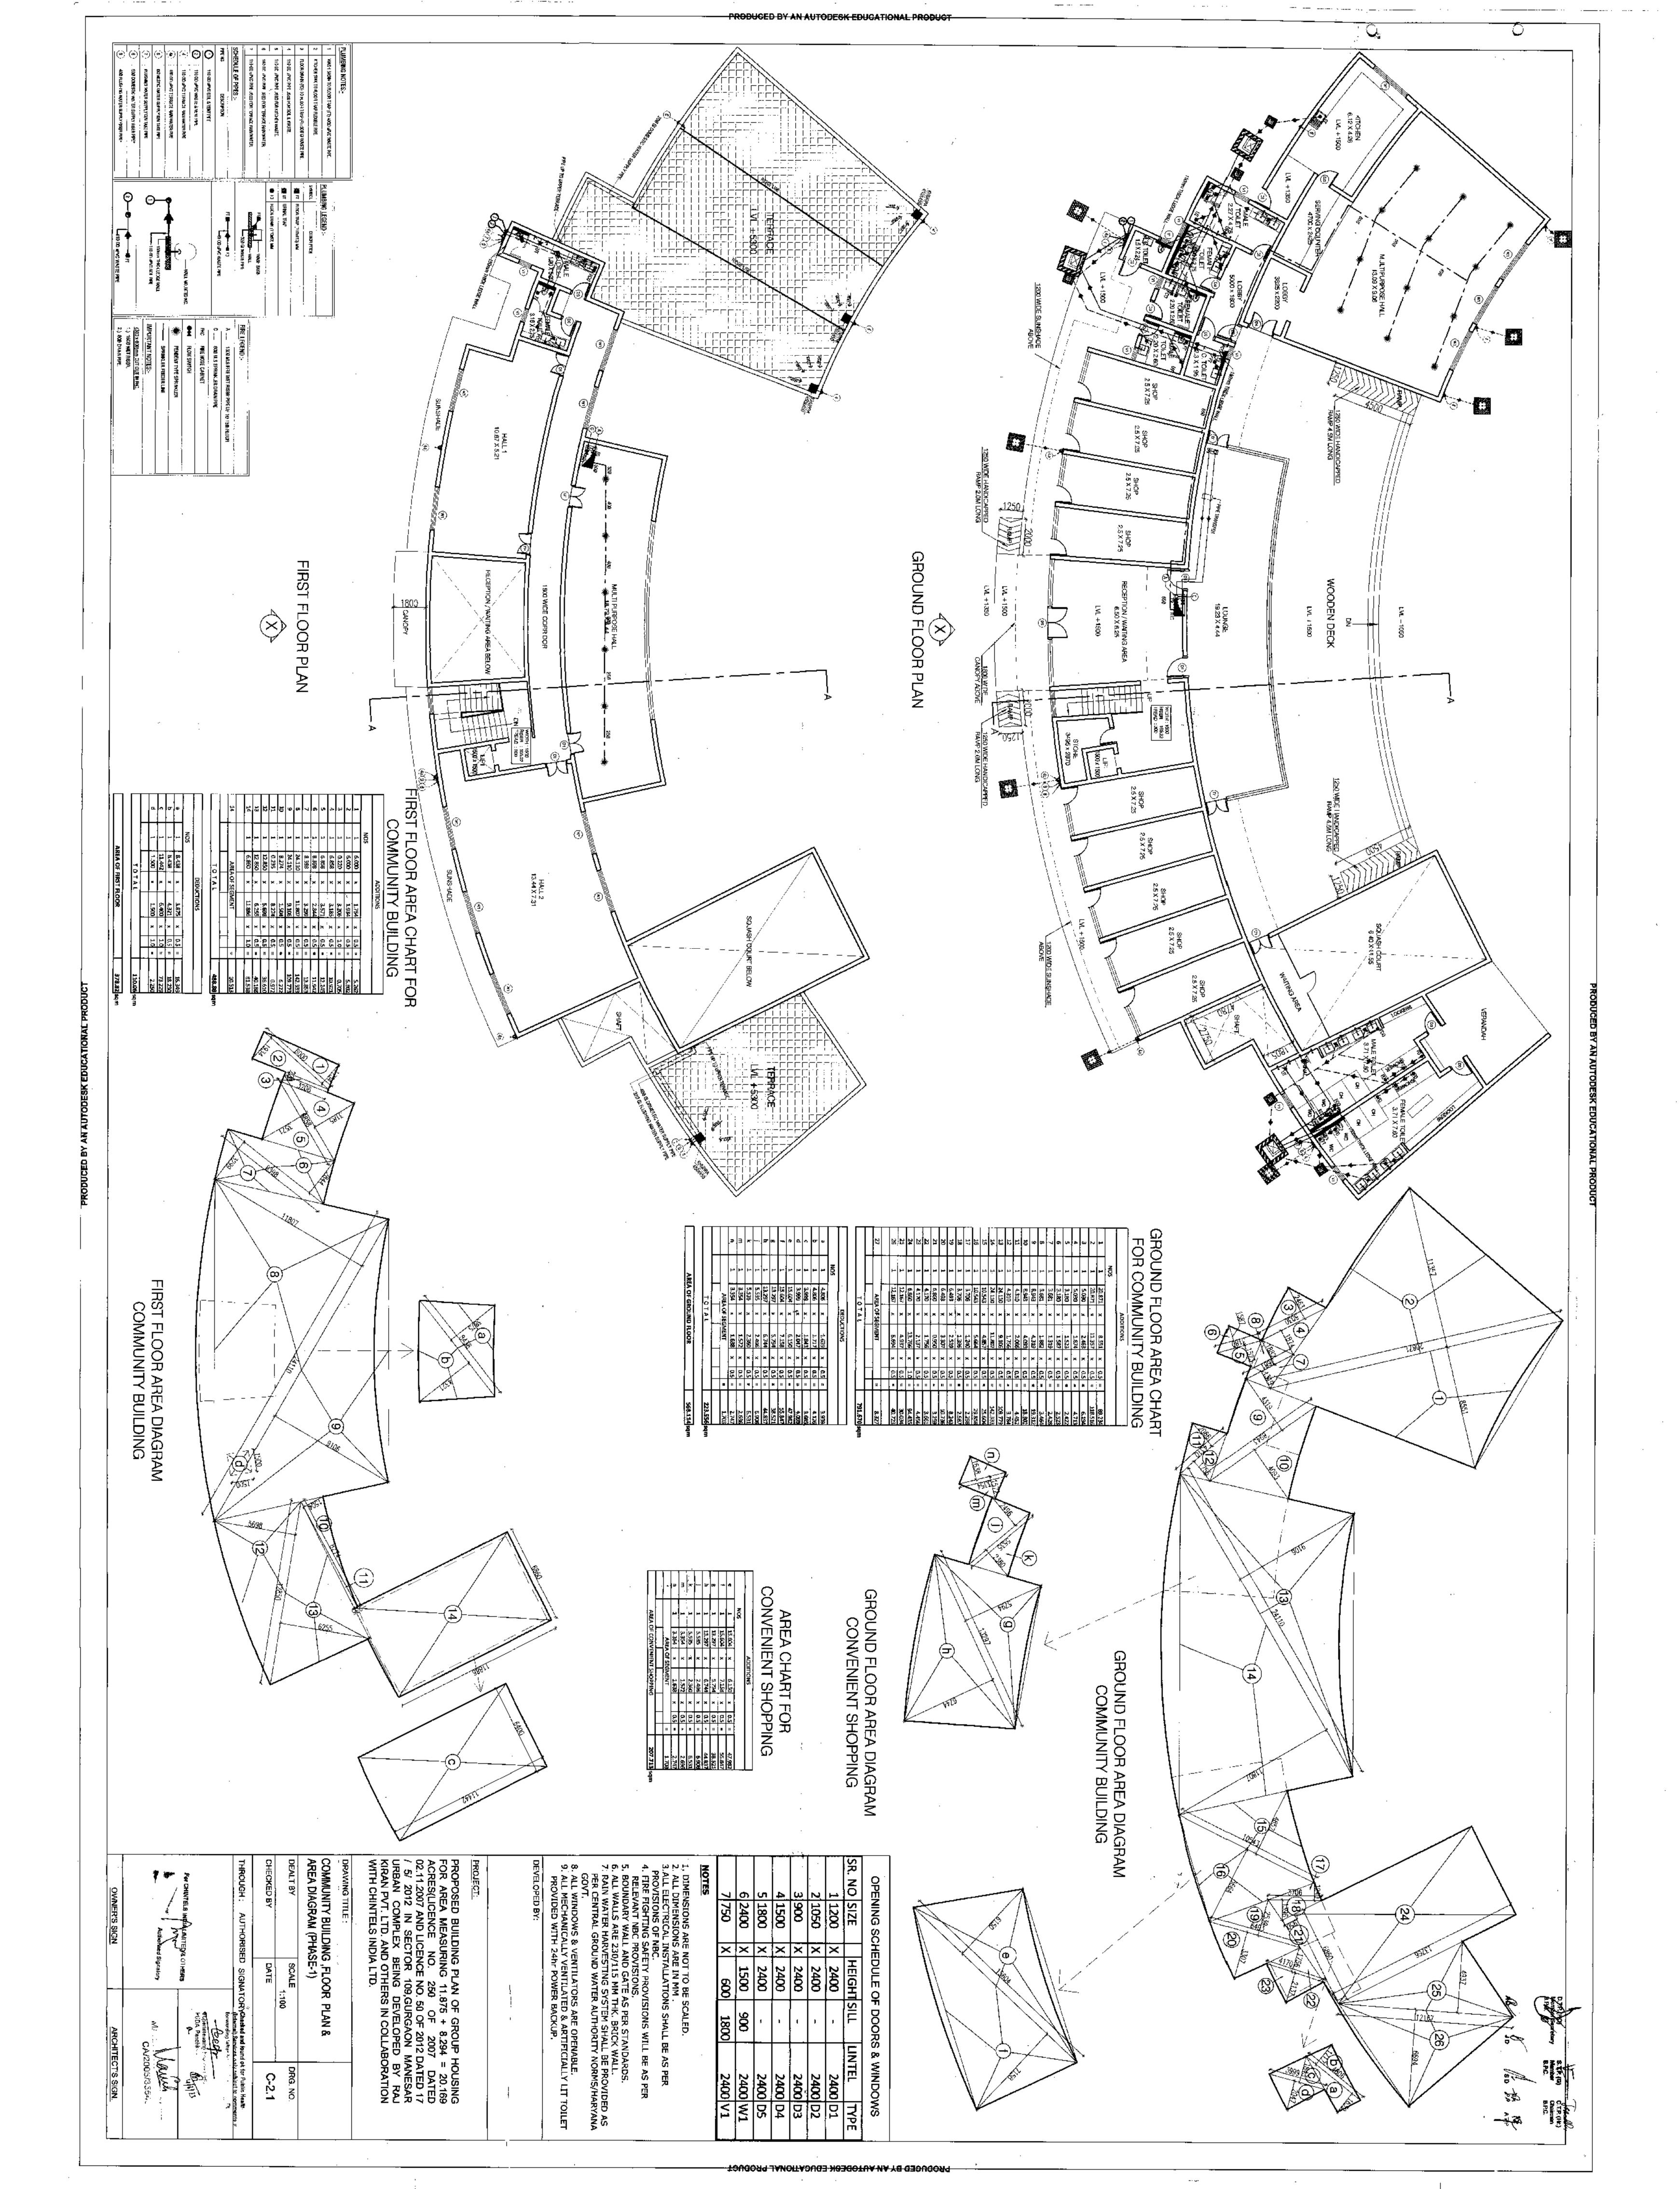

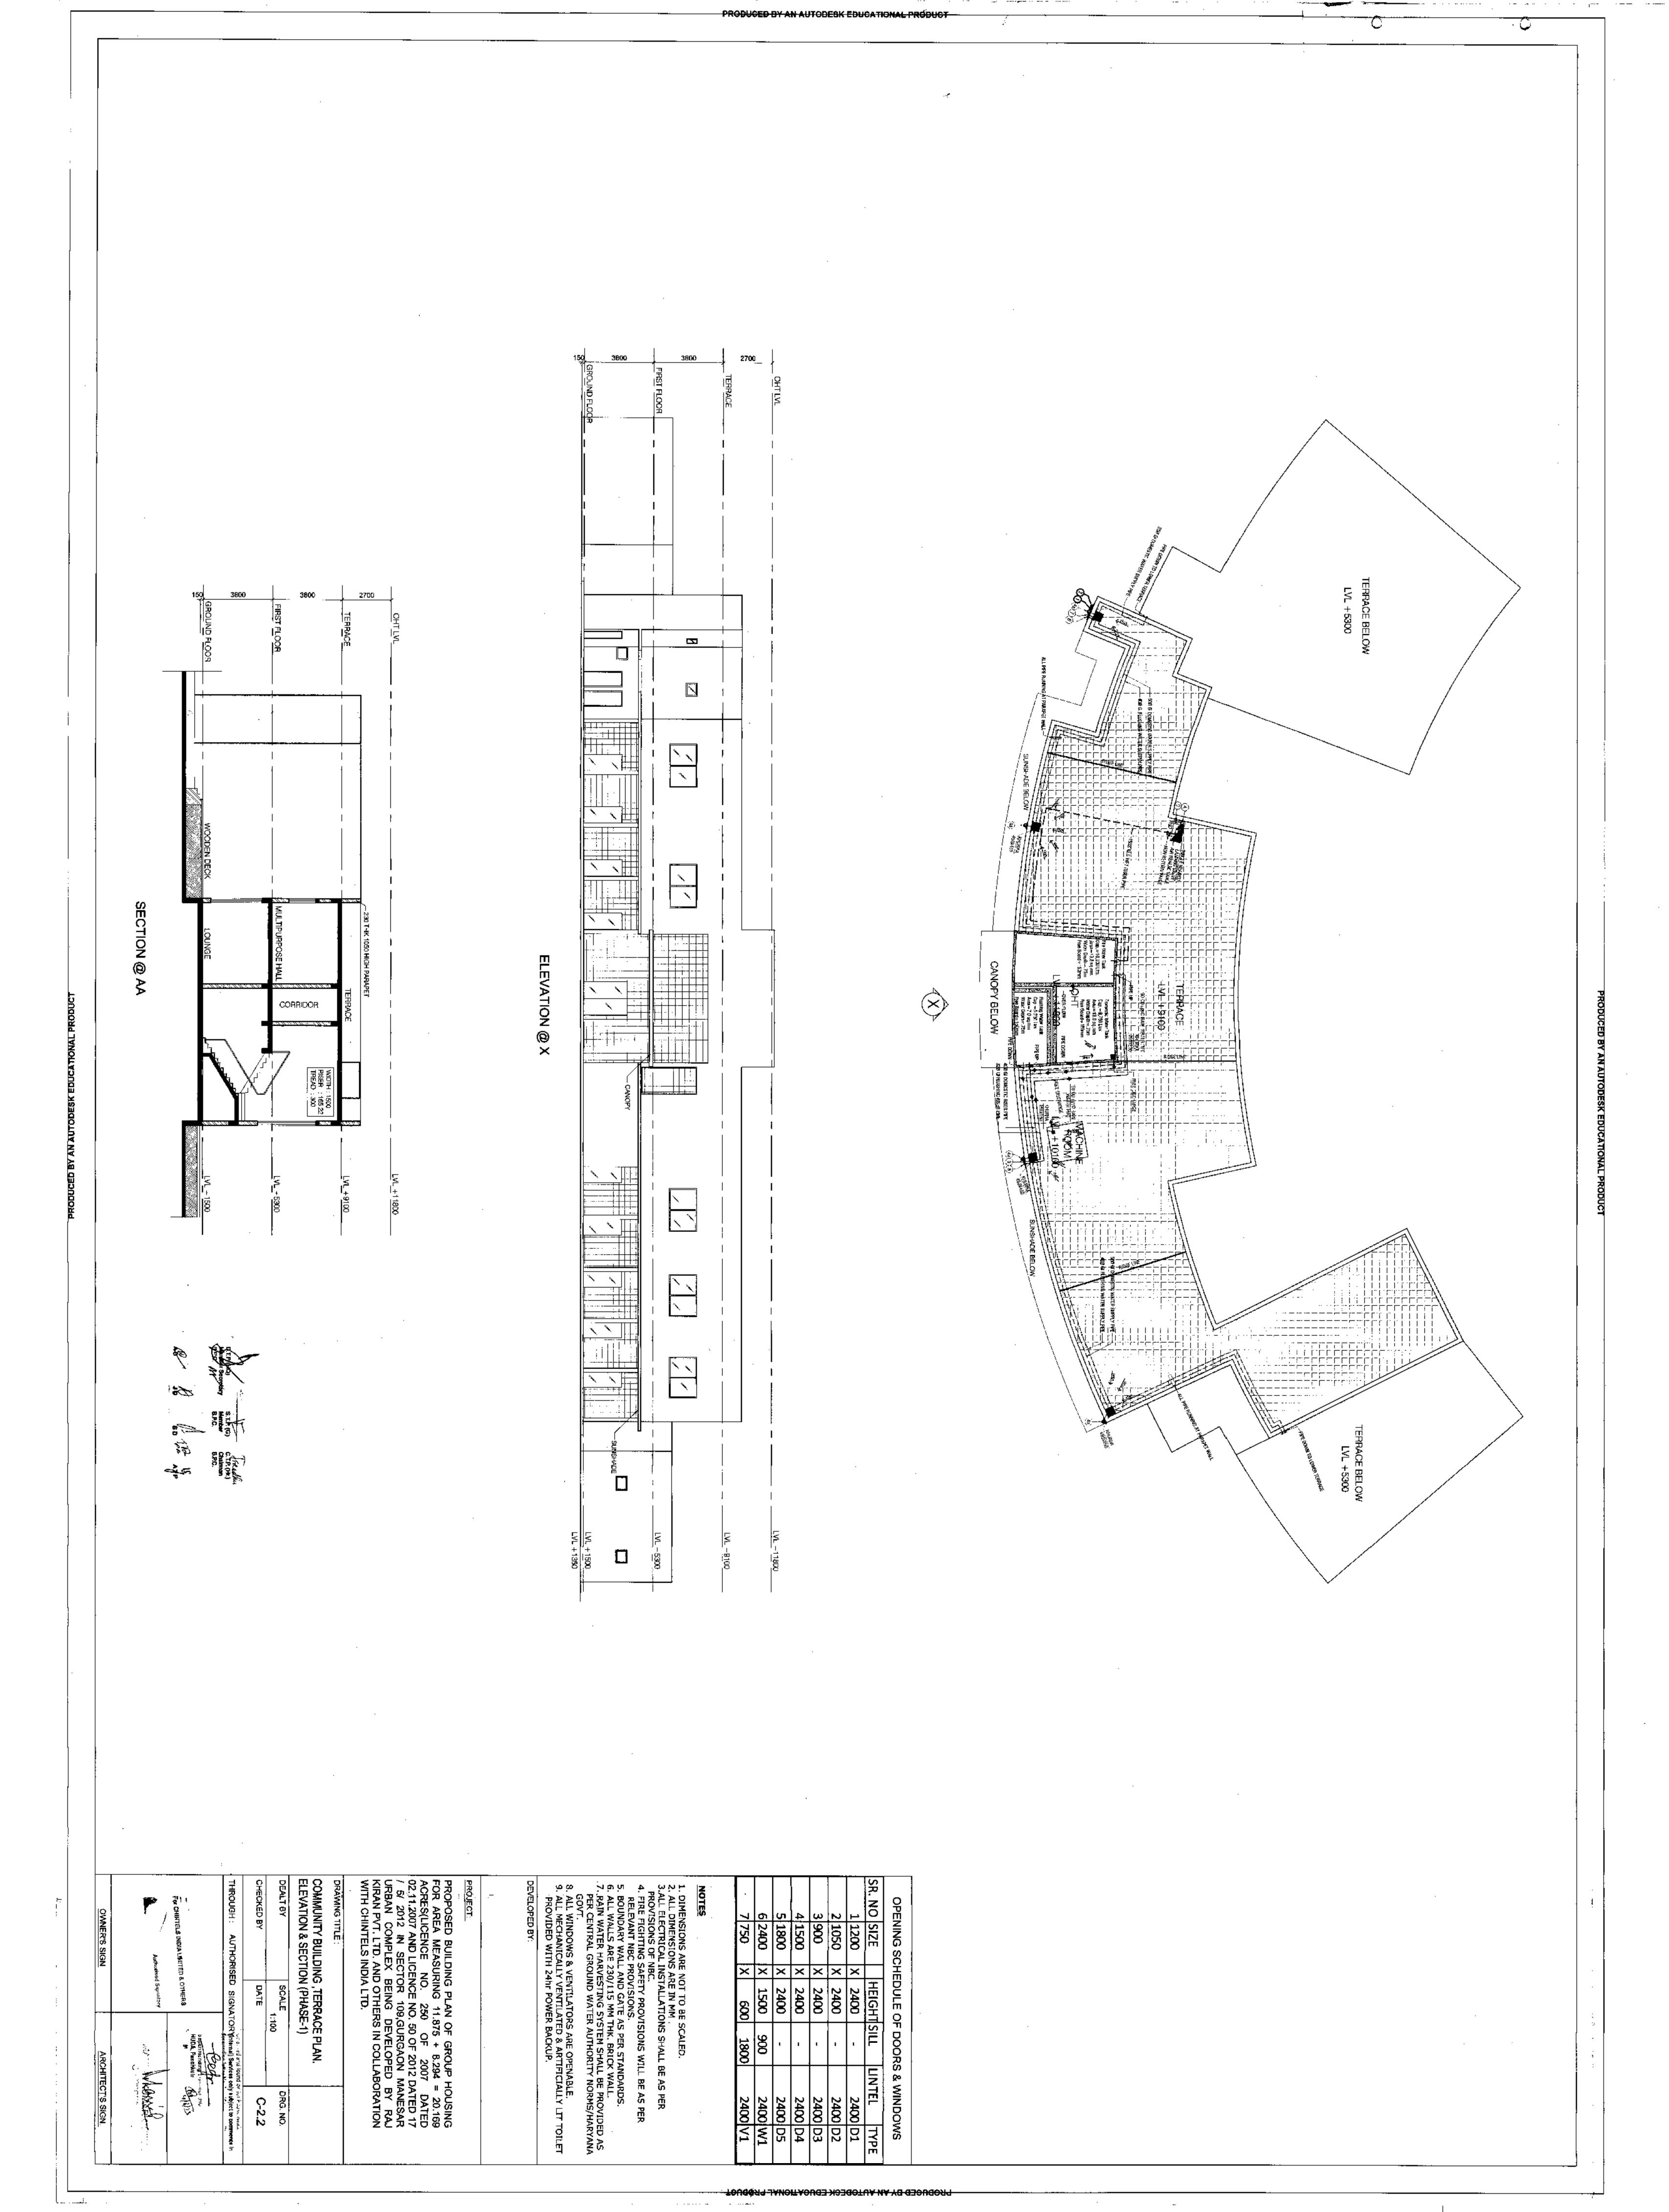

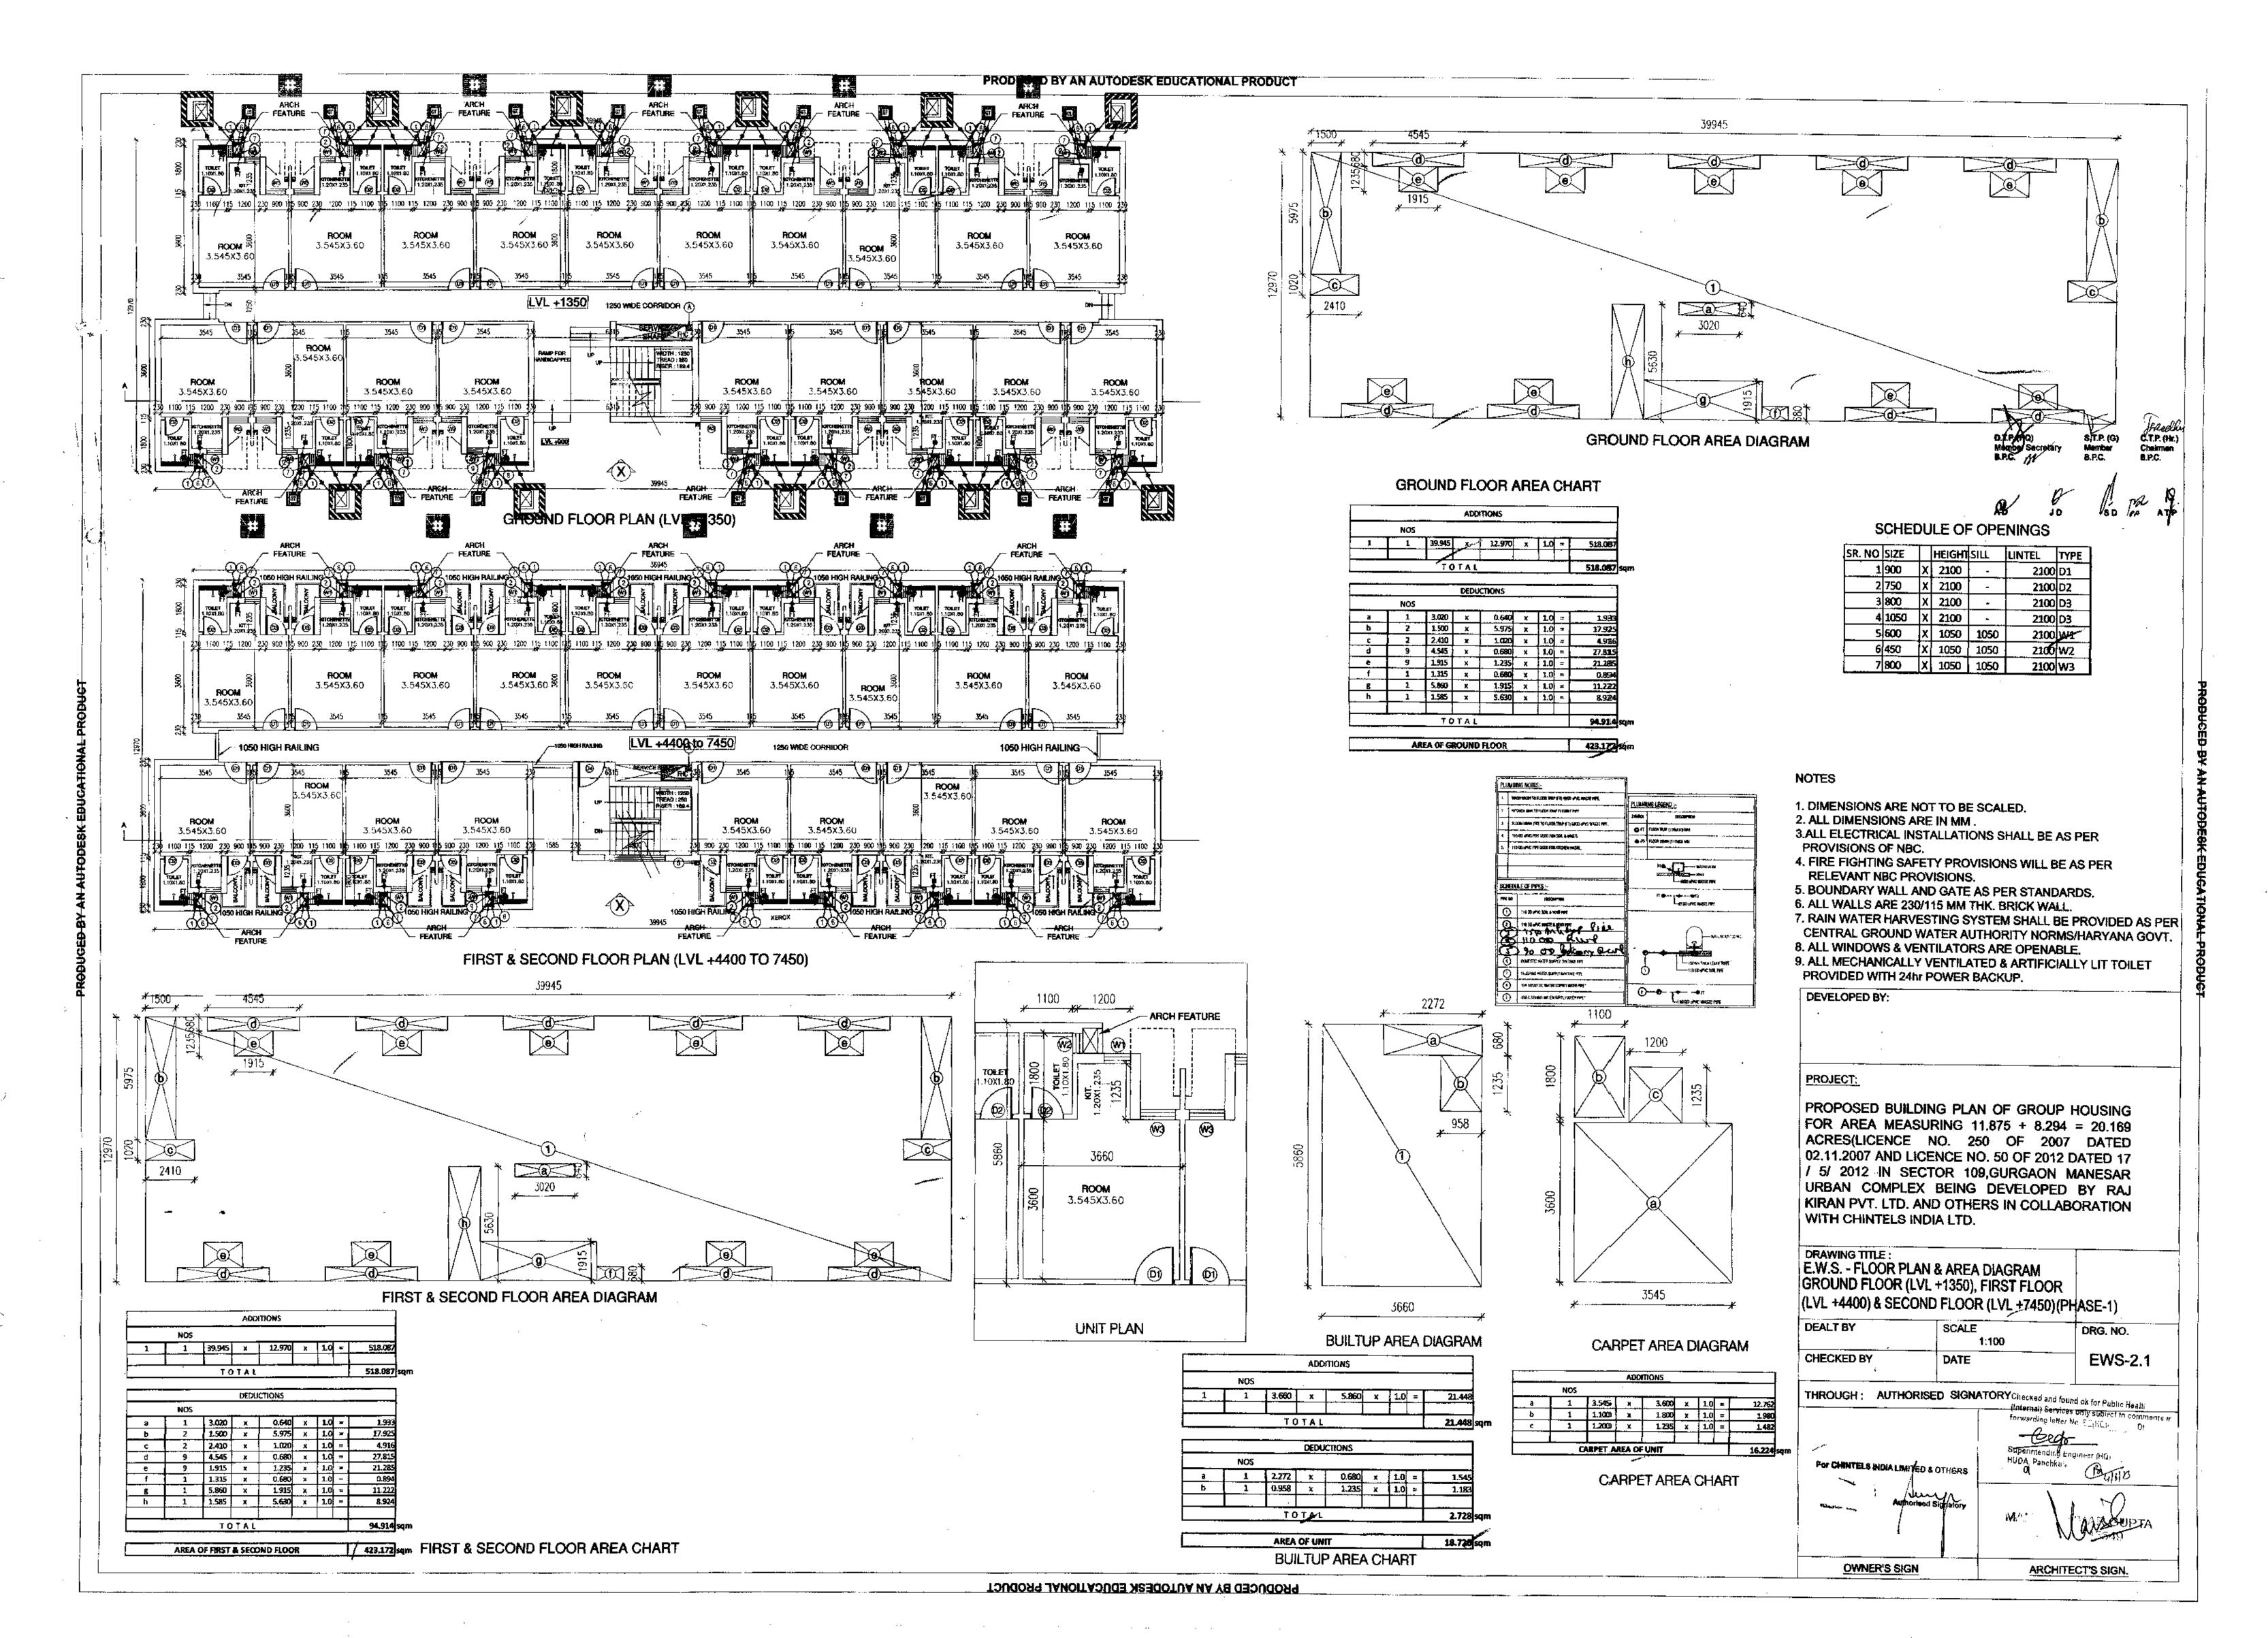


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**ELEVATION @ X** 

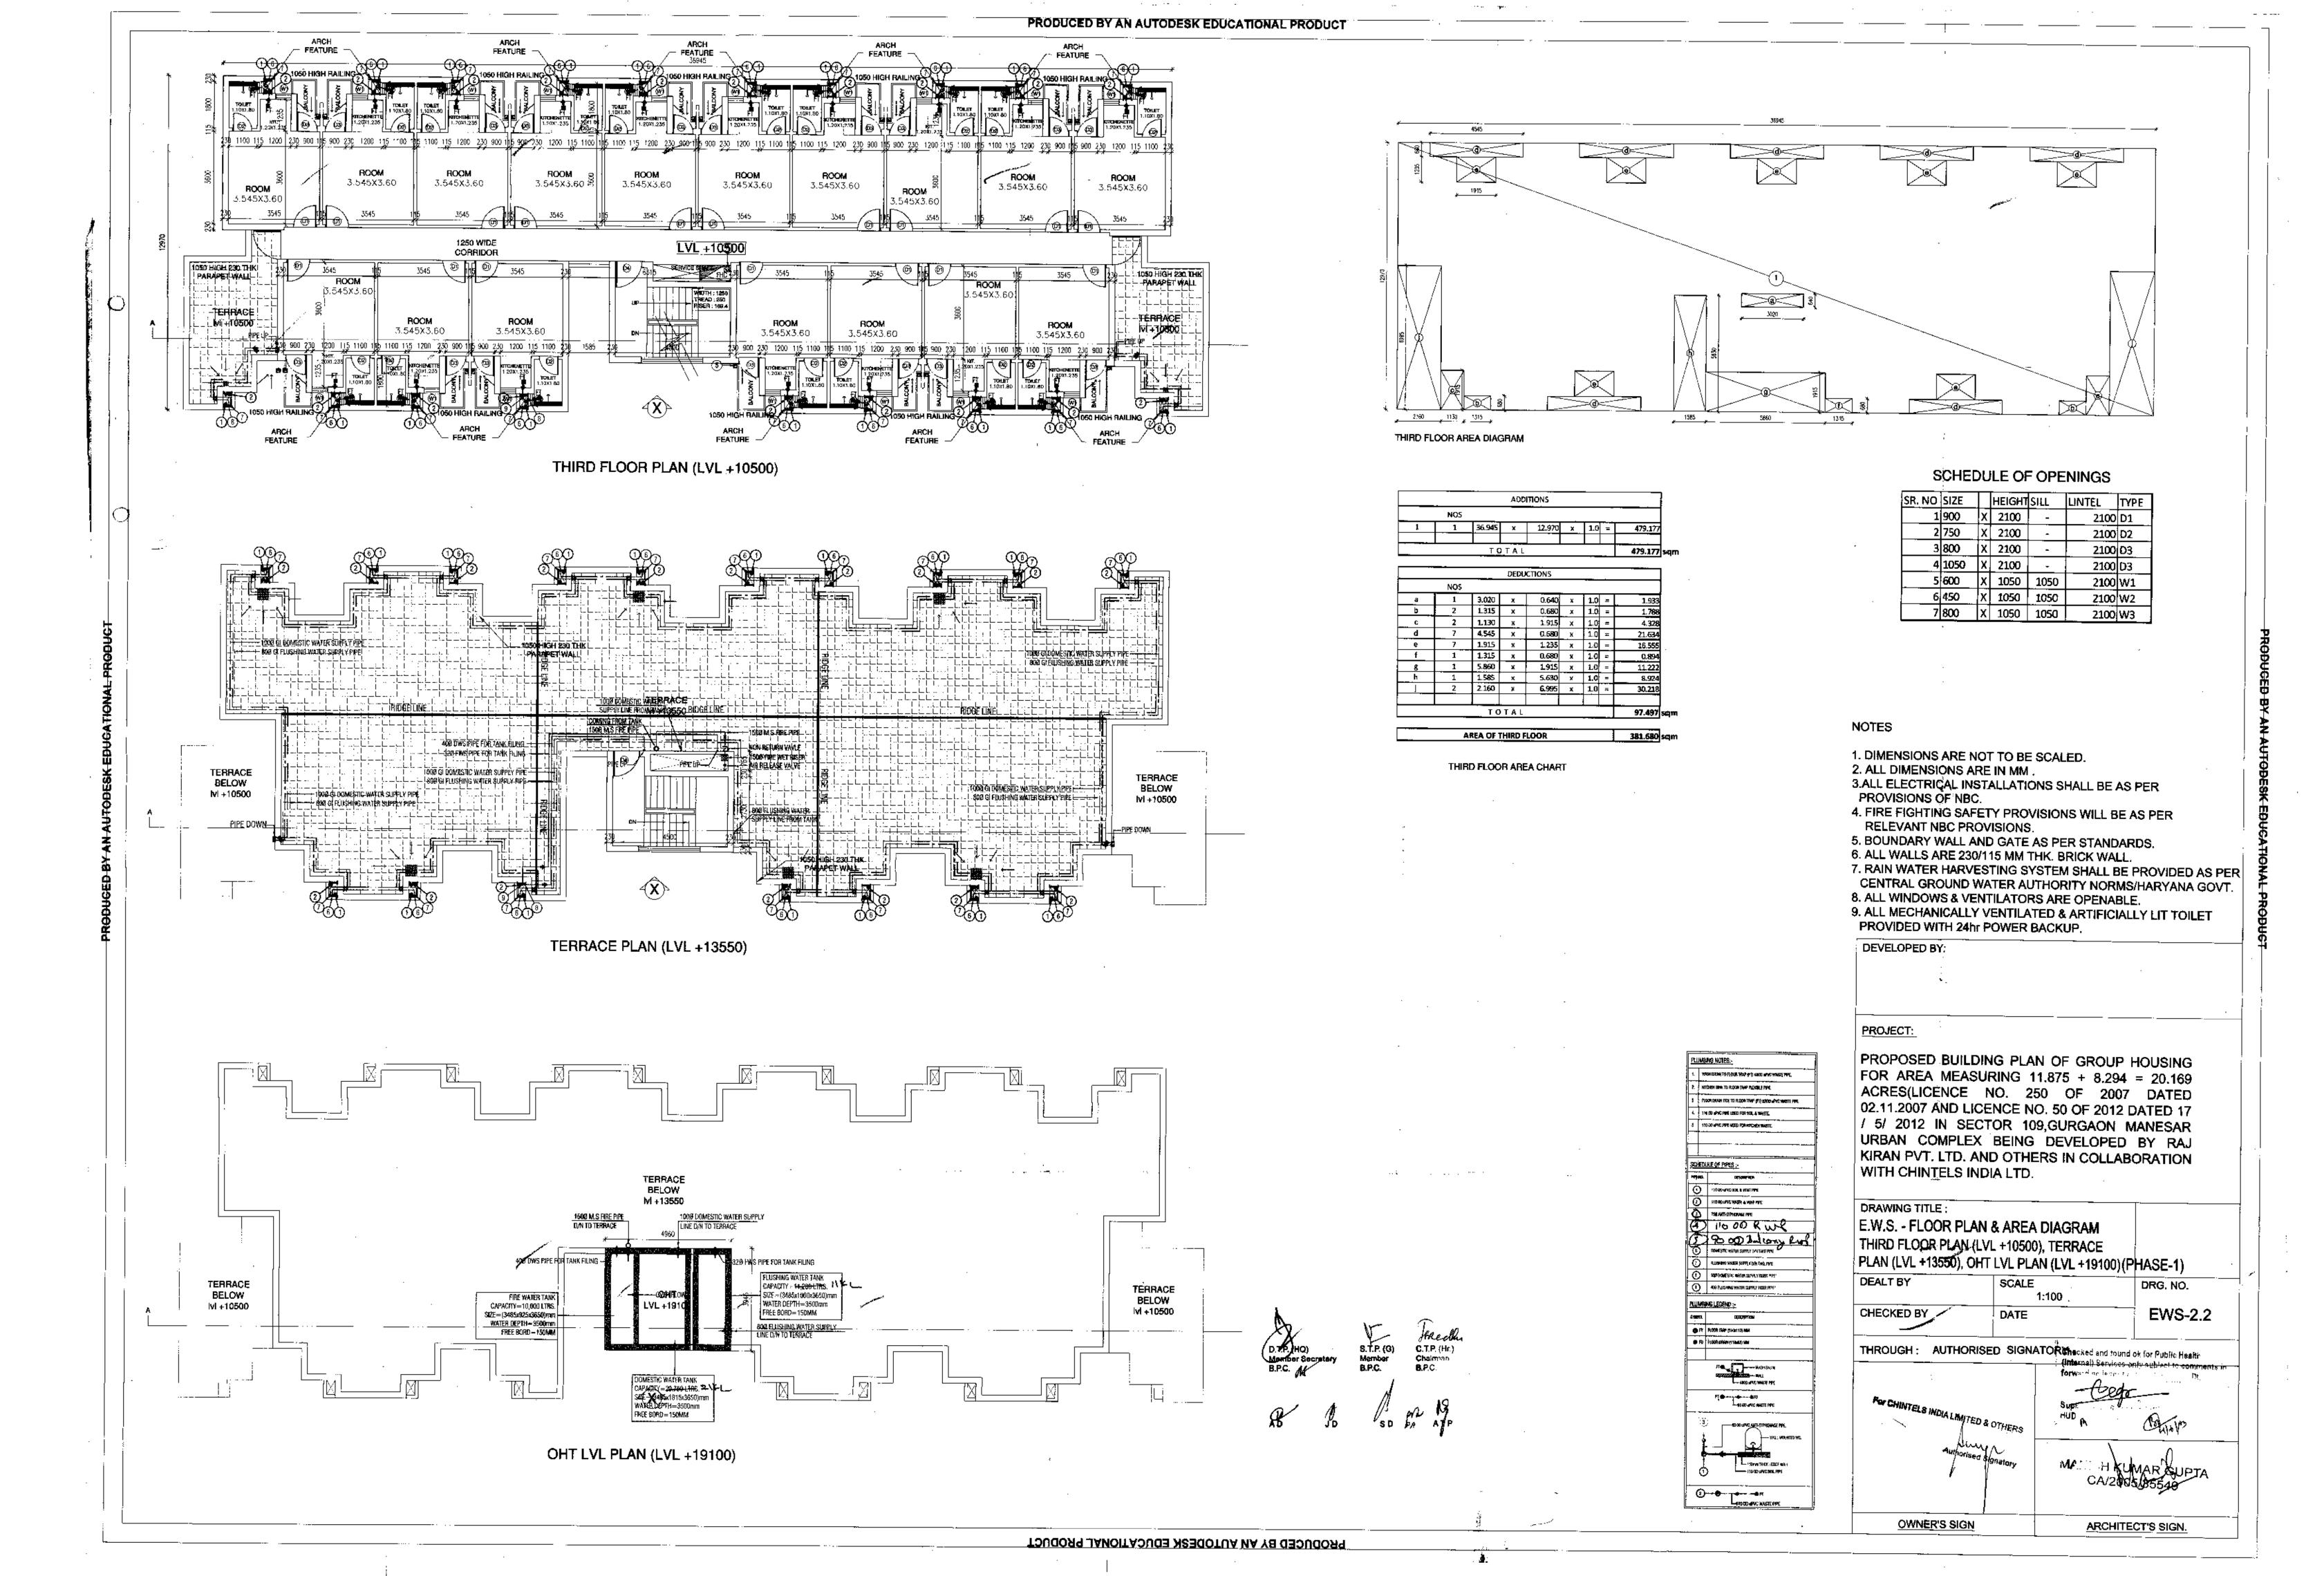

SECTION @ A

D.T.P. (HQ)

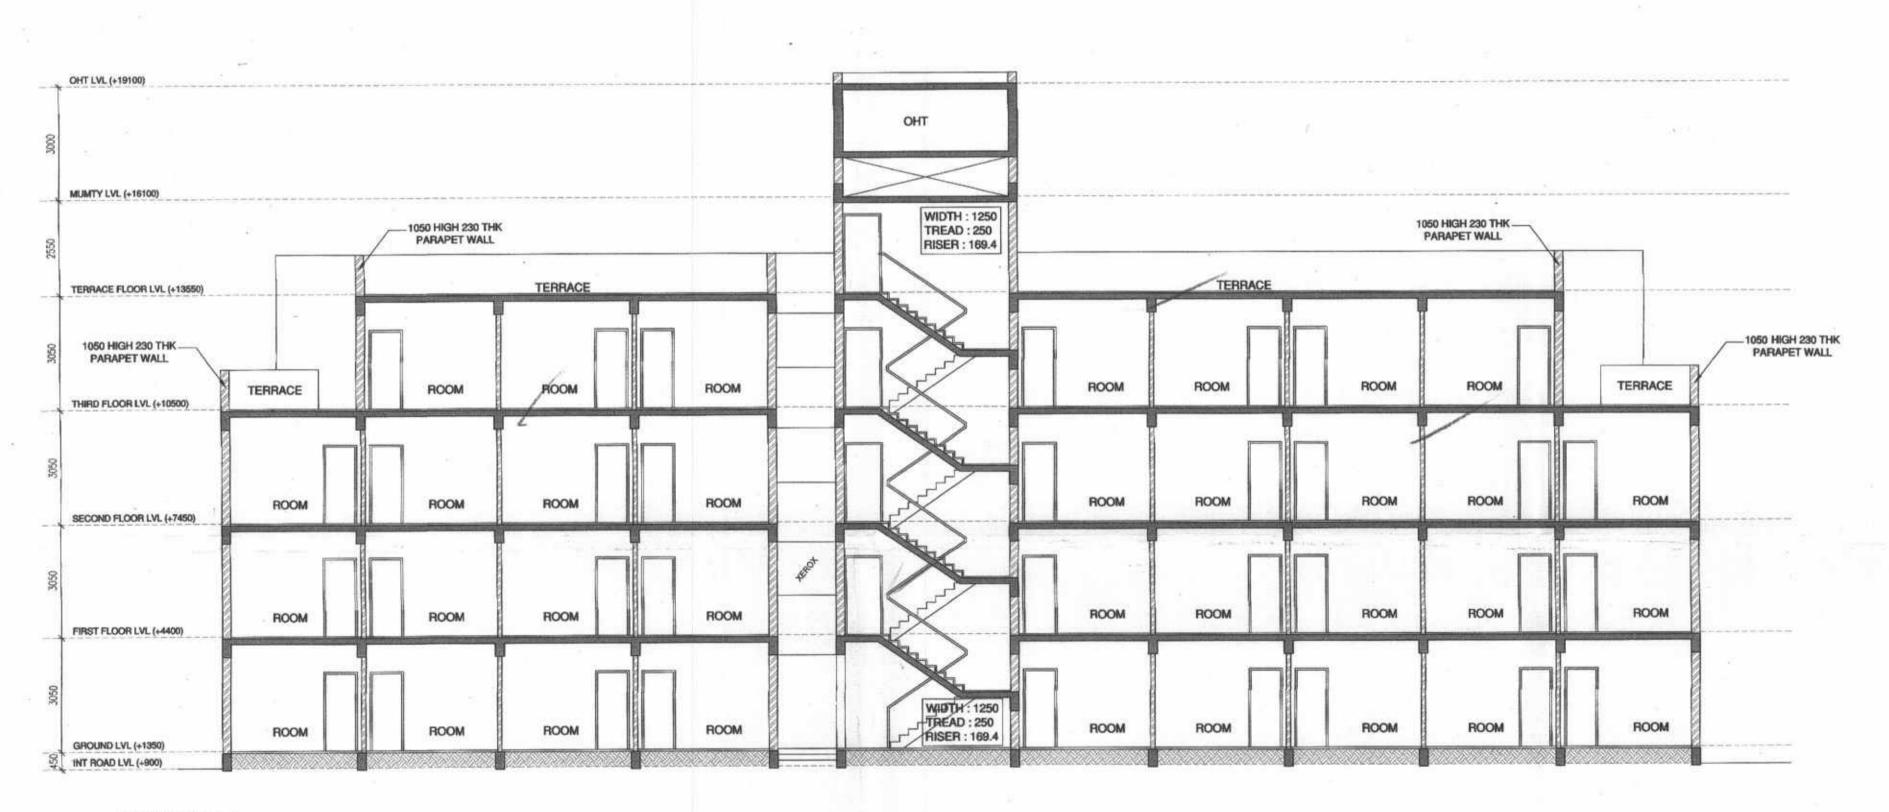All Sp. C. M. S.T.P. (G)

B.P.C. Member B.P.C.

B.P.C.

B.P.C.

B.P.C.

B.P.C.

B.P.C.

B.P.C.

A.P.

B.P.C.

B.P.C.

A.P.

A.P.

A.P.

A.P.

A.P.

A.P.

A.P.

A.P.

B.P.C.

B.P.C

### IOTES

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DEVELOPED BY:

PROJECT:

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DRAWING TITLE :

OWNER'S SIGN

E.W.S. - SECTION & ELEVATION (PHASE-1)

DEALT BY	SCALE 1:100	DRG. NO.
CHECKED BY	DATE	EWS-2.3
THROUGH: AUTH	ORISED SIGNATORY	
	TED & OTHERS	
For CHINTELS INDIA LIMI	/	
a a	horised Signatory	N C GUPTA

ARCHITECT'S SIGN.

PRODUCED BY AN AUTODESK EDUCATIONAL PRODUCT