

**ZONING PLAN OF GROUP HOUSING COLONY AREA MEASURING 11.125 ACRES (LICENSE NO. 87 OF 2013 DATED 11-10-2013) IN SECTOR-89-A, GURGAON MANESAR URBAN COMPLEX BEING DEVELOPED BY DALE DEVELOPERS PVT. LTD. AND OTHERS IN COLLABORATION WITH VATIKA LTD.**

LC-2805

**FOR THE PURPOSE OF RULE 38(xiii) AND 48 (2) OF THE PUNJAB SCHEDULED ROADS AND CONTROLLED AREAS RESTRICTION OF UNREGULATED DEVELOPMENT RULES,1965.**

**1. SHAPE & SIZE OF SITE**

The shape and size of the Group Housing Colony is in accordance with the densification plan shown as A to H as confirmed by DTP, Gurgaon into Encls. No.3245 dated 17.07.2013.

**2. TYPE OF BUILDING PERMITTED**

The type of building permitted on site shall be buildings designated in the form of Rettad development for residential purpose or any ancillary or appurtenant building including community facilities, public amenities and public utility as may be prescribed and approved by the Director General, Town and Country Planning, Haryana.

**3. GROUND COVERAGE AND FAR**

a. Building shall only be permitted in the portion of the site marked as buildable zone and no where else.

b. The maximum coverage on ground floor shall be 35% and that on subsequent floors shall be 30% on the area of 10.2850 acres.

c. The maximum FAR shall not exceed 175 on the area of 10.2850 acres. However, it shall not include community buildings which shall be as per the prescribed norms, the building plan of which shall have to be got approved from the Director General, Town and Country Planning, Haryana.

**4. HEIGHT OF BUILDING**

The height of the building block, subject to course to the provision of the site coverage and FAR, shall be governed by the following:

a. The maximum height of the buildings shall not be more than as allowed by National Airport Authority and shall not exceed 1.5 times (the width of the road abutting) plus the total open space.

b. If a building sits on two or more streets of different widths, the buildings shall be denied to face upon the street that has the greater width and the height of the buildings shall be regulated by the width of that street and may be continued to this height to a depth of 24M, along the narrow street.

c. Building/Structures which rise to 39 meters or more in height shall be constructed if no clearance certificate has been obtained from the National Airport Authority.

d. All building(s) shall be constructed so as to maintain an intense distance not less the set back required for each building according to the table below:

S.NO.	HEIGHT OF BUILDING (in meters)	SET BACK / OPEN SPACE TO BE LEFT AROUND BUILDINGS (in meters)
1	10	3
2	15	5
3	18	6
4	21	7
5	24	8
6	27	9
7	30	10
8	33	11
9	36	12
10	45	15
11	50	14
12	55 & above	16

e. To ensure fire safety and structural stability of the buildings of more than 60 meters in height, the developer shall submit the structural drawings duly vetted from reputed institute like IIT Delhi, IIT Bombay, IITC Chandigarh or NIT Kurukshetra etc. Fire Fighting Scheme needs to be written by the Institute of Fire Engineers at Nagpur. These certificates are to be obtained prior to starting the construction work at site.

f. If such interior or exterior open space is intended to be used for the benefit of more than one building belonging to the same owner, then the width of such open air space shall be the one specified for the tallest building as specified above.

**5. SUB-DIVISION OF SITE**

a. The site of the Group Housing Colony shall be governed by the Haryana Apartment Ownership Act.

b. The site shall not be sub divided or fragmented in any manner whatsoever.

**6. GATE POST AND BOUNDARY WALL**

Such Boundary wall, railings or their combination, hedges or fences along with gates and gate shafts shall be constructed as per design approved by DGTCP, Haryana. In addition to the gate/gates an additional wicket gate not exceeding 3.25 meters width may be allowed in the front and side boundary wall provided that the main gate shall be allowed to open on the sector road/public open space.

**7. DENSITY**

a. The minimum density of the population provided in the colony shall be 100 PPA and the maximum be 300 PPA on the area of 10.2850 acres.

b. For computing the density, the occupancy per main dwelling unit shall be taken as five persons and for service dwelling unit two persons per room or one person per 80 sq. feet of living area, whichever is more.

**8. ACCOMMODATION FOR SERVICE POPULATION**

Adequate accommodation shall be provided for domestic servants and other service population of FWS. The number of such dwelling units for domestic servants shall not be less than 10% of the number of main dwelling units and the carpet area of such a unit if attached to the main units shall not be less than 320 sqft. In addition 15% of the total number of dwelling units having a minimum area of 200 sq ft shall be earmarked for L.W.S category.

**9. PARKING**

a. Parking space shall be provided @ 1.5 Equivalent Car Space for each dwelling unit. These parking spaces shall be allotted only to the flat holders and shall not be allotted, leased, sold or transferred in any manner to the third party. The area for parking per car shall be as under:-

- i) Basement: 35 sqm.
- ii) Stalls: 30 sqm.
- iii) Open: 25 sqm.

b. At least 75% of the equivalent car spaces shall be provided in the form of covered parking. Further minimum 5% of the total parking will be made available to the CWS category flats.

c. The covered parking in the basement or in the form of multi level parking above ground level shall not be counted towards FAR. However, in case of multi level parking above the ground level the foot print of separate parking building block shall be counted towards ground coverage. In case of provision of mechanical parking in the basement floor/upper stories, the floor to ceiling height of the basement / upper floor may be maximum of 4.5 meter. Other than the mechanical parking the floor to ceiling height in upper floor shall not be more than 2.4mtr. before the hanging beam.

**10. LIFTS AND RAMPS**

Ramps would be optional in Group Housing building in case of 100% stand by generators along with automatic switchover are provided for running of lifts along with stairs. However, in case of buildings having more than four storey lifts with 100% stand by generators along with automatic switchover would be essential. At least one lift shall be provided with minimum size of 1.40 M X 2.00 M. The clear width of the ramp leading to the basement shall be 4.00 meters with an adequate slope not steeper than 1:10. The entry end shall be separate preferable at opposite ends.

**11. OPEN SPACES**

While all the open spaces including those between the blocks and wings of buildings shall be developed, equipped and landscaped according to the plan approved by the DG.TCP, Haryana. At least 15% of the total site area shall be developed as organized open space i.e. tot lots and play ground.

**12. APPROVAL OF BUILDING PLANS**

The building plans of the buildings to be constructed at site shall have to be get approved from the DG.TCP, Haryana (under section 8(2) of the Act No.43 of 1963), before taking up the construction.

**13. BUILDING BY-LAWS**

The construction of the building/buildings shall be governed by the building rules provided in part VII of the Punjab Schedule Areas (Controlled Areas, Restriction of Unregulated Development Rules, 1965 and S. Code No. 4863-1967 regarding provision for Physically Handicapped Persons). The owner shall also follow the provisions of Section 45 of "The Persons With Disabilities (Barriers Opportunities, Protection of Rights and Full Participation) Act, 1995" which includes construction of ramps in public buildings, addition of lifts for wheel chair user, Braille symbols and auditory signals elevators or lifts and other relevant measures for hospitals, primary health centres and other medical care and rehabilitation units. On the points where such rules are silent and stipulate no condition or norm, the model building bylaw issued by the ISL, as well as given in the NBC shall be followed as may be approved by DG.TCP, Haryana.

**14. CONVENIENT SHOPPING**

0.5% of the area of 10.2850 acres area shall be reserved to cater for essential convenient shopping with the following conditions:

- a. The ground coverage of 100% with FAR of 100 will be permissible. However this will be a part of the permissible ground coverage and FAR of the Group Housing Colony.
- b. The size of Kiosk/Shop shall not be more than 2.75 meter x 2.75 meter and 2.75 meter x 8.25 meter.
- c. The height of Kiosk/Shop/Departmental Store shall not exceed 4.00 meter.

**15. PROVISION OF COMMUNITY BUILDINGS**

The community buildings shall be provided as per the composite norm in the Group Housing Colony.

**16. BASEMENT**

Four-level basements within the building zone of the site provided it flushes with the ground and is properly landscaped may be allowed. The basement may in addition to parking could be utilized for generator room, lift room, fire fighting pumps, water reservoir, electric sub-station, air-conditioning plants and related utilities, if they satisfy the public health requirements and for no other purposes. Area under stilts (only for parking) and basement shall not be counted towards FAR. Basement shall not be used for storage/commercial purposes but will be used only for parking and auxiliary services of the main building and it is further stipulated that no other partitions of basement will be permissible for uses other than those specified above.

**17. APPROACH TO SITE**

The vehicular approach to the site and parking lots shall be planned and provided giving due consideration to the junctions of and the junctions with the surrounding roads to the satisfaction of the DG.TCP, Haryana.

**18. FIRE SAFETY MEASURES**

- a. The owner will ensure the provision of proper fire safety measures in the multi storey buildings conforming to the provisions of Rules 395/1 NBC and the same should be got certified from the competent authority.
- b. Electric Sub Station / generator room if provided should be an solid ground near DG/LT. Control panel on ground floor or in upper basement and it should be located on outer periphery of the building, the same should be get approved from the competent authority.

**19. SOLAR WATER HEATING SYSTEM**

The provision of solar water heating system shall be as per norms specified by HARIDA and shall be made operational in each building block before applying for an occupation certificate.

**20. RAINFOREST HARVESTING SYSTEM**

The rain water harvesting system shall be provided as per Central Ground Water Authority norms/Haryana Govt. notification as applicable.

21. The coloniser shall obtain the clearance/NOC as per the provisions of the Notification No.5-D/133/ETI Date 14.5.2006 issued by Ministry of Environment and Forest, Government of India before starting the construction/execution of development works at site.

22. The coloniser/owner shall use only Compact Fluorescent Lamp fittings for internal lighting as well as campus lighting.

23. That no separate zoning plan is required for community sites earmarked within a Group Housing Colony. The community building/buildings shall be constructed by the coloniser/owner as per provision of The Haryana Development and Regulation of Urban Areas (Amendment and Validation) Act No. 8 of 2012, falling which the said site shall vest with the Government.

24. That the eligibility criteria, guidelines for scrutiny of application and construction/occupation of FWS flats shall be governed by the EWS policy of the Department dated 08.07.2011. Accordingly, the complete scheme for allotment of FWS flats shall be floated within 4 months from issuance of part occupation certificate of the EWS flats.

25. The coloniser shall convey the ultimate power load requirement of your power utility as enable the provision of project to the concerned site for transformer/switching station/electric sub-station as per the norms prescribed by the power utility in your project site at the time of approval of building plan.



DIRE. NO. DG.TCP 9/34 DATED 16-2-2013

(P.B. SINGH)  
DG (HQ)


(GURMEET KAUR)  
STP (M) HQ

(J.S. REDHU)  
CTP (HR)



(ANURAG RASTOGI)  
DG, TCP (HR)

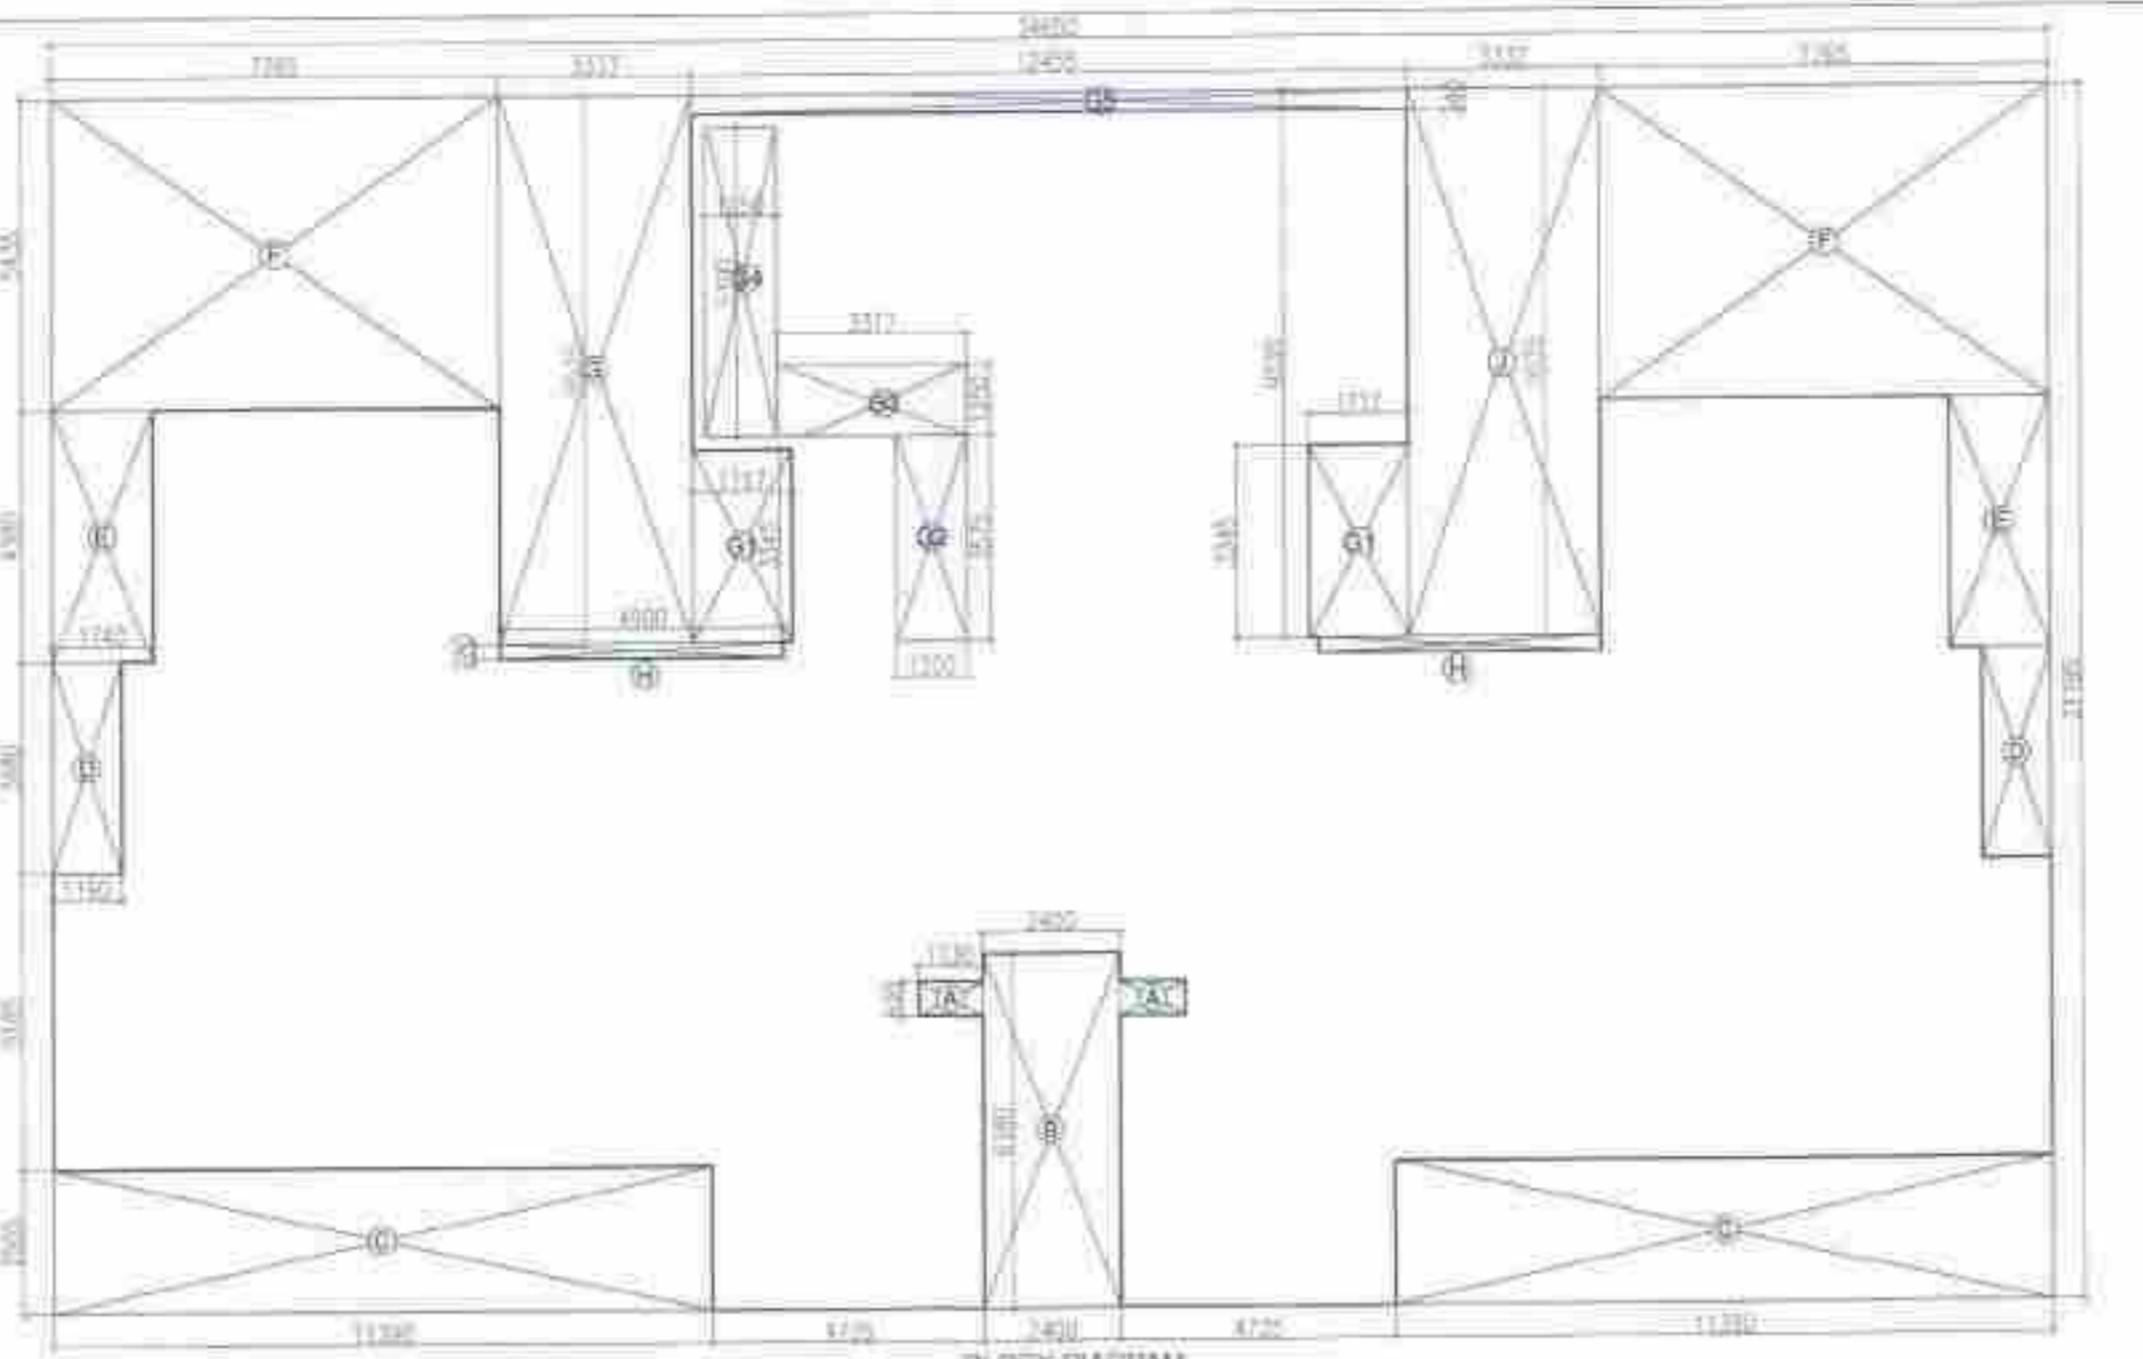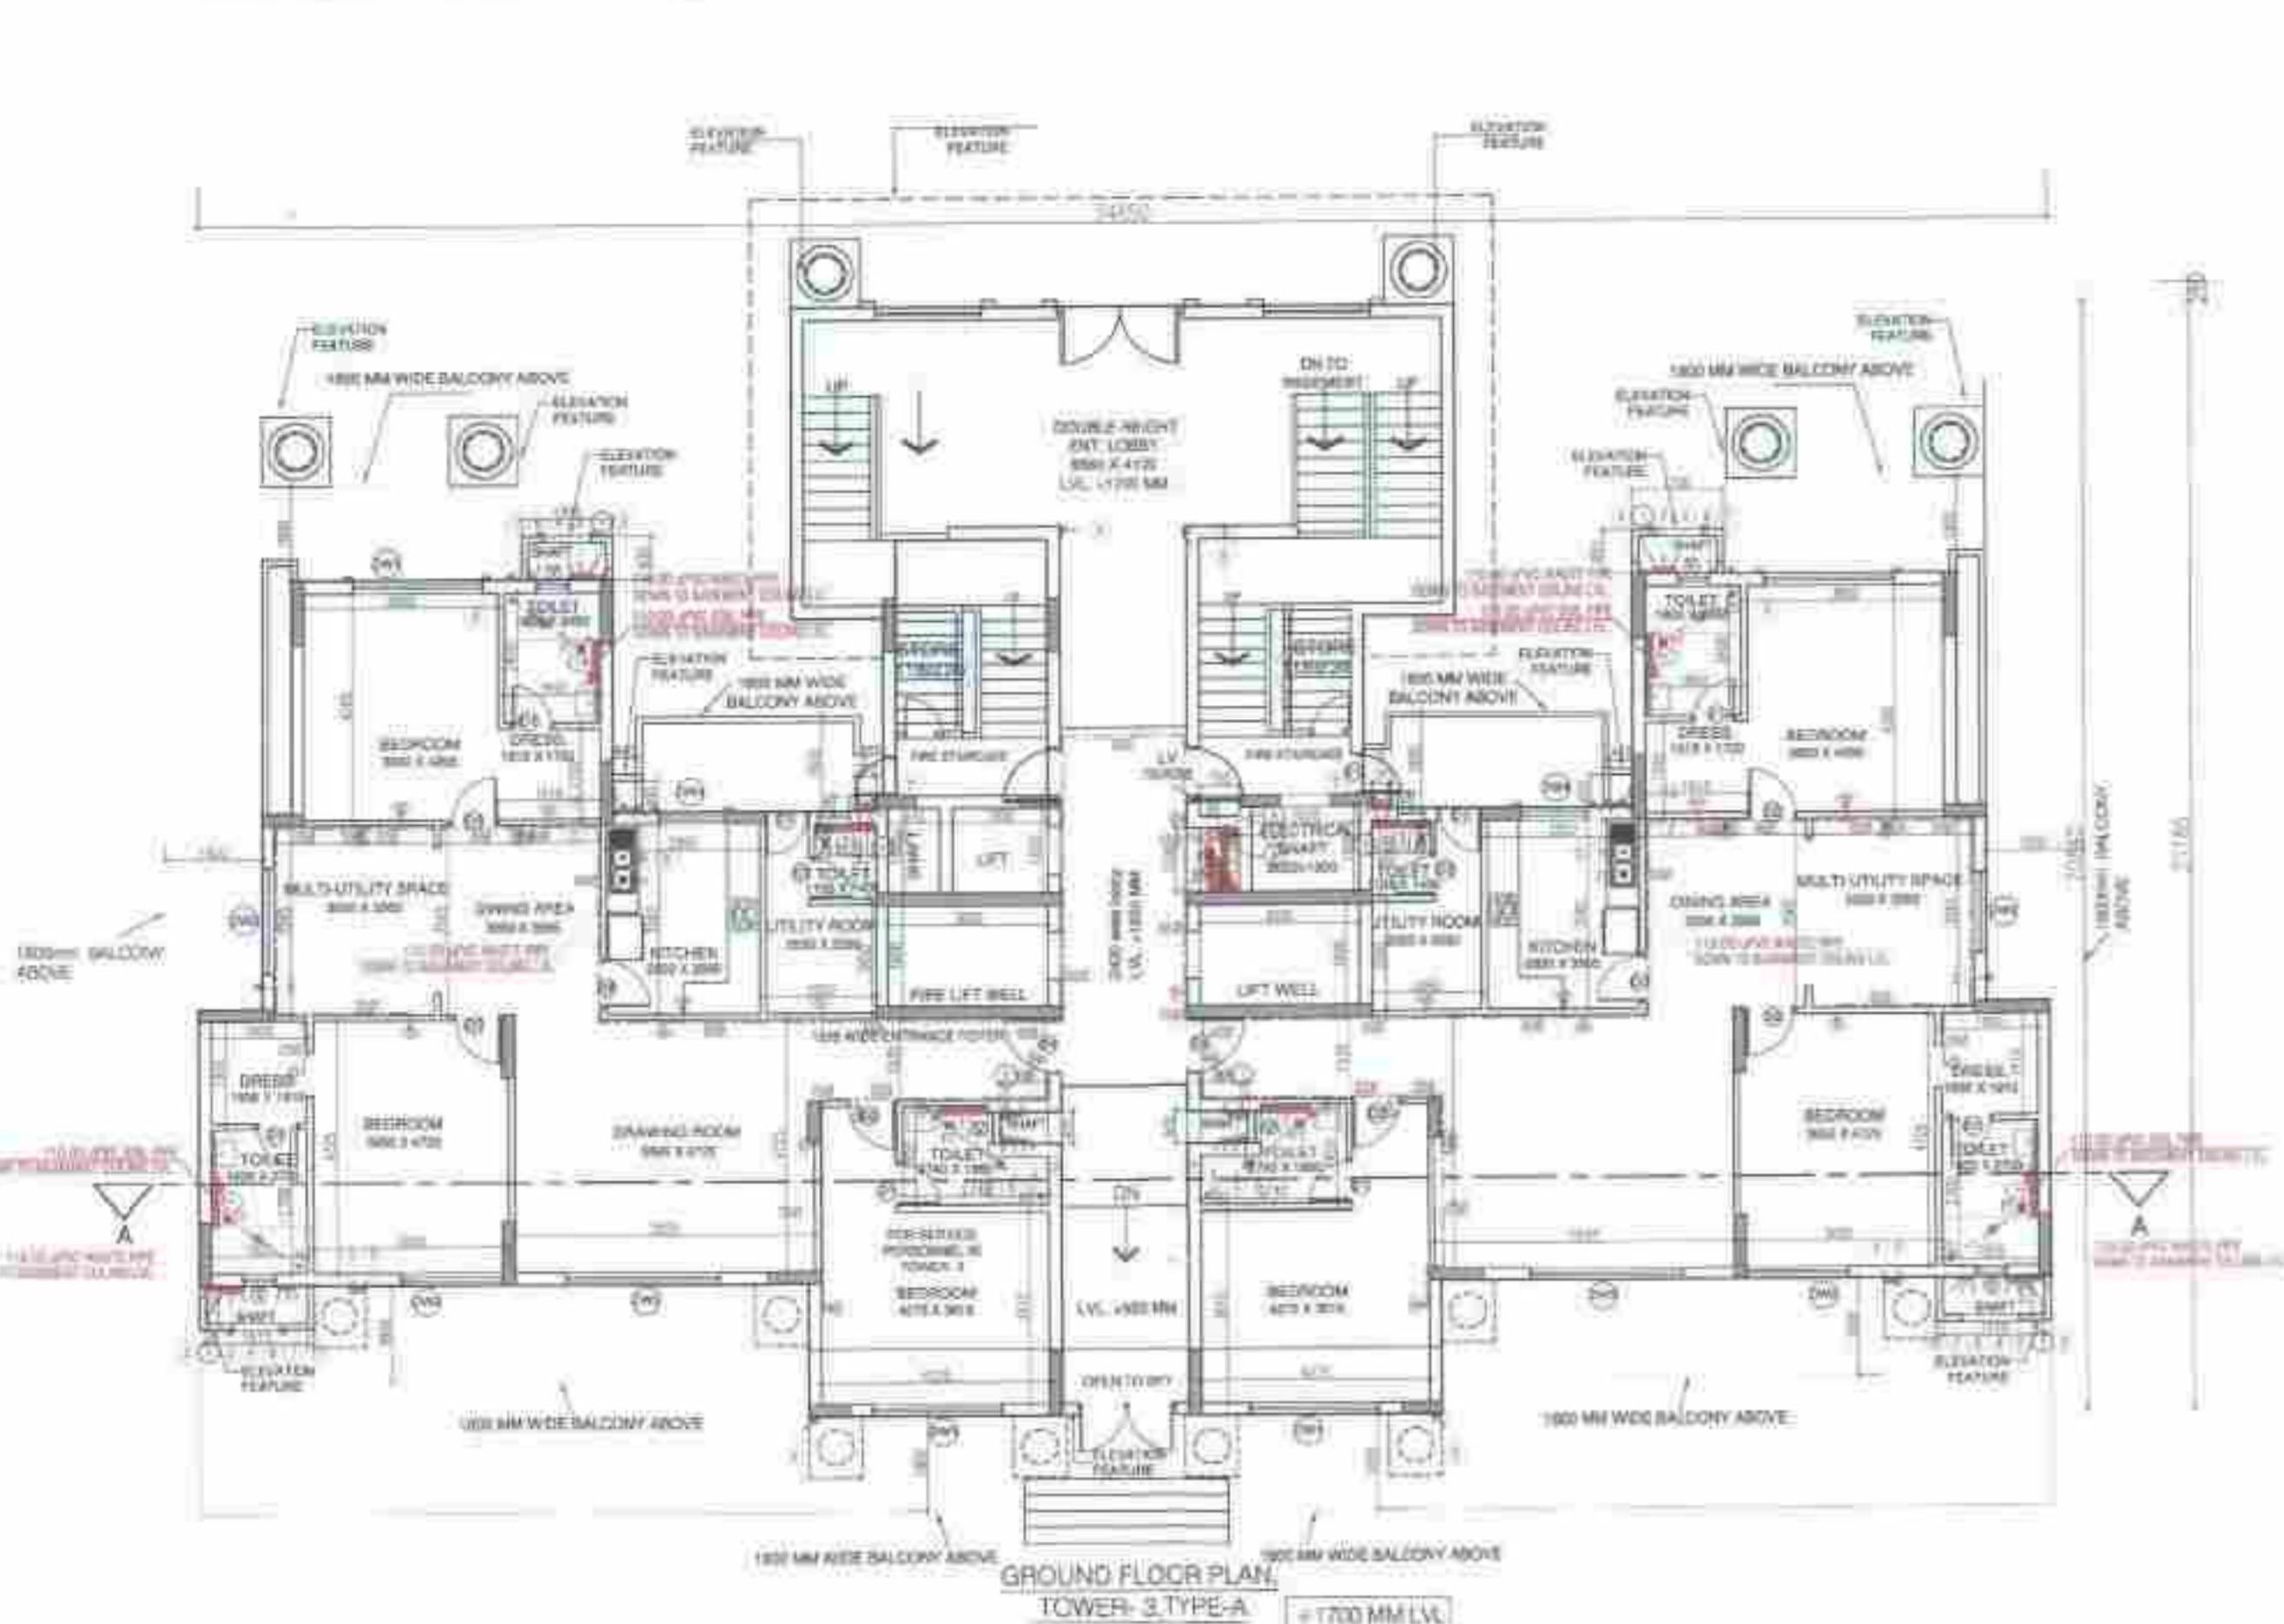

GROUND FLOOR AREA ADDITION			
AREA CALCULATION			ADDITION
AREA = (L x B)		34.650 x 21.185	734.060
3RD TO 5TH FLOOR AREA ADDITION			584.026
<b>ADDITION AREA = 734.060 SQ.MT</b>			
<b>DEDUCTION DETAIL</b>			
A	1.130 X 0.600 X 2	1.356	
B	2.400 X 6.180 X 1	14.832	
C	11.290 X 2.505 X 2	57.064	
D	1.190 X 3.680 X 2	8.758	
E	1.740 X 4.380 X 2	15.242	
F	7.765 X 3.435 X 2	84.406	
G	3.332 X 9.535 X 2	31.773	
G1	1.717 X 3.945 X 2	11.487	
G2	1.250 X 3.575 X 2	4.469	
G3	3.317 X 1.250 X 2	4.146	
G4	1.250 X 5.390 X 1	6.738	
G5	12.495 X 0.540 X 1	6.725	
H	4.500 X 0.280 X 2	2.744	
I	3.332 X 9.535 X 2	31.773	
J	2.630 X 3.925 X 2	10.323	
K	5.050 X 5.205 X 1	26.285	
L	3.000 X 1.900 X 2	11.400	
M	3.000 X 1.600 X 1	4.800	
N	0.750 X 1.200 X 1	0.900	
P	2.020 X 1.600 X 1	3.232	
Q	0.750 X 0.285 X 1	0.214	
<b>TOTAL</b>		279.077	<b>TOTAL</b>
<b>3RD TO 5TH FLOOR AREA ADDITION</b>			
AREA CALCULATION			584.026-216.628
AREA = (L x B)		34.650 x 16.855	584.026
<b>ADDITION AREA = 584.026 SQ.MT</b>			
<b>DEDUCTION DETAIL</b>			
A	1.130 X 0.600 X 2	1.356	
B	2.400 X 6.180 X 1	14.832	
C	11.290 X 2.505 X 2	57.064	
D	1.190 X 3.680 X 2	8.758	
E	1.740 X 4.380 X 2	15.242	
F	7.765 X 3.435 X 2	84.406	
G	3.332 X 9.535 X 2	31.773	
G1	1.717 X 3.945 X 2	11.487	
G2	1.250 X 3.575 X 2	4.469	
G3	3.317 X 1.250 X 2	4.146	
G4	1.250 X 5.390 X 1	6.738	
G5	12.495 X 0.540 X 1	6.725	
H	4.500 X 0.280 X 2	2.744	
I	3.332 X 9.535 X 2	31.773	
J	2.630 X 3.925 X 2	10.323	
K	5.050 X 5.205 X 1	26.285	
L	3.000 X 1.900 X 2	11.400	
M	3.000 X 1.600 X 1	4.800	
N	0.750 X 1.200 X 1	0.900	
P	2.020 X 1.600 X 1	3.232	
Q	0.750 X 0.285 X 1	0.214	
<b>TOTAL</b>		216.628	<b>TOTAL</b>

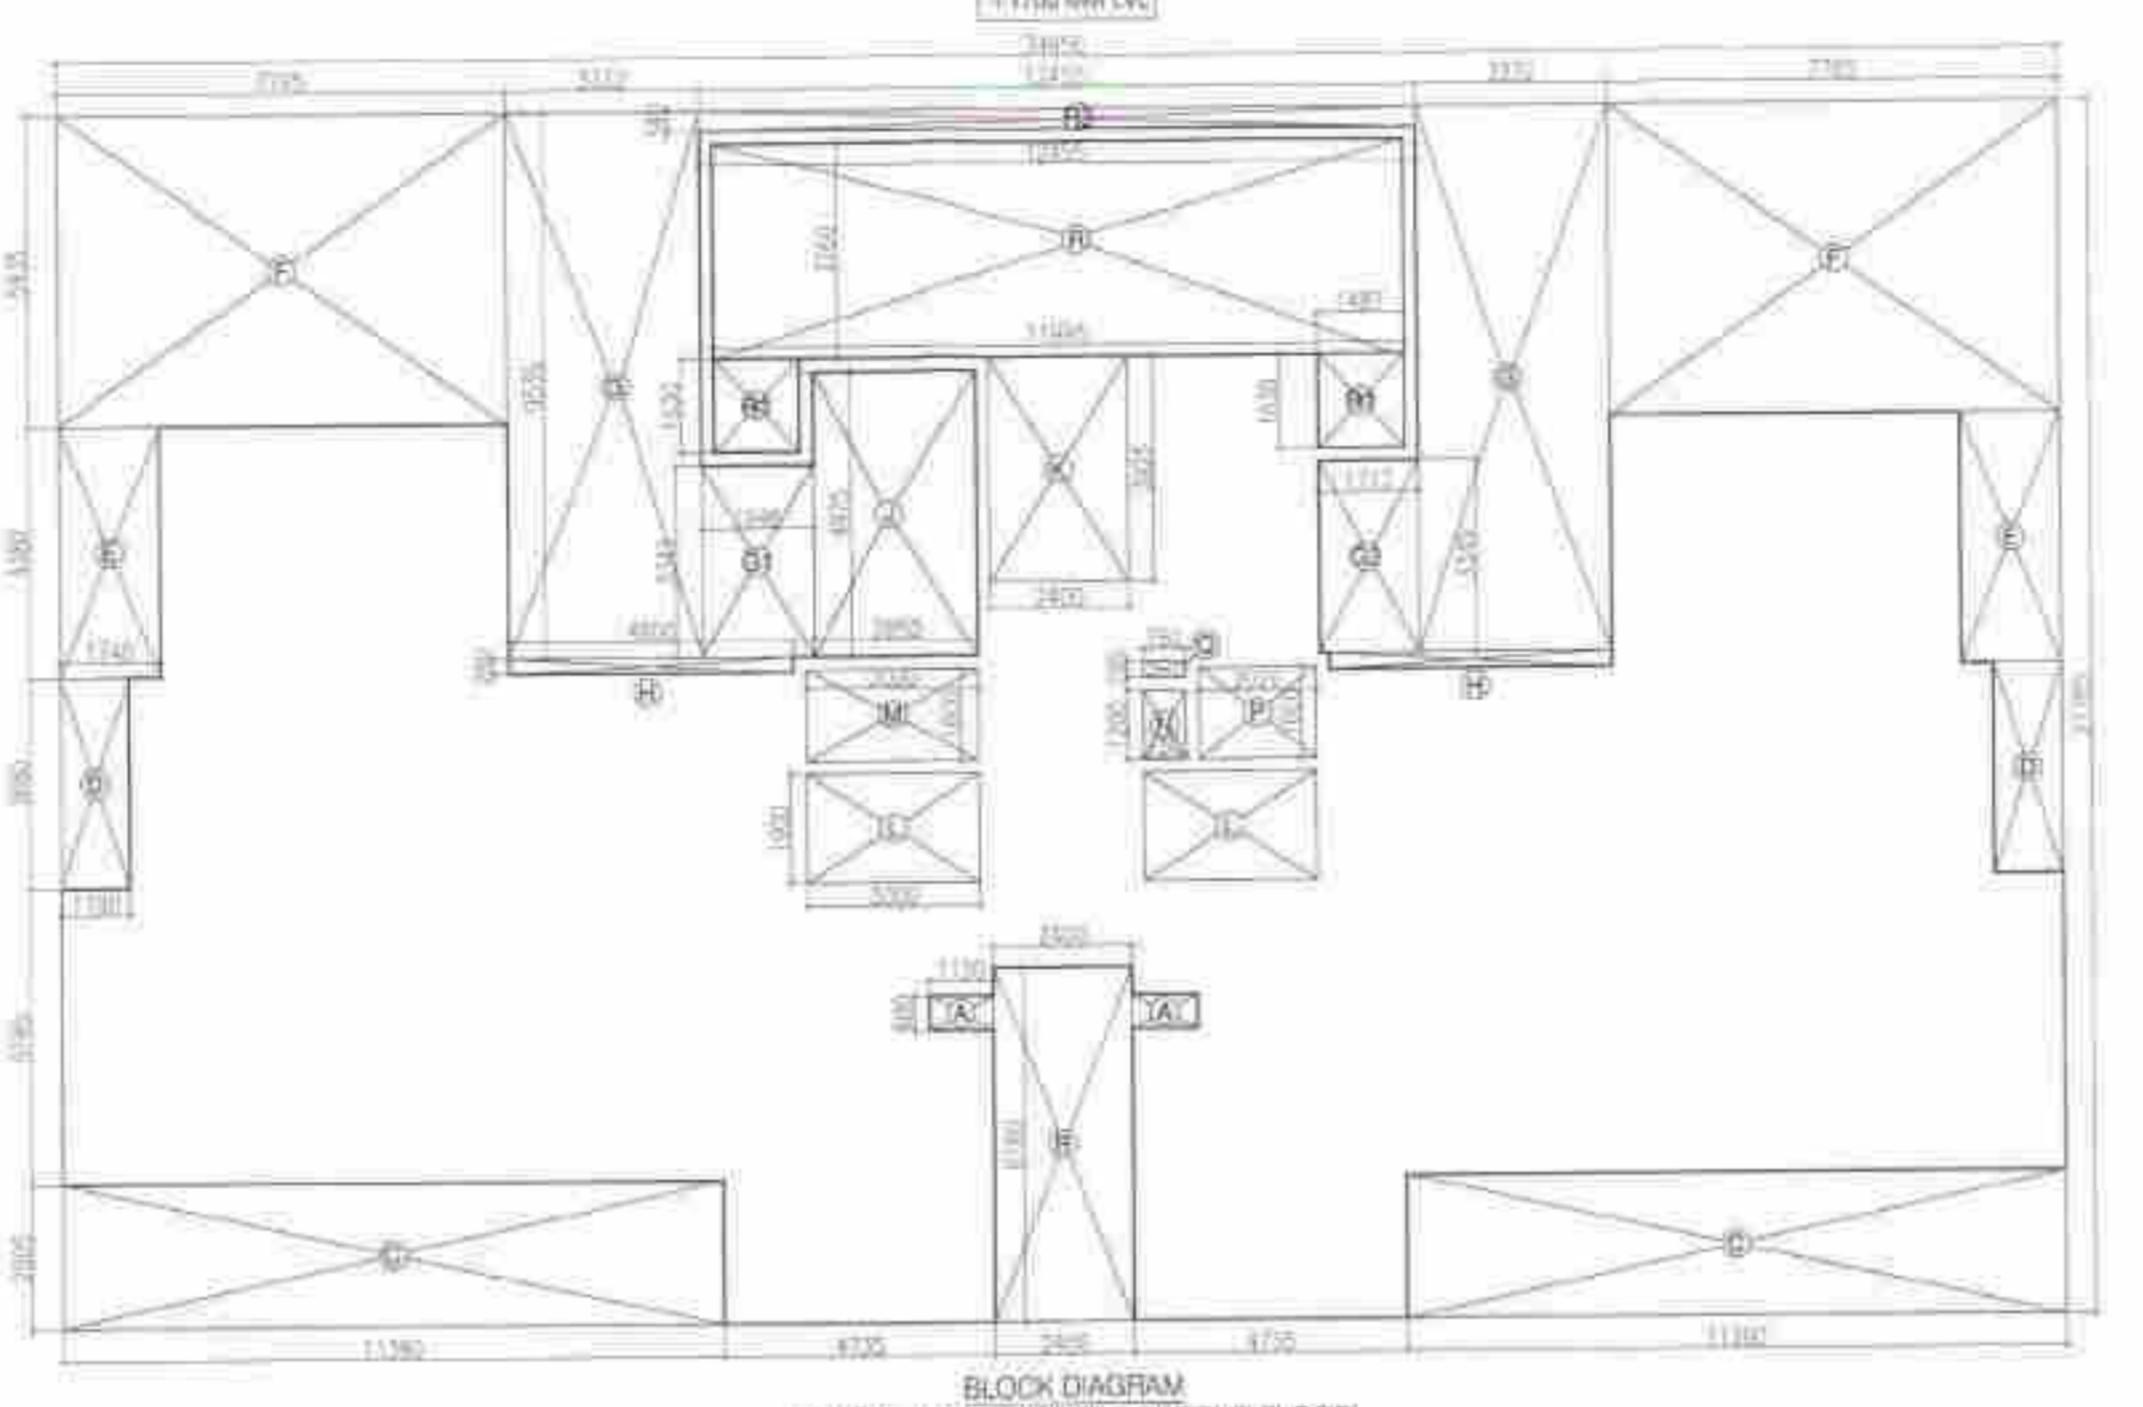

GROUND FLOOR AREA ADDITION			
AREA CALCULATION			ADDITION
AREA = (L x B)		34.650 x 21.185	734.060
3RD TO 5TH FLOOR AREA ADDITION			584.026
<b>ADDITION AREA = 734.060 SQ.MT</b>			
<b>DEDUCTION DETAIL</b>			
A	1.130 X 0.600 X 2	1.356	
B	2.400 X 6.180 X 1	14.832	
C	11.290 X 2.505 X 2	57.064	
D	1.190 X 3.680 X 2	8.758	
E	1.740 X 4.380 X 2	15.242	
F	7.765 X 3.435 X 2	84.406	
G	3.332 X 9.535 X 2	31.773	
G1	1.940 X 3.945 X 2	6.516	
G2	1.717 X 3.945 X 1	5.743	
H	4.900 X 0.280 X 2	2.744	
I	3.680 X 4.975 X 1	15.323	
J	2.400 X 3.925 X 1	9.420	
K	3.000 X 1.900 X 2	11.400	
L	3.000 X 1.600 X 1	4.800	
M	0.750 X 1.200 X 1	0.900	
N	2.020 X 1.600 X 1	3.232	
O	0.750 X 0.285 X 1	0.214	
P	11.995 X 3.760 X 1	45.101	
R	1.487 X 1.630 X 1	4.648	
R1	12.455 X 0.340 X 1	4.235	
R2	12.455 X 0.340 X 1	4.235	
<b>TOTAL</b>		359.675	<b>TOTAL</b>
<b>3RD TO 5TH FLOOR AREA ADDITION</b>			
AREA CALCULATION			584.026-216.628
AREA = (L x B)		34.650 x 16.855	584.026
<b>ADDITION AREA = 584.026 SQ.MT</b>			
<b>DEDUCTION DETAIL</b>			
A	1.130 X 0.600 X 2	1.356	
B	2.400 X 6.180 X 1	14.832	
C	11.290 X 2.505 X 2	57.064	
D	1.190 X 3.680 X 2	8.758	
E	1.740 X 4.380 X 2	15.242	
F	7.765 X 3.435 X 2	84.406	
G	3.332 X 9.535 X 2	31.773	
G1	1.940 X 3.945 X 2	6.516	
G2	1.717 X 3.945 X 1	5.743	
H	4.900 X 0.280 X 2	2.744	
I	3.680 X 4.975 X 1	15.323	
J	2.400 X 3.925 X 1	9.420	
K	3.000 X 1.900 X 2	11.400	
L	3.000 X 1.600 X 1	4.800	
M	0.750 X 1.200 X 1	0.900	
N	2.020 X 1.600 X 1	3.232	
O	0.750 X 0.285 X 1	0.214	
P	11.995 X 3.760 X 1	45.101	
R	1.487 X 1.630 X 1	4.648	
R1	12.455 X 0.340 X 1	4.235	
R2	12.455 X 0.340 X 1	4.235	
<b>TOTAL</b>		216.628	<b>TOTAL</b>




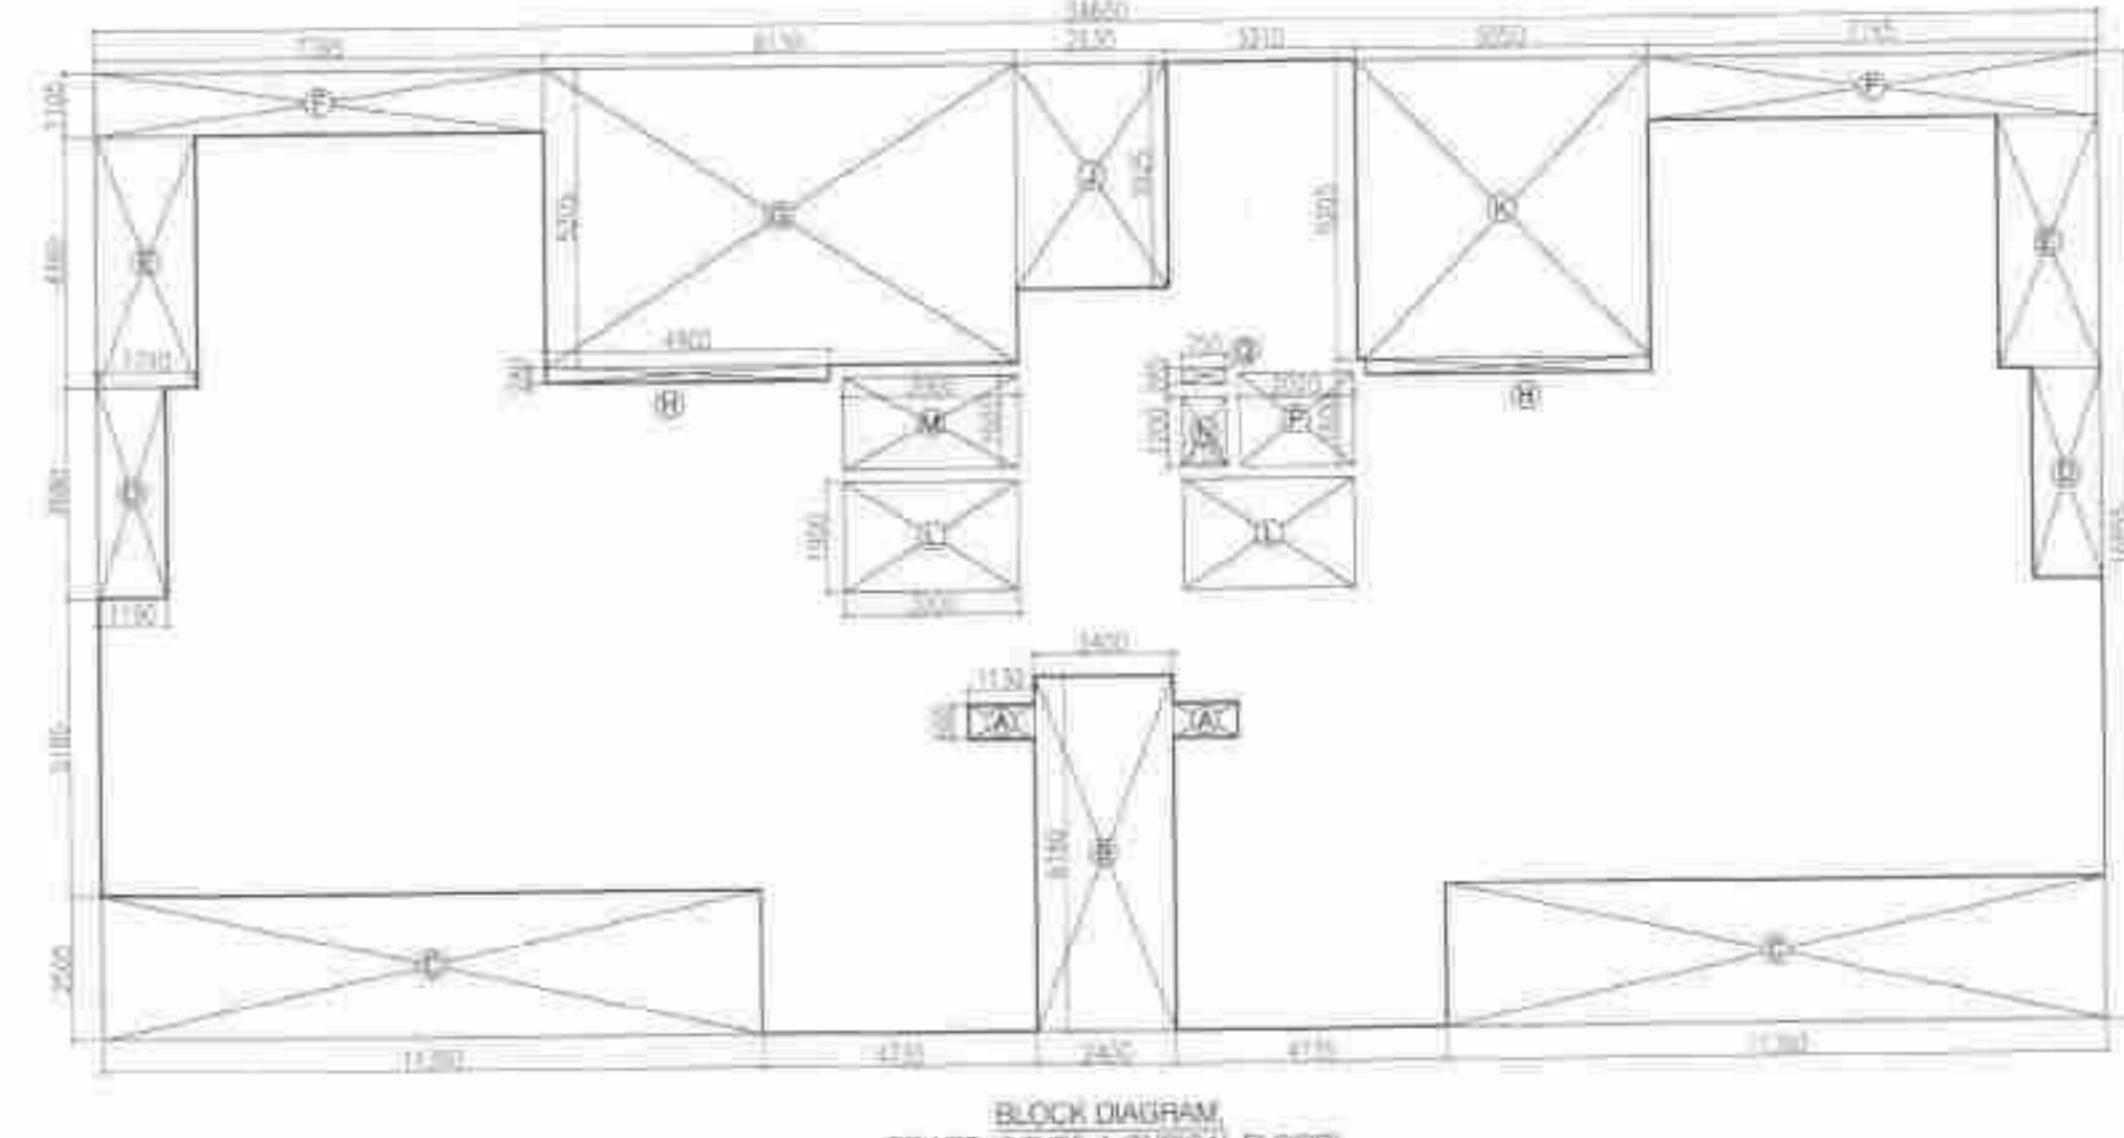
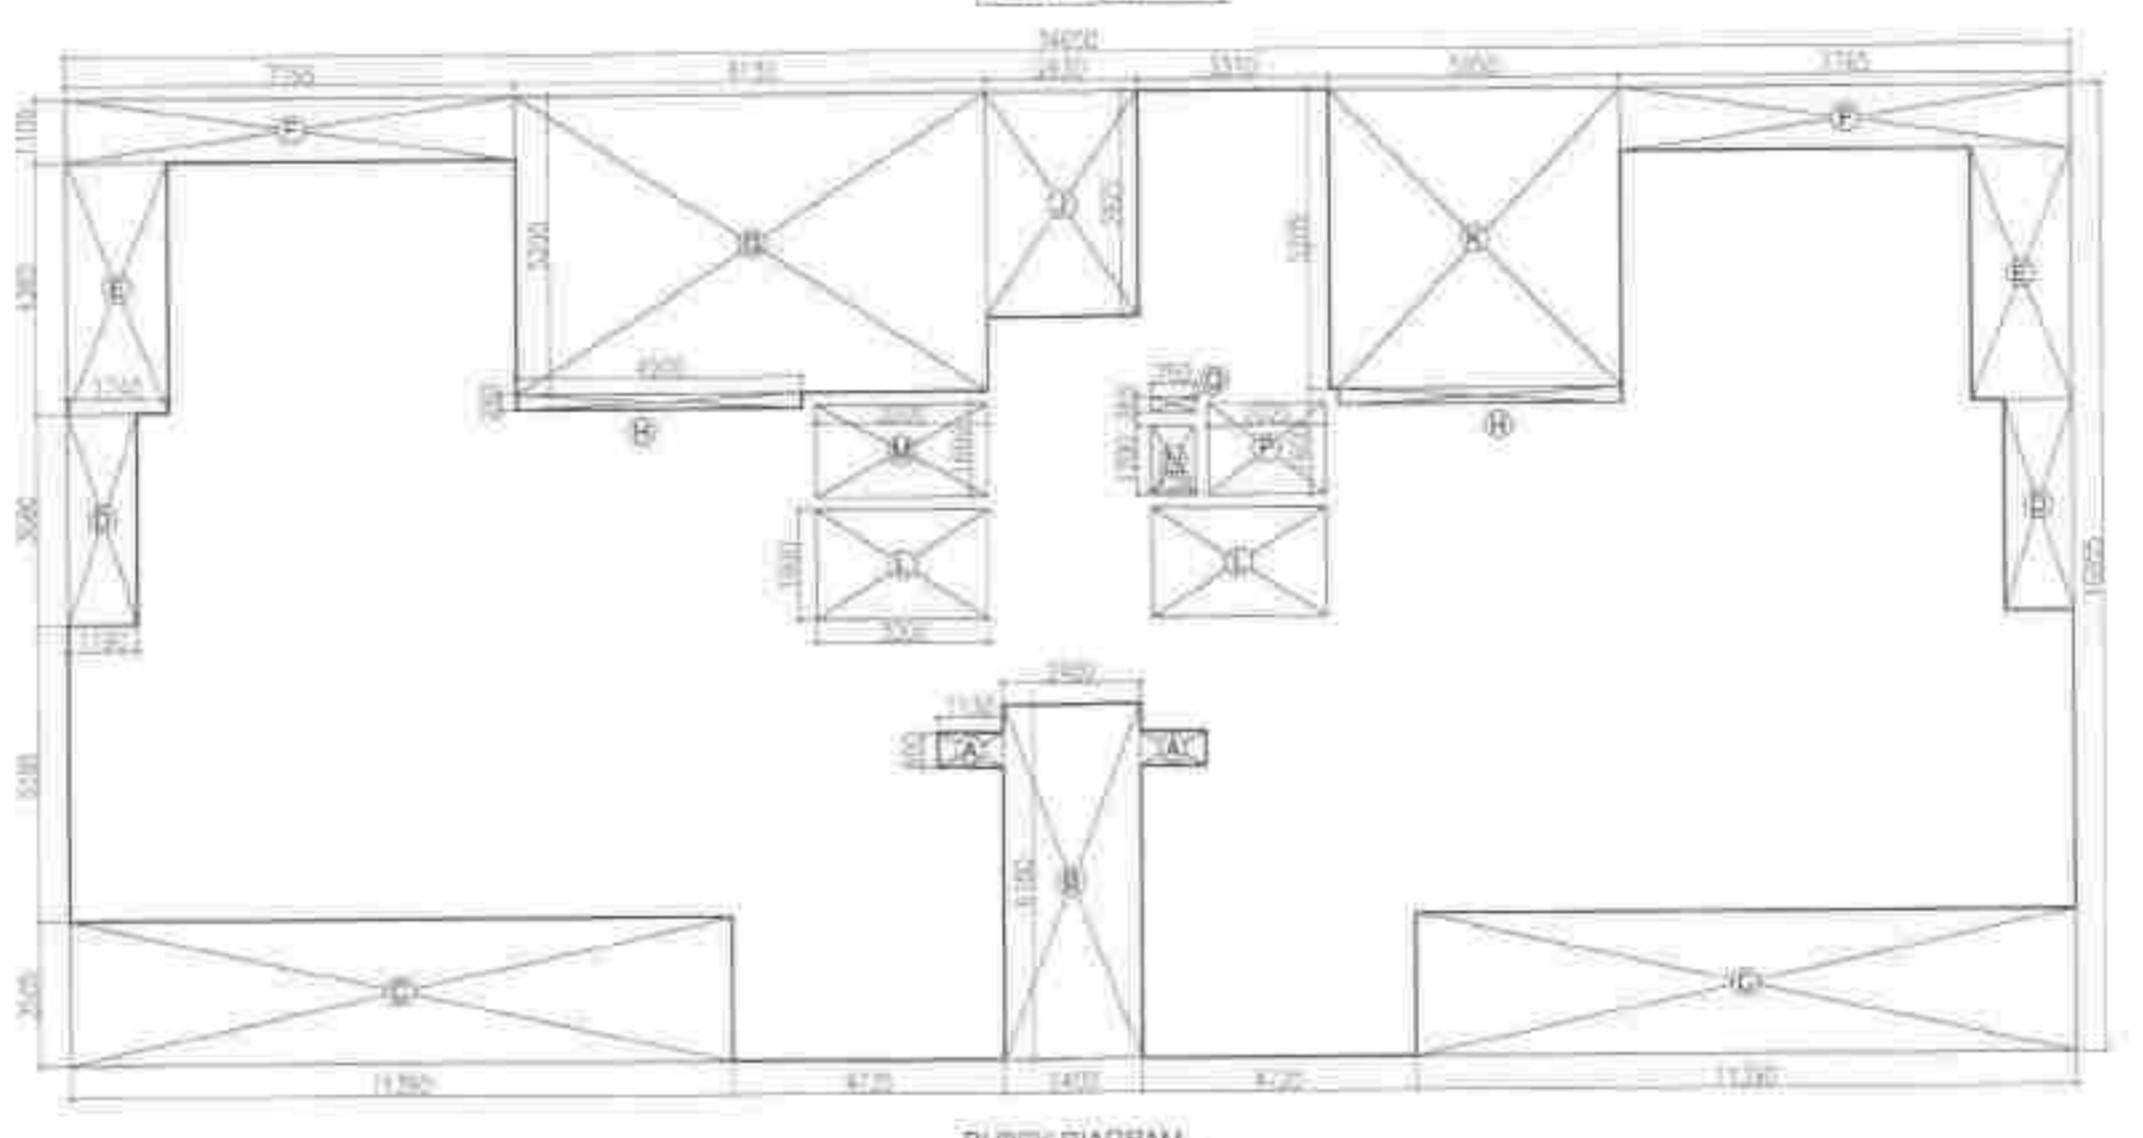


BLOCK DIAGRAM, TOWER-3 TYPE-A (TYPICAL FLOOR)  
+2040MM TO +6200MM LVL.

AREA STATEMENT		
S.NO.	FLOORS	FLOOR AREA(SQ.MT.) UNITS ON EACH FLOOR
1	GROUND FLOOR	455.033 2
2	1st FLOOR	374.385 2
3	2nd FLOOR	374.385 2
4	3rd FLOOR	367.398 2
5	4th FLOOR	367.398 2
6	5th FLOOR	367.398 2
7	6th FLOOR	367.398 2
8	7th FLOOR	367.398 2
9	8th FLOOR	367.398 2
10	9th FLOOR	367.398 2
11	10th FLOOR	367.398 2
12	11th FLOOR	367.398 2
13	12th FLOOR	367.398 2
14	13th FLOOR	367.398 2
15	14th FLOOR	367.398 2
16	15th FLOOR	367.398 2
17	16th FLOOR	367.398 2
18	17th FLOOR	367.398 2
19	18th FLOOR	367.398 2
20	19th FLOOR	367.398 2
21	20th FLOOR	367.398 2
22	21st FLOOR	367.398 2
23	22nd FLOOR (PHL)	337.231 2
24	23rd FLOOR (PHU)	230.287 2
25	TERRACE	20.961 1
	<b>TOTAL</b>	<b>8772.844</b> 46

#### OPENING SCHEDULE OF DOORS & WINDOWS

SR. NO	SIZE	SILL	LINTEL	TYPE
1	800 X 2100	-	2100	D1
2	900 X 2100	-	2100	D2
3	750 X 2100	-	2100	D3
4	1050 X 2400	-	2400	D4
5	1050 X 2100	-	2100	FD

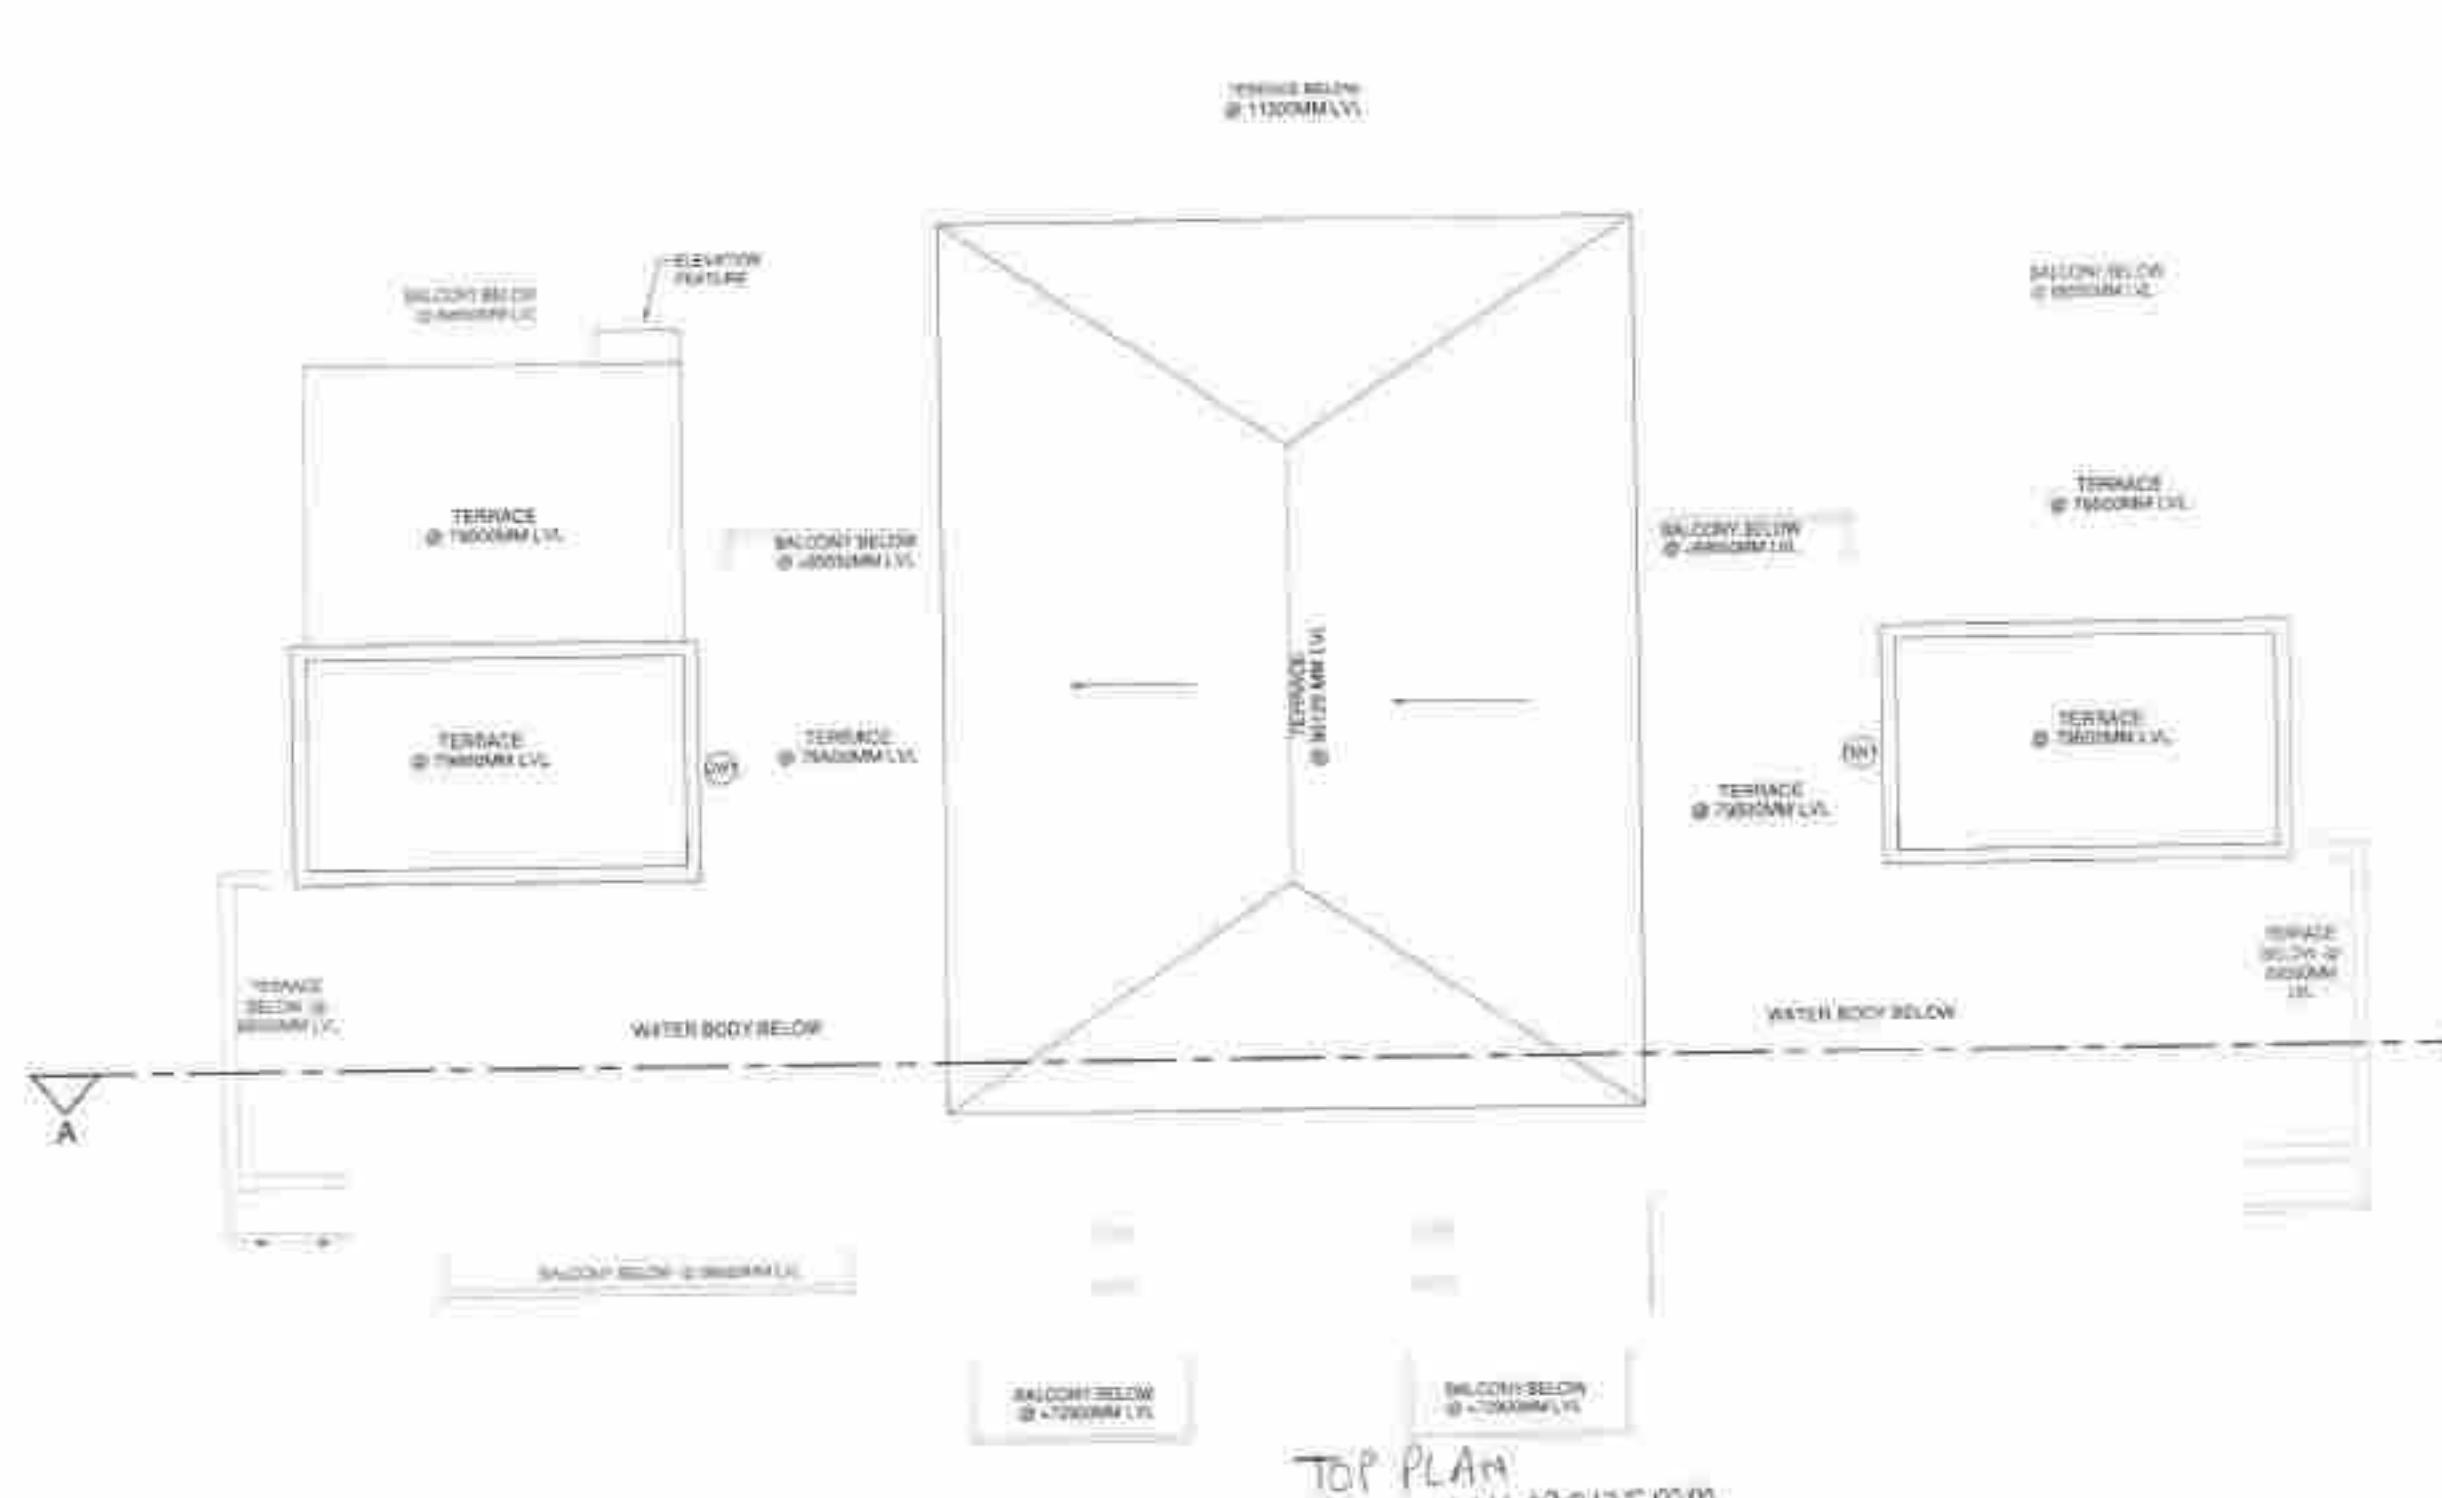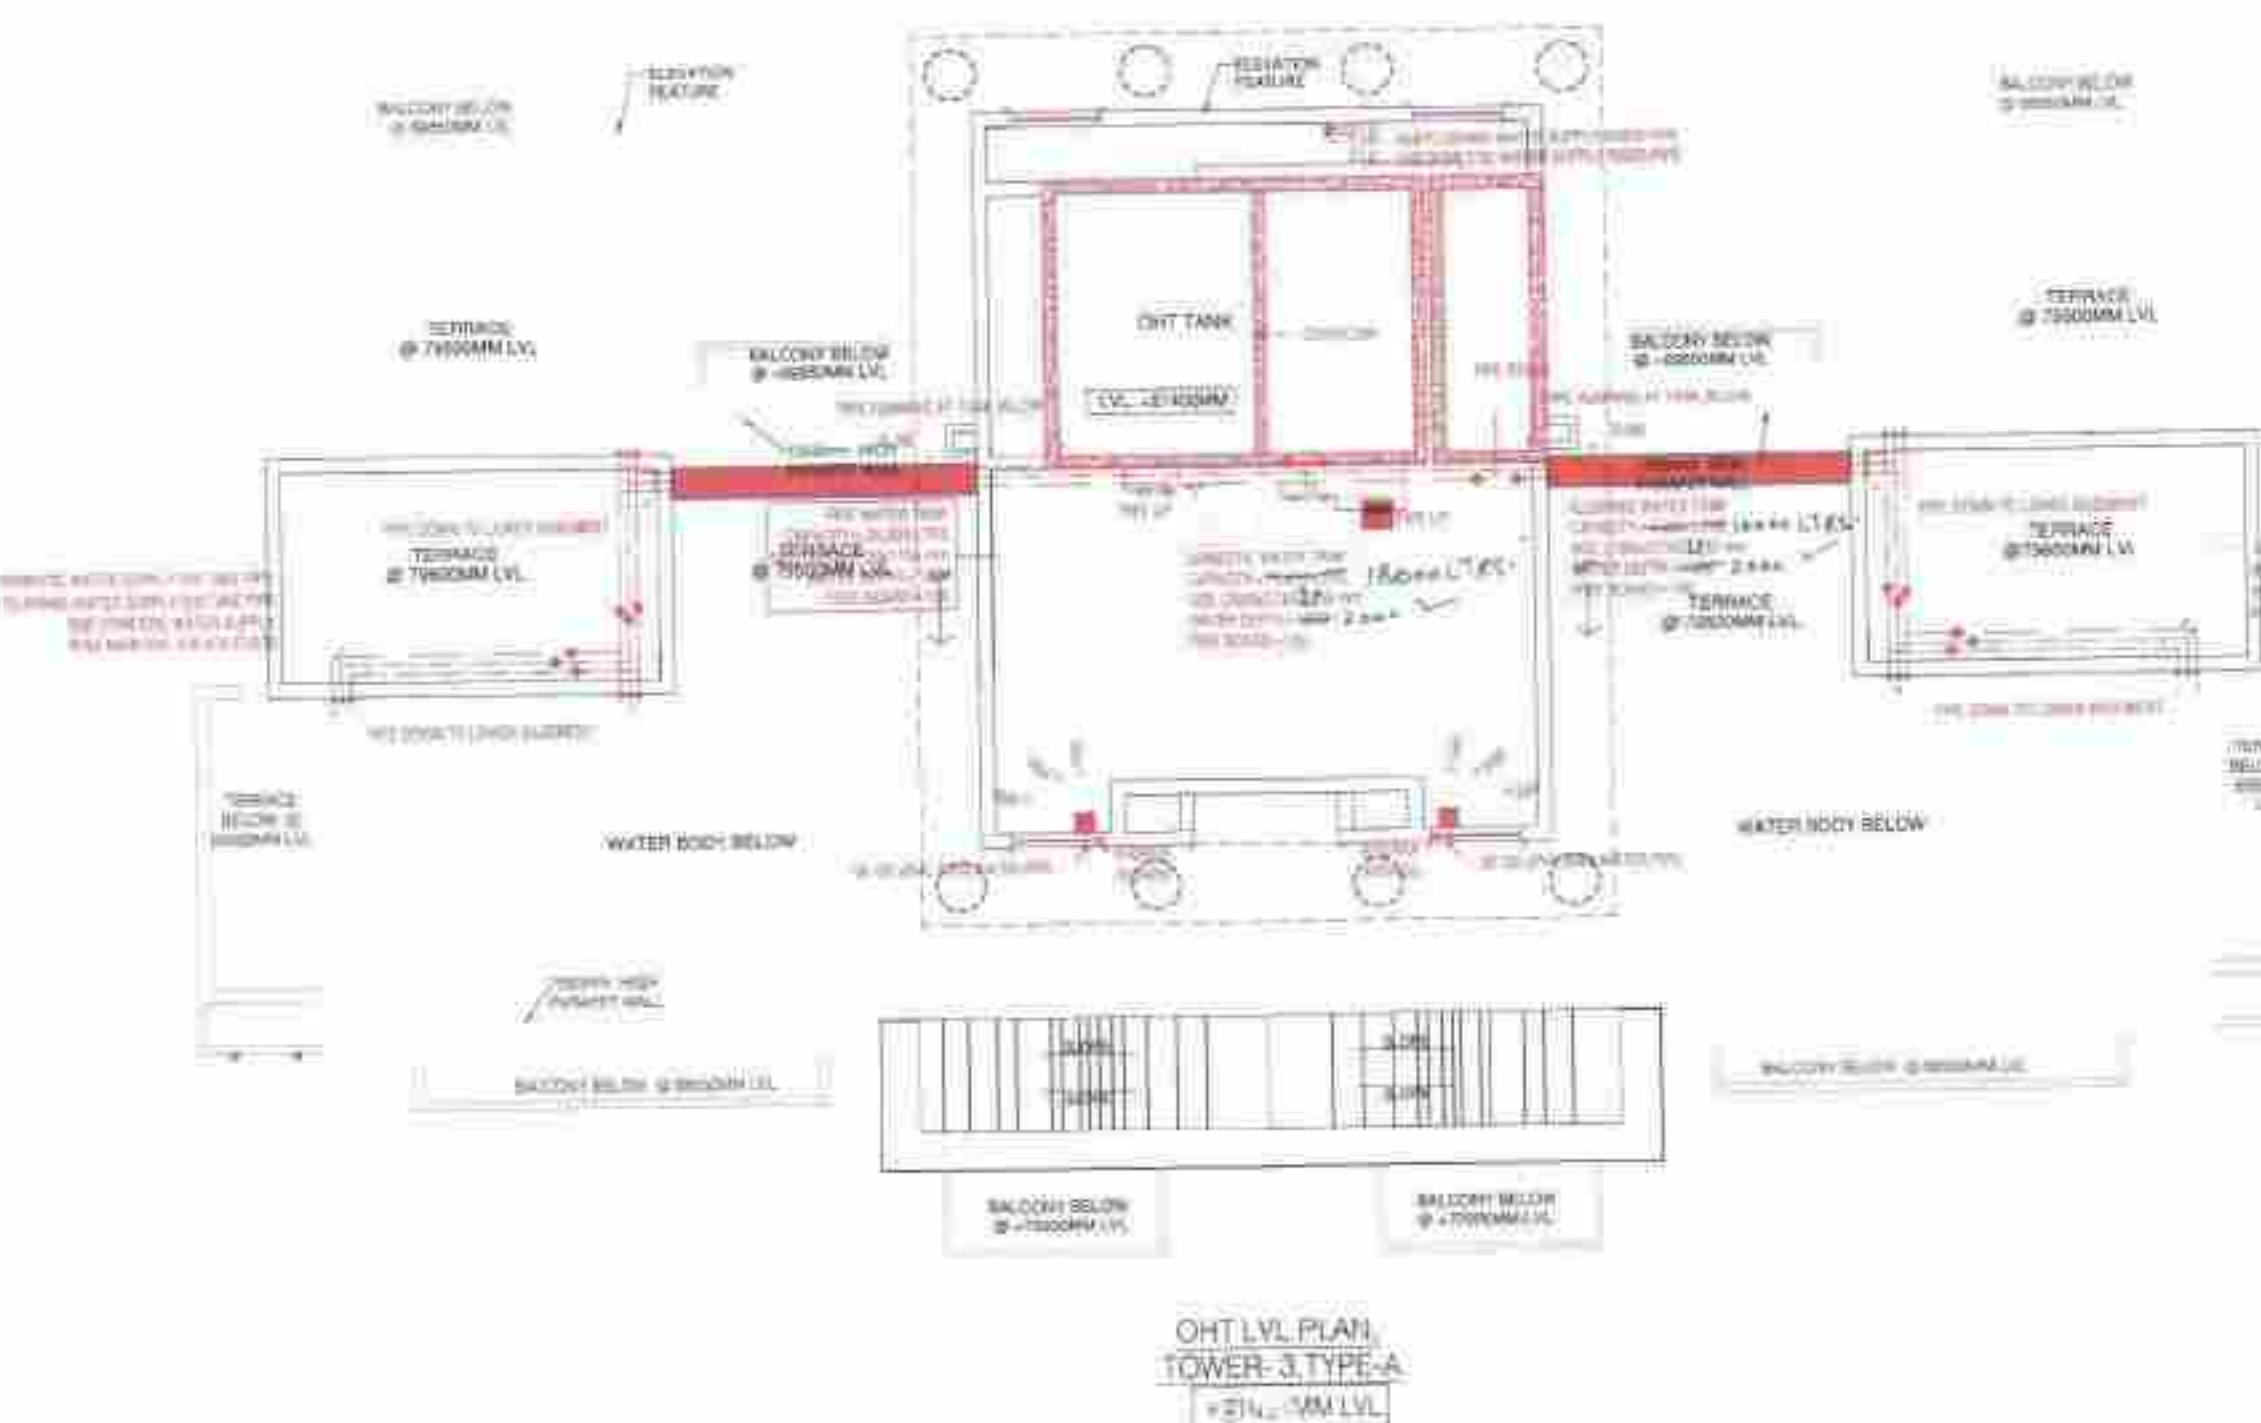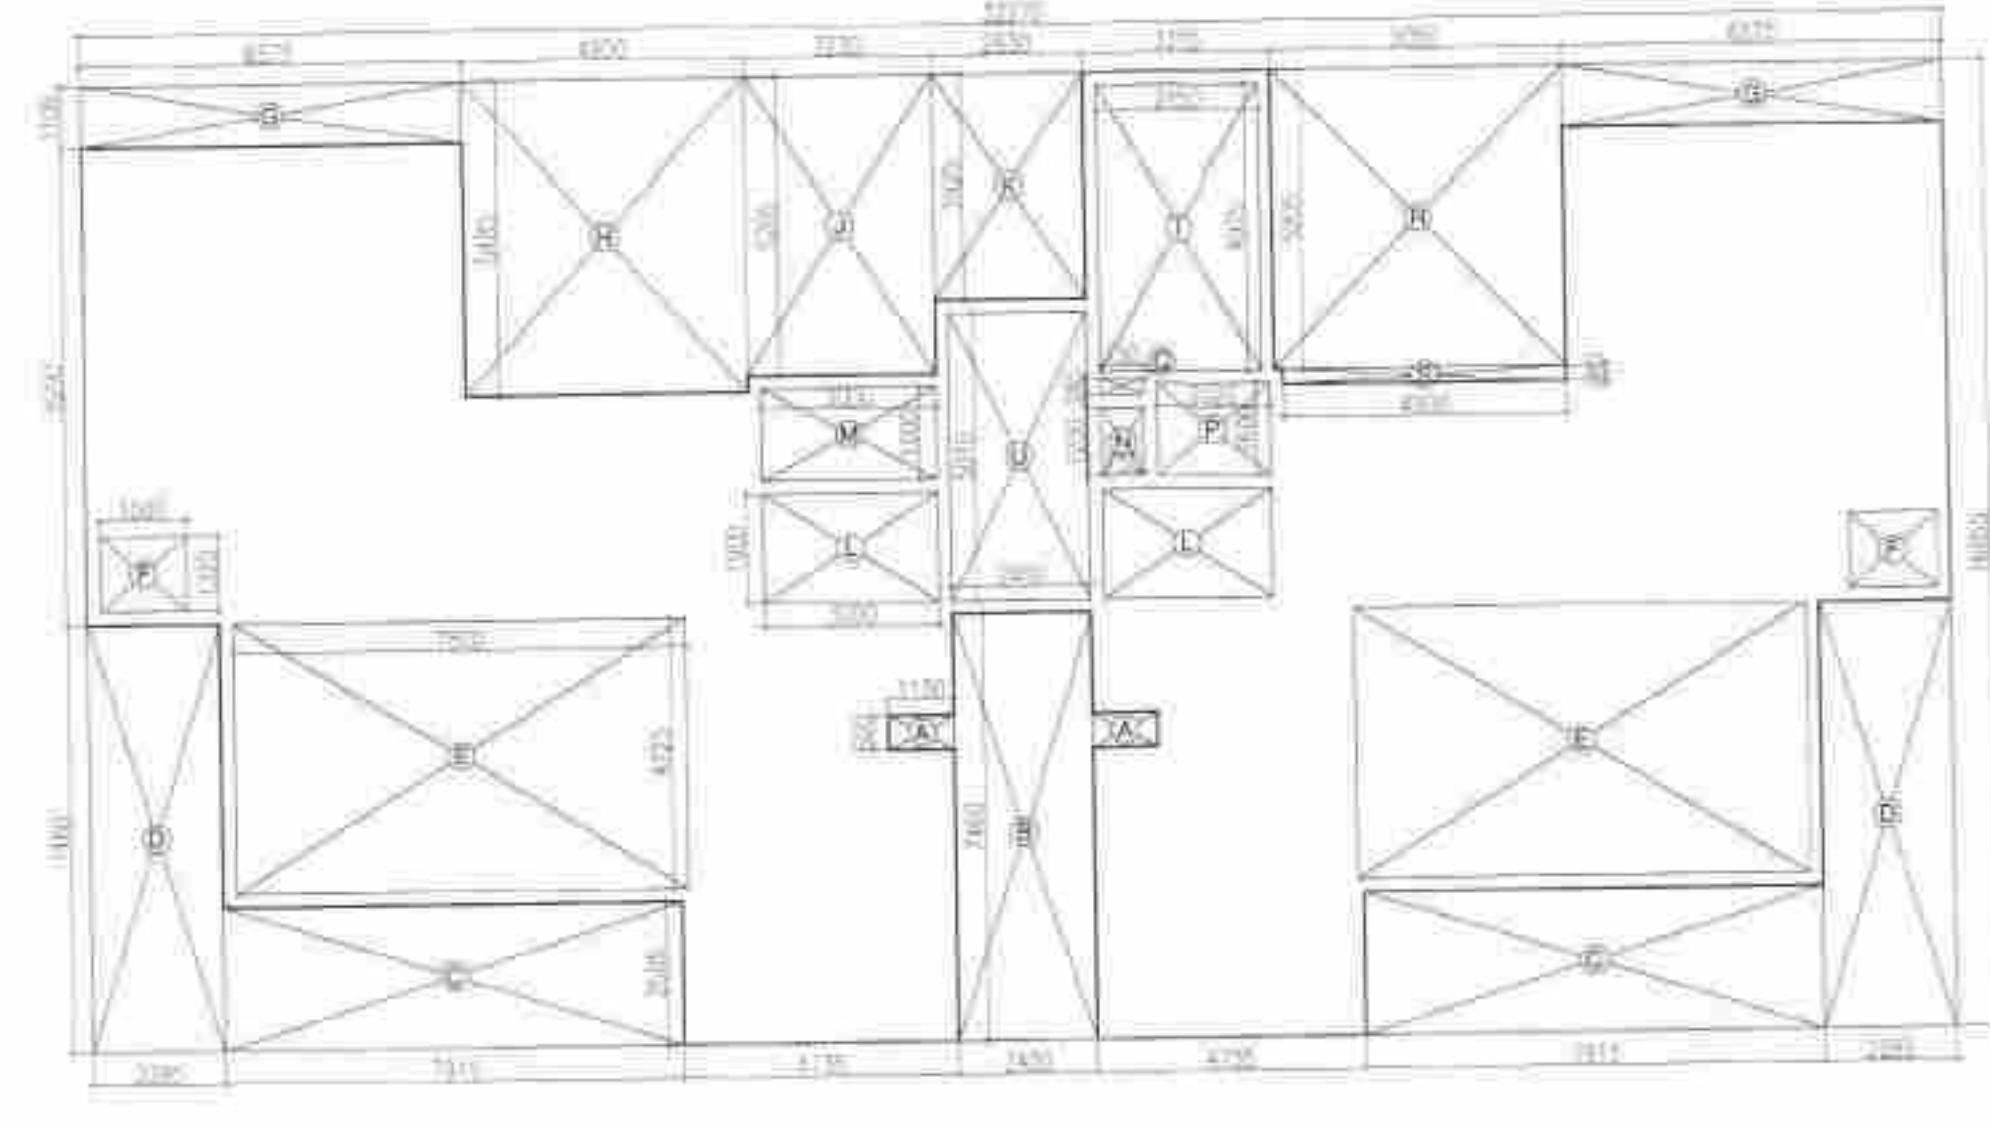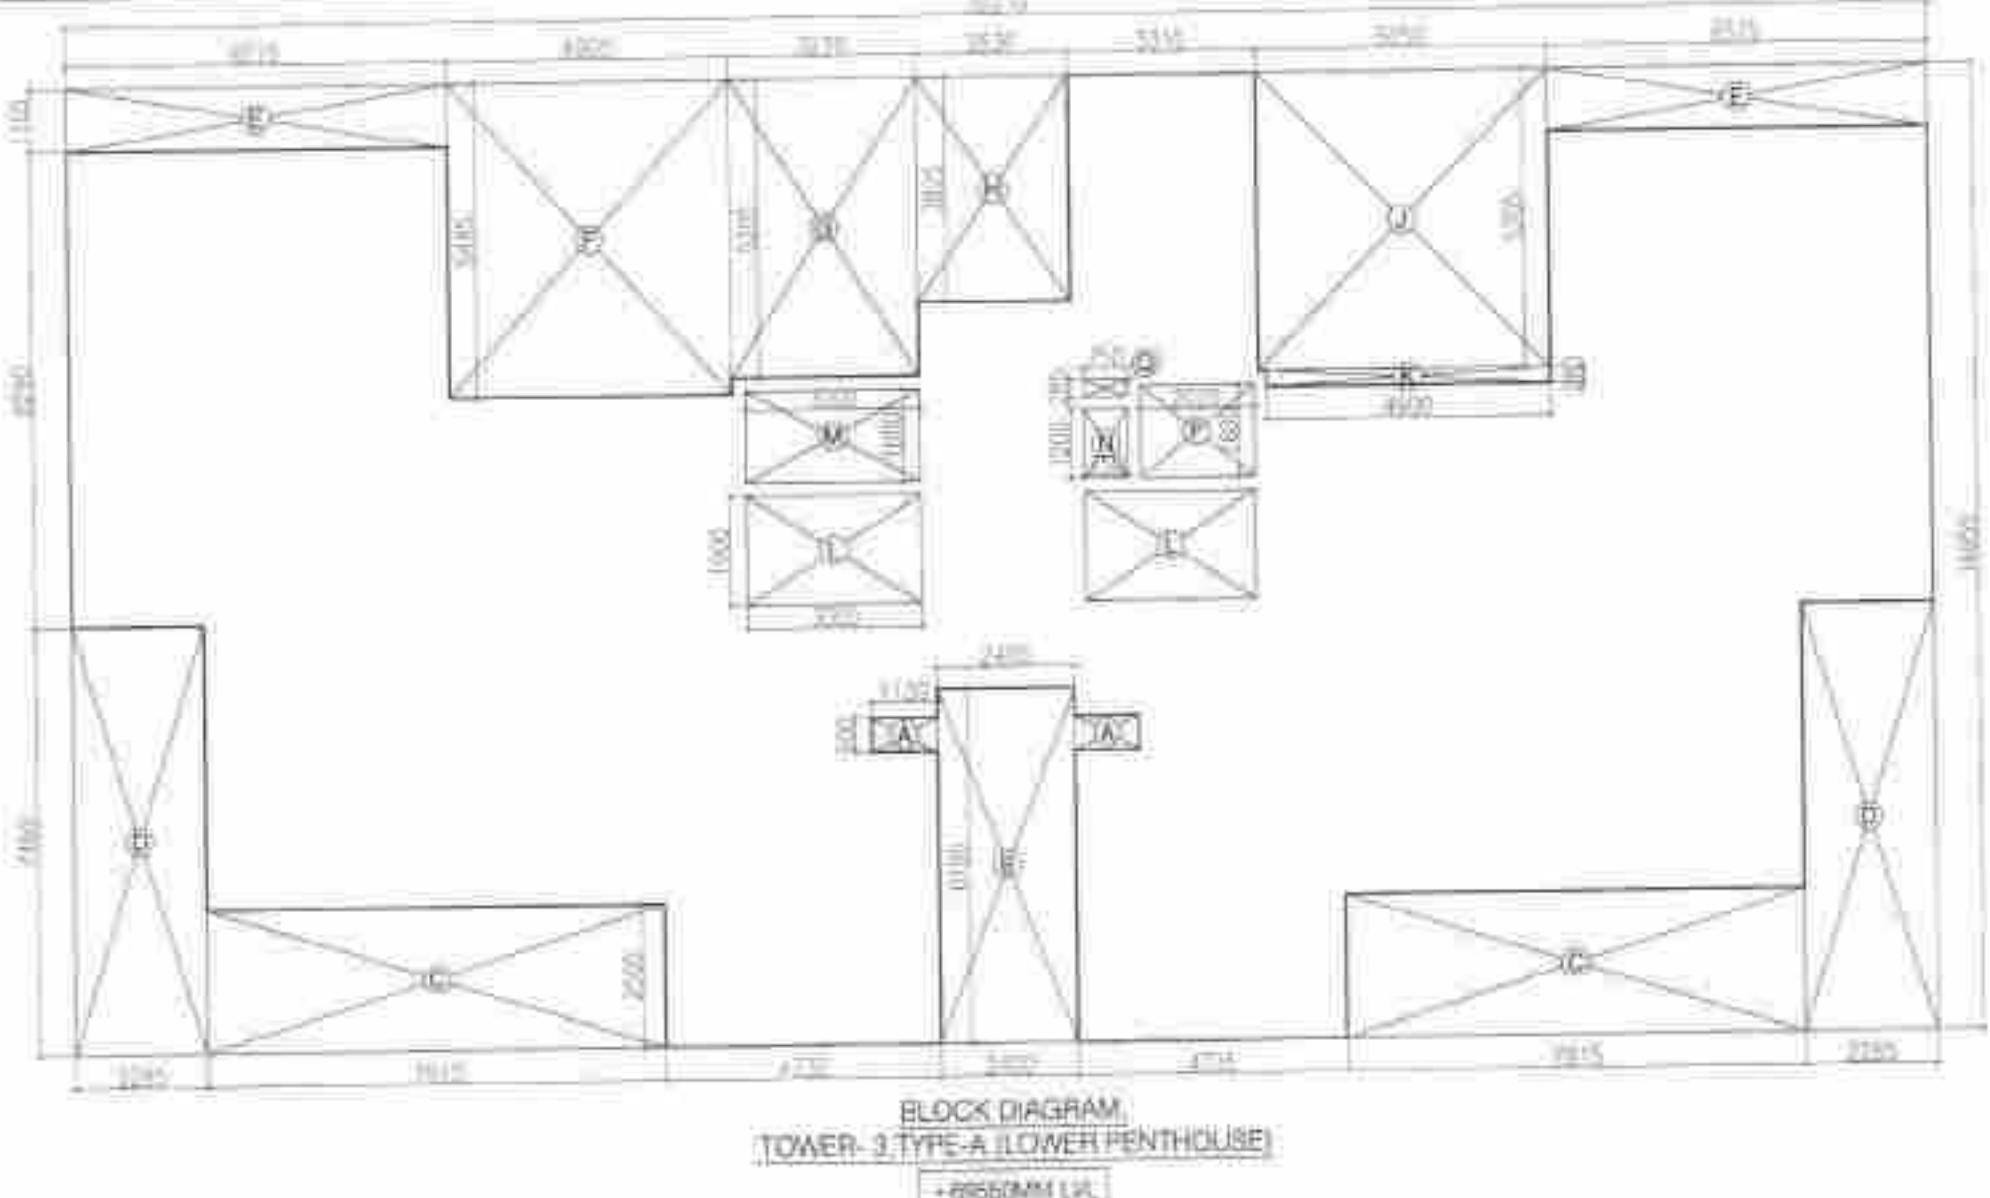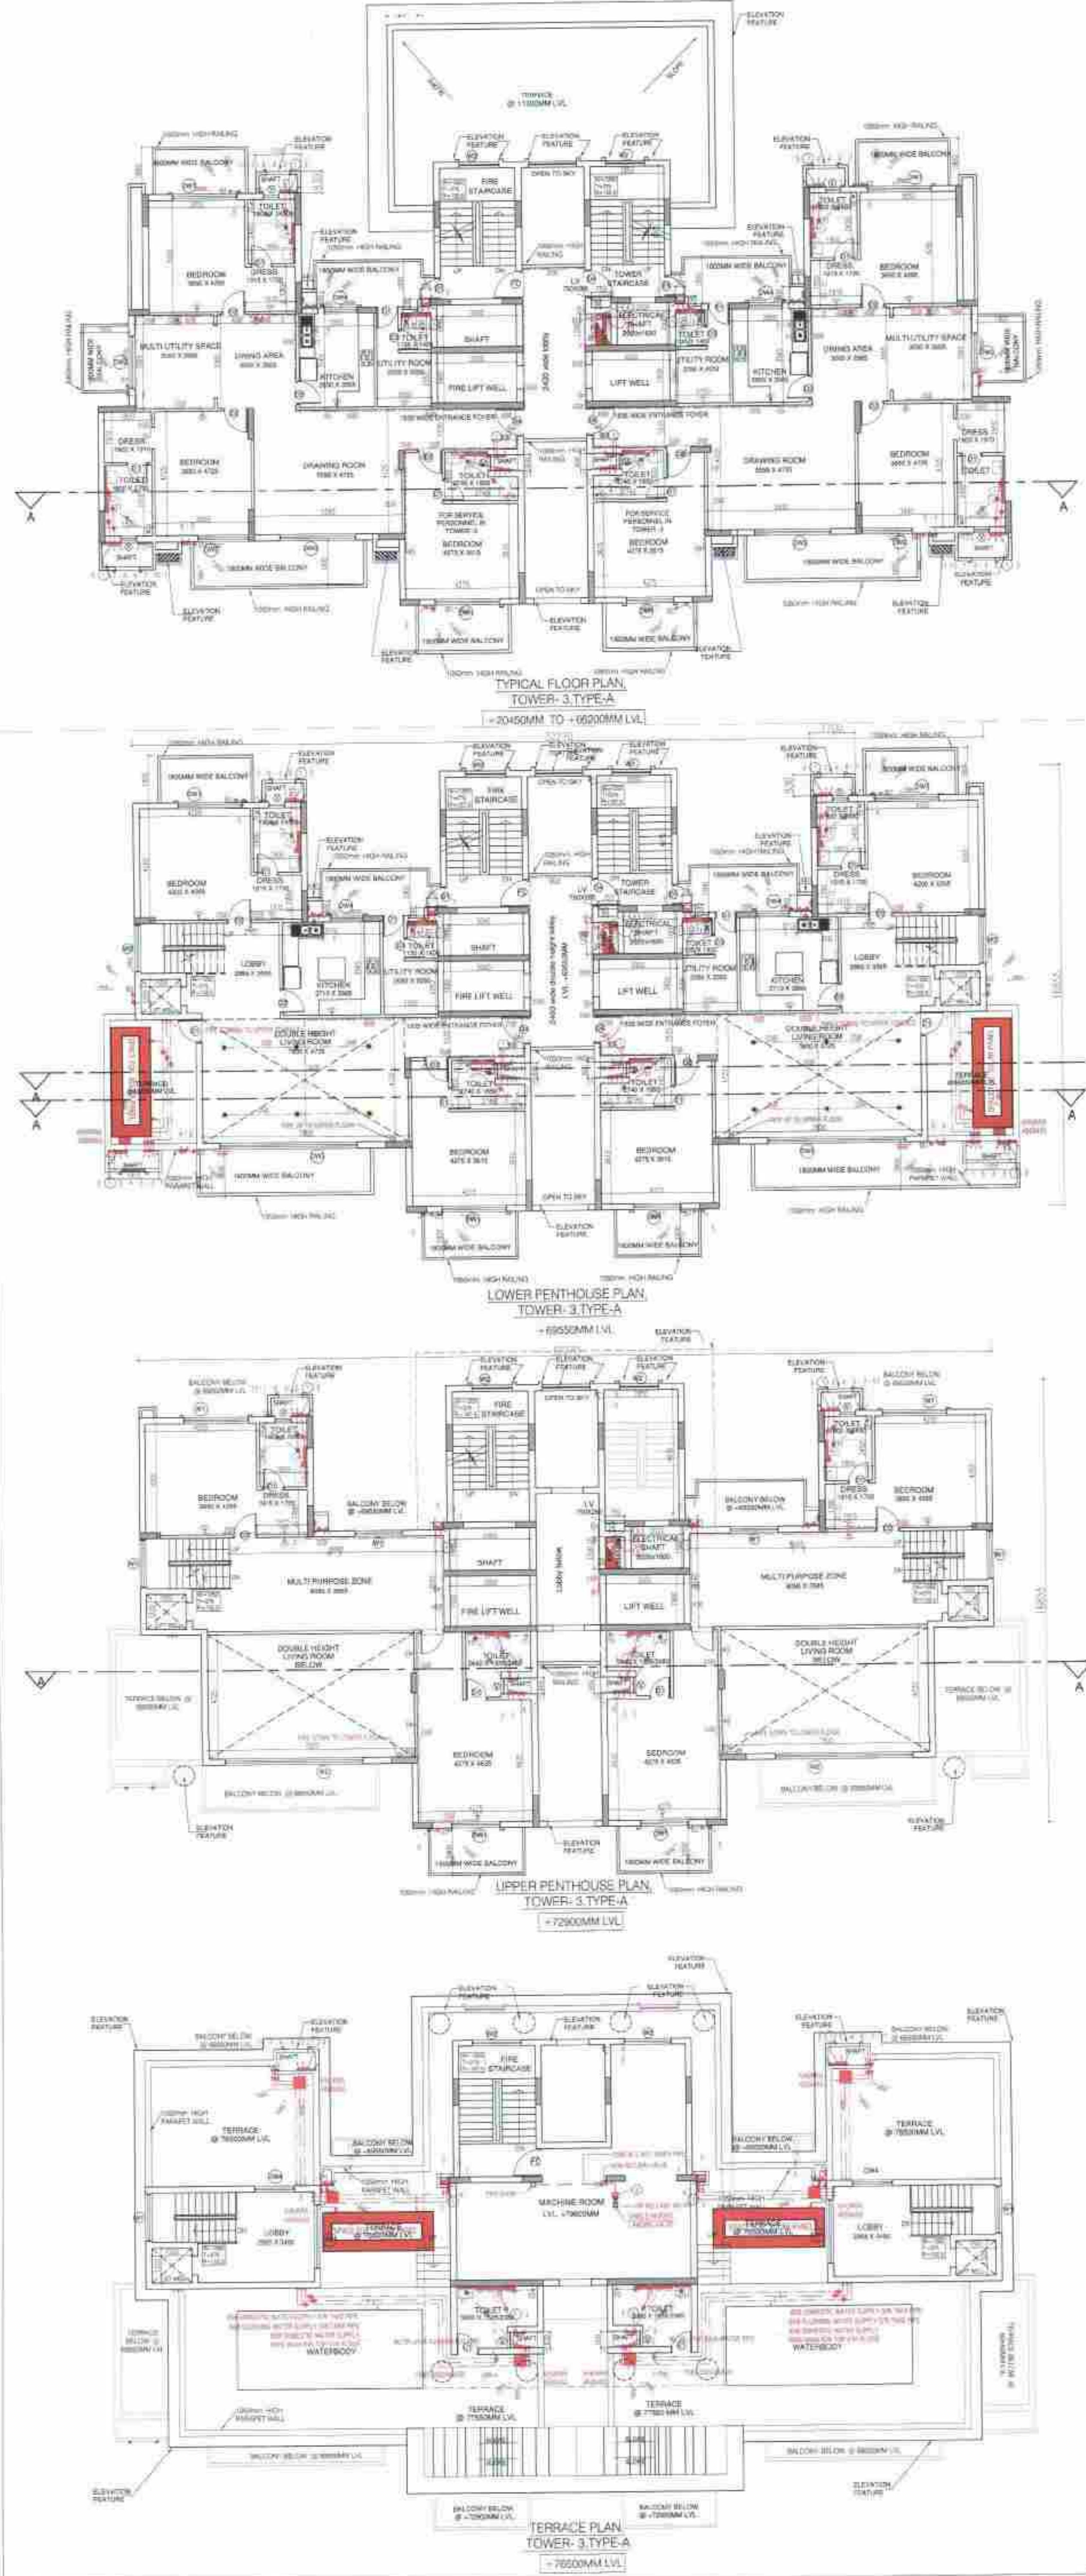


LOWER PENTHOUSE AREA ADDITION			
AREA = (L x B)			
32.270 x 16.855			543.911
<b>ADDITION AREA = 543.91 SQ.MT</b>			
DEDUCTION DETAIL			
A	1.130 X 0.600 X 2	1.356	
B	2.400 X 6.180 X 1	14.832	
C	7.915 X 2.505 X 2	39.654	
D	2.285 X 7.460 X 2	34.092	
E	6.575 X 1.105 X 2	14.531	
F	4.000 X 5.485 X 1	26.877	
G	3.230 X 5.205 X 1	16.812	
H	2.638 X 3.925 X 1	10.323	
J	5.050 X 5.205 X 1	26.285	
K	4.900 X 0.280 X 1	1.372	
L	3.000 X 1.900 X 2	11.400	
M	3.000 X 1.600 X 1	4.800	
N	0.750 X 1.200 X 1	0.900	
P	2.020 X 1.400 X 1	3.232	
Q	0.750 X 0.285 X 1	0.214	
<b>TOTAL = 206.680</b>			

LOWER PENTHOUSE AREA = ADDITION AREA-Deduction Area			
543.911-206.680			= 337.231 SQ.MT
UPPER PENTHOUSE AREA ADDITION			

UPPER PENTHOUSE AREA ADDITION			
AREA CALCULATION			
AREA = (L x B)			
32.270 x 16.855			543.911

ADDITION AREA = 543.911 SQ.MT			
DEDUCTION DETAIL			
A	1.130 X 0.600 X 2	1.356	
B	2.400 X 7.460 X 1	17.904	
C	7.915 X 2.505 X 2	39.654	
D	2.285 X 7.460 X 2	34.092	
E	6.575 X 4.725 X 2	73.710	
F	1.500 X 1.320 X 2	3.960	
G	6.575 X 1.105 X 2	14.531	
H	4.900 X 5.485 X 1	26.877	
J	3.230 X 5.205 X 1	16.812	
K	2.630 X 3.925 X 1	10.323	
L	3.000 X 1.900 X 2	11.400	
M	3.000 X 1.600 X 1	4.800	
N	0.750 X 1.200 X 1	0.900	
P	2.020 X 1.400 X 1	3.232	
Q	0.750 X 0.285 X 1	0.214	
R	5.050 X 5.205 X 1	26.285	
S	4.900 X 0.280 X 1	1.372	
T	2.850 X 4.975 X 1	14.179	
U	2.400 X 5.010 X 1	12.024	
<b>TOTAL = 313.624</b>			

UPPER PENTHOUSE AREA = ADDITION AREA-Deduction Area			
543.911-301.624			= 230.287 SQ.MT
NOTES			

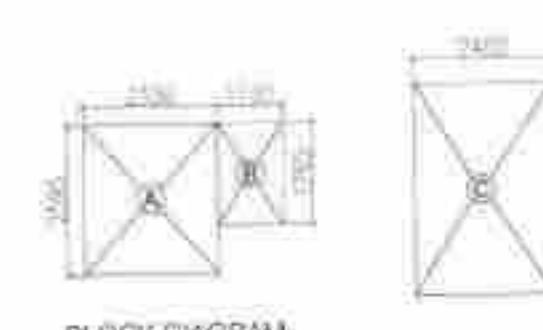

TERRACE AREA ADDITION			
AREA CALCULATION			
AREA = (L x B)			
A = 2.33 x 2.595 X 2			12.093
B = 1.13 x 1.765 X 2			3.589
C = 2.4 x 3.695 X 1			8.668
<b>ADDITION AREA = 20.961 SQ.MT</b>			

#### OPENING SCHEDULE OF DOORS & WINDOWS

SR. NO	SIZE	SILL	LINTEL	TYPE
1	800 X 2100	-	2100	D1
2	900 X 2100	-	2100	D2
3	750 X 2100	-	2100	D3
4	1050 X 2400	-	2400	D4
5	1050 X 2100	-	2100	FD
6	2430 X 2325	-	2325	DW1
7	2000 X 2325	-	2325	DW2
8	2880 X 2325	-	2325	DW3
9	1500 X 2325	-	2325	DW4
10	1800 X 1275	900	B.O.B.	W1
11	600 X 1275	1050	2325	V

PLUMBING NOTES:-			
1	WASH BASIN TO FLOOR TRAP (FT) 40 OD UPVC PIPE		
2	KITCHEN SINK TO FLOOR TRAP (FT) FLEXIBLE PIPE		
3	FLOOR DRAIN (FD) TO FLOOR TRAP (FT)		
4	63 OD UPVC WASTE PIPE USED FOR SOIL & WASTE.		
5	110 OD UPVC PIPE USED FOR TERRACE RAIN WATER		
6	90 OD UPVC PIPE USED FOR BALCONY		
SCHEDULE OF PIPES :-			
PIPE NO.	DESCRIPTION		
1	110 OD UPVC SOIL & VENT PIPE		
2	110 OD UPVC WASTE & VENT PIPE		
3	75 OD UPVC ANTI-SIPHONAGE PIPE		
4	110 OD UPVC TERRACE RAIN WATER PIPE		
5	90 OD UPVC BALCONY MAIN WATER PIPE		
6	DOMESTIC WATER SUPPLY DN TAKE PIPE*		
7	FLUSHING WATER SUPPLY DN TAKE PIPE*		
8	800 DOMESTIC WATER SUPPLY RISER *		
9	400 FLUSHING WATER SUPPLY RISER *		
10	HOT WATER SUPPLY DN TAKE PIPE FROM SOLAR PANEL *		
11	DOMESTIC WATER SUPPLY DN TAKE PIPE FOR TOP 4th FLOOR		

D.T.P (HO)  
D.T.P (HO)  
C.Y.P. (H)  
B.P.A.C.  
B.P.A.C.

1. DIMENSIONS ARE NOT TO BE SCALED.
2. ALL DIMENSIONS ARE IN MM.
3. ALL ELECTRICAL INSTALLATIONS SHALL BE AS PER PROVISIONS OF NBC.
4. FIRE FIGHTING SAFETY PROVISIONS WILL BE AS PER RELEVANT NBC PROVISIONS.
5. BOUNDARY WALL AND GATE AS PER STANDARDS.
6. ALL WALLS ARE 230/115 MM THK. BRICK WALL.
7. RAIN WATER HARVESTING SYSTEM SHALL BE PROVIDED AS PER CENTRAL GROUND WATER AUTHORITY NORMS/HARYANA GOVT.
8. ALL WINDOWS & VENTILATORS ARE OPENABLE.
9. ALL MECHANICALLY VENTILATED & ARTIFICIALLY LIT TOILET PROVIDED WITH 24hr POWER BACKUP.

DEVELOPED BY:

PROJECT:

PROPOSED BUILDING PLAN OF GROUP HOUSING COLONY AREA MEASURING 11.125 ACRES (LICENSE NO. 87 OF 2013 DATED 11-10-2013 IN SECTOR-89-A, GURGAON MANESAR URBAN COMPLEX BEING DEVELOPED BY DALE DEVELOPERS PVT. LTD. AND OTHERS IN COLLABORATION WITH VATIKA LTD.

DRAWING TITLE : TOWER -3,TYPE -A , FLOOR PLAN & AREA DIAGRAM +20450 TO +6550 MM LVL

DEALT BY : DATE : 1:100 @ A0 DRG. NO. A-1.2








CHECKED BY : DATE :

THROUGH : AUTHORISED SIGNATORY

For VATIKA LIMITED  
MANESAR  
GURGAON  
HARYANA  
INDIA  
MANESAR Bypass  
Car No. 2005/2250  
OWNER'S SIGN ARCHITECT'S SIGN



TOWER b

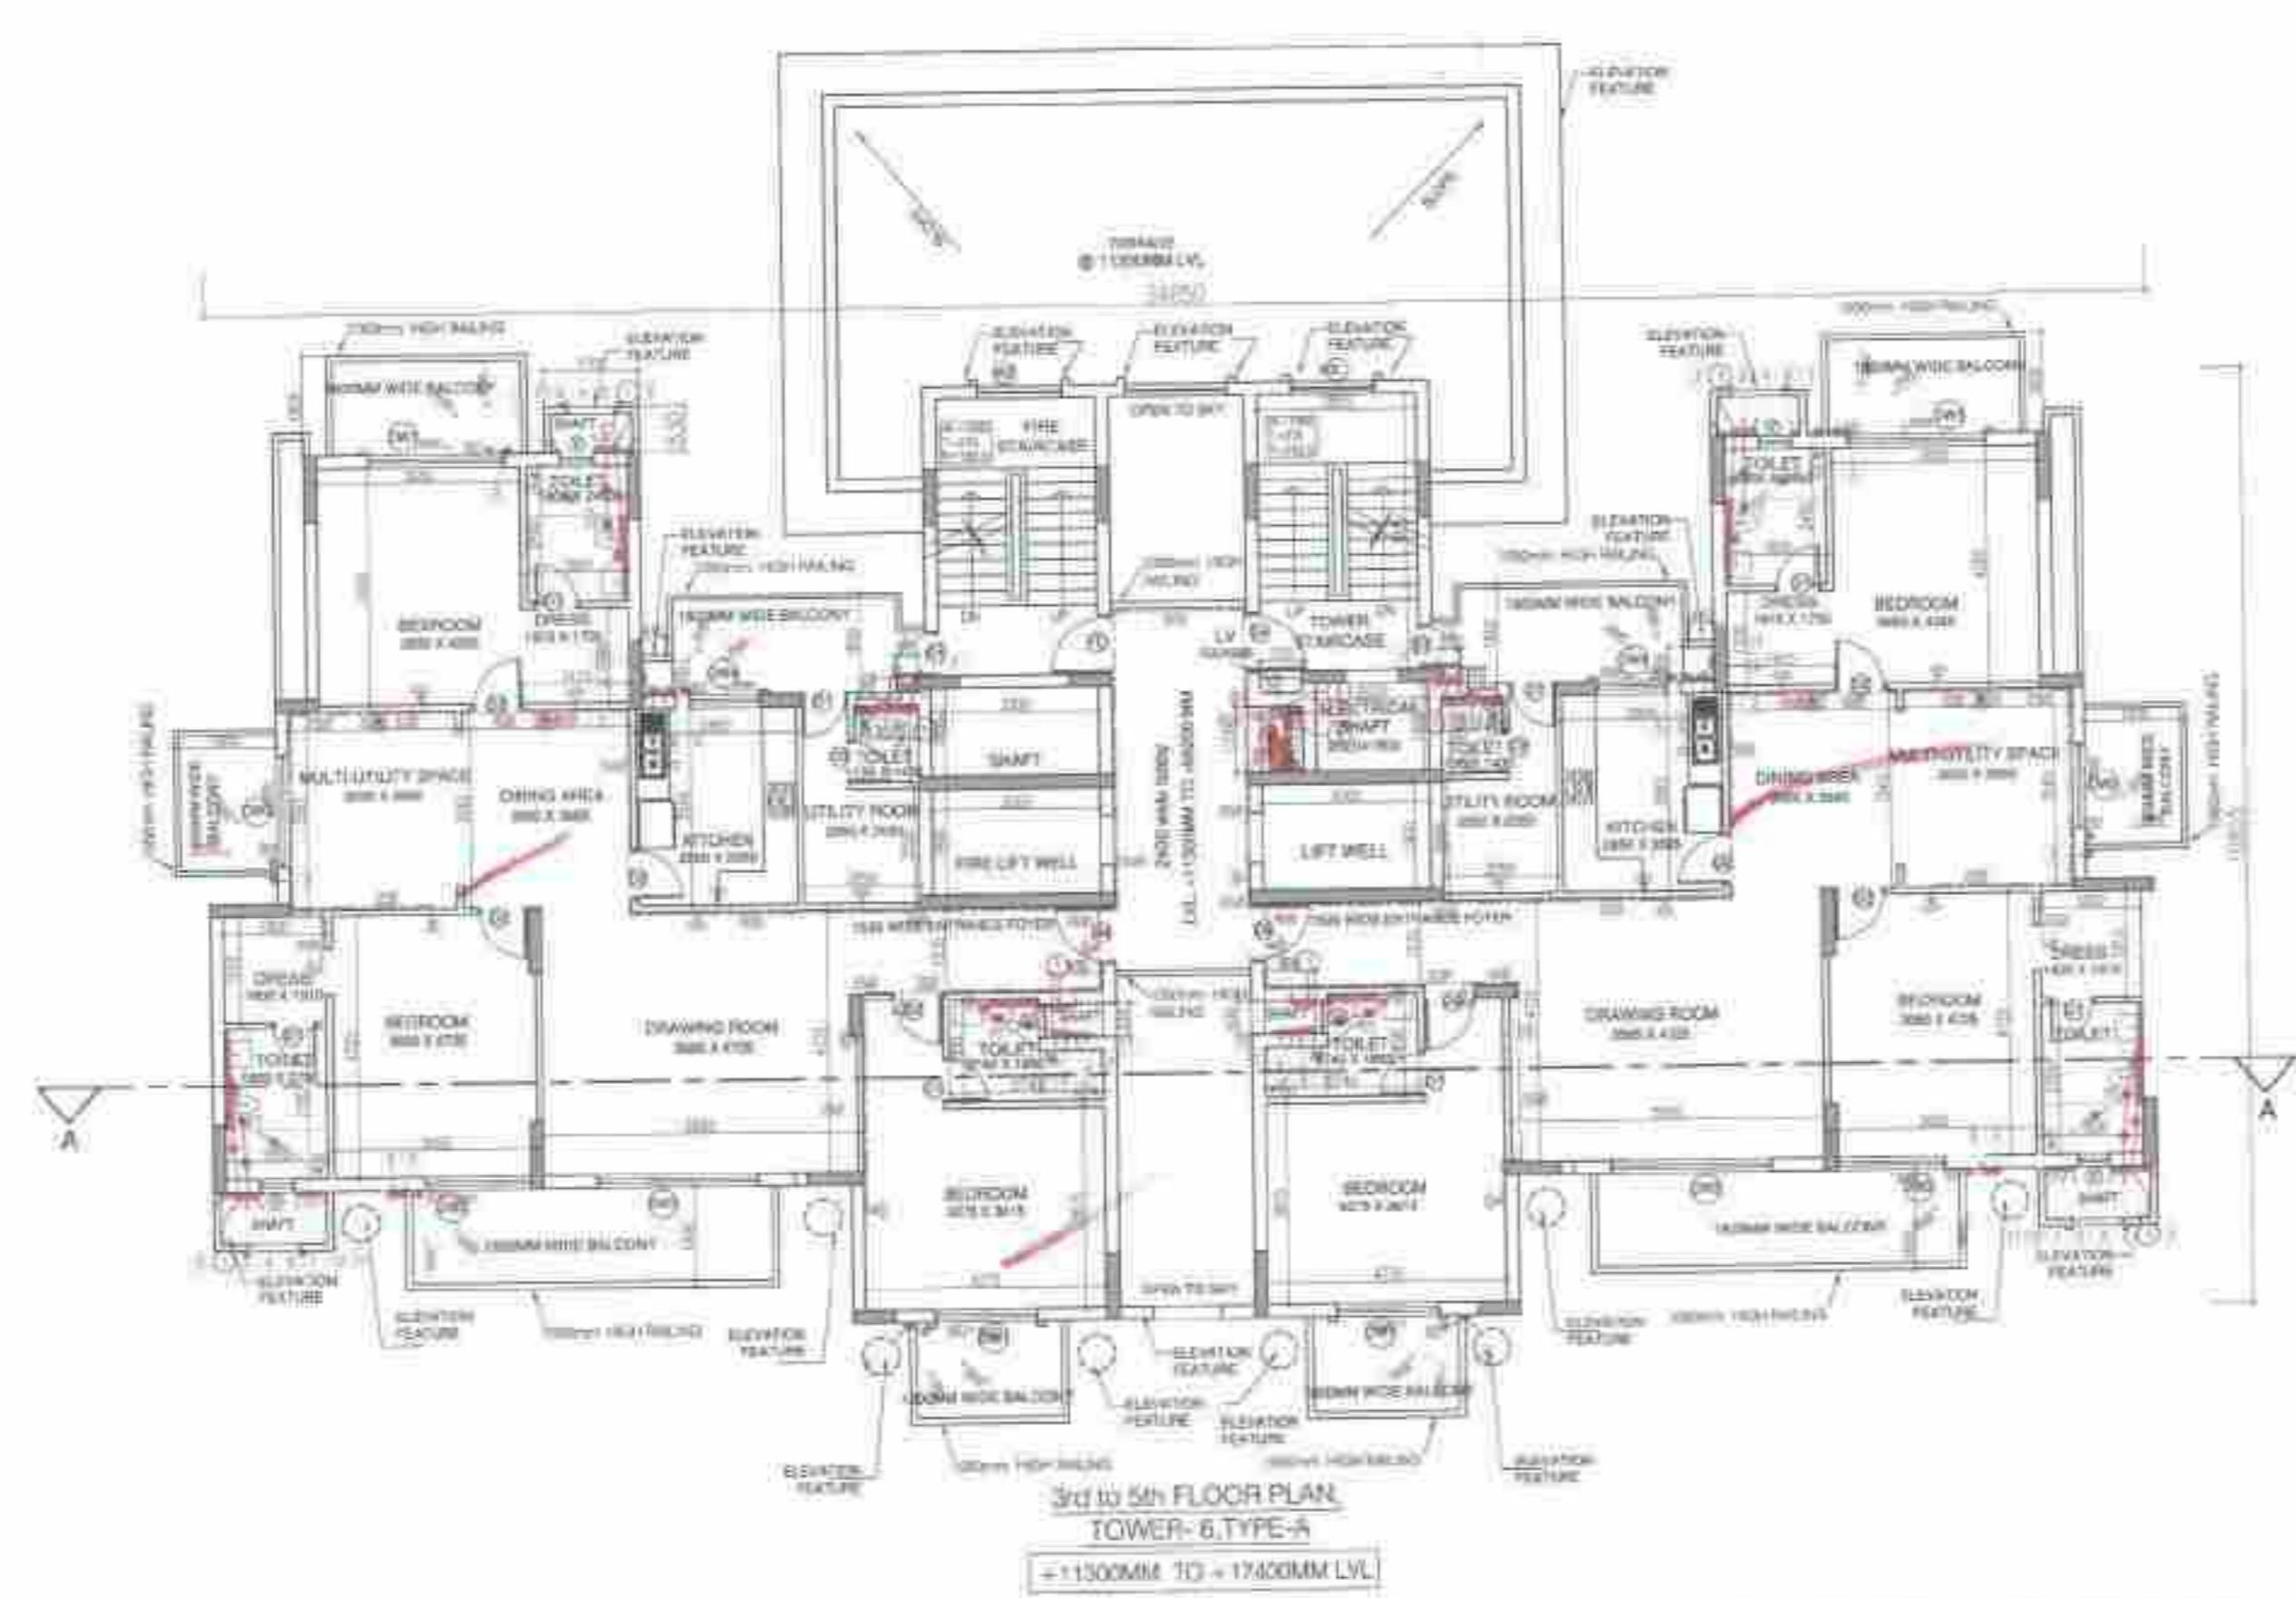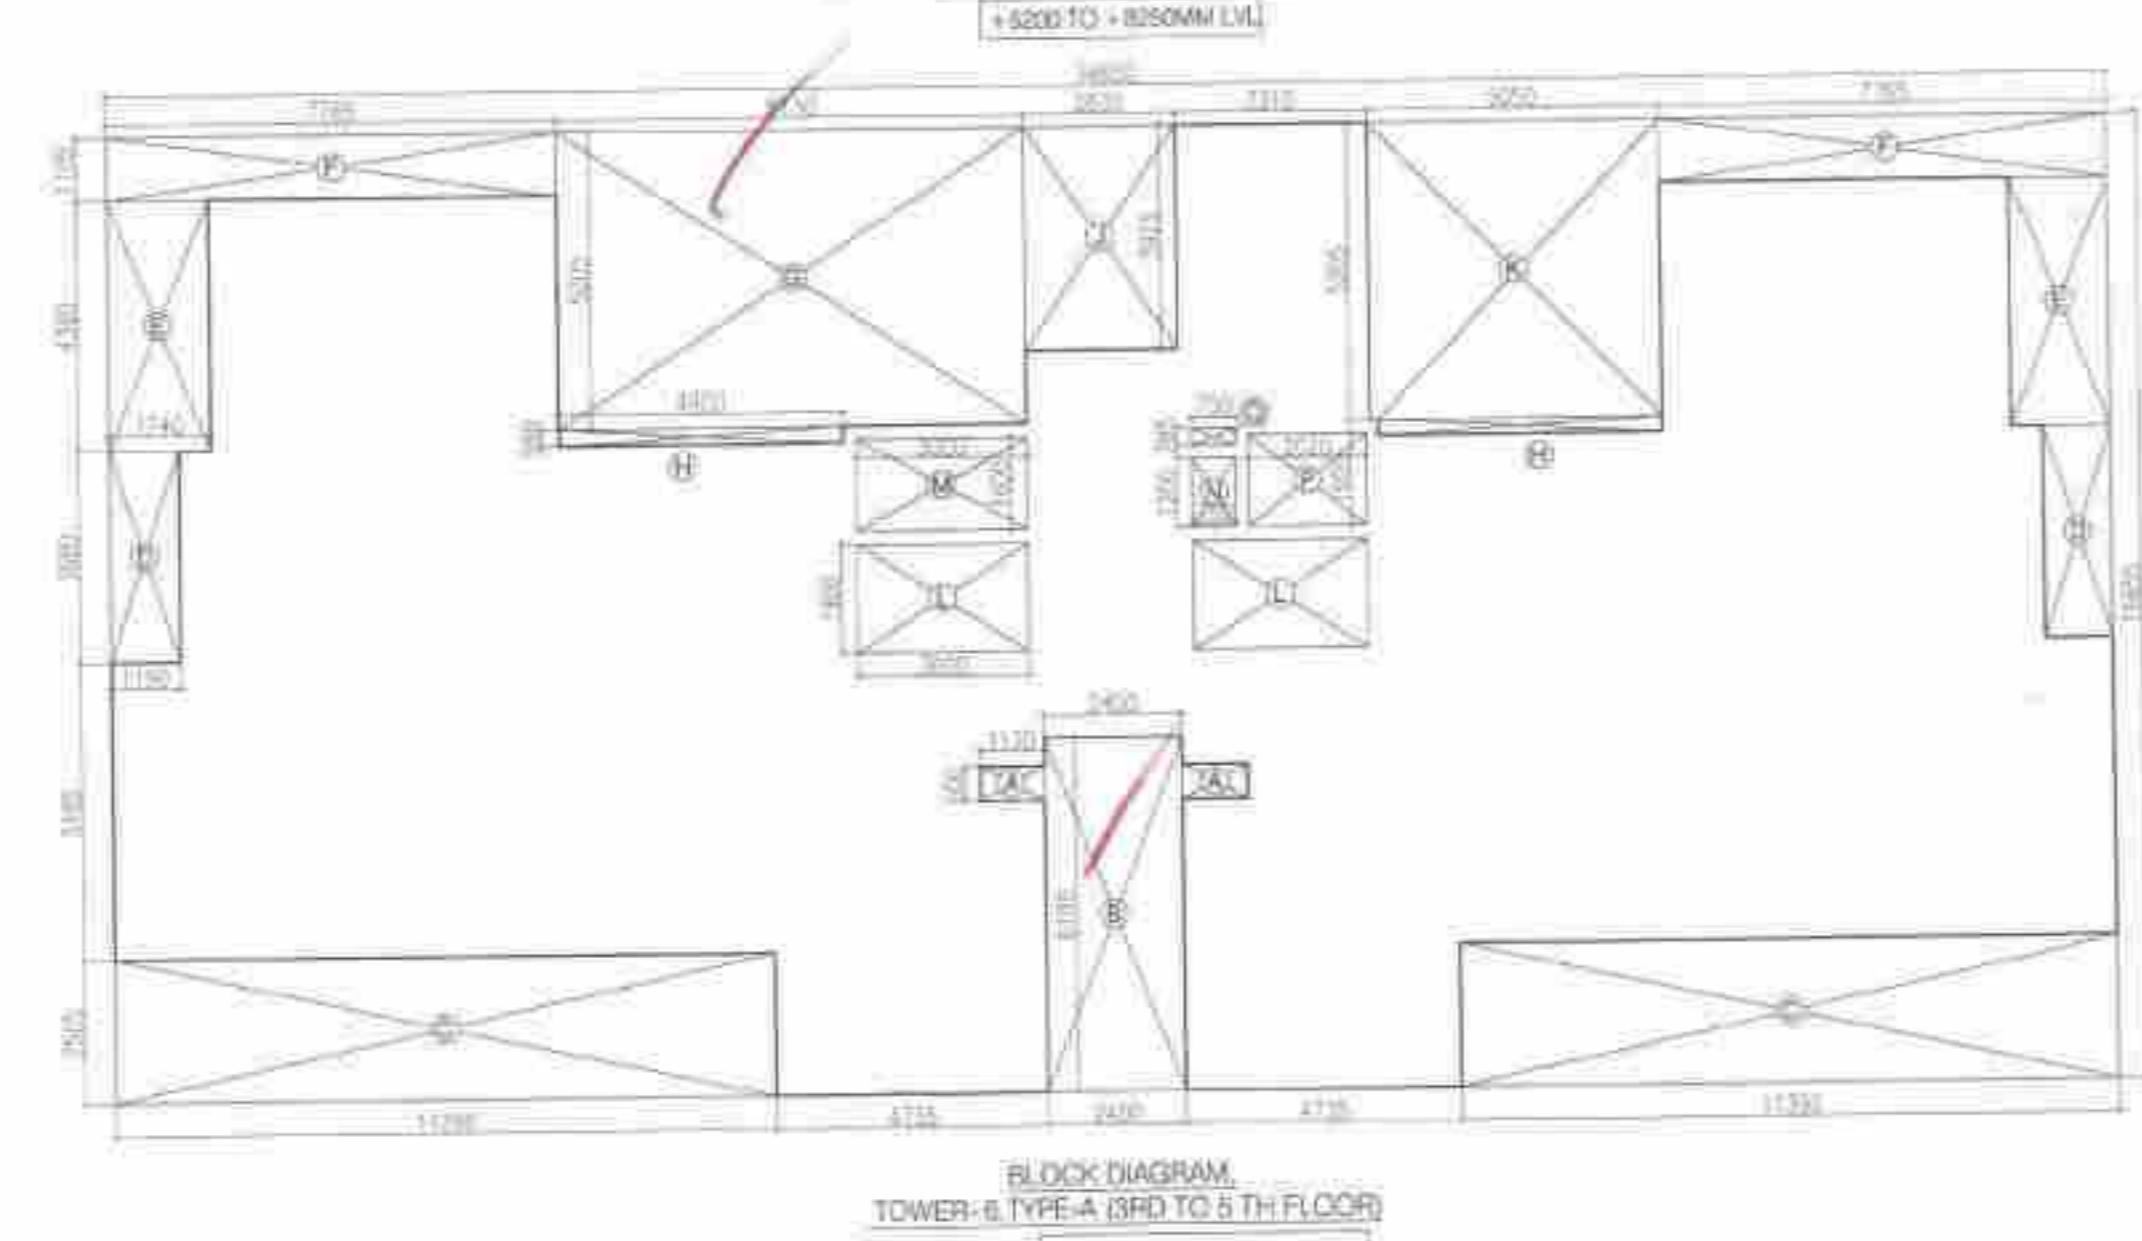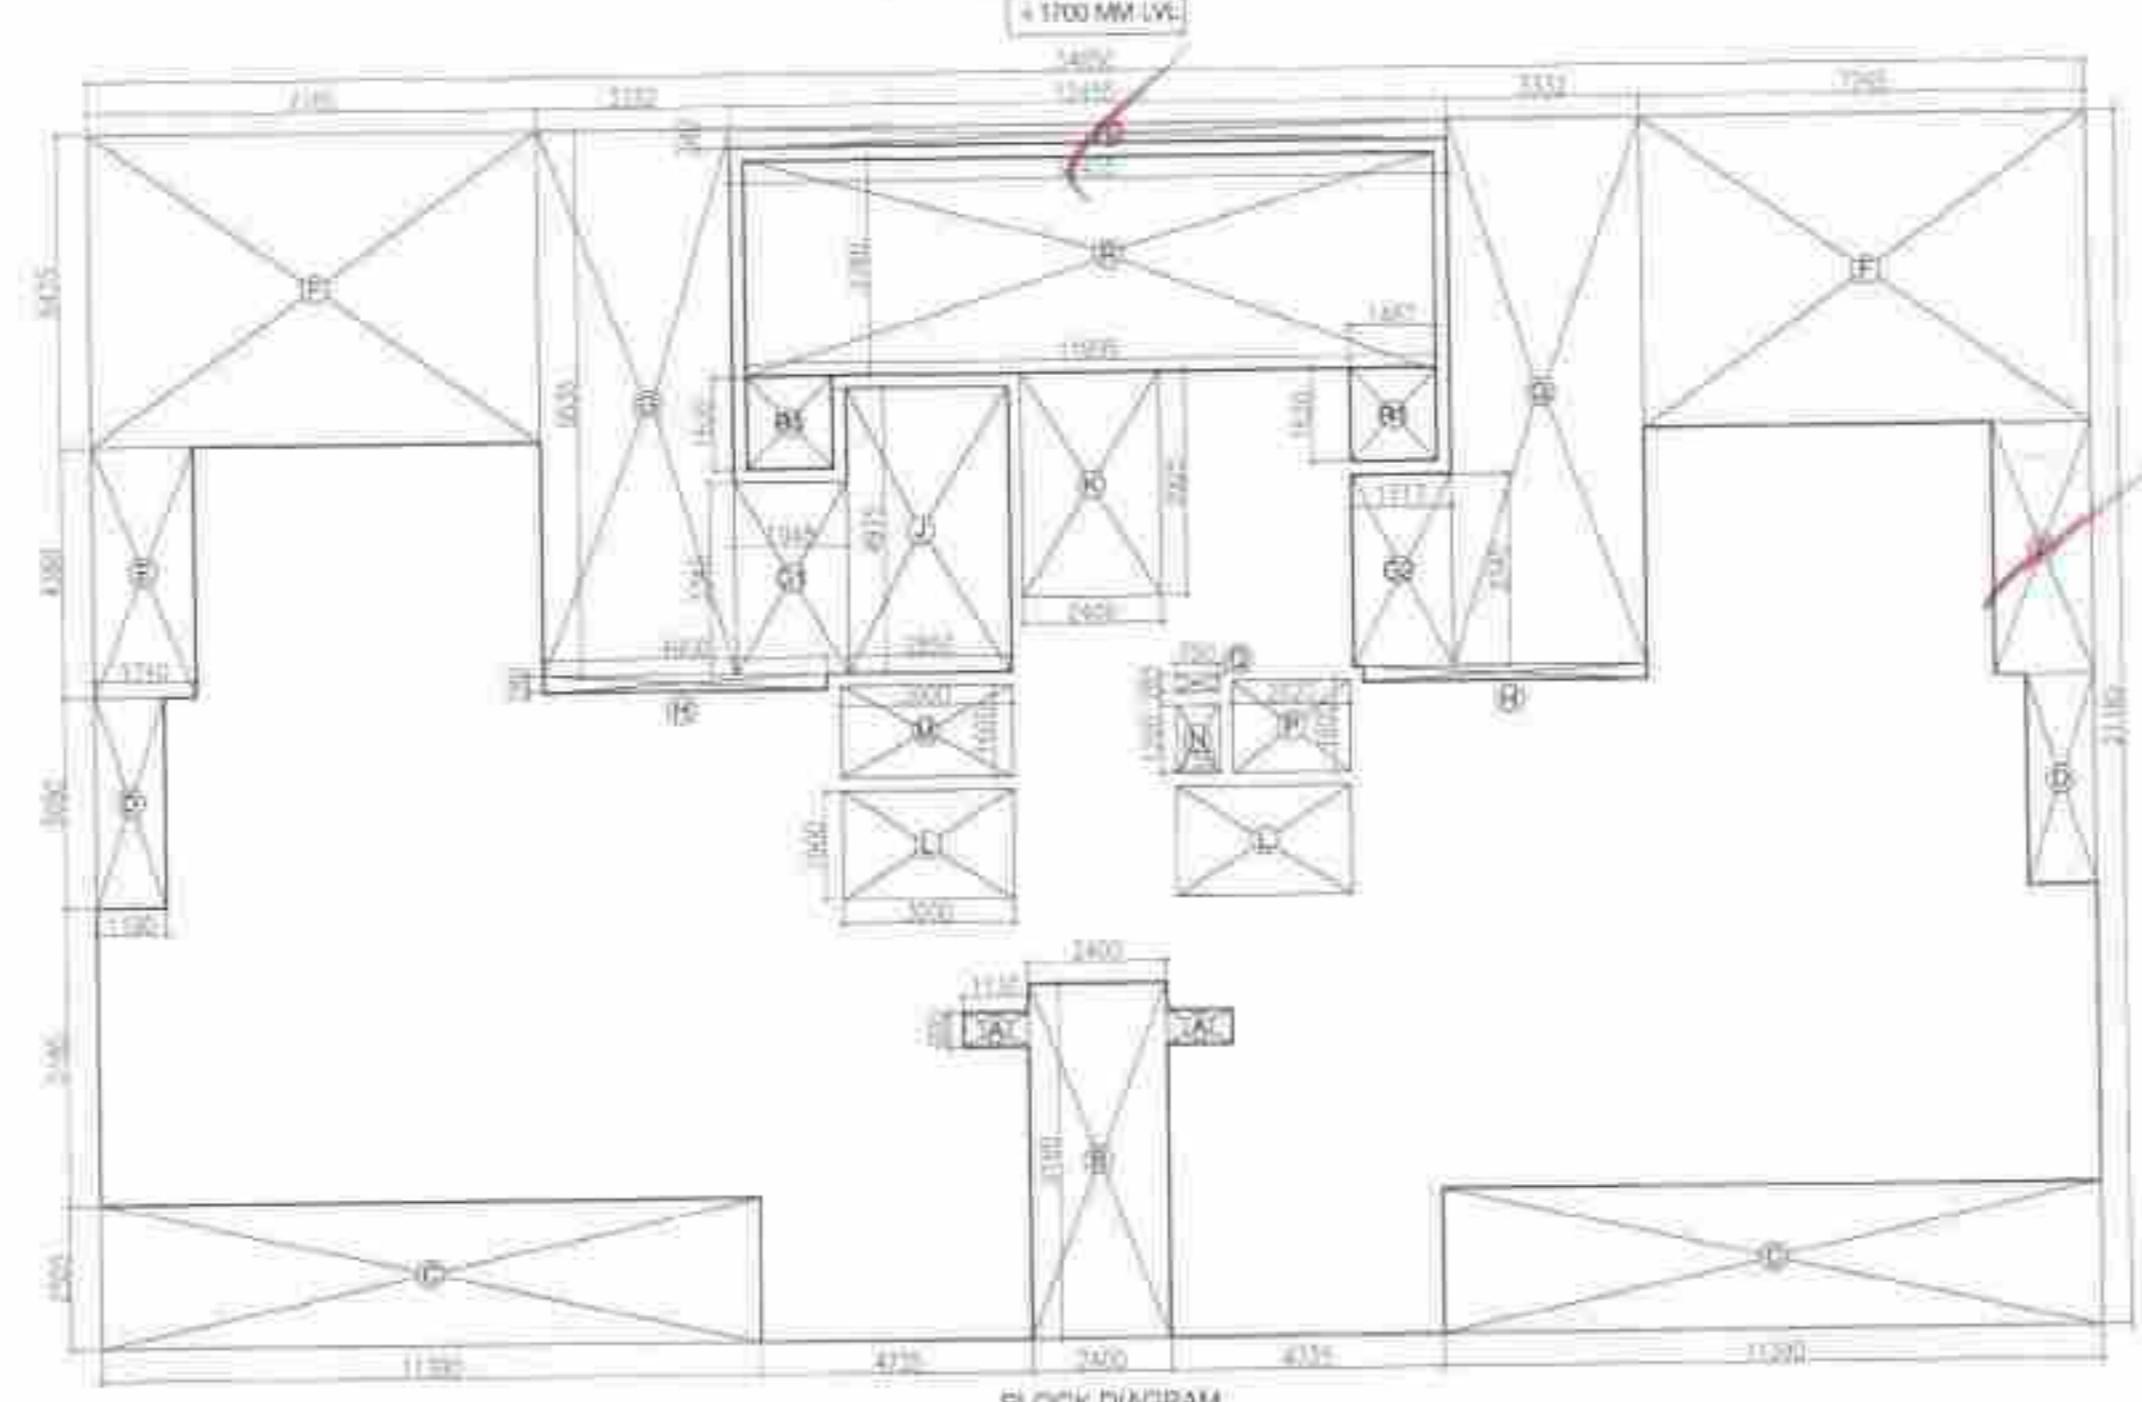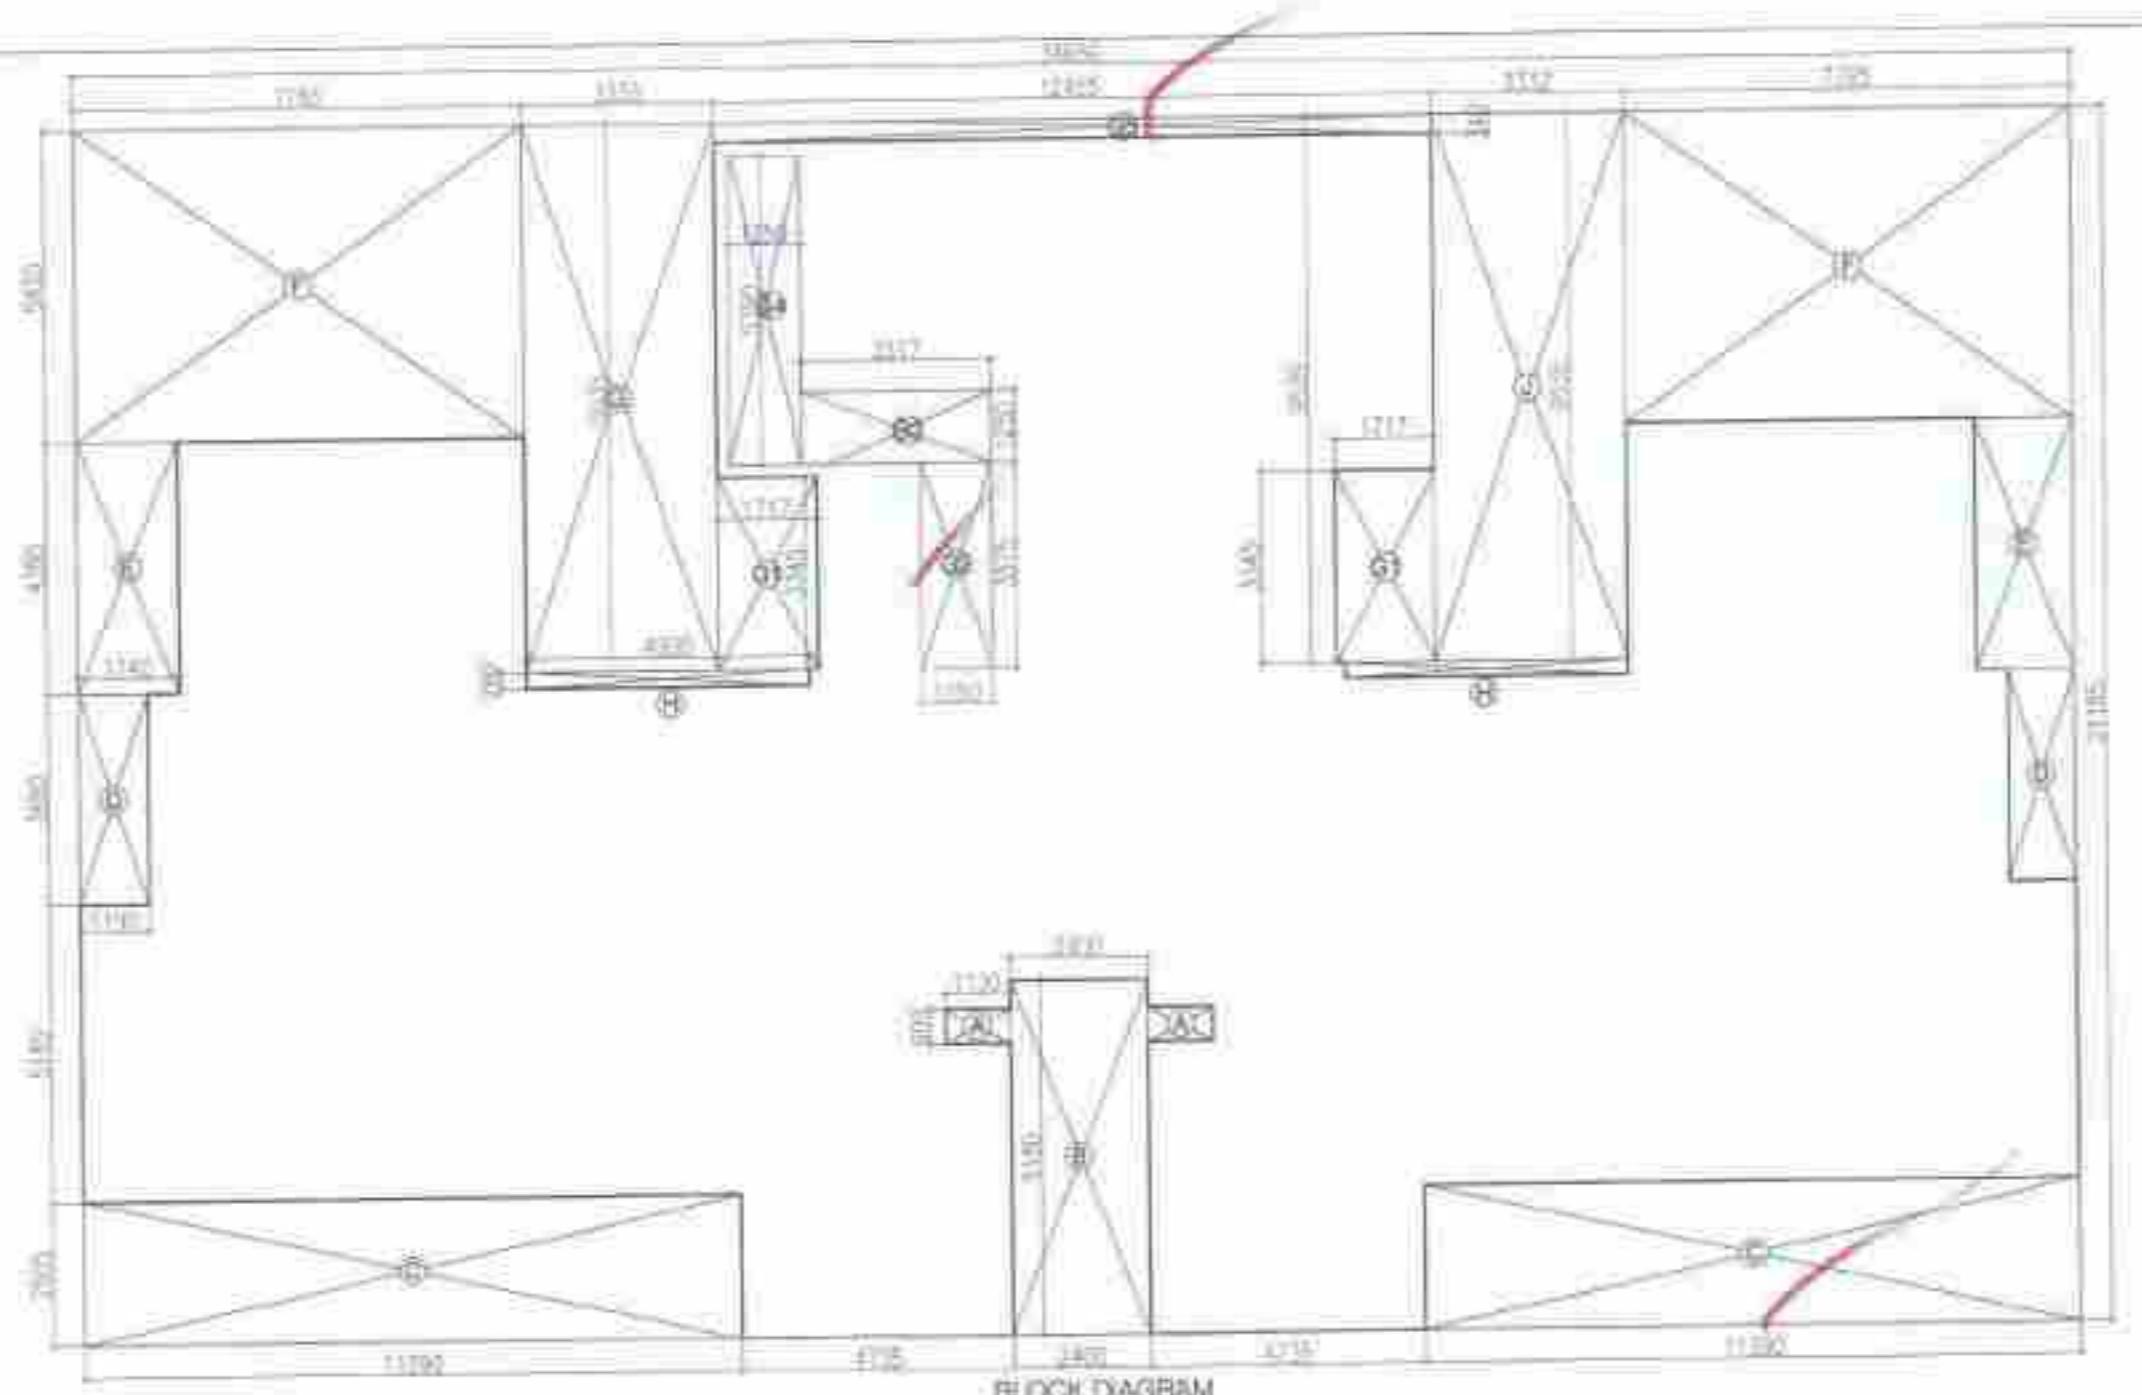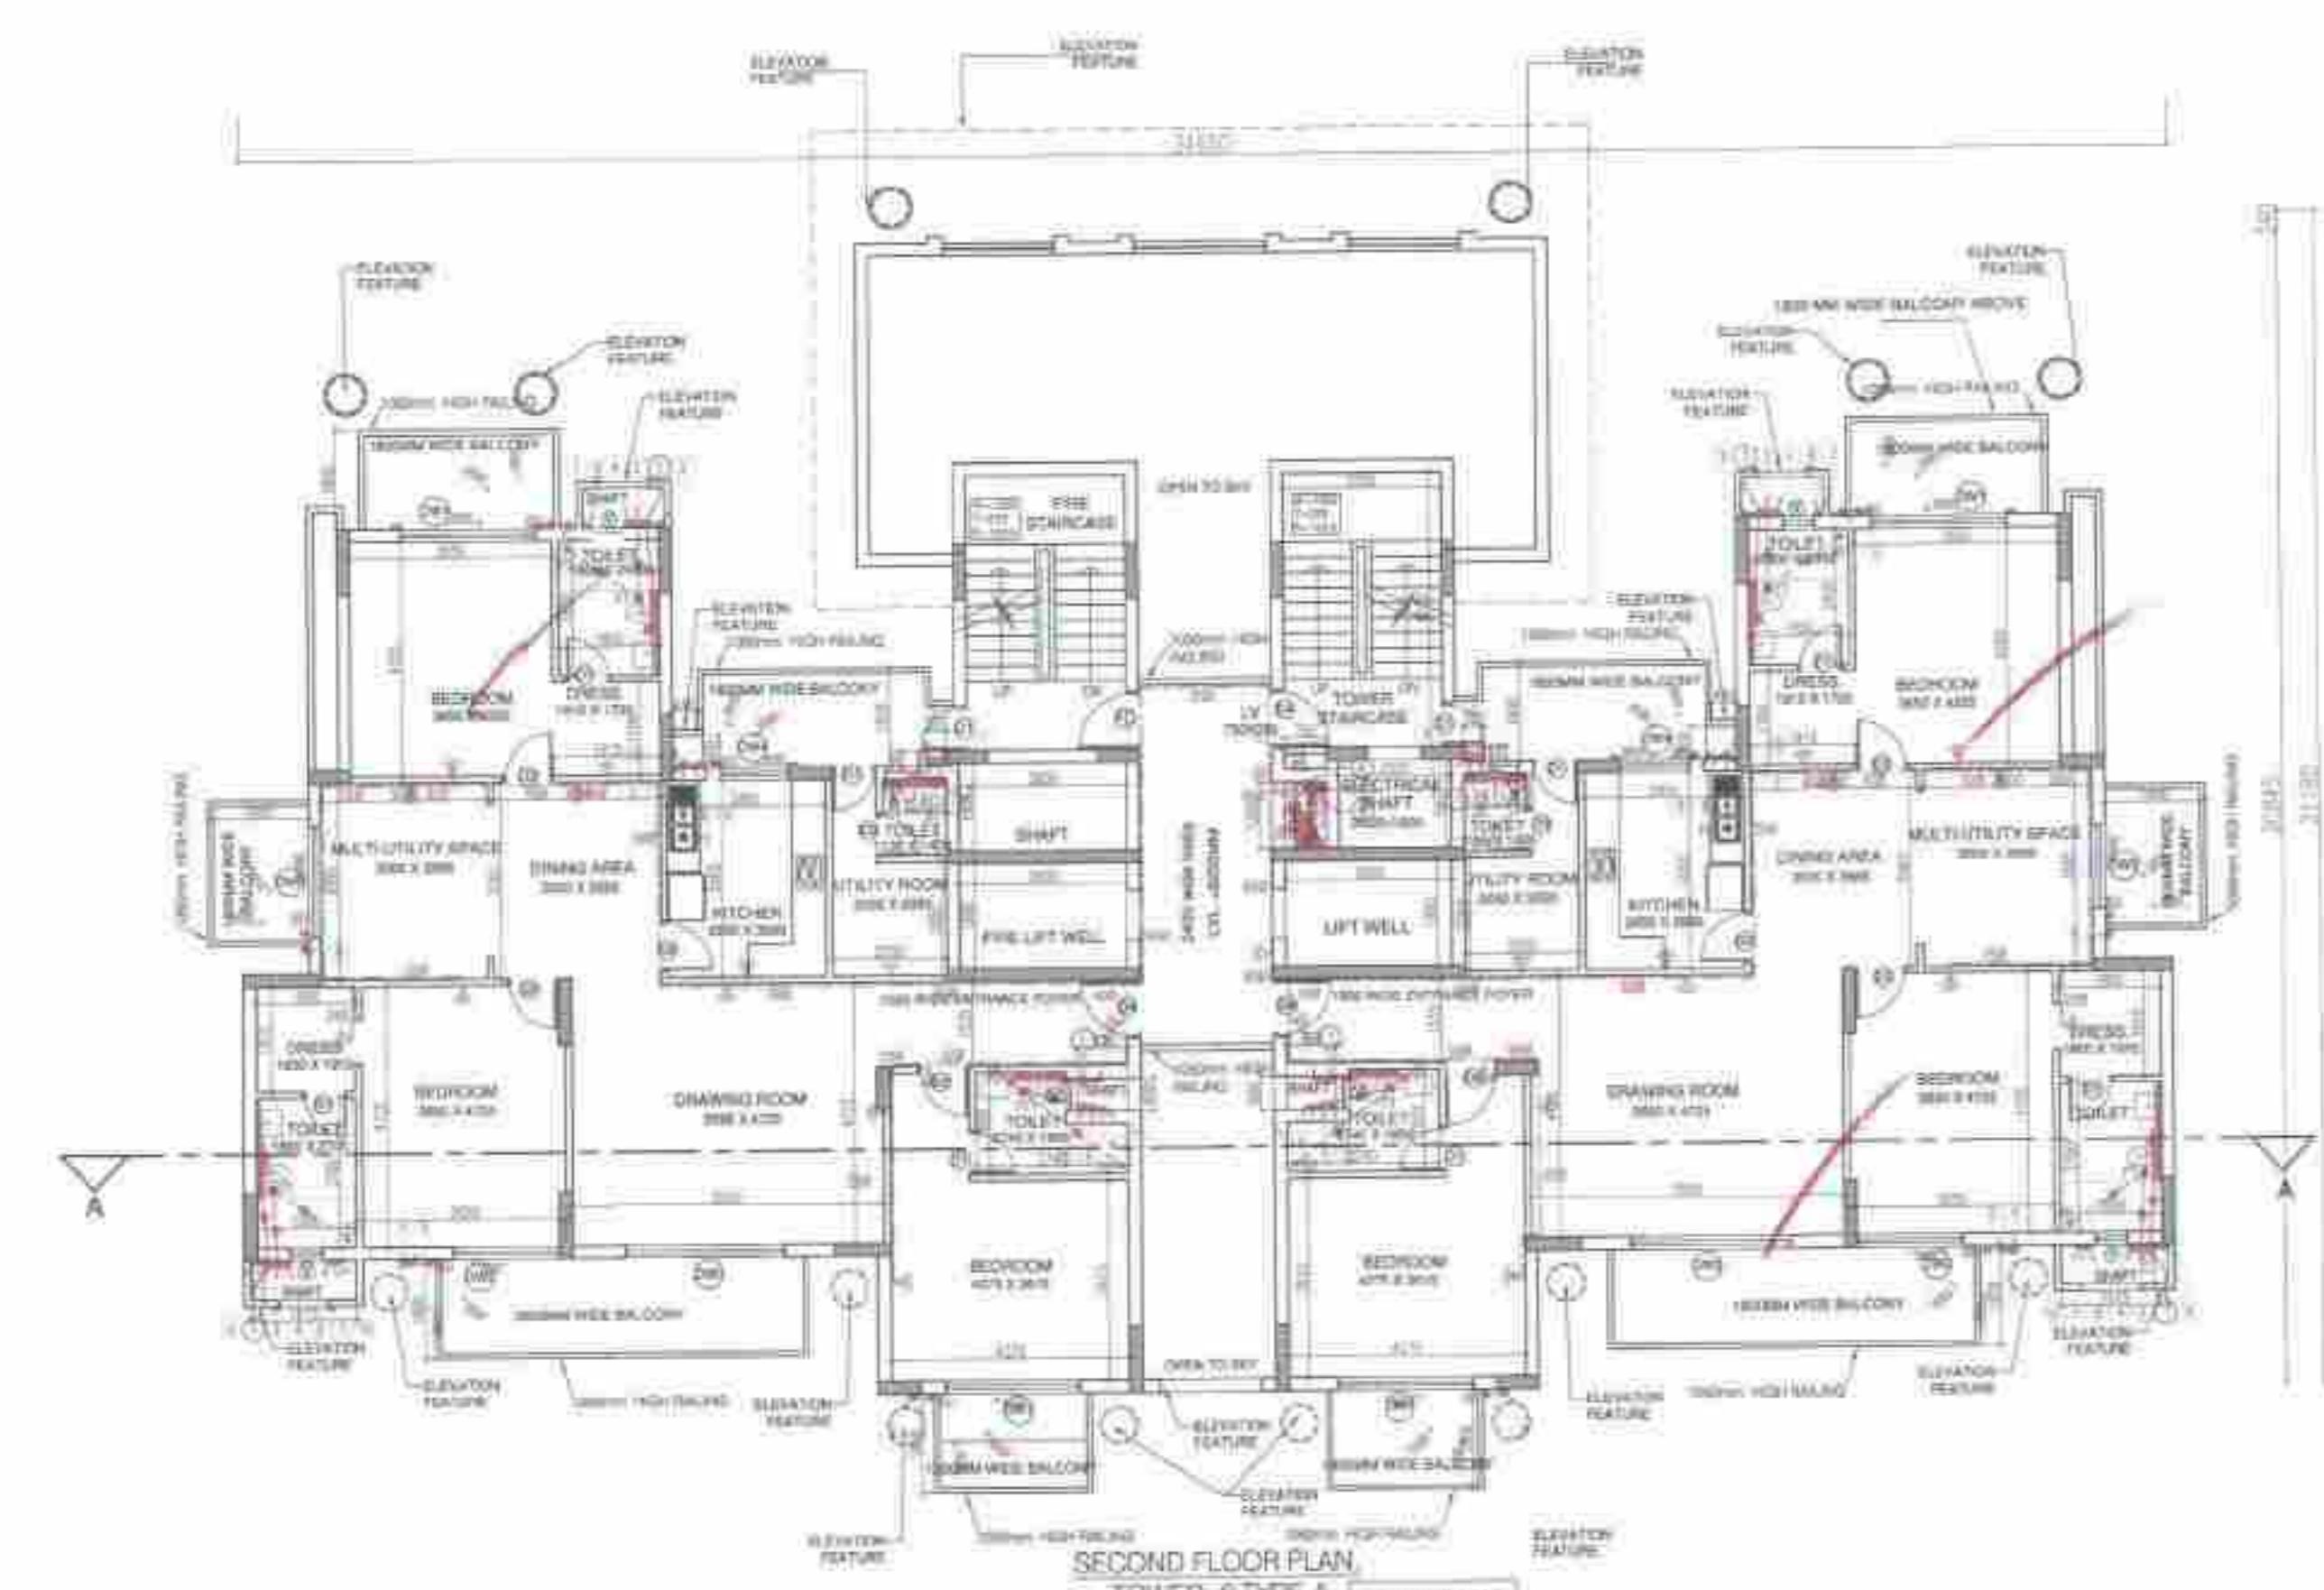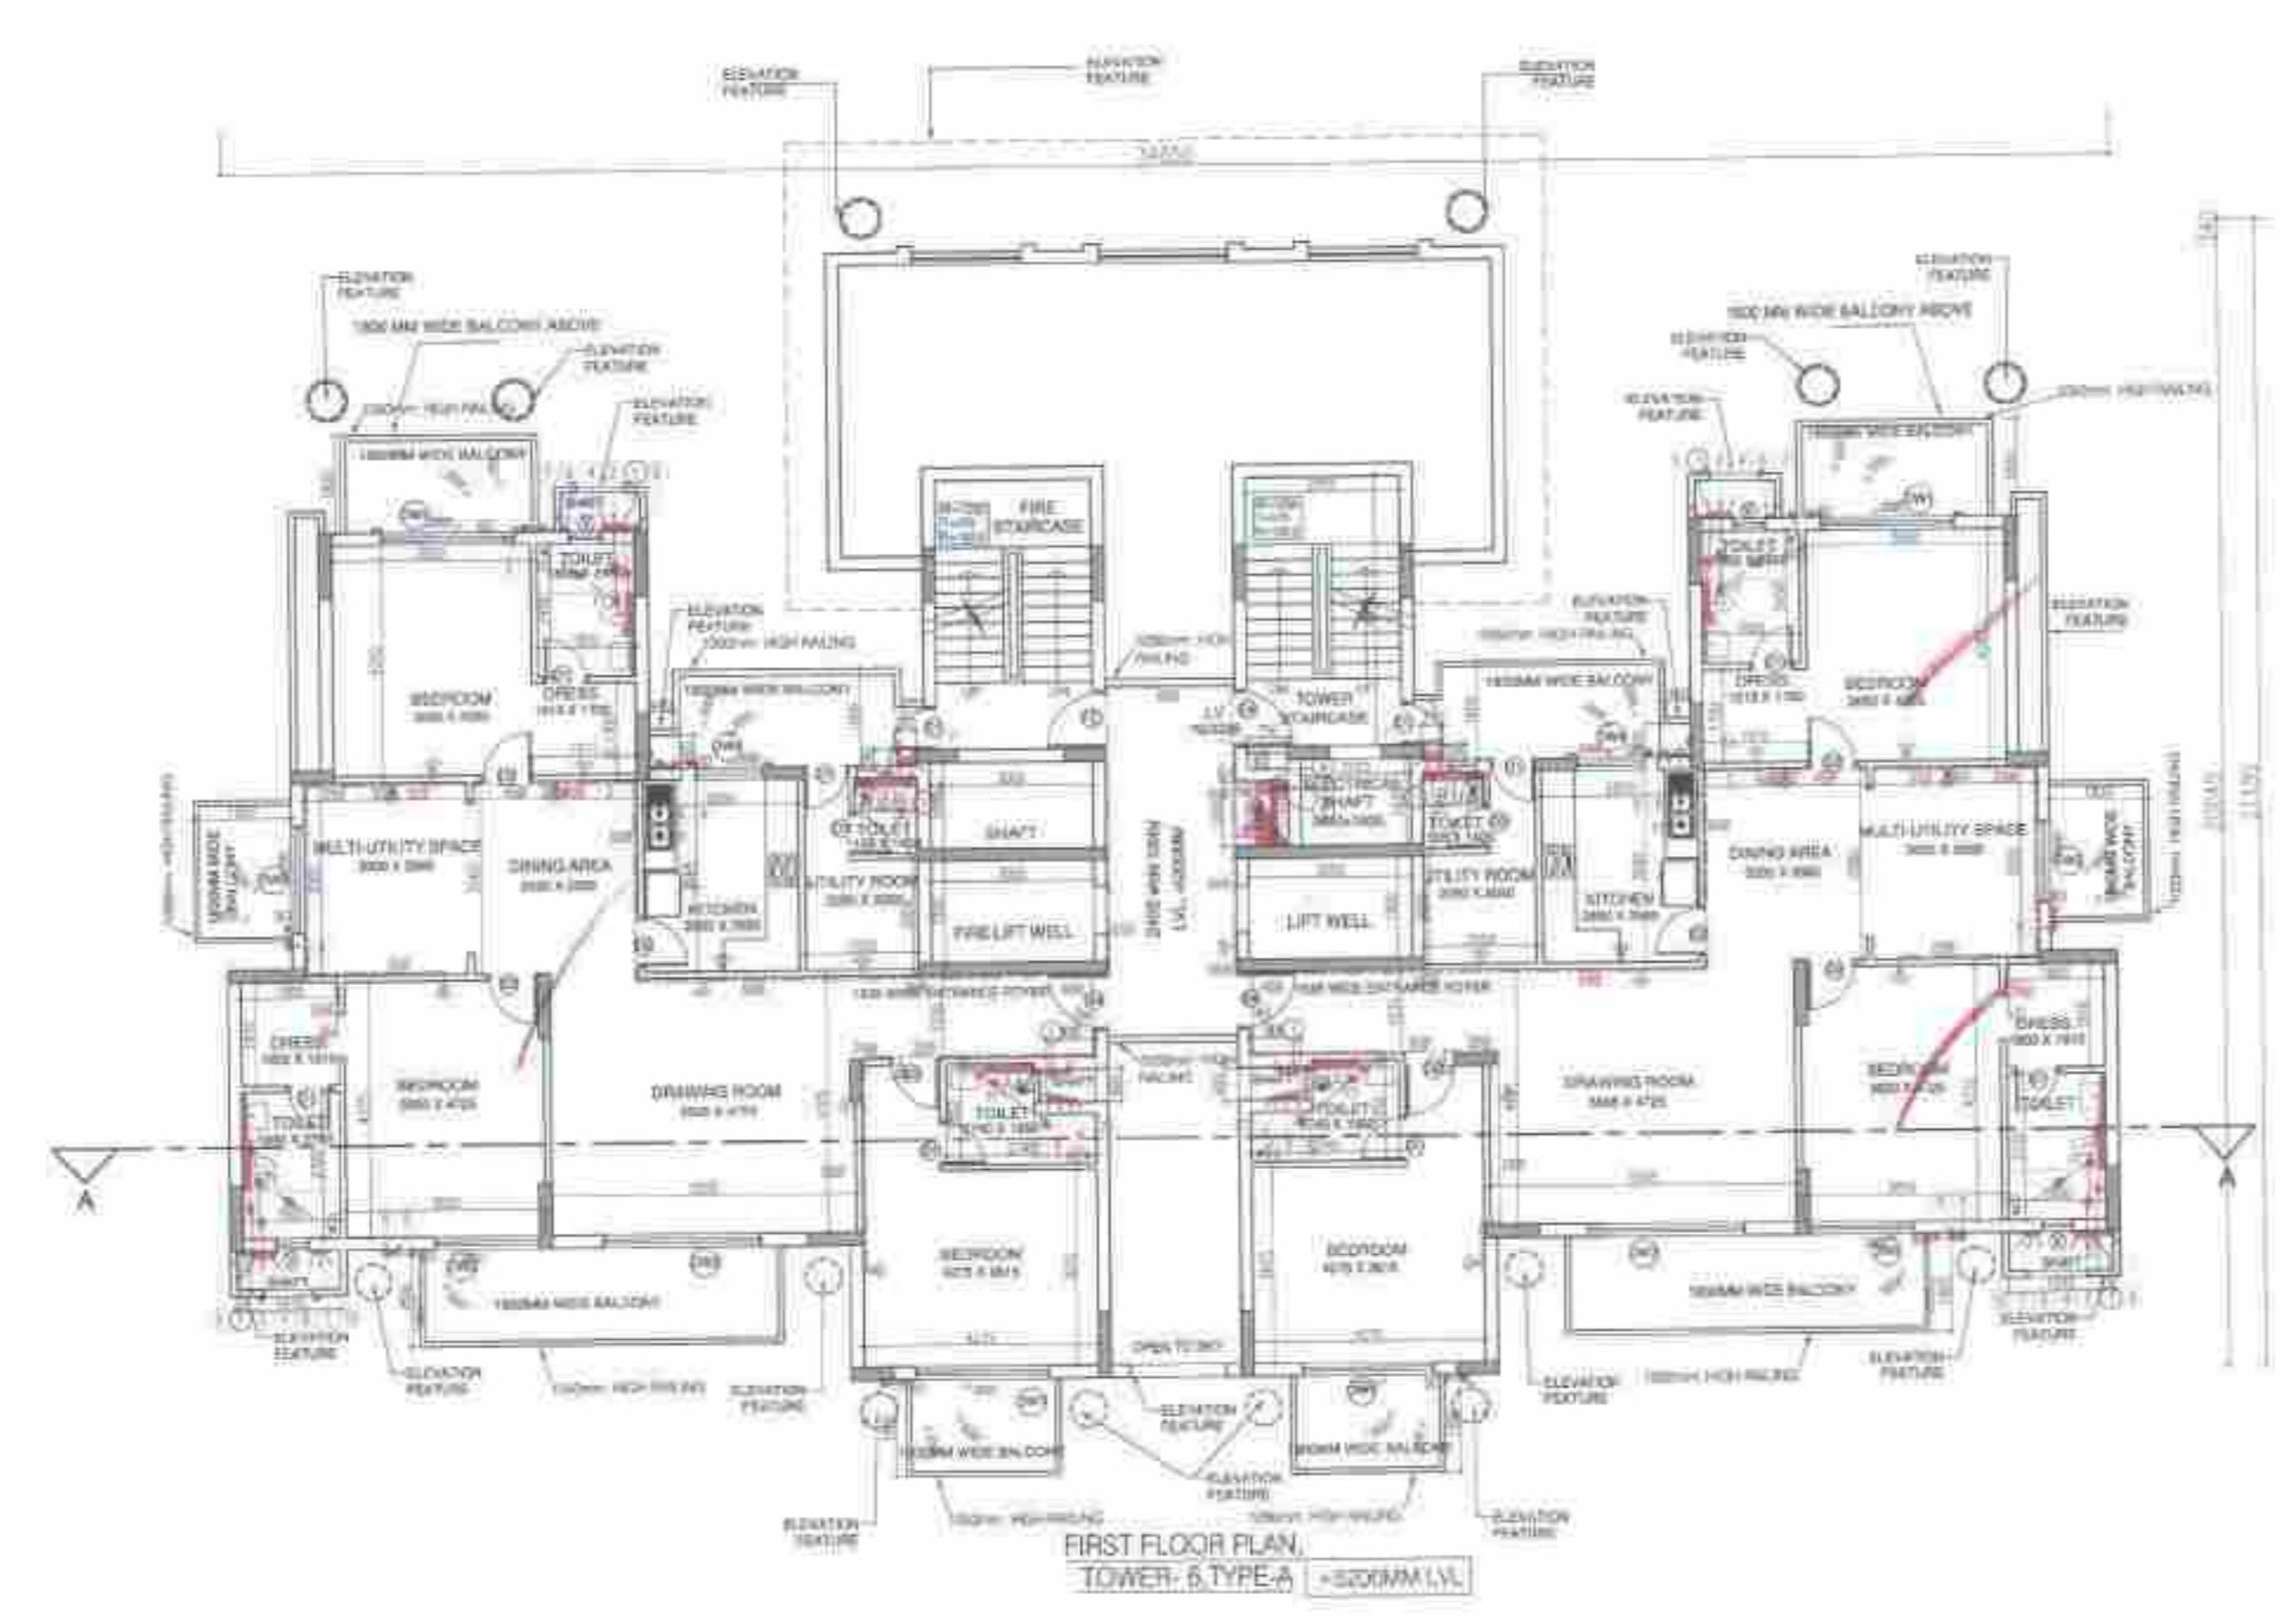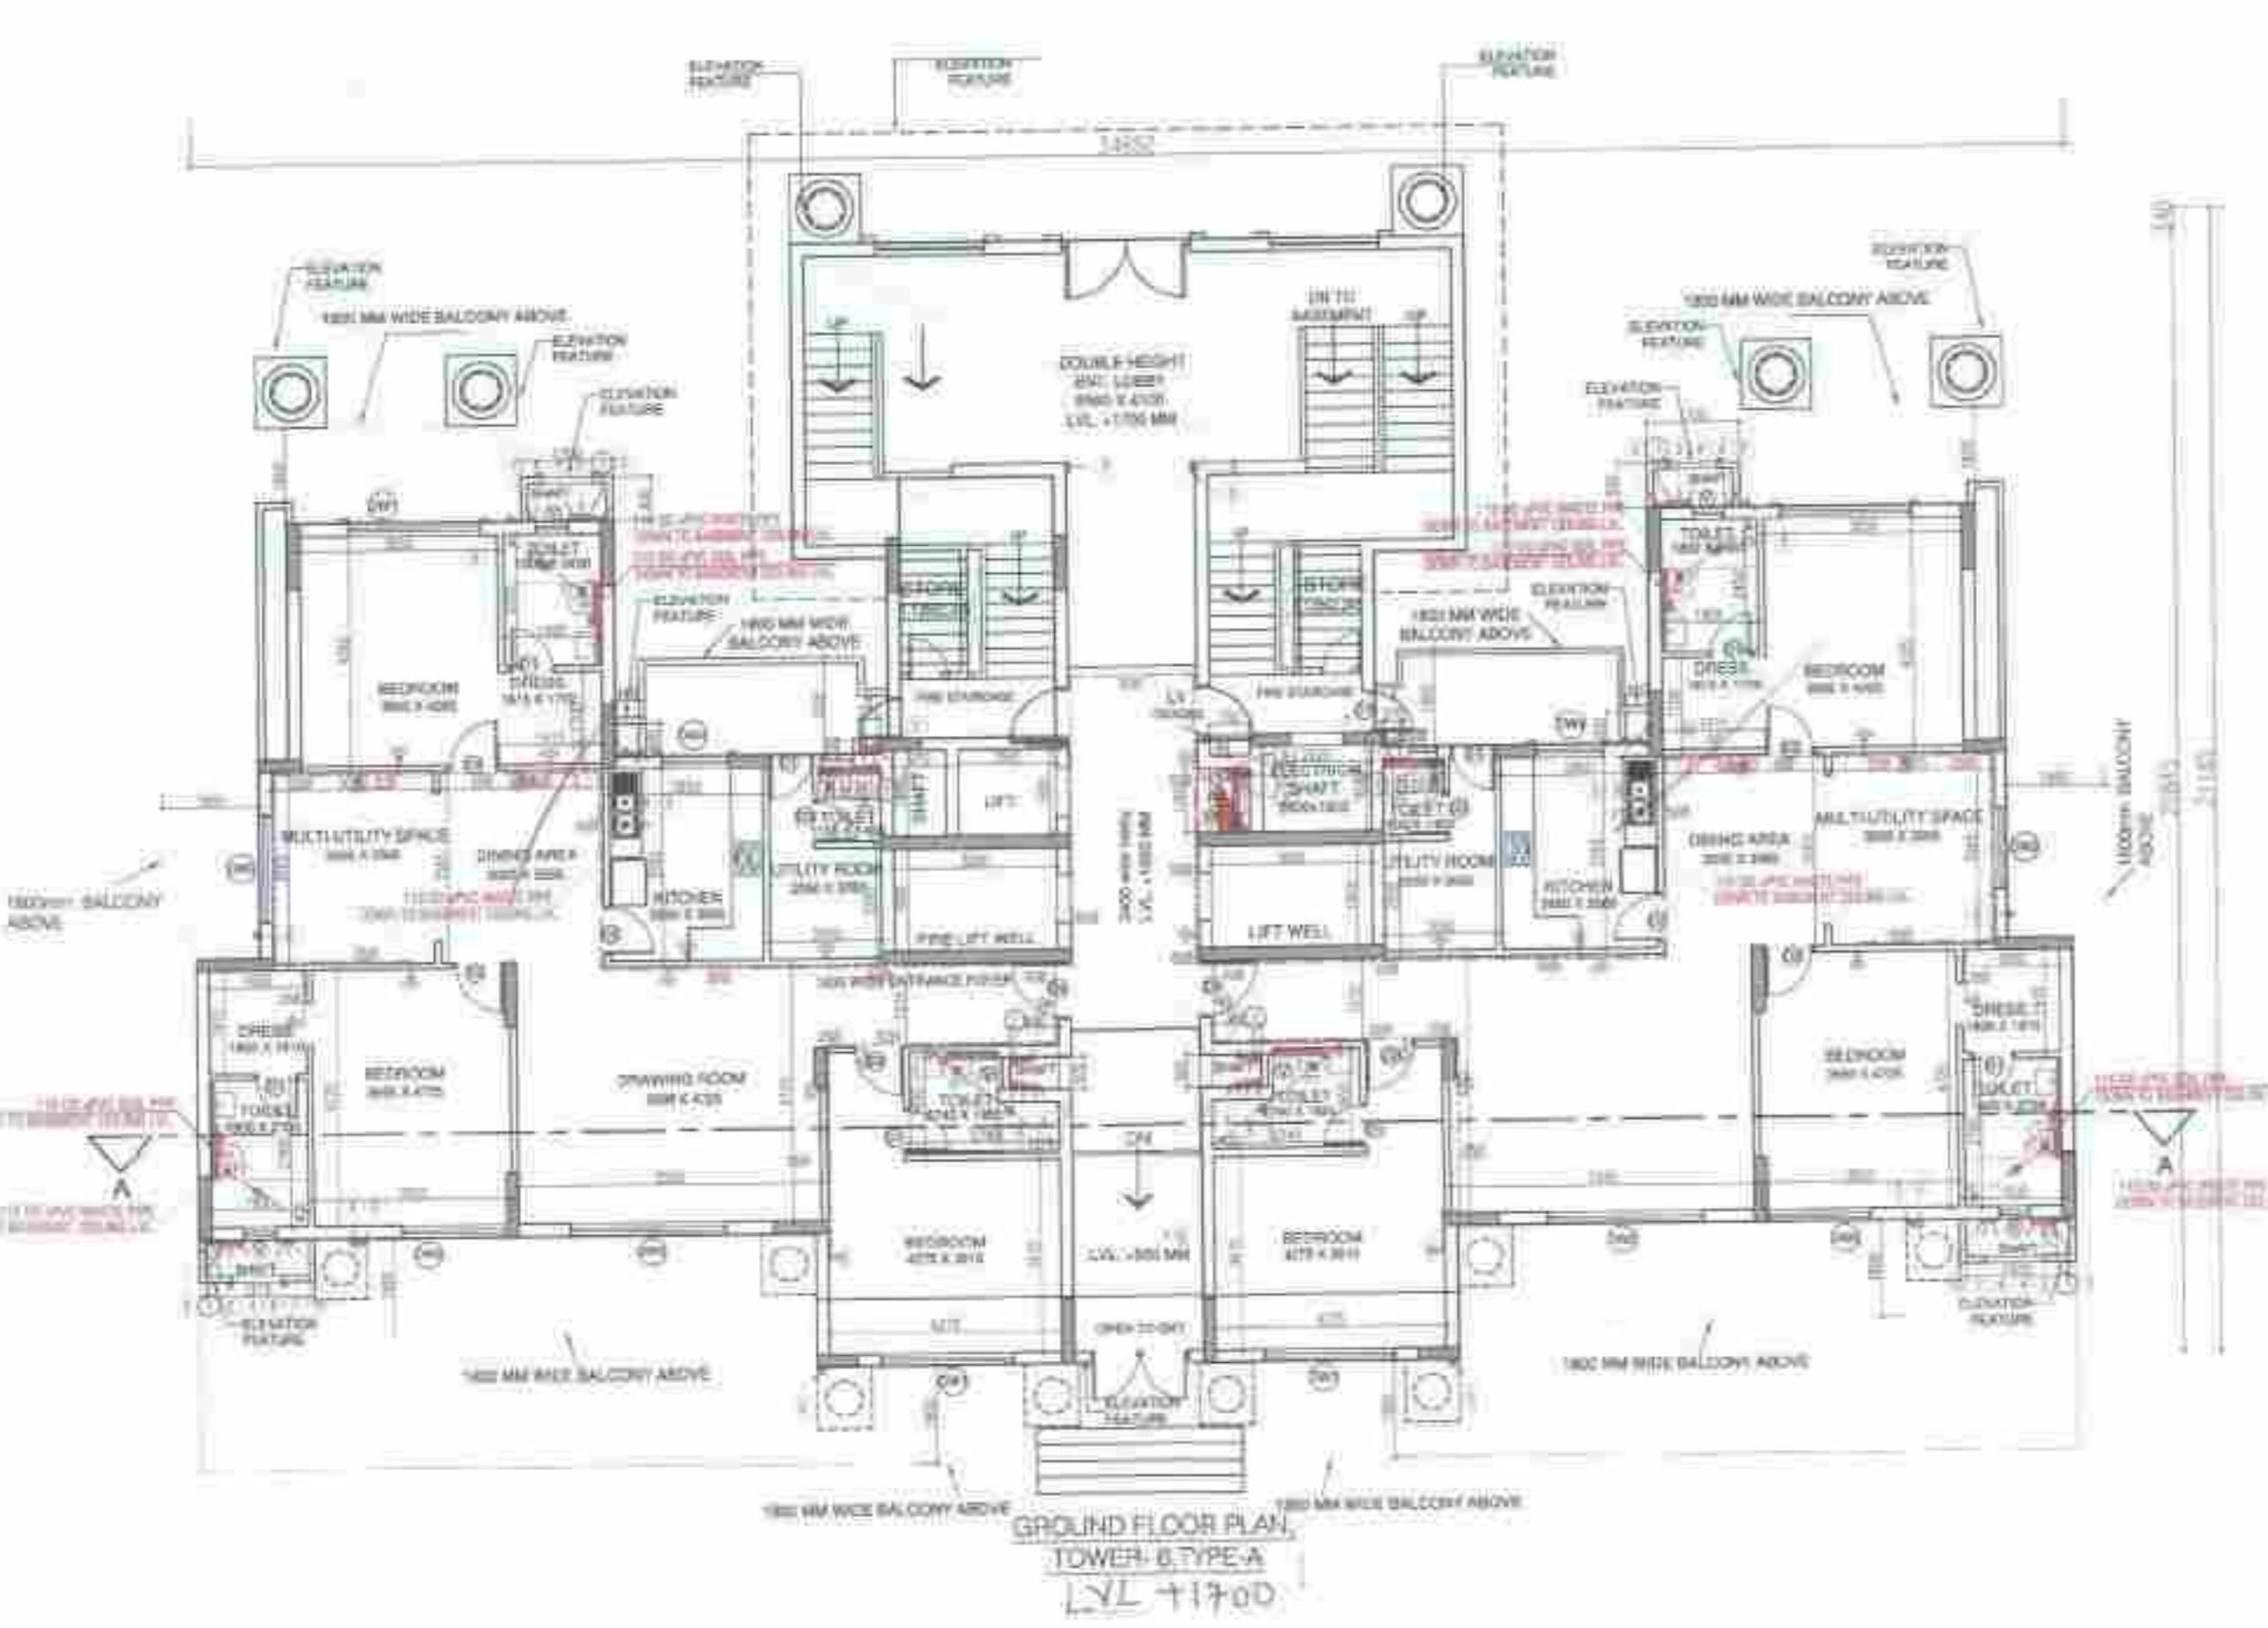

GROUND FLOOR AREA ADDITION		3RD TO 5TH FLOOR AREA ADDITION	
AREA CALCULATION AREA = (L x B) 34.650 x 21.185		AREA CALCULATION AREA = (L x B) 34.650 x 16.855	
<b>ADDITION AREA = 734.060 SQ.MT</b>		<b>ADDITION AREA = 584.026 SQ.MT</b>	
DEDUCTION DETAIL		DEDUCTION DETAIL	
A 1.130 X 0.600 X 2 1.356		A 1.130 X 0.600 X 2.000 1.356	
B 2.400 X 6.180 X 1 14.822		B 2.400 X 6.180 X 1.000 14.832	
C 11.390 X 2.505 X 2 57.064		C 11.390 X 2.505 X 2.000 57.064	
D 1.160 X 3.680 X 2 8.758		D 1.160 X 3.680 X 2.000 8.758	
E 1.740 X 4.380 X 2 15.242		E 1.740 X 4.380 X 2.000 15.242	
F 7.765 X 5.435 X 2 84.405		F 7.765 X 5.435 X 2.000 17.161	
G 3.333 X 9.535 X 1 31.780		G 8.130 X 5.205 X 1.000 42.317	
H 4.900 X 0.280 X 2 2.744		H 4.900 X 0.280 X 2.000 2.744	
I 1.250 X 3.345 X 2 11.487		J 2.630 X 3.925 X 1.000 10.523	
K 5.050 X 5.205 X 1.000 26.085		L 3.000 X 1.900 X 1.000 31.400	
M 3.000 X 1.600 X 1.000 4.800		N 0.750 X 1.200 X 1.000 0.900	
P 2.020 X 1.800 X 1.000 3.232		Q 0.750 X 0.285 X 1.000 0.214	
<b>TOTAL 279.027</b>		<b>TOTAL 216.628</b>	

GROUND FLOOR AREA = ADDITION AREA - DEDUCTION AREA  
734.060 - 279.027 = 455.033 SQ.MT

3RD TO 5TH FLOOR AREA = ADDITION AREA - DEDUCTION AREA  
584.026 - 216.628 = 367.40 SQ.MT

FIRST & SECOND FLOOR AREA ADDITION

AREA CALCULATION AREA = (L x B)  
34.650 x 21.185 734.060

ADDITION AREA = 584.026 SQ.MT

ADDITION AREA = 734.060 SQ.MT		ADDITION AREA = 584.026 SQ.MT	
DEDUCTION DETAIL		DEDUCTION DETAIL	
A 1.130 X 0.600 X 2 1.356		A 1.130 X 0.600 X 2.000 1.356	
B 2.400 X 6.180 X 1 14.822		B 2.400 X 6.180 X 1.000 14.832	
C 11.390 X 2.505 X 2 57.064		C 11.390 X 2.505 X 2.000 57.064	
D 1.160 X 3.680 X 2 8.758		D 1.160 X 3.680 X 2.000 8.758	
E 1.740 X 4.380 X 2 15.242		E 1.740 X 4.380 X 2.000 15.242	
F 7.765 X 5.435 X 2 84.405		F 7.765 X 5.435 X 2.000 17.161	
G 3.333 X 9.535 X 1 31.780		G 8.130 X 5.205 X 1.000 42.317	
H 4.900 X 0.280 X 2 2.744		H 4.900 X 0.280 X 2.000 2.744	
I 1.250 X 3.345 X 2 11.487		J 2.630 X 3.925 X 1.000 10.523	
K 5.050 X 5.205 X 1.000 26.085		L 3.000 X 1.900 X 1.000 31.400	
M 3.000 X 1.600 X 1.000 4.800		N 0.750 X 1.200 X 1.000 0.900	
P 2.020 X 1.800 X 1.000 3.232		Q 0.750 X 0.285 X 1.000 0.214	
<b>TOTAL 216.628</b>		<b>TOTAL 359.675</b>	

FIRST & SECOND FLOOR AREA = ADDITION AREA - DEDUCTION AREA  
734.060 - 359.675 = 374.385 SQ.MT

TYPICAL FLOOR AREA = ADDITION AREA - DEDUCTION AREA  
374.385 - 359.675 = 14.710 SQ.MT

NOTES:

- 1. DIMENSIONS ARE NOT TO BE SCALLED.
- 2. ALL DIMENSIONS ARE IN MM.
- 3. ALL ELECTRICAL INSTALLATIONS SHOULD BE AS PER PROVISIONS OF NBC.
- 4. FIRE FIGHTING SAFETY PROVISIONS WILL BE AS PER RELEVANT NBC PROVISIONS.
- 5. BOUNDARY WALL AND GATE AS PER STANDARDS.
- 6. ALL WALLS ARE 230/115 MM THK. BRICK WALL.
- 7. RAIN WATER HARVESTING SYSTEM SHALL BE PROVIDED AS PER CENTRAL GROUND WATER AUTHORITY NORMS/HARYANA GOVT.
- 8. ALL WINDOWS & VENTILATORS ARE OPENABLE.
- 9. ALL MECHANICALLY VENTILATED & ARTIFICIALLY LIT TOILET PROVIDED WITH 24hr POWER BACKUP.

#### OPENING SCHEDULE OF DOORS & WINDOWS

SR. NO.	SIZE	SILL	UNTEL	TYPE
1	800 X 2100	-	2100	D1
2	900 X 2100	-	2100	D2
3	750 X 2100	-	2100	D3
4	1050 X 2400	-	2400	D4
5	1050 X 2100	-	2100	FD
6	2430 X 2325	-	2325	DW1
7	2000 X 2325	-	2325	DW2
8	2880 X 2325	-	2325	DW3
9	1500 X 2325	-	2325	DW4
10	1800 X 1275	900	B.O.B.	W1
11	600 X 1275	1050	2325	V

#### PLUMBING NOTES:-

1. WASH BASIN TO FLOOR TRAP (FT) 40 OD UPVC PIPE
2. KITCHEN SINK TO FLOOR TRAP (FT) FLEXIBLE PIPE
3. 1500 M.S SPRINKLER RISER PIPE
4. 1500 M.S SPRINKLER DOWN PIPE
5. 110 OD UPVC PIPE USED FOR SOIL & WASTE
6. 110 OD UPVC PIPE USED FOR TERRACE RAIN WATER
7. 90 OD UPVC BALCONY RAIN WATER PIPE
8. DOMESTIC WATER SUPPLY DN TAKE PIPE \*
9. FLUSHING WATER SUPPLY DN TAKE PIPE \*
10. 500 DOMESTIC WATER SUPPLY RISER \*
11. 400 FLUSHING WATER SUPPLY RISER \*
12. HOT WATER SUPPLY DN TAKE PIPE FROM SOLAR PANEL \*
13. DOMESTIC WATER SUPPLY DN TAKE PIPE FOR TOP AM FLOOR

#### SCHEDULE OF PIPES :-

PIPE NO.	DESCRIPTION
1	110 OD UPVC SOIL & VENT PIPE
2	110 OD UPVC WASTE & VENT PIPE
3	75 OD UPVC ANTI-SIPHONAGE PIPE
4	110 OD UPVC TERRACE RAIN WATER PIPE
5	90 OD UPVC BALCONY RAIN WATER PIPE
6	DOMESTIC WATER SUPPLY DN TAKE PIPE *
7	FLUSHING WATER SUPPLY DN TAKE PIPE *
8	500 DOMESTIC WATER SUPPLY RISER *
9	400 FLUSHING WATER SUPPLY RISER *
10	HOT WATER SUPPLY DN TAKE PIPE FROM SOLAR PANEL *
11	DOMESTIC WATER SUPPLY DN TAKE PIPE FOR TOP AM FLOOR

#### NOTES

1. DIMENSIONS ARE NOT TO BE SCALLED.  
 2. ALL DIMENSIONS ARE IN MM.  
 3. ALL ELECTRICAL INSTALLATIONS SHOULD BE AS PER PROVISIONS OF NBC.  
 4. FIRE FIGHTING SAFETY PROVISIONS WILL BE AS PER RELEVANT NBC PROVISIONS.  
 5. BOUNDARY WALL AND GATE AS PER STANDARDS.  
 6. ALL WALLS ARE 230/115 MM THK. BRICK WALL.  
 7. RAIN WATER HARVESTING SYSTEM SHALL BE PROVIDED AS PER CENTRAL GROUND WATER AUTHORITY NORMS/HARYANA GOVT.  
 8. ALL WINDOWS & VENTILATORS ARE OPENABLE.  
 9. ALL MECHANICALLY VENTILATED & ARTIFICIALLY LIT TOILET PROVIDED WITH 24hr POWER BACKUP.

#### DEVELOPED BY:

#### PROJECT:









PROPOSED BUILDING PLAN OF GROUP HOUSING COLONY AREA MEASURING 11.125 ACRES (LICENSE NO. 87 OF 2013 DATED 11-10-2013 IN SECTOR-89-A, GURGAON MANESAR URBAN COMPLEX BEING DEVELOPED BY DALE DEVELOPERS PVT. LTD. AND OTHERS IN COLLABORATION WITH VATIKA LTD.)

#### DRAWING TITLE :

TOWER-6, TYPE-A, FLOOR PLAN & AREA DIAGRAM

+1700 TO 17400 MM LVL

DEALT BY : DATE : DRG. NO. : A-2.1

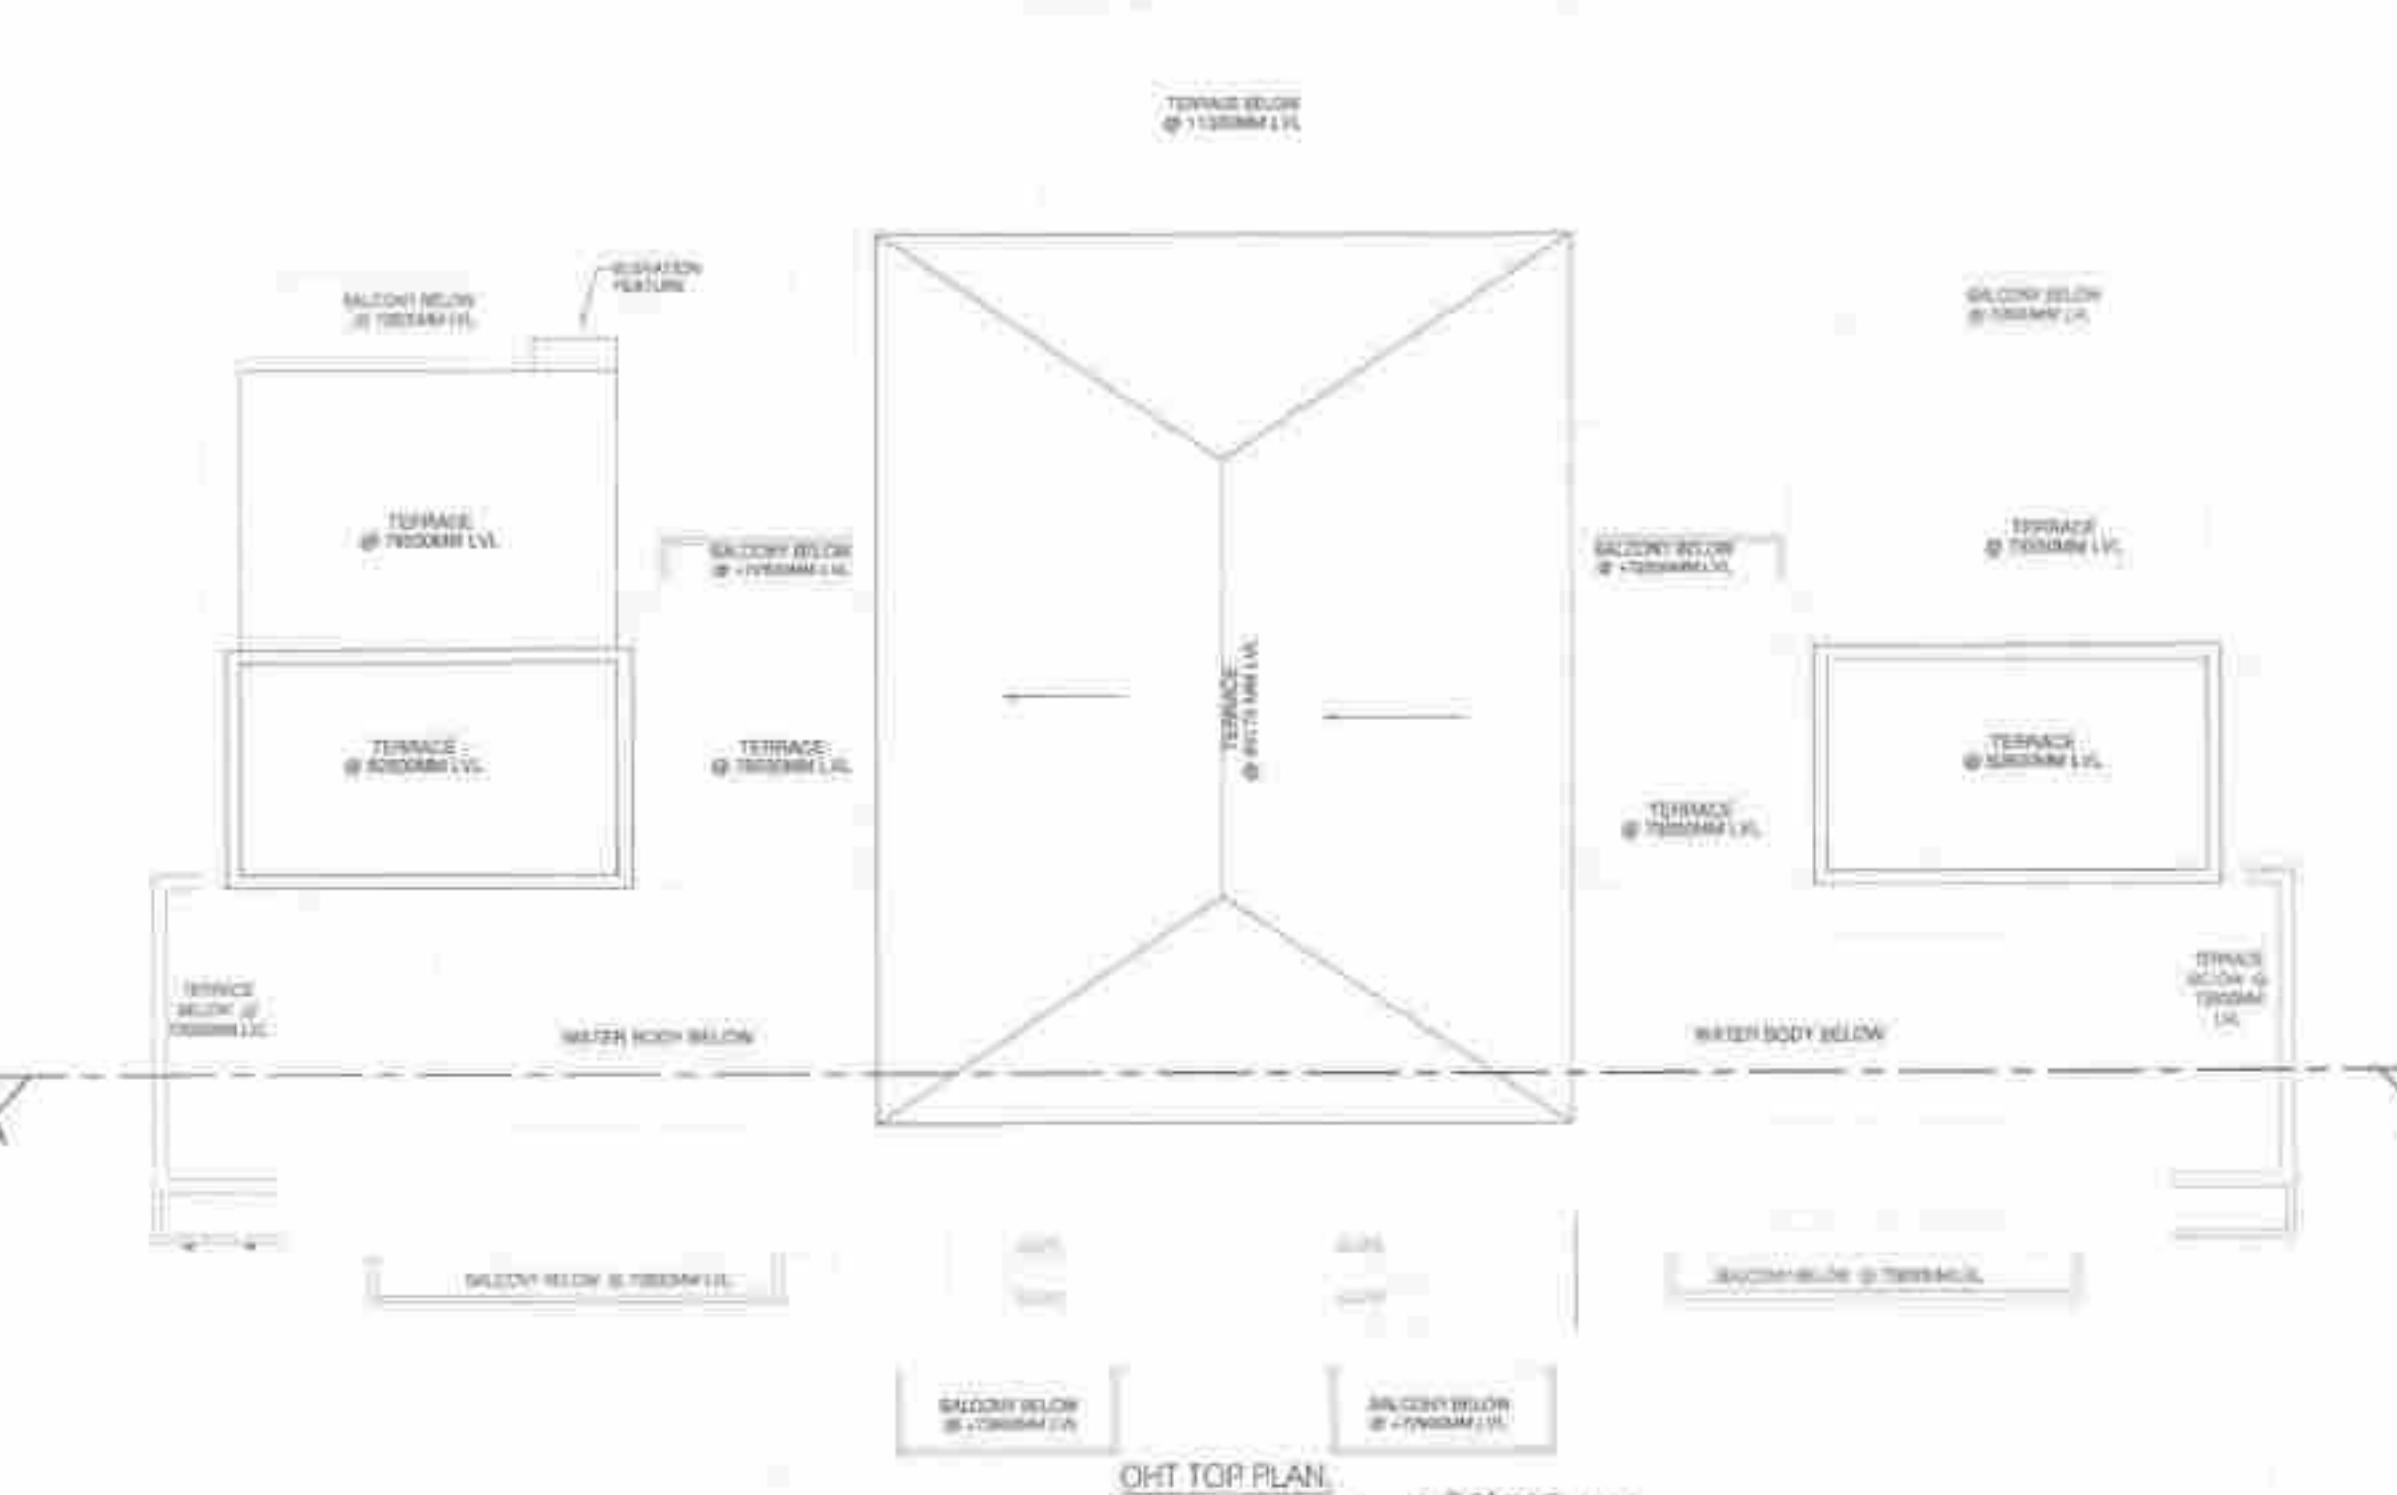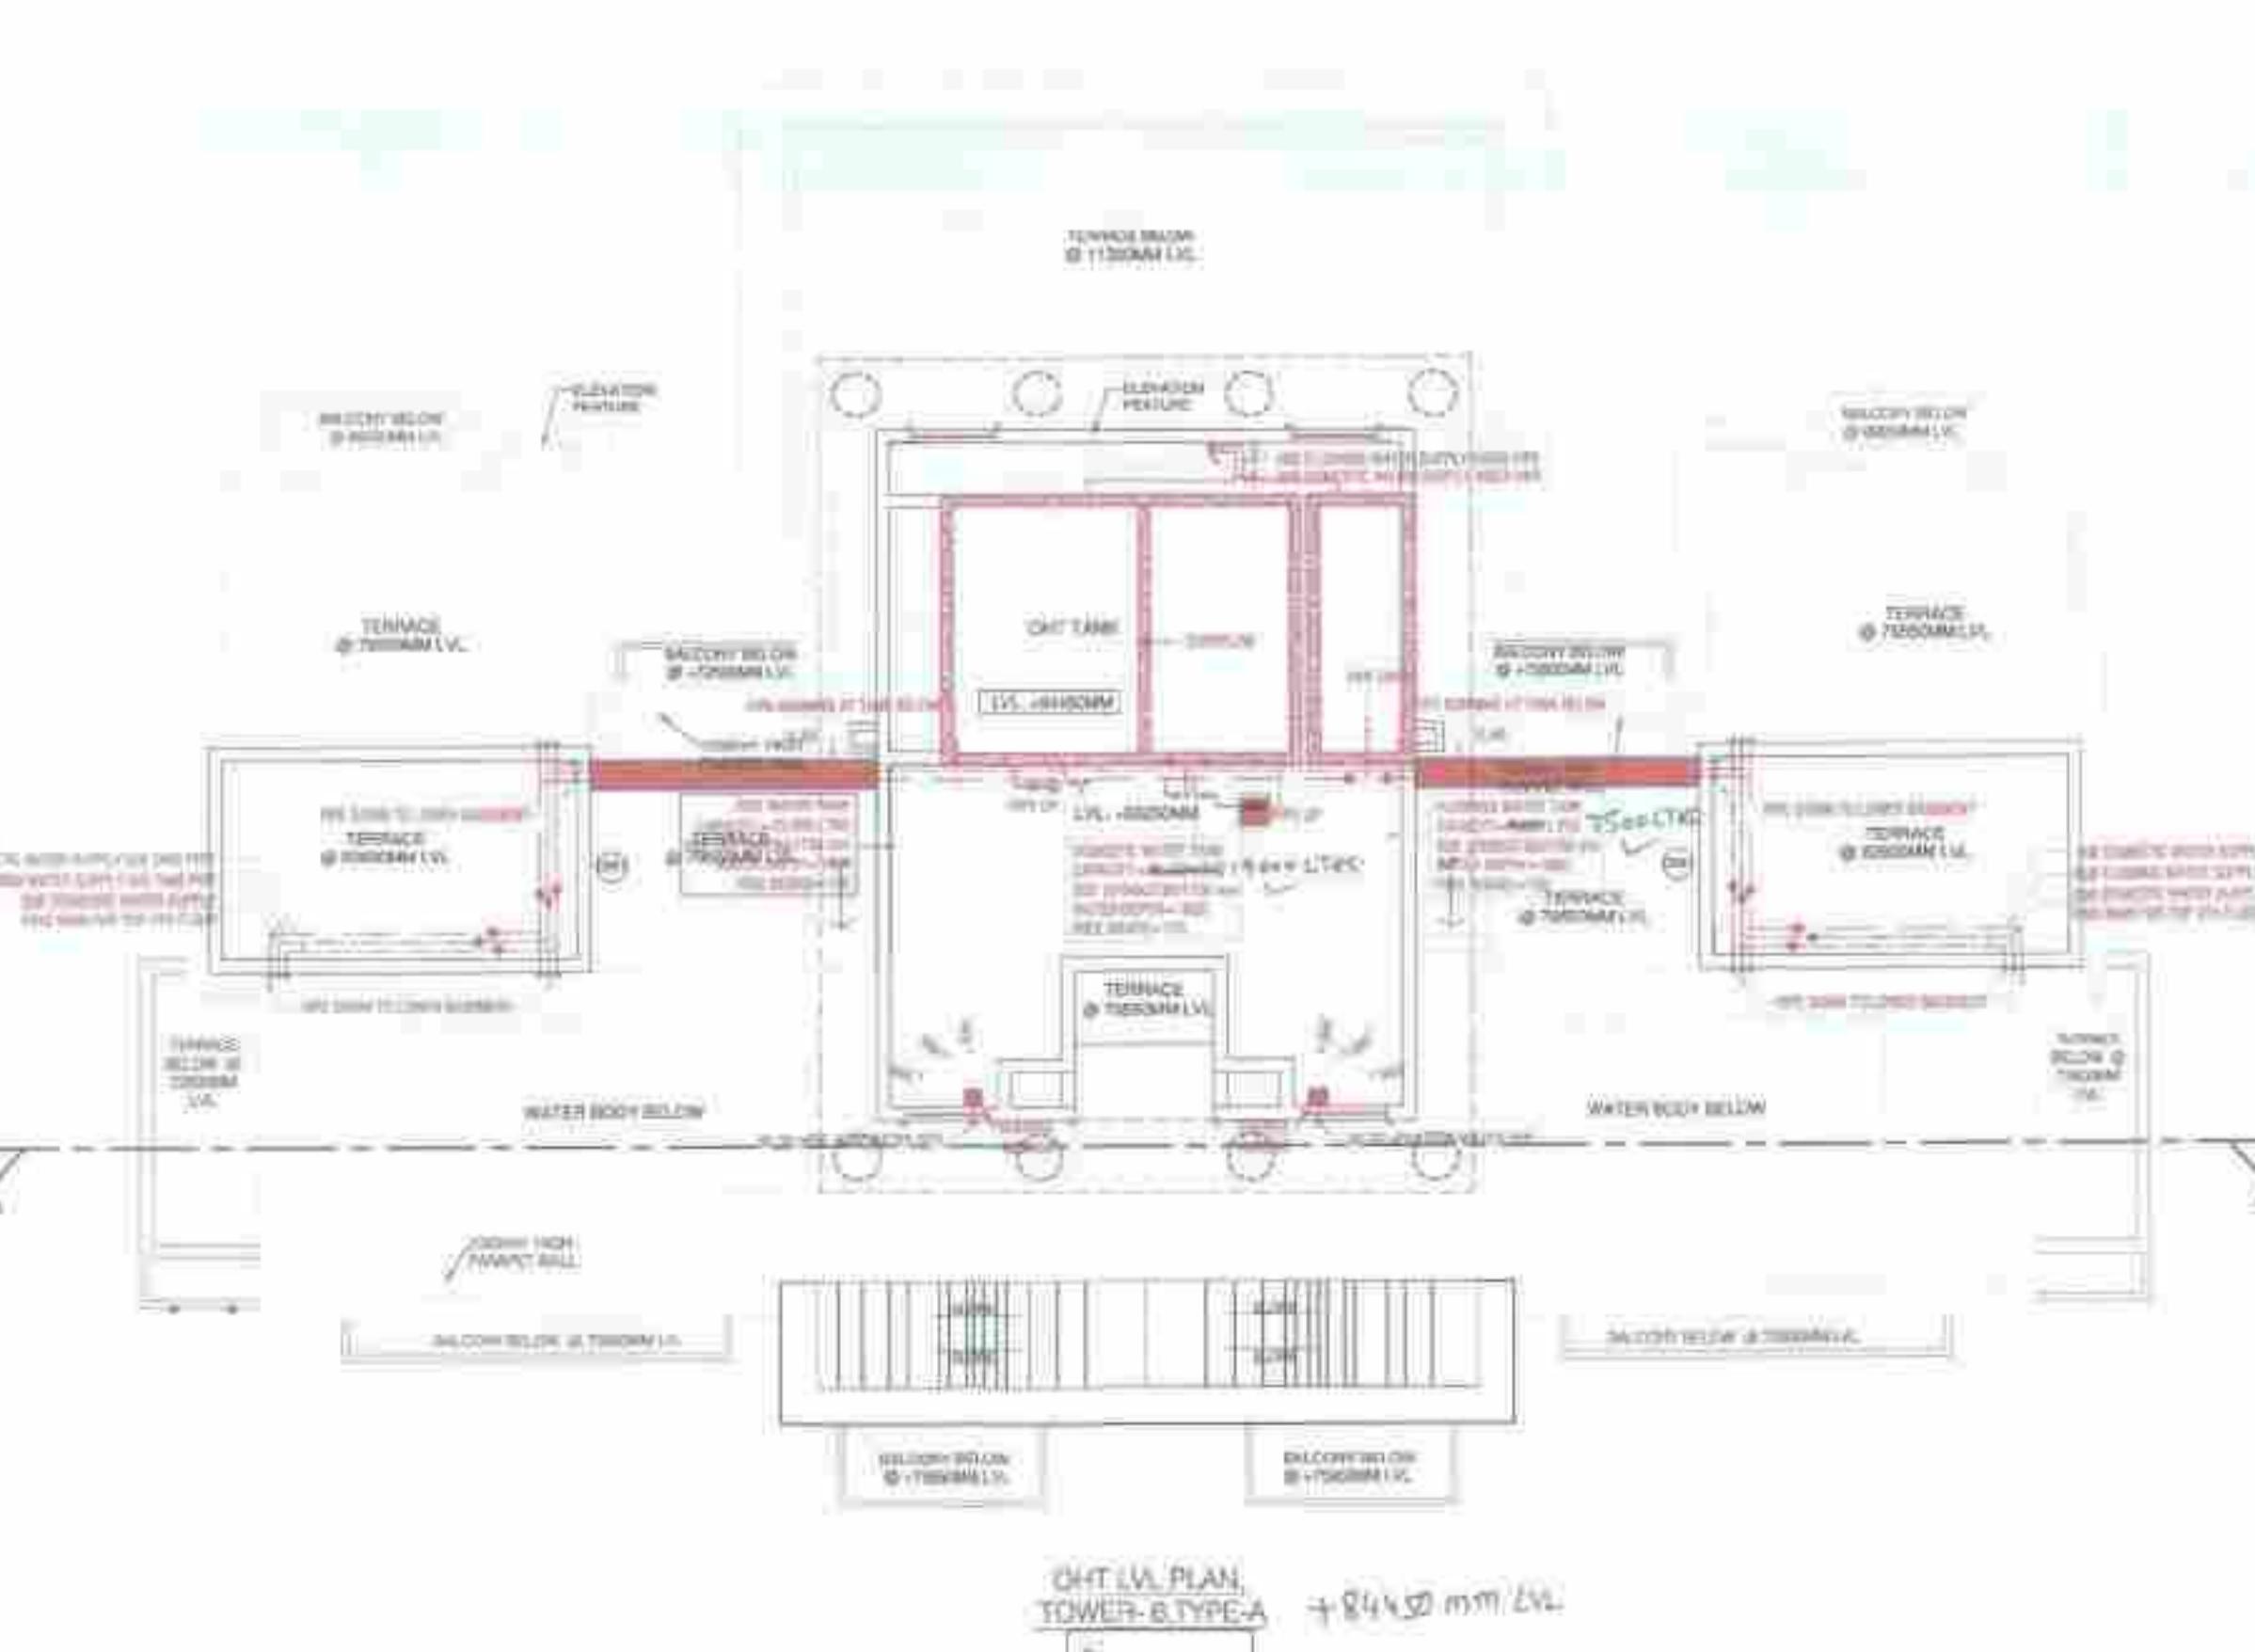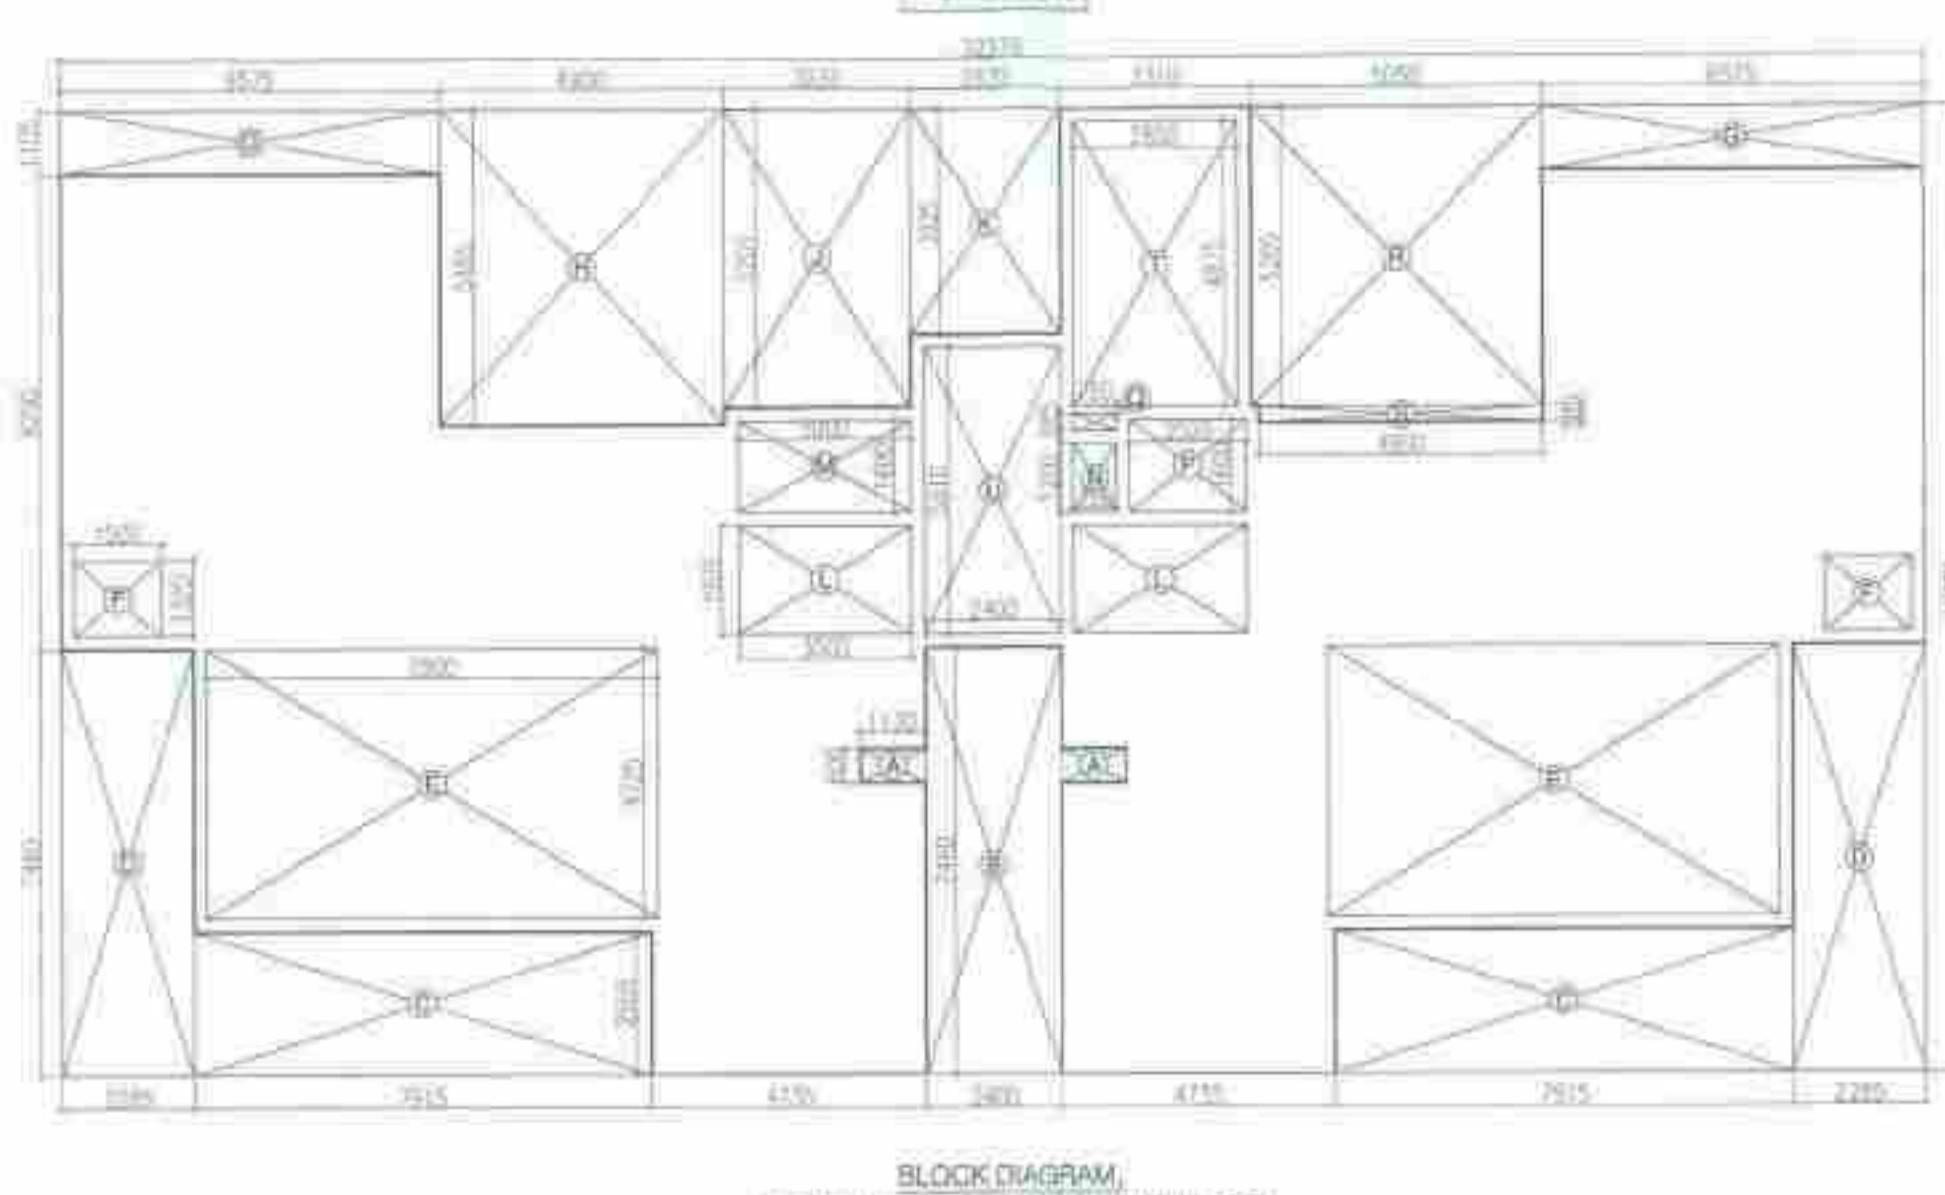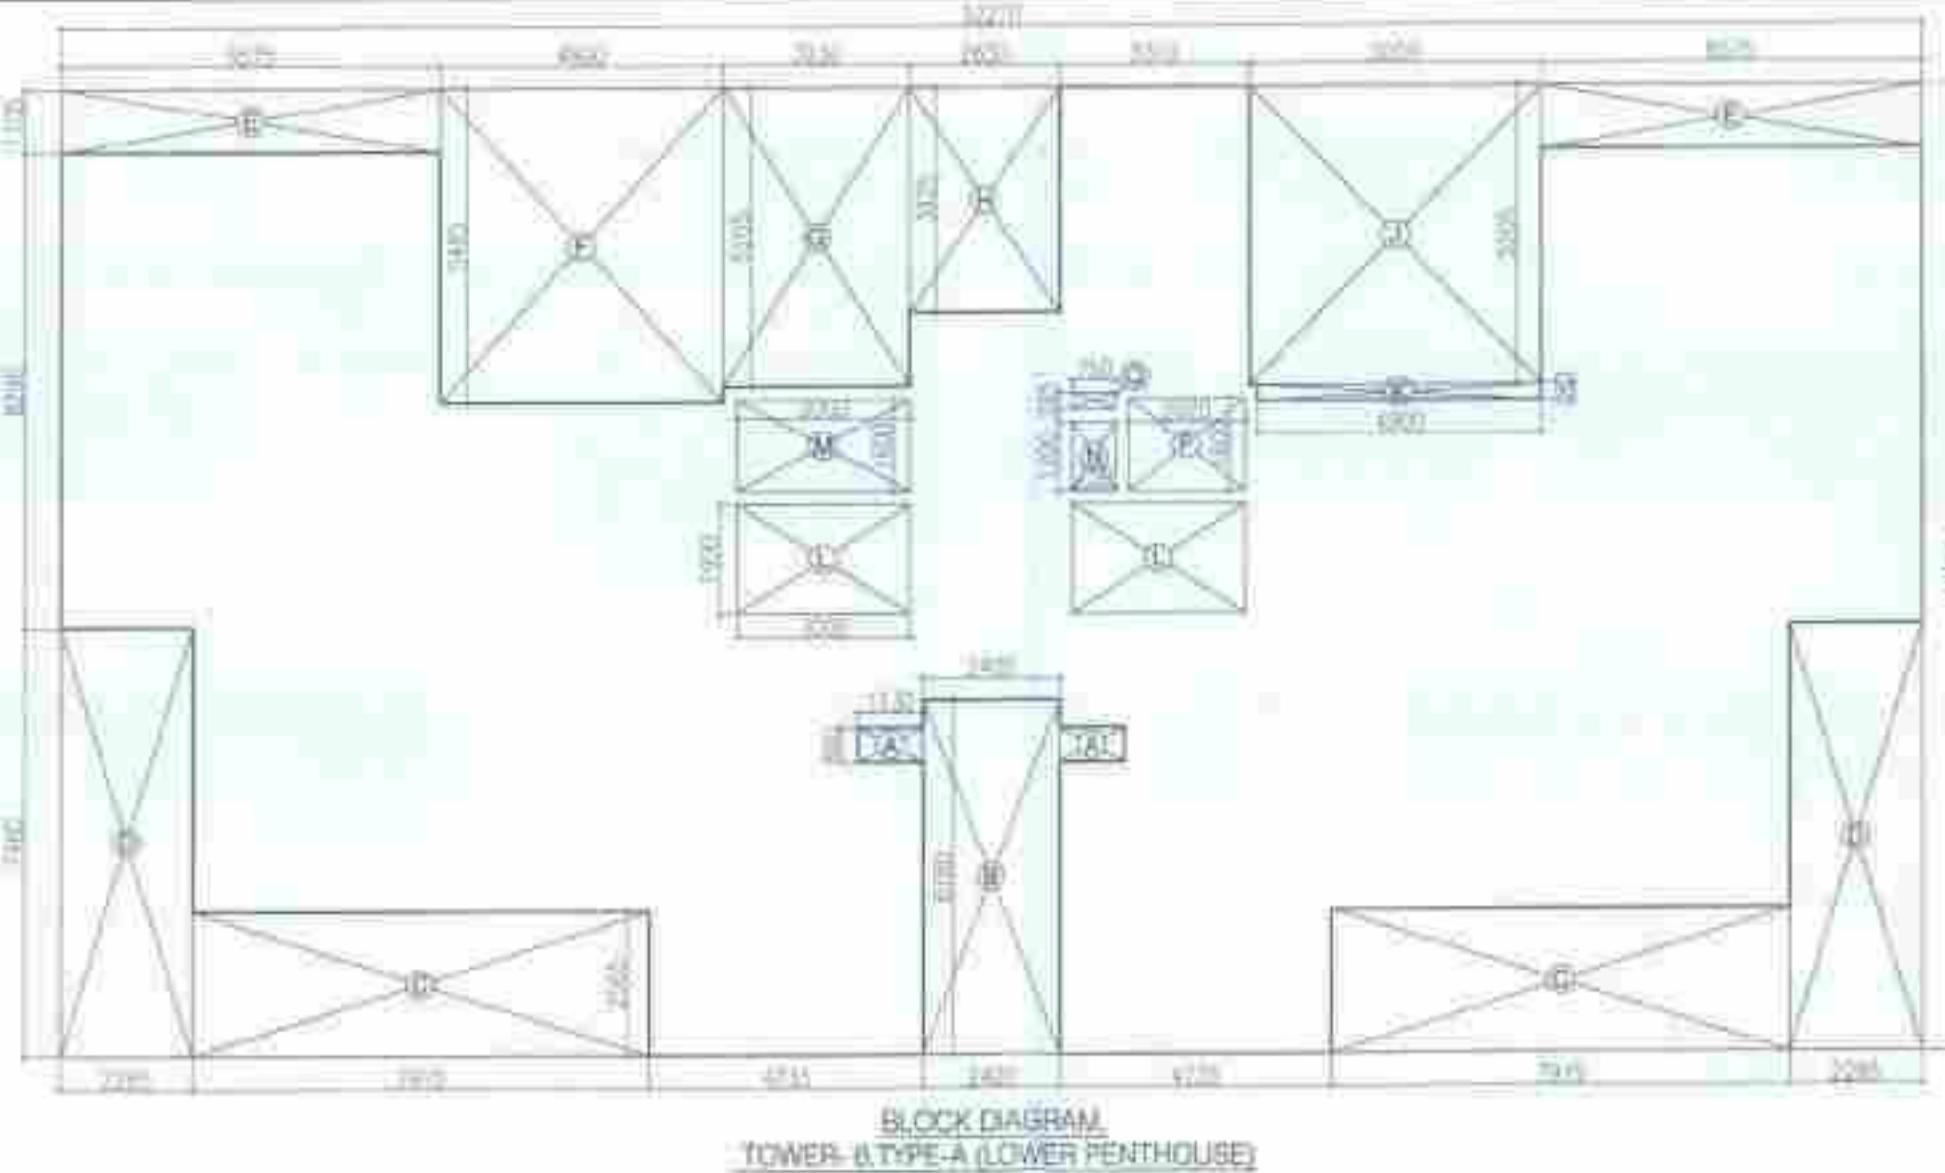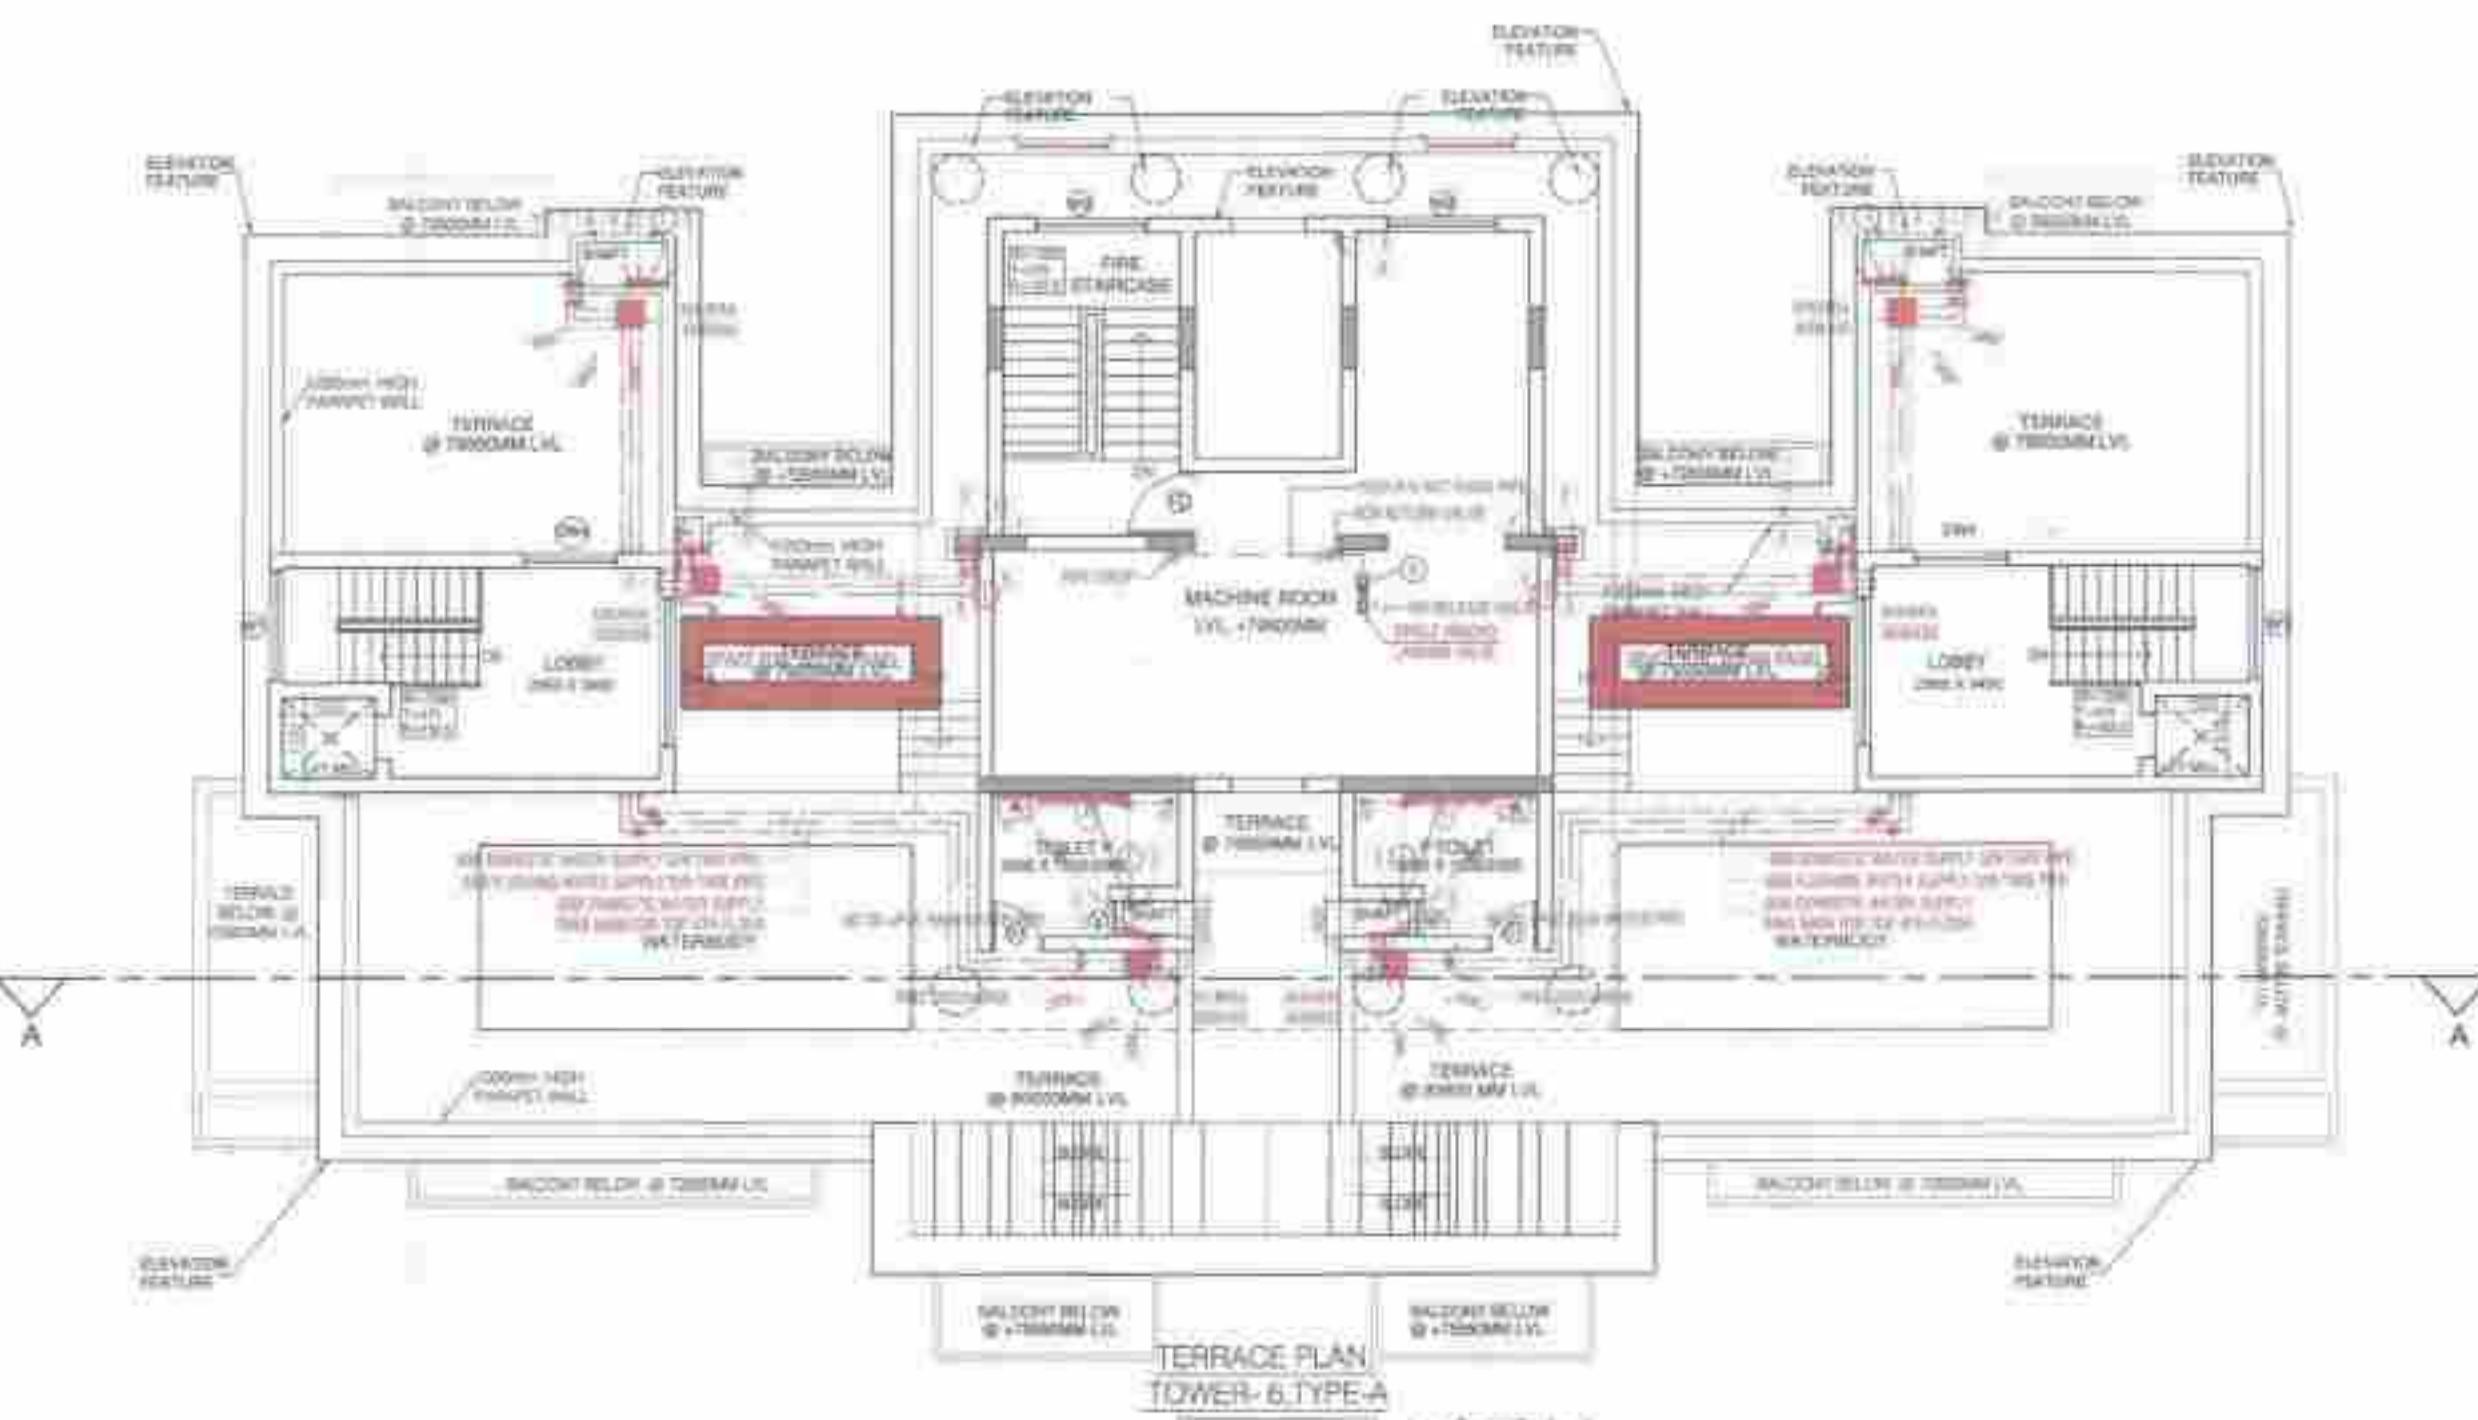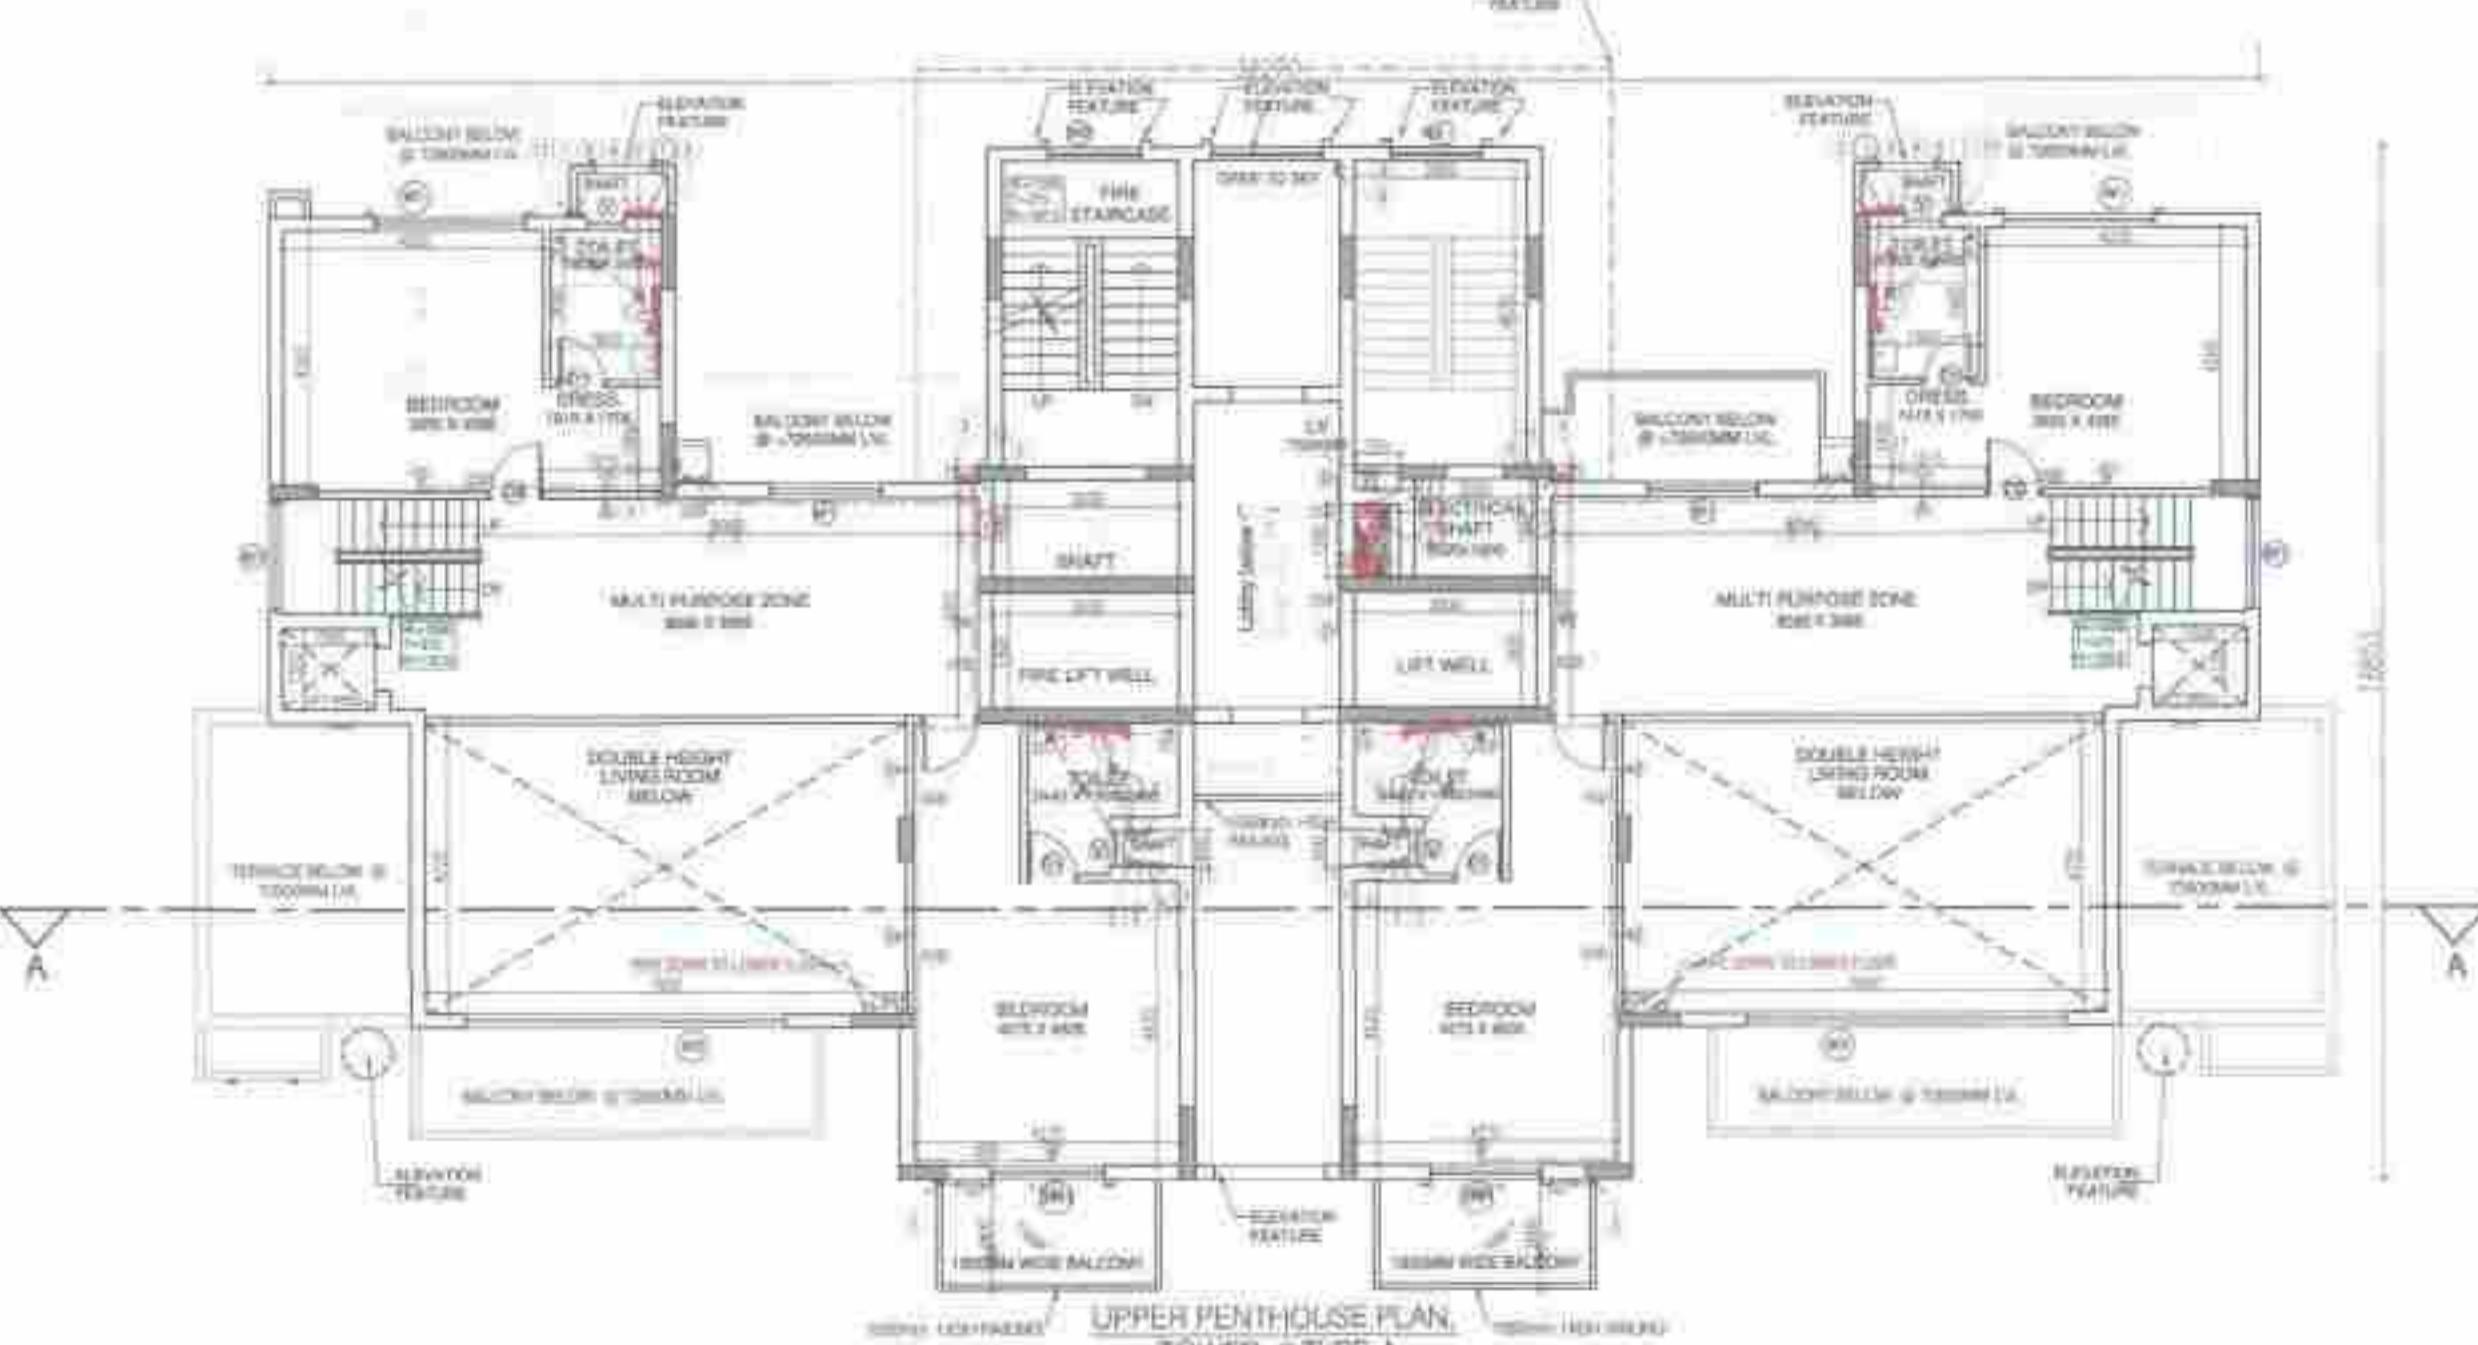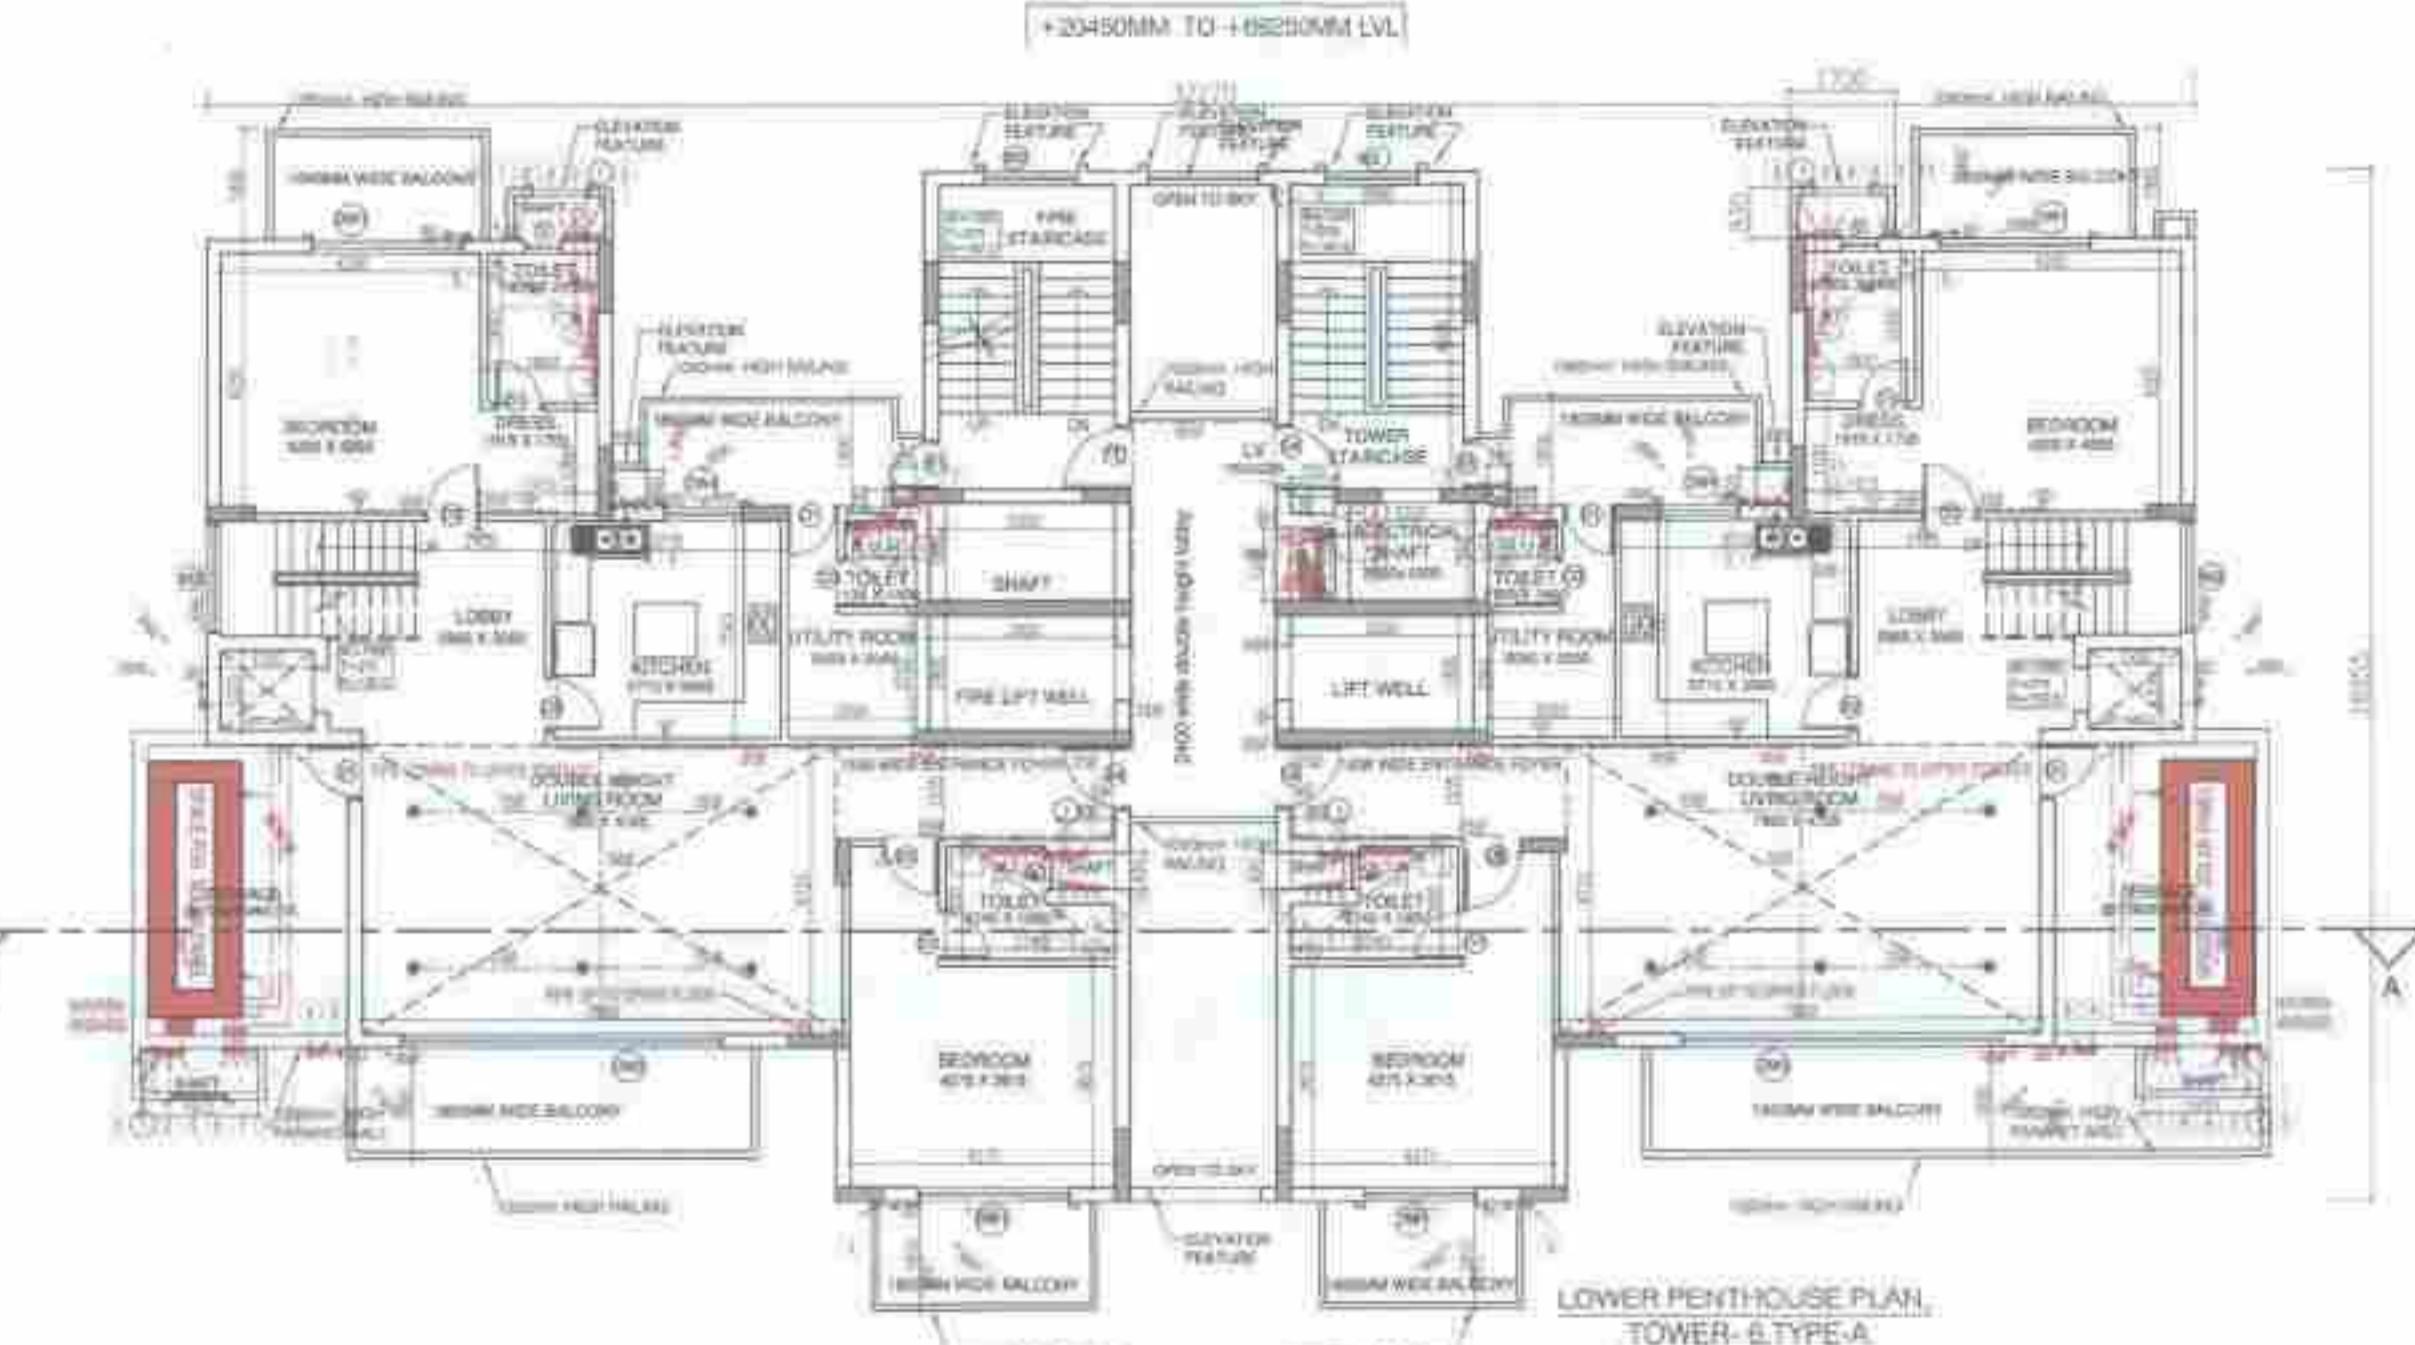
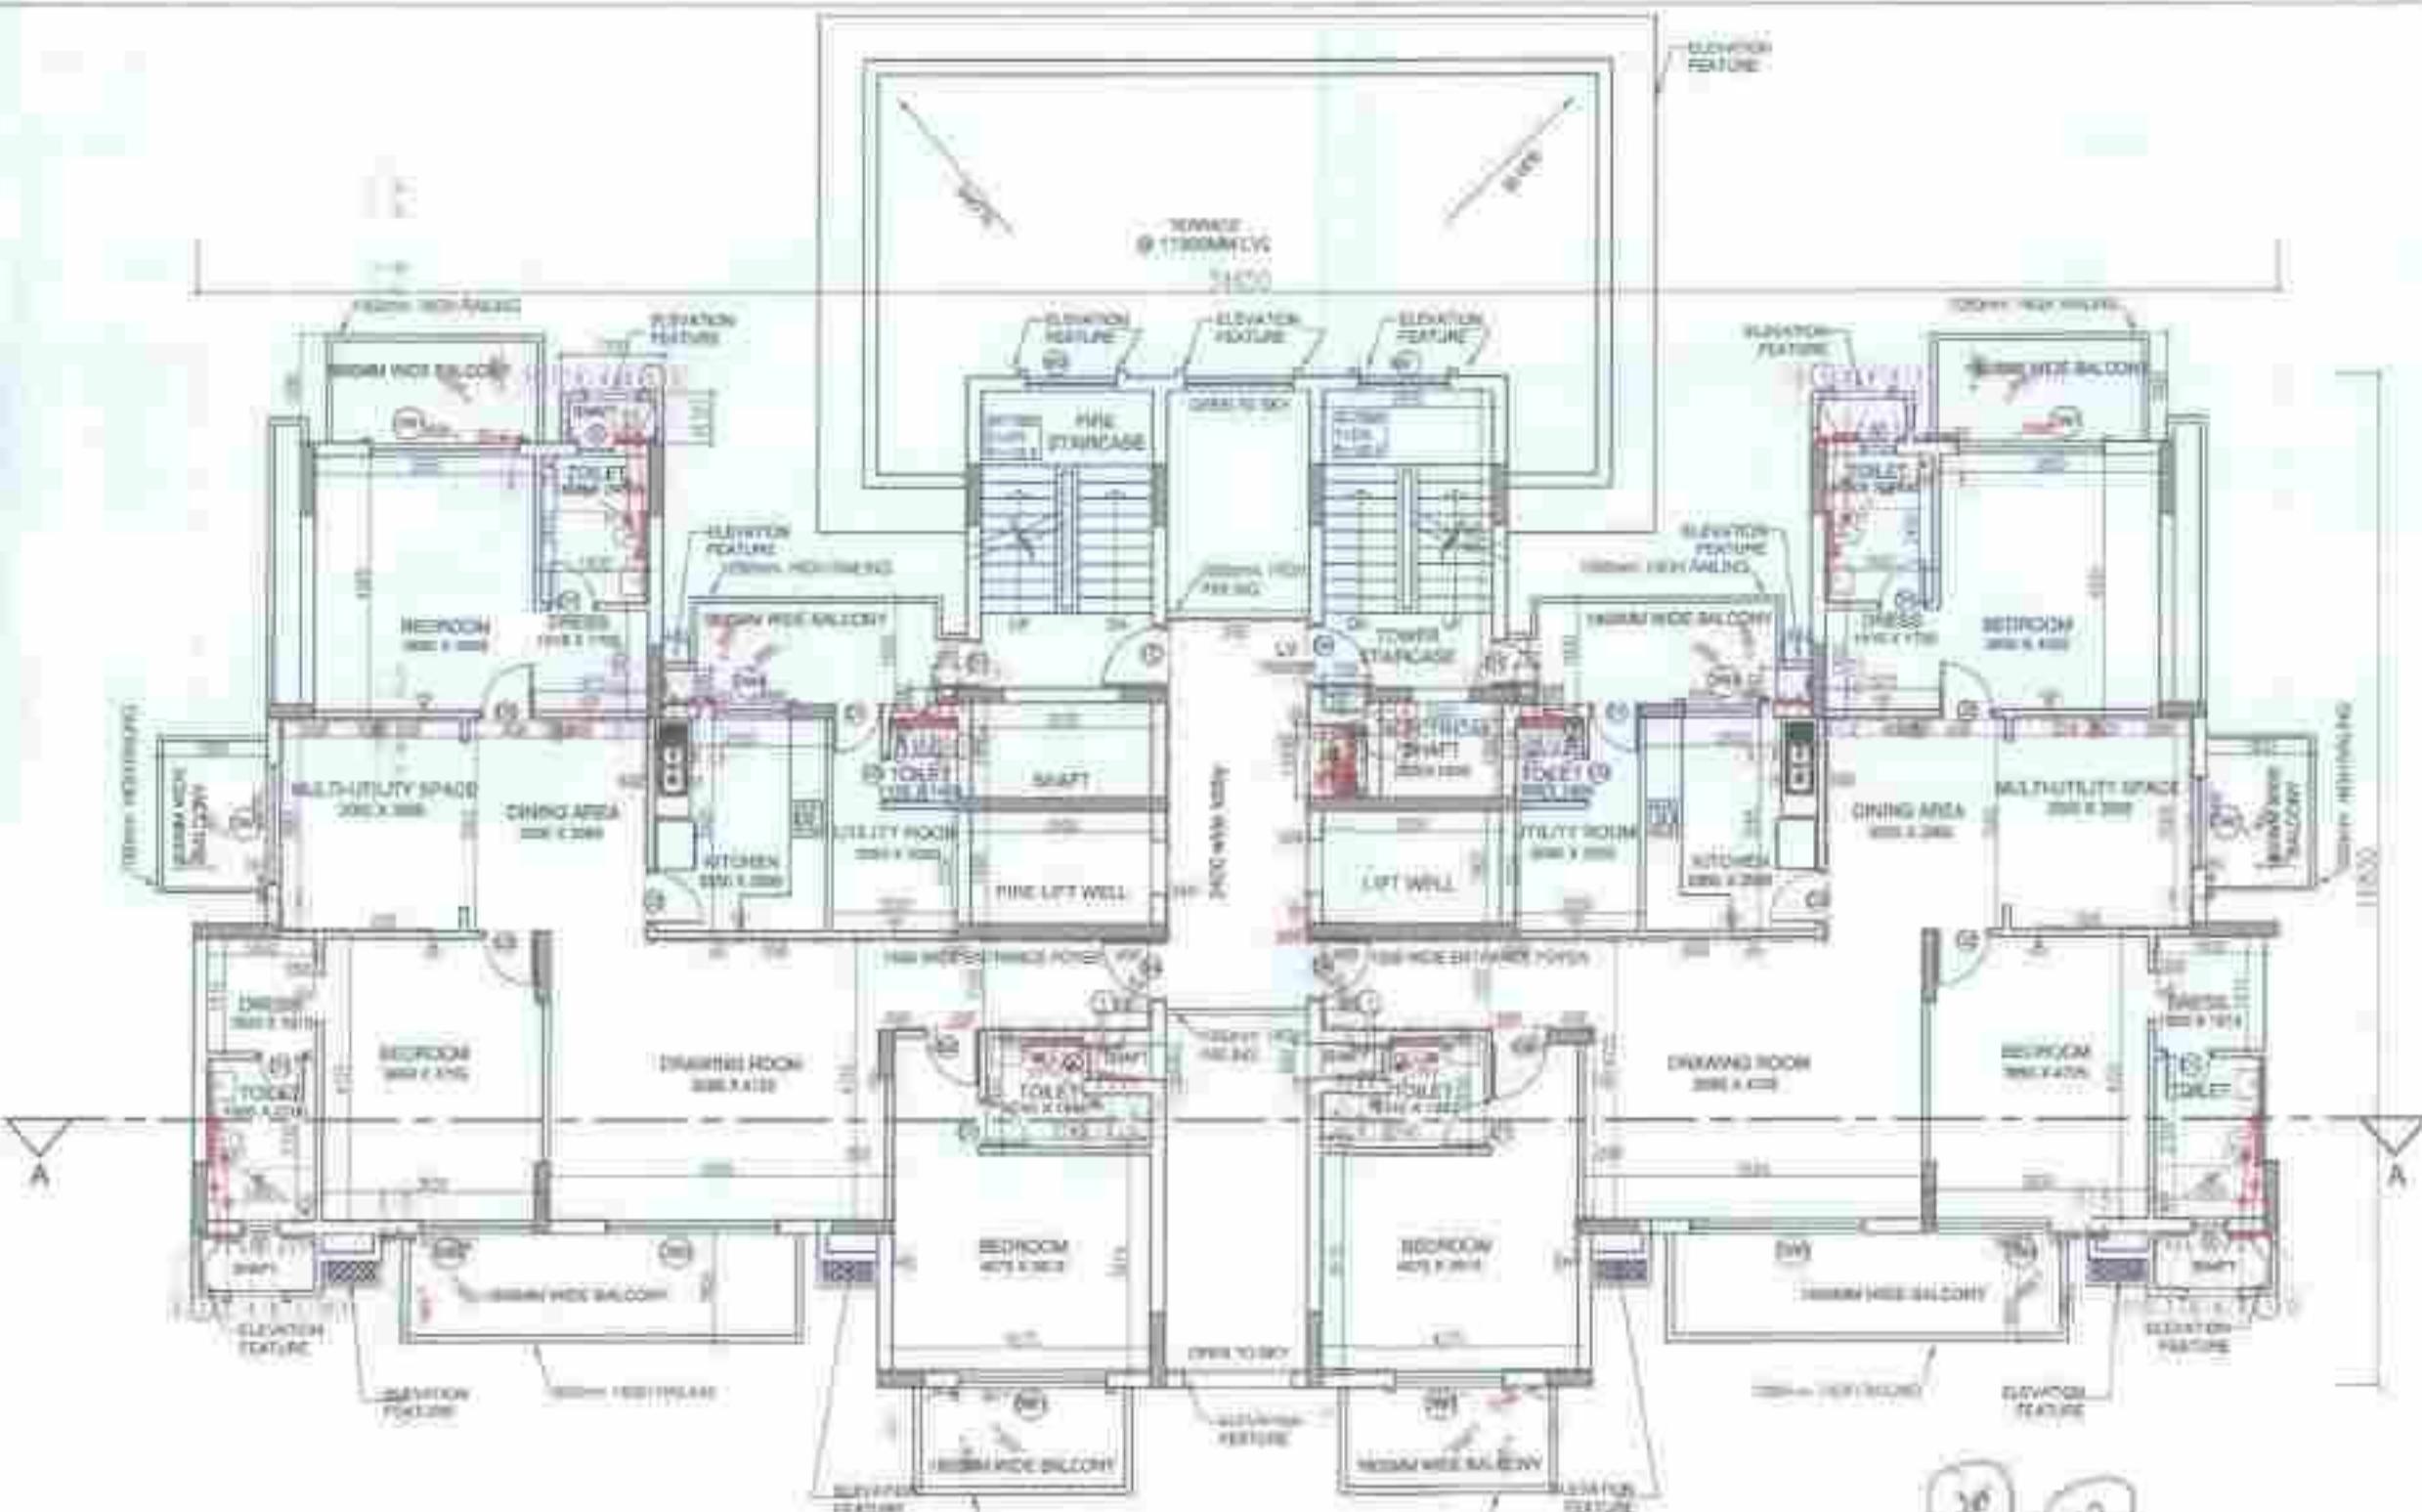


LOWER PENTHOUSE AREA ADDITION		
AREA CALCULATION AREA = (L x B)		
32.70 x 16.855		
<b>\$43.911</b>		
ADDITION AREA = 543.91 SQ.MT		
DEDUCTION DETAIL		
A	1.130 X 0.600 X 2	1.356
B	2.400 X 6.180 X 1	14.832
C	7.915 X 2.505 X 2	39.654
D	2.285 X 7.460 X 2	34.092
E	6.575 X 1.105 X 2	14.531
F	4.900 X 5.485 X 1	26.877
G	3.230 X 5.205 X 1	16.812
H	2.630 X 3.925 X 1	10.323
J	5.050 X 5.205 X 1	26.285
K	4.900 X 0.280 X 1	1.372
L	3.000 X 1.900 X 2	11.400
M	3.000 X 1.600 X 1	4.800
N	0.750 X 1.200 X 1	0.900
P	2.020 X 1.600 X 1	3.232
Q	0.750 X 0.285 X 1	0.214
<b>TOTAL</b>		
206.680		

LOWER PENTHOUSE AREA = ADDITION AREA - DEDUCTION AREA		
543.911-206.680 = 337.231 SQ.MT		

UPPER PENTHOUSE AREA ADDITION		
AREA CALCULATION AREA = (L x B)		
32.70 x 16.855		
<b>\$43.911</b>		
ADDITION AREA = 543.911 SQ.MT		
DEDUCTION DETAIL		
A	1.130 X 0.600 X 2	1.356
B	2.400 X 7.460 X 1	17.904
C	7.915 X 2.505 X 2	39.654
D	2.285 X 7.460 X 2	34.092
E	7.800 X 4.725 X 2	73.710
F	3.500 X 1.320 X 2	3.960
G	6.575 X 1.105 X 2	14.531
H	4.900 X 5.485 X 1	26.877
J	3.230 X 5.205 X 1	16.812
K	2.630 X 3.925 X 1	10.323
L	3.000 X 1.900 X 2	11.400
M	3.000 X 1.600 X 1	4.800
N	0.750 X 1.200 X 1	0.900
P	2.020 X 1.600 X 1	3.232
Q	0.750 X 0.285 X 1	0.214
R	5.050 X 5.205 X 1	26.285
S	4.900 X 0.280 X 1	1.372
T	2.850 X 4.975 X 1	14.179
U	2.400 X 5.010 X 1	12.024
<b>TOTAL</b>		
313.624		

UPPER PENTHOUSE AREA = ADDITION AREA - DEDUCTION AREA		
543.911-301.624 = 240.287 SQ.MT		

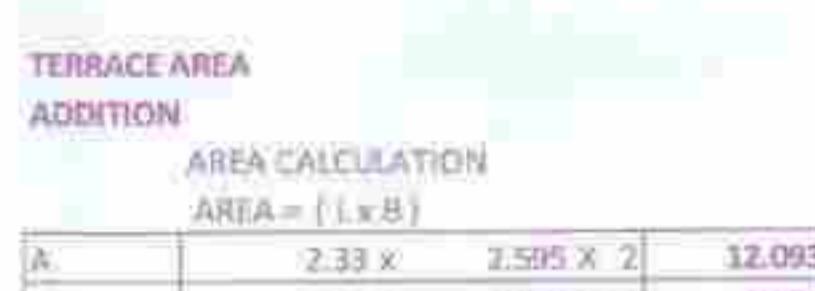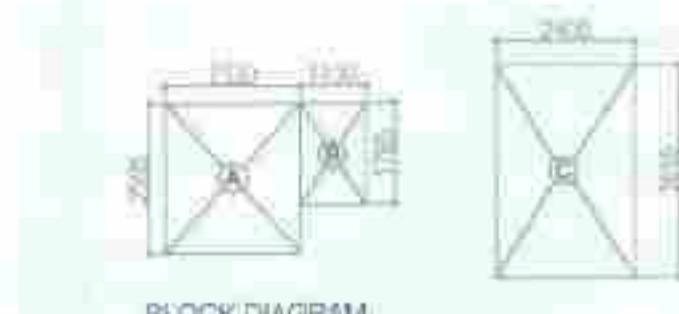

PLUMBING NOTES:-		
1.	WASH BASIN TO FLOOR TRAP (FT) 40 OD UPVC PIPE.	
2.	KITCHEN SINK TO FLOOR TRAP (FT) FLEXIBLE PIPE.	
3.	FLOOR DRAIN (FD) TO FLOOR TRAP (FT) 63 OD UPVC WASTE PIPE.	
4.	110 OD UPVC PIPE USED FOR SOIL & WASTE.	
5.	110 OD UPVC PIPE USED FOR TERRACE RAIN WATER.	
6.	90 OD UPVC PIPE USED FOR BALCONY.	
7.	110 OD UPVC SOIL & VENT PIPE.	
8.	110 OD UPVC WASTE & VENT PIPE.	
9.	75 OD UPVC ANTI-SIPHONAGE PIPE.	
10.	110 OD UPVC TERRACE RAIN WATER PIPE.	
11.	90 OD UPVC BALCONY RAIN WATER PIPE.	
12.	DOMESTIC WATER SUPPLY DN TAKE PIPE.	
13.	FLUSHING WATER SUPPLY DN TAKE PIPE.	
14.	500 DOMESTIC WATER SUPPLY RISER.	
15.	400 FLUSHING WATER SUPPLY RISER.	
16.	HOT WATER SUPPLY DN TAKE PIPE FROM SOLAR PANEL.	
17.	DOMESTIC WATER SUPPLY DN TAKE PIPE FOR TOP 40 FLOOR.	

OPENING SCHEDULE OF DOORS & WINDOWS			
SR. NO	SIZE	SILL	UNTEL TYPE
1	800 X 2100	-	2100 D1
2	900 X 2100	-	2100 D2
3	750 X 2100	-	2100 D3
4	1050 X 2400	-	2400 D4
5	1050 X 2100	-	2100 FD
6	2430 X 2325	-	2325 DW1
7	2000 X 2325	-	2325 DW2
8	2880 X 2325	-	2325 DW3
9	1500 X 2325	-	2325 DW4
10	1800 X 1275	900	8.O.B. W1
11	600 X 1275	1050	2325 V

NOTES:  
 1. DIMENSIONS ARE NOT TO BE FOLLOWED.  
 2. ALL DIMENSIONS ARE IN MM.  
 3. ALL ELECTRICAL INSTALLATIONS SHALL BE AS PER PROVISIONS OF NBC.  
 4. FIRE FIGHTING SAFETY PROVISIONS WILL BE AS PER RELEVANT NBC PROVISIONS.  
 5. BOUNDARY WALL AND GATE AS PER STANDARDS.  
 6. ALL WALLS ARE 230/115 MM THK. BRICK WALL.  
 7. RAIN WATER HARVESTING SYSTEM SHALL BE PROVIDED AS PER CENTRAL GROUND WATER AUTHORITY NORMS/HARYANA GOVT.  
 8. ALL WINDOWS & VENTILATORS ARE OPENABLE.  
 9. ALL MECHANICALLY VENTILATED & ARTIFICIALLY LIT TOILET PROVIDED WITH 24hr POWER BACKUP.

DEVELOPED BY:

PROJECT:

PROPOSED BUILDING PLAN OF GROUP HOUSING COLONY AREA MEASURING 11.125 ACRES (LICENSE NO. 87 OF 2013 DATED 11-10-2013 IN SECTOR-89-A, GURGAON MANESAR URBAN COMPLEX BEING DEVELOPED BY DALE DEVELOPERS PVT. LTD. AND OTHERS IN COLLABORATION WITH VATIKA LTD.

DRAWING TITLE :  
TOWER - 6, TYPE - A, FLOOR PLAN & AREA  
DIAGRAM  
+20450 TO 93175 MM LVL

DEALT BY : SCALE : 1:100 @ A0 DRG. NO. A-2.2  
CHECKED BY : DATE :


THROUGH : AUTHORISED SIGNATORY

For VATIKA LIMITED Architects & Engineers Signature	IAA/MS/2013/CAP/001 Signature
OWNER'S SIGN	ARCHITECT'S SIGN

D.T.P (HQ)  
B.T.P (G)  
M.T.P (B)  
C.T.P (B)  
B.P.A.C  
B.P.A.C

SD  
HA  
JB  
KS  
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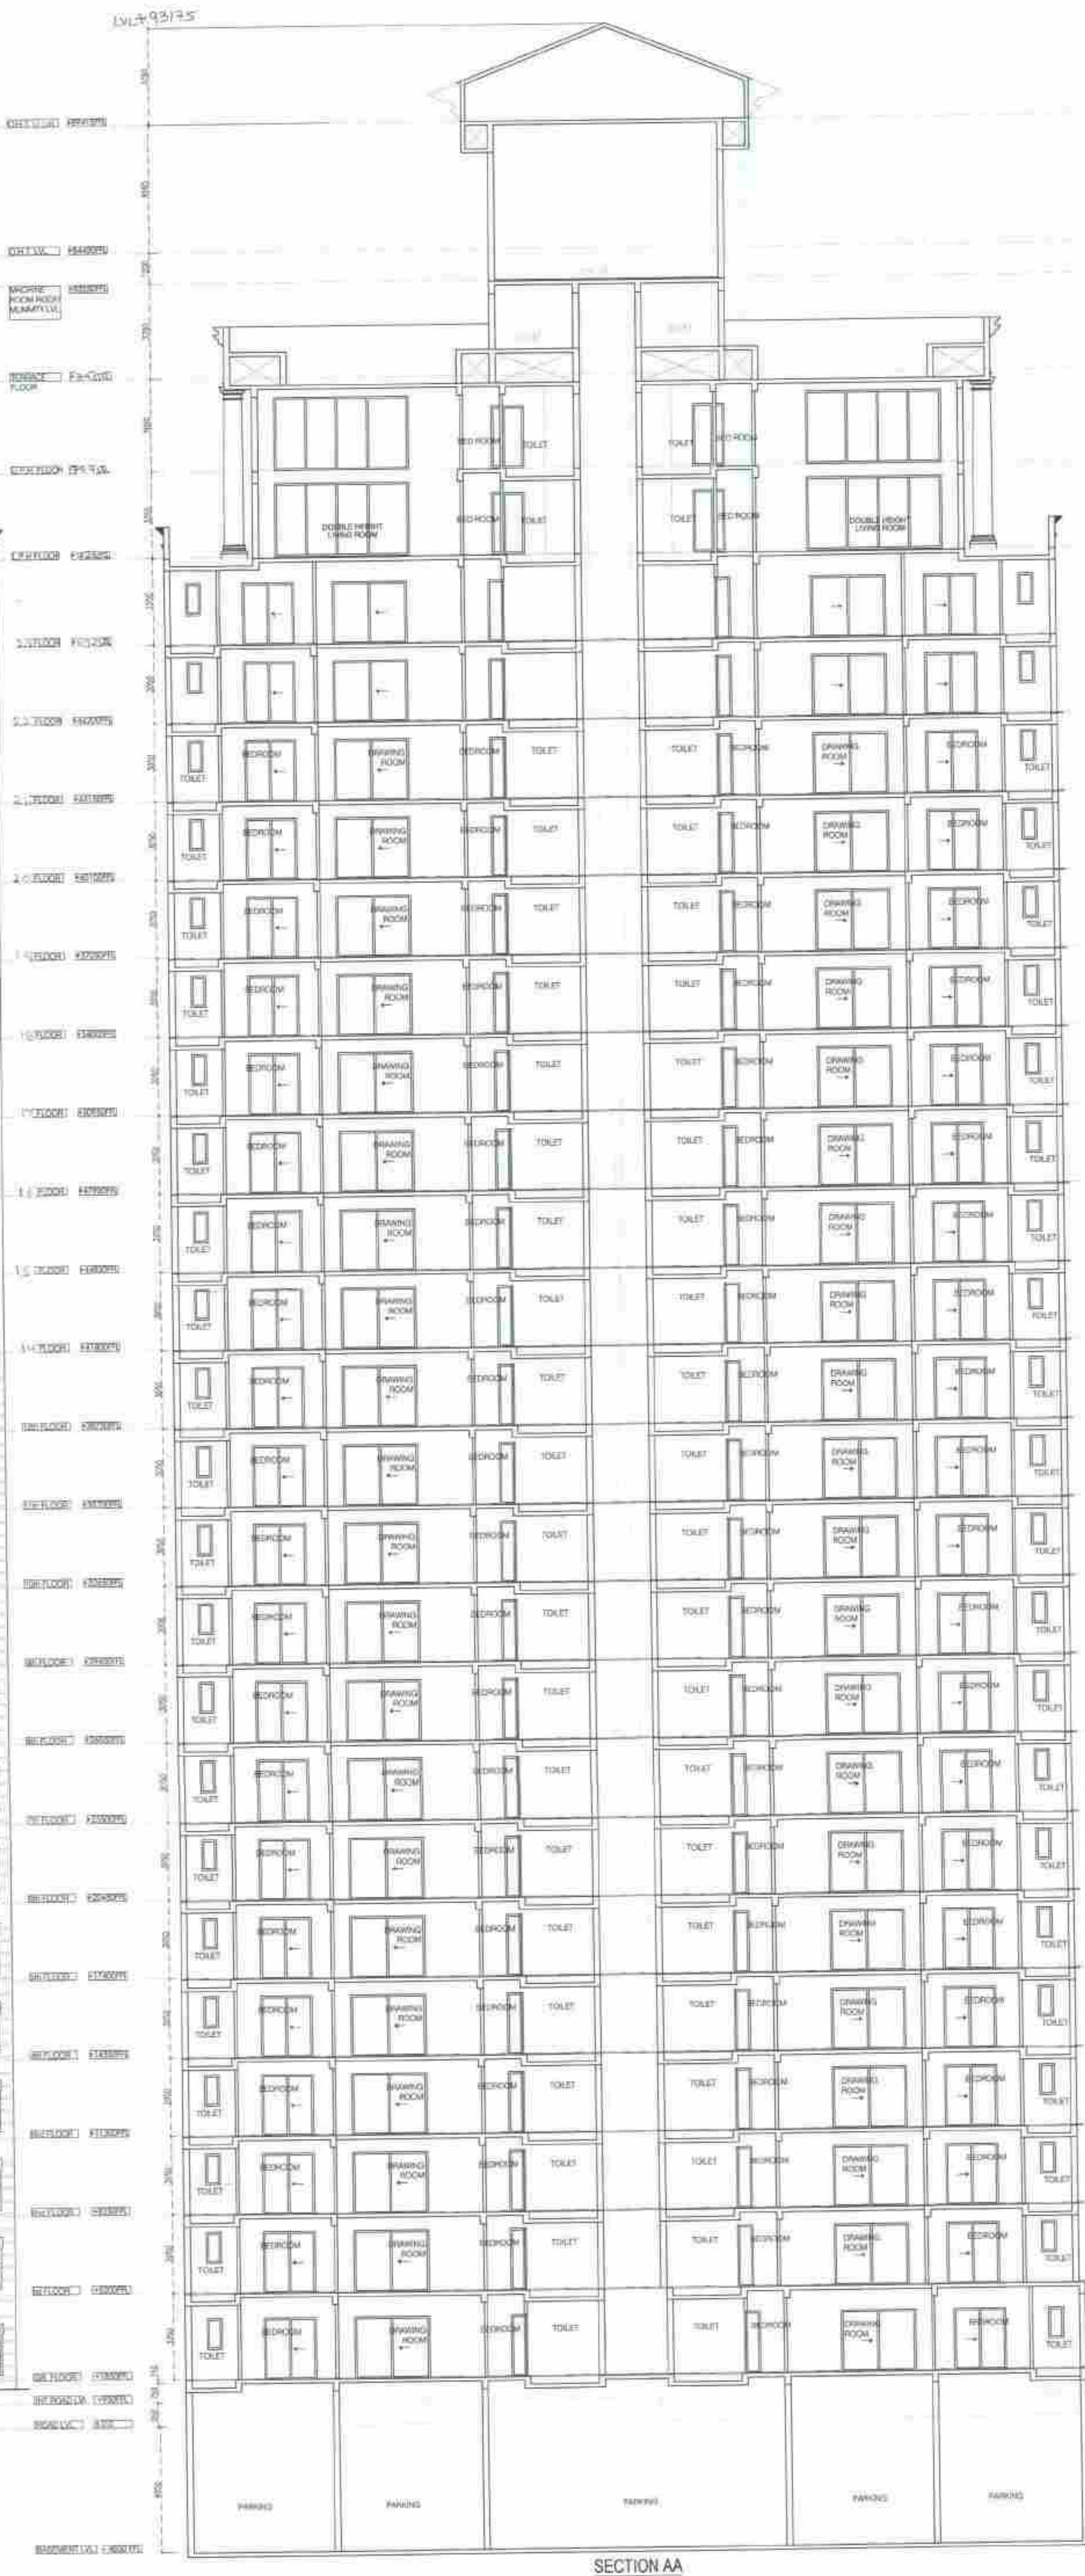
FIRE LEGEND :-		
(A)	1500 M.S. PIPE WET RISER PIPE	
(B)	1500 M.S. SPRINKLER RISER PIPE	
(C)	800 M.S. SPRINKLER DRAIN PIPE	
F.H.	FIRE HOSE CASHET	
FS.	FLOW SWITCH	
EXT.	EXTENDED THROW SIDE WALL SPRINKLER	
NORM.	NORMAL SIDE WALL TYPE SPRINKLER	
SPRINKLER FEEDER LINE		
IMPORTANT NOTES:-		
300 x 300mm CUT OUT IN FHC.		
1) 1500 WET RISER.		
2) 800 DRAIN PIPE.		

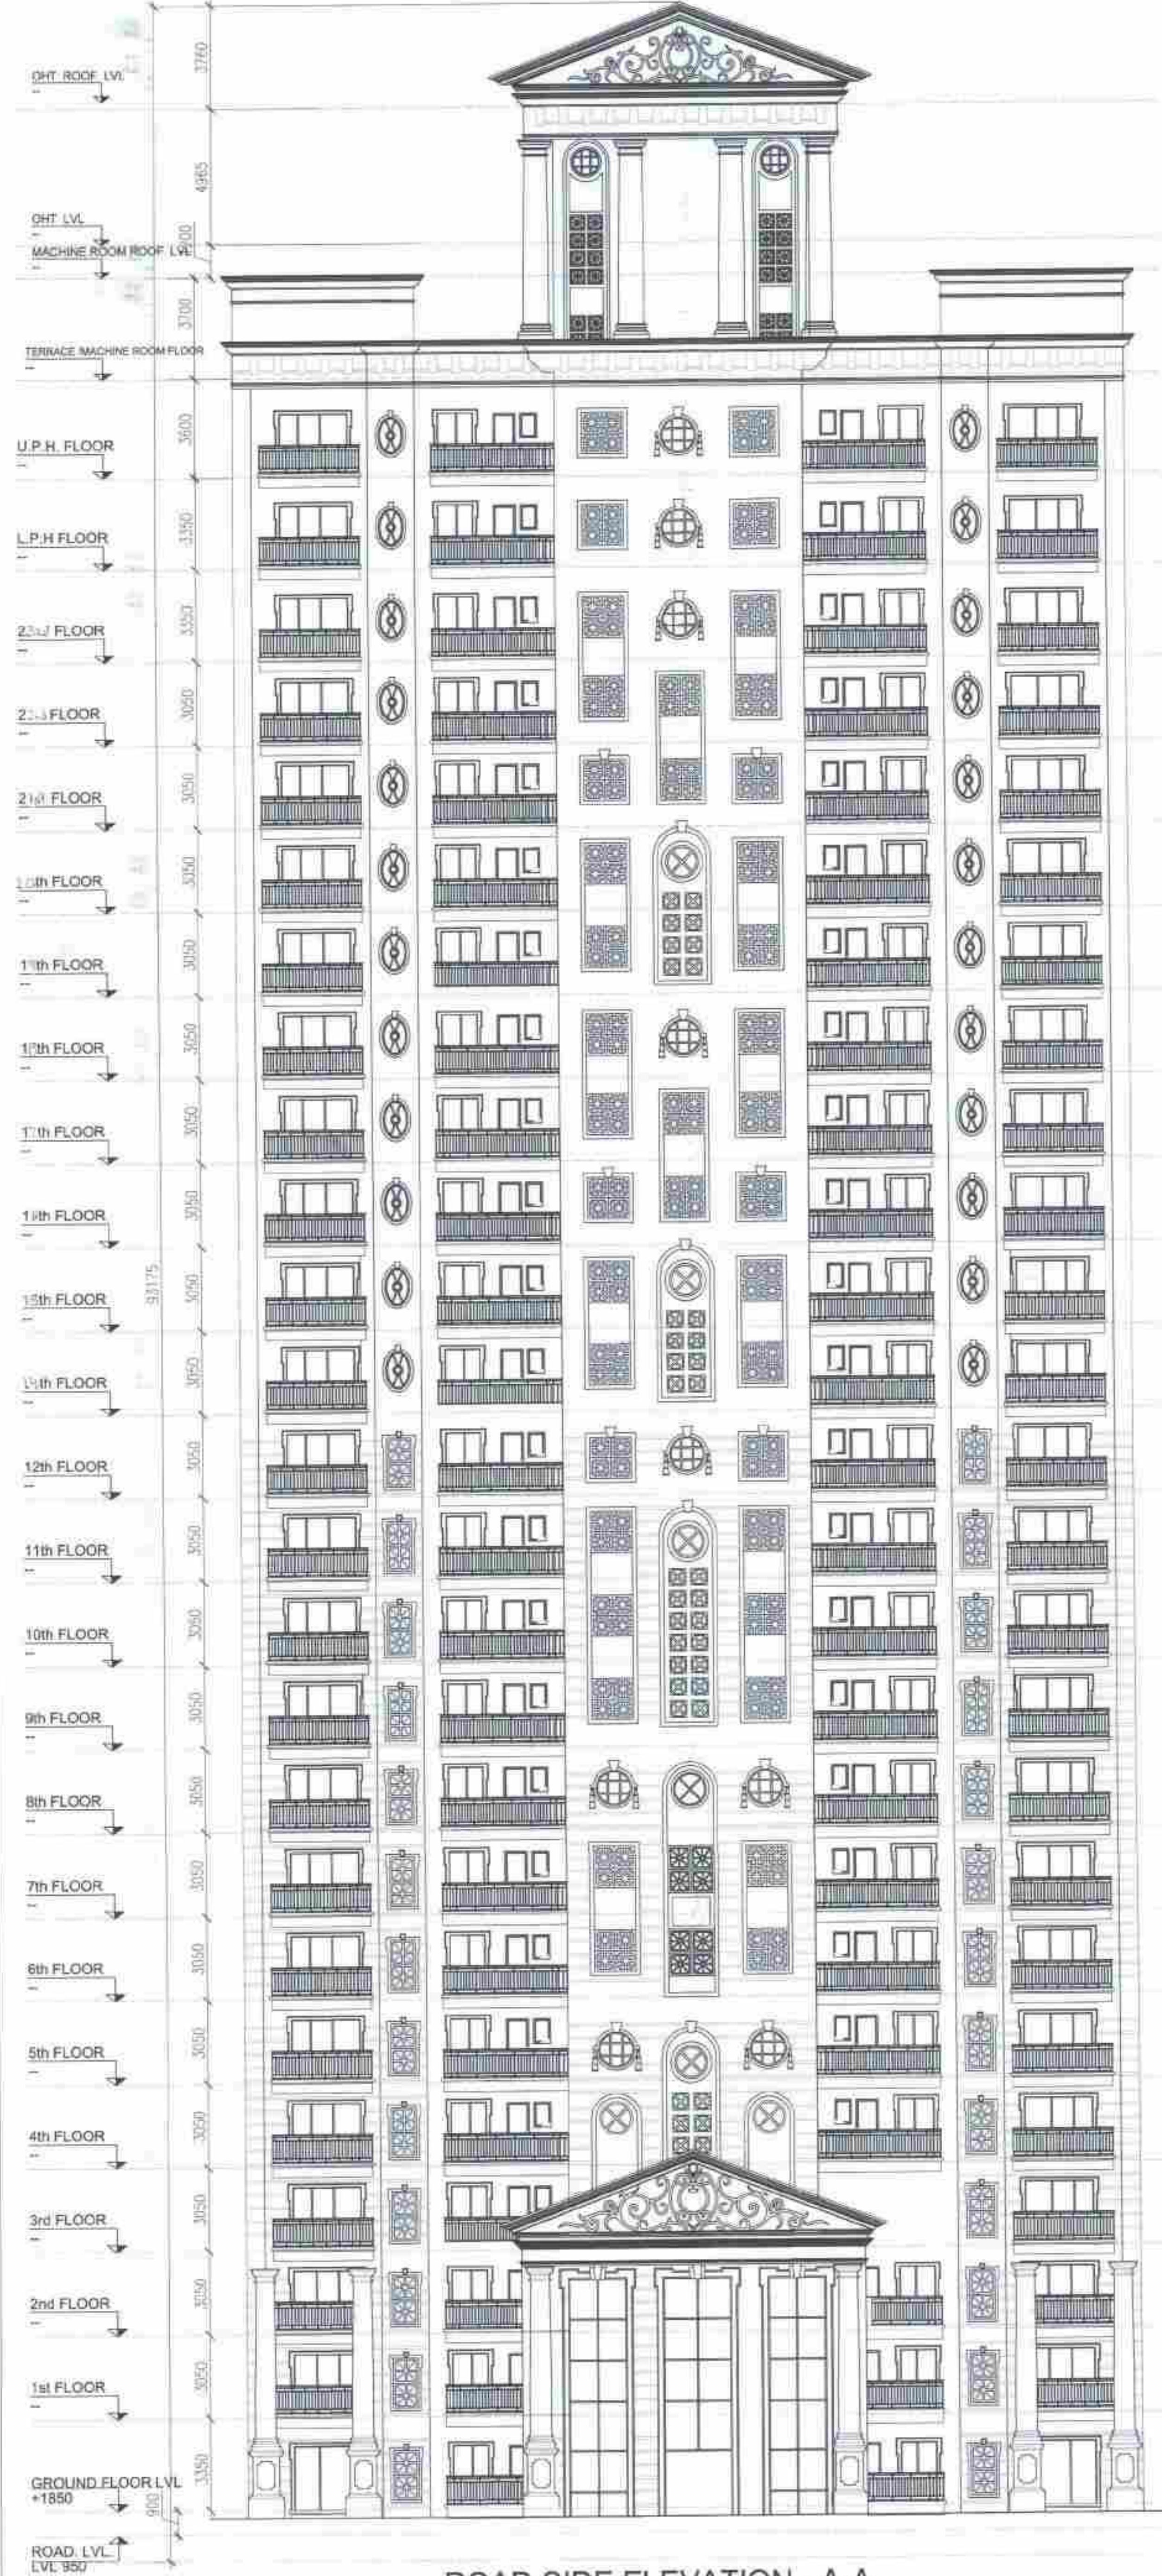

ROAD SIDE ELEVATION - A-A



GARDEN SIDE ELEVATION - A-A



SECTION AA

D.T.P. (H.Q.)  
Manager Secretary  
B.P.A.C.  
S.T.P. (G)  
Manager Secretary  
B.P.A.C.

AD SD PA ATC

NOTES

1. DIMENSIONS ARE NOT TO BE SCALED.
2. ALL DIMENSIONS ARE IN MM.
3. ALL ELECTRICAL INSTALLATIONS SHALL BE AS PER PROVISIONS OF NBC.
4. FIRE FIGHTING SAFETY PROVISIONS WILL BE AS PER RELEVANT NBC PROVISIONS.
5. BOUNDARY WALL AND GATE AS PER STANDARDS.
6. ALL WALLS ARE 230X15 CM THICK BRICK WALL.
7. RAIN WATER HARVESTING SYSTEM SHALL BE PROVIDED AS PER THE GROUND WATER AUTHORITY NORMS HARYANA GOVT.
8. ALL WINDOWS & VENTILATORS ARE OPENABLE.
9. ALL MECHANICALLY VENTILATED & ARTIFICIALLY LIT TOILET PROVIDED WITH 24hr POWER BACKUP.

DEVELOPED BY:

PROJECT:

PROPOSED BUILDING PLAN OF GROUP HOUSING COLONY AREA MEASURING 11.125 ACRES (LICENSE NO. 87 OF 2013 DATED 11-10-2013 IN SECTOR-R9-A, GURGAON MANESAR URBAN COMPLEX BEING DEVELOPED BY DALE DEVELOPERS PVT. LTD. AND OTHERS IN COLLABORATION WITH VATIKA LTD.









DRAWING TITLE :  
TOWER - 6, TYPE - A, ELEVATION &  
SECTION

DEALT BY	SCALE	DRG. NO.
CHECKED BY	DATE	A-2.3

THROUGH : AUTHORISED SIGNATORY

For VATIKA LIMITED	MANU KUMAR GURTA CHIEF SIGNATORY
--------------------	-------------------------------------

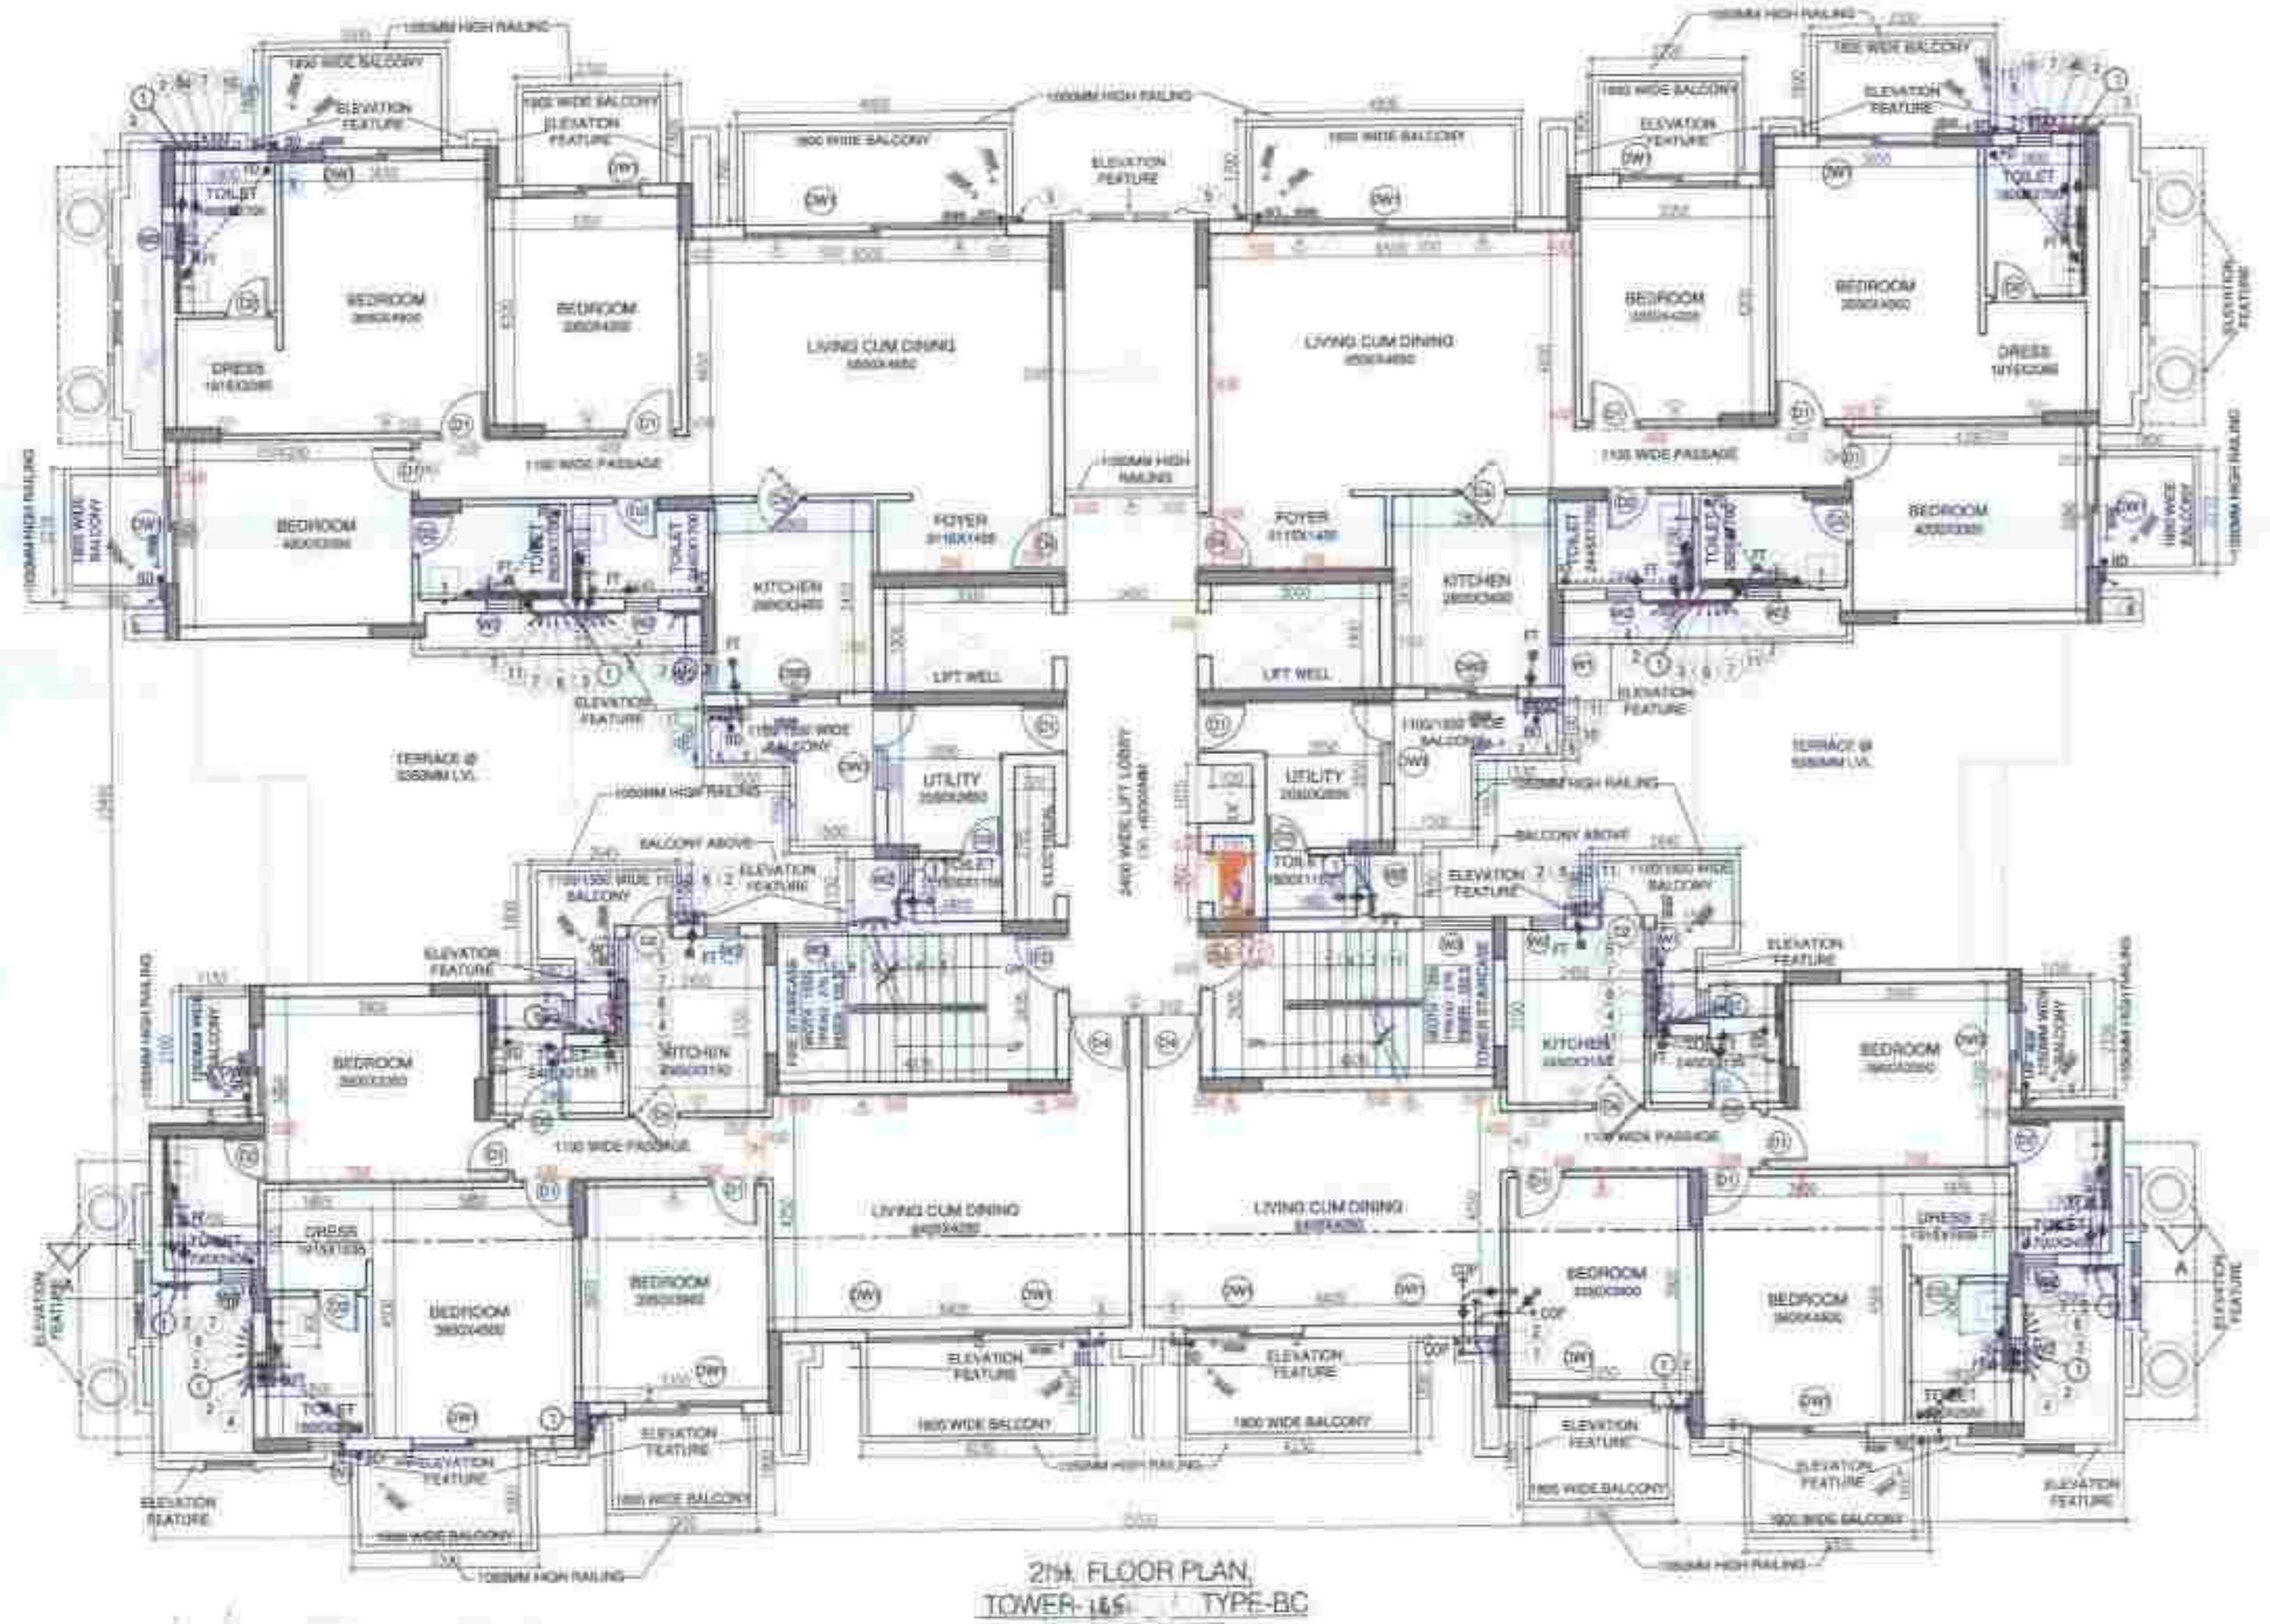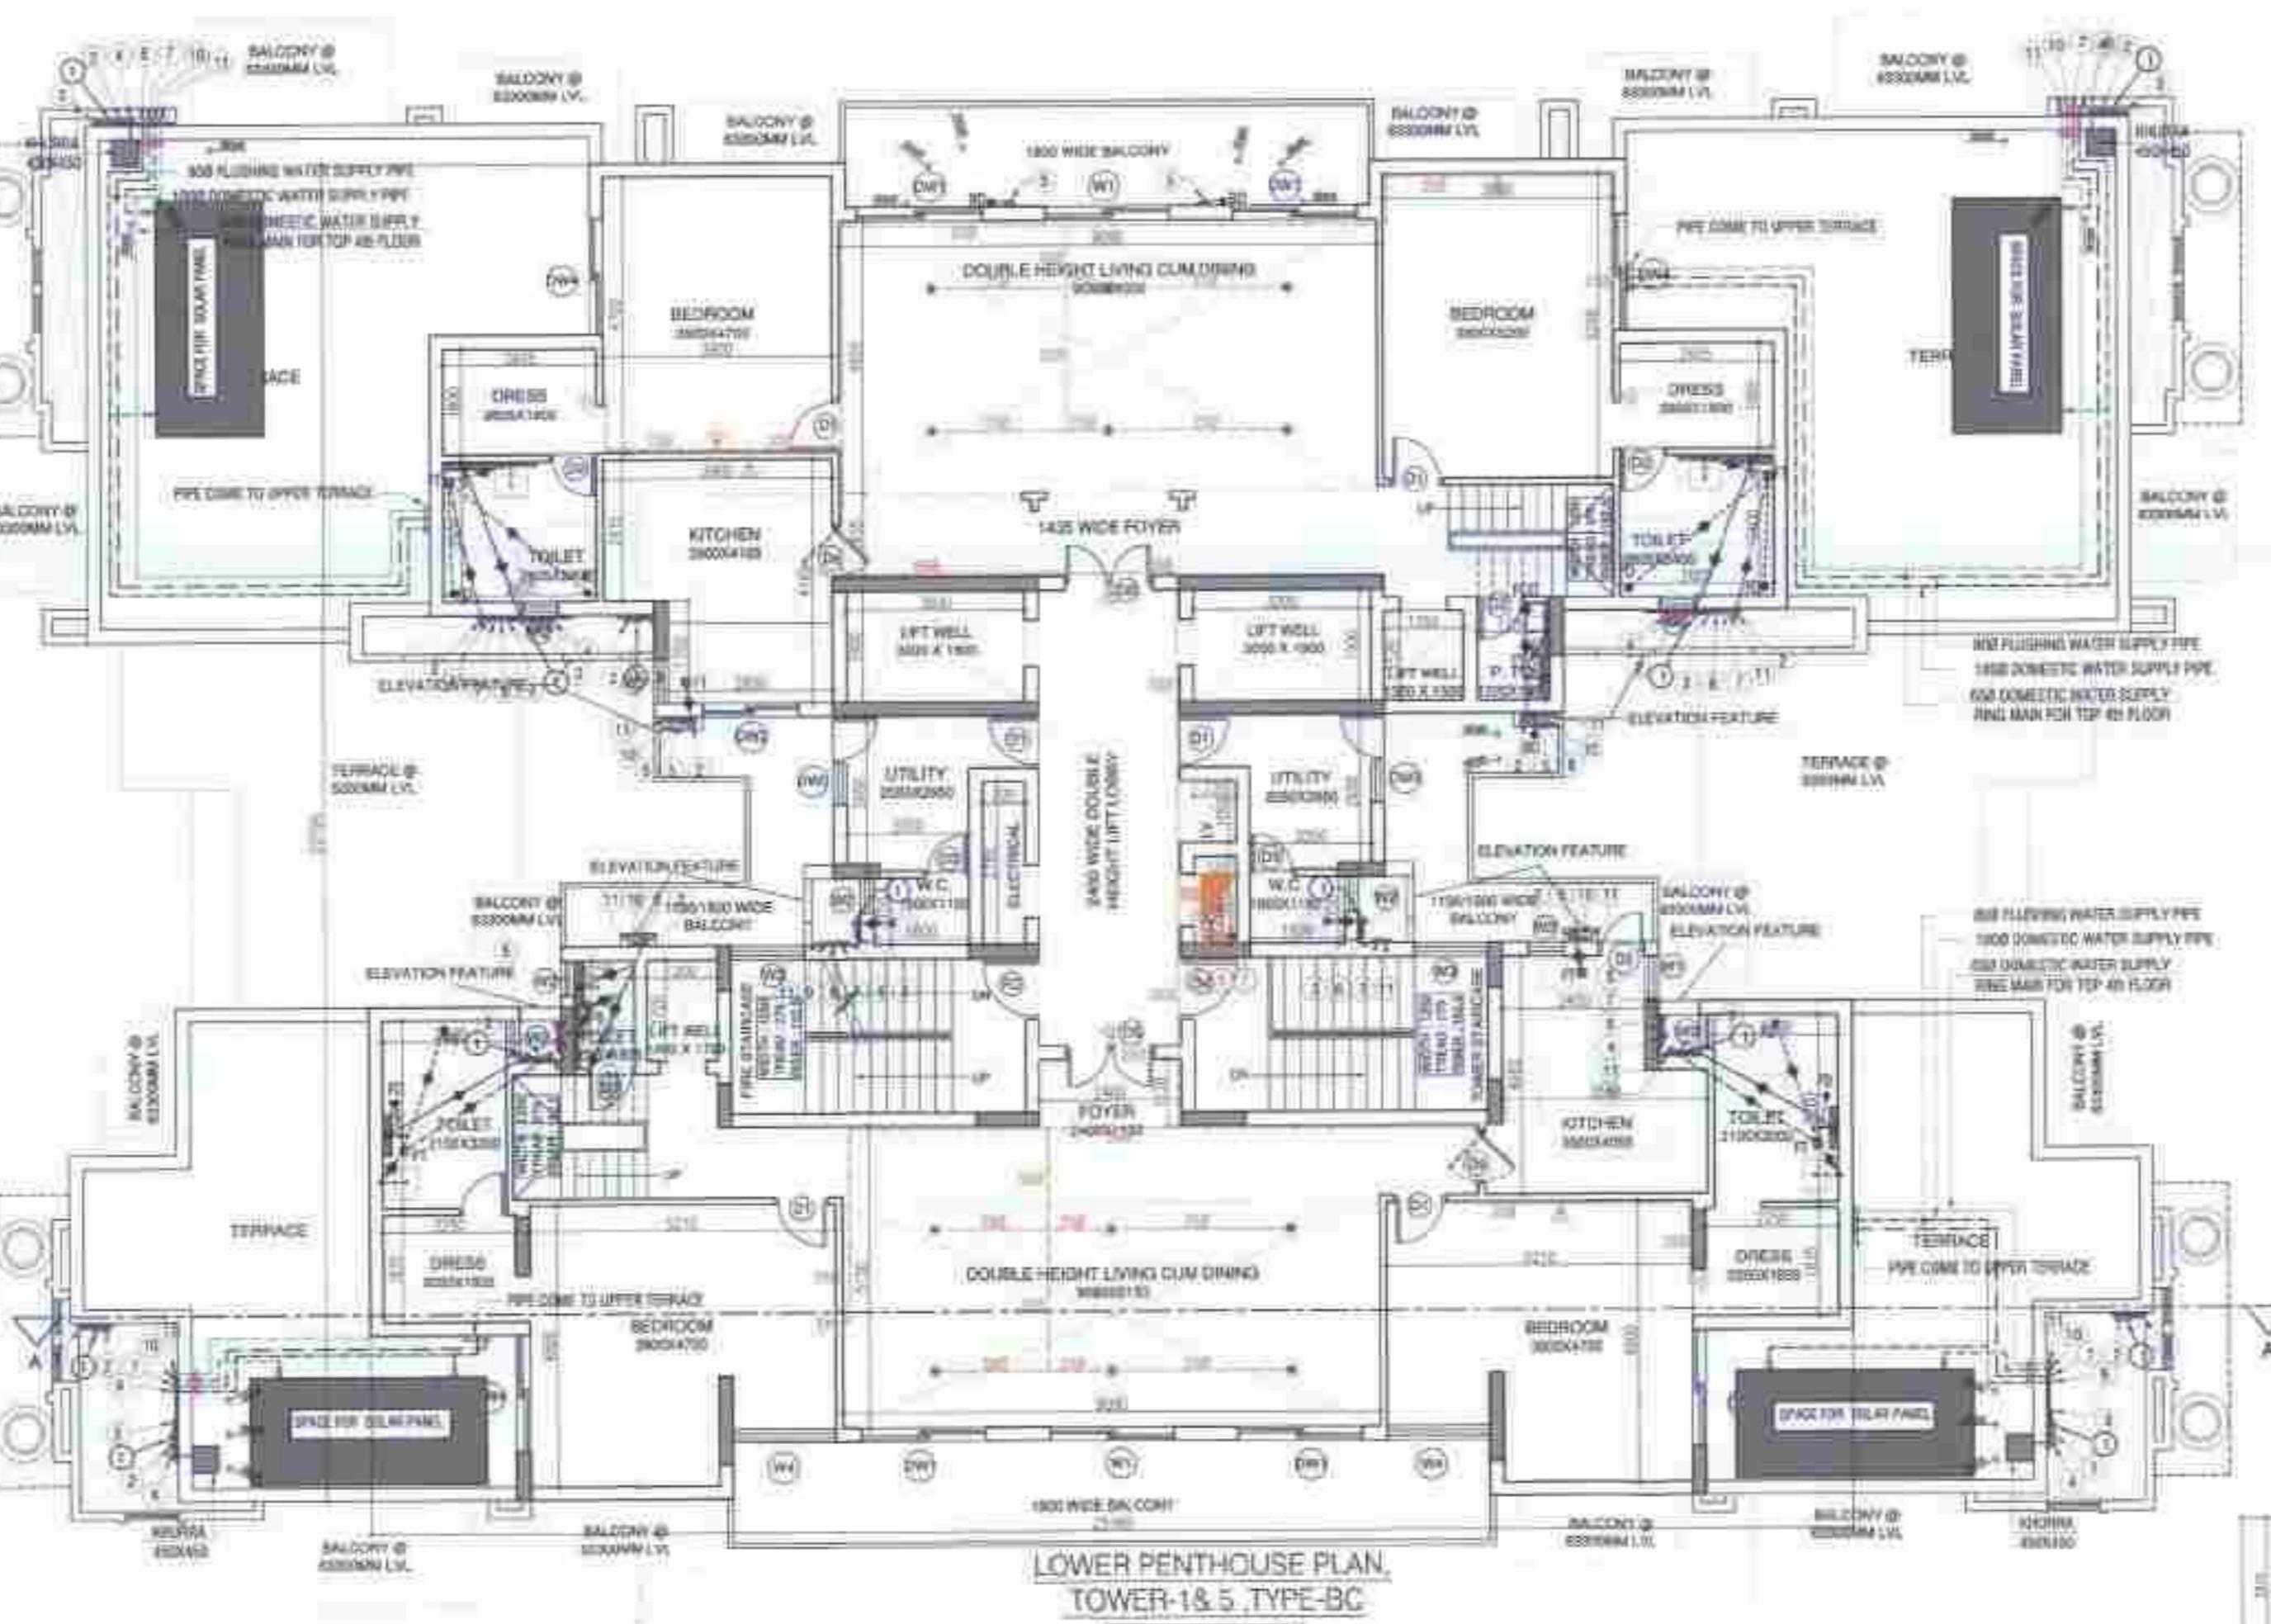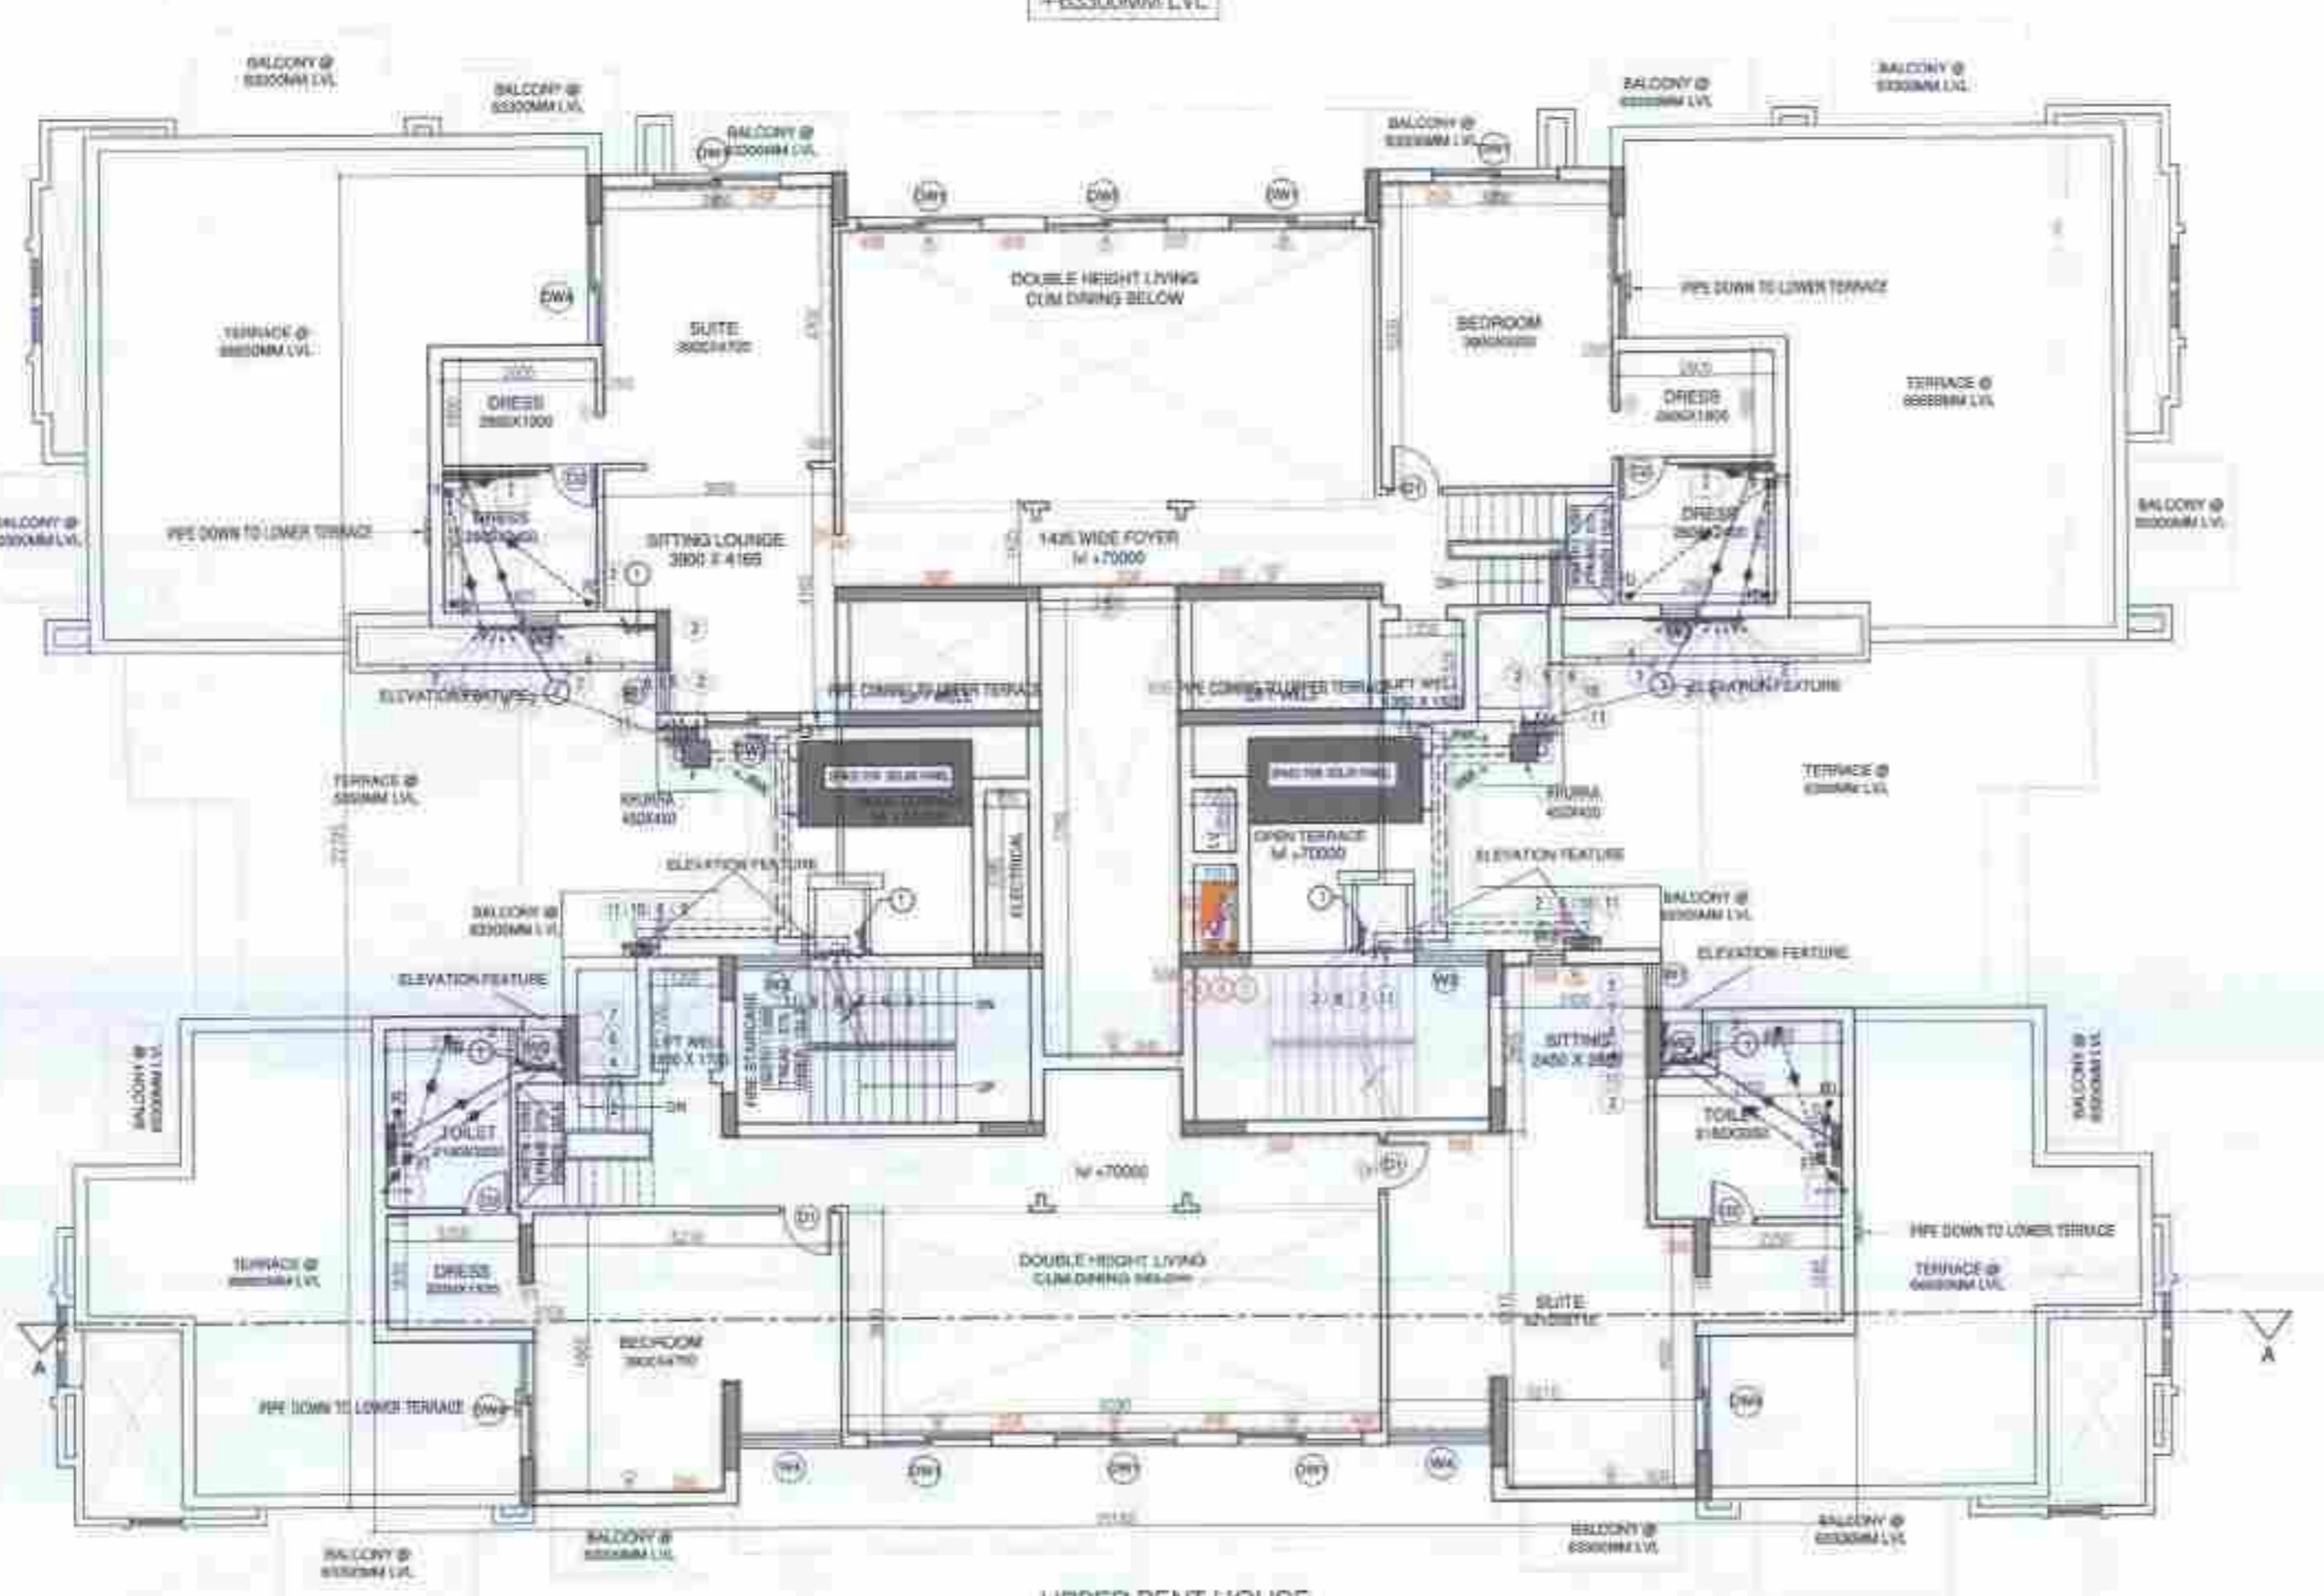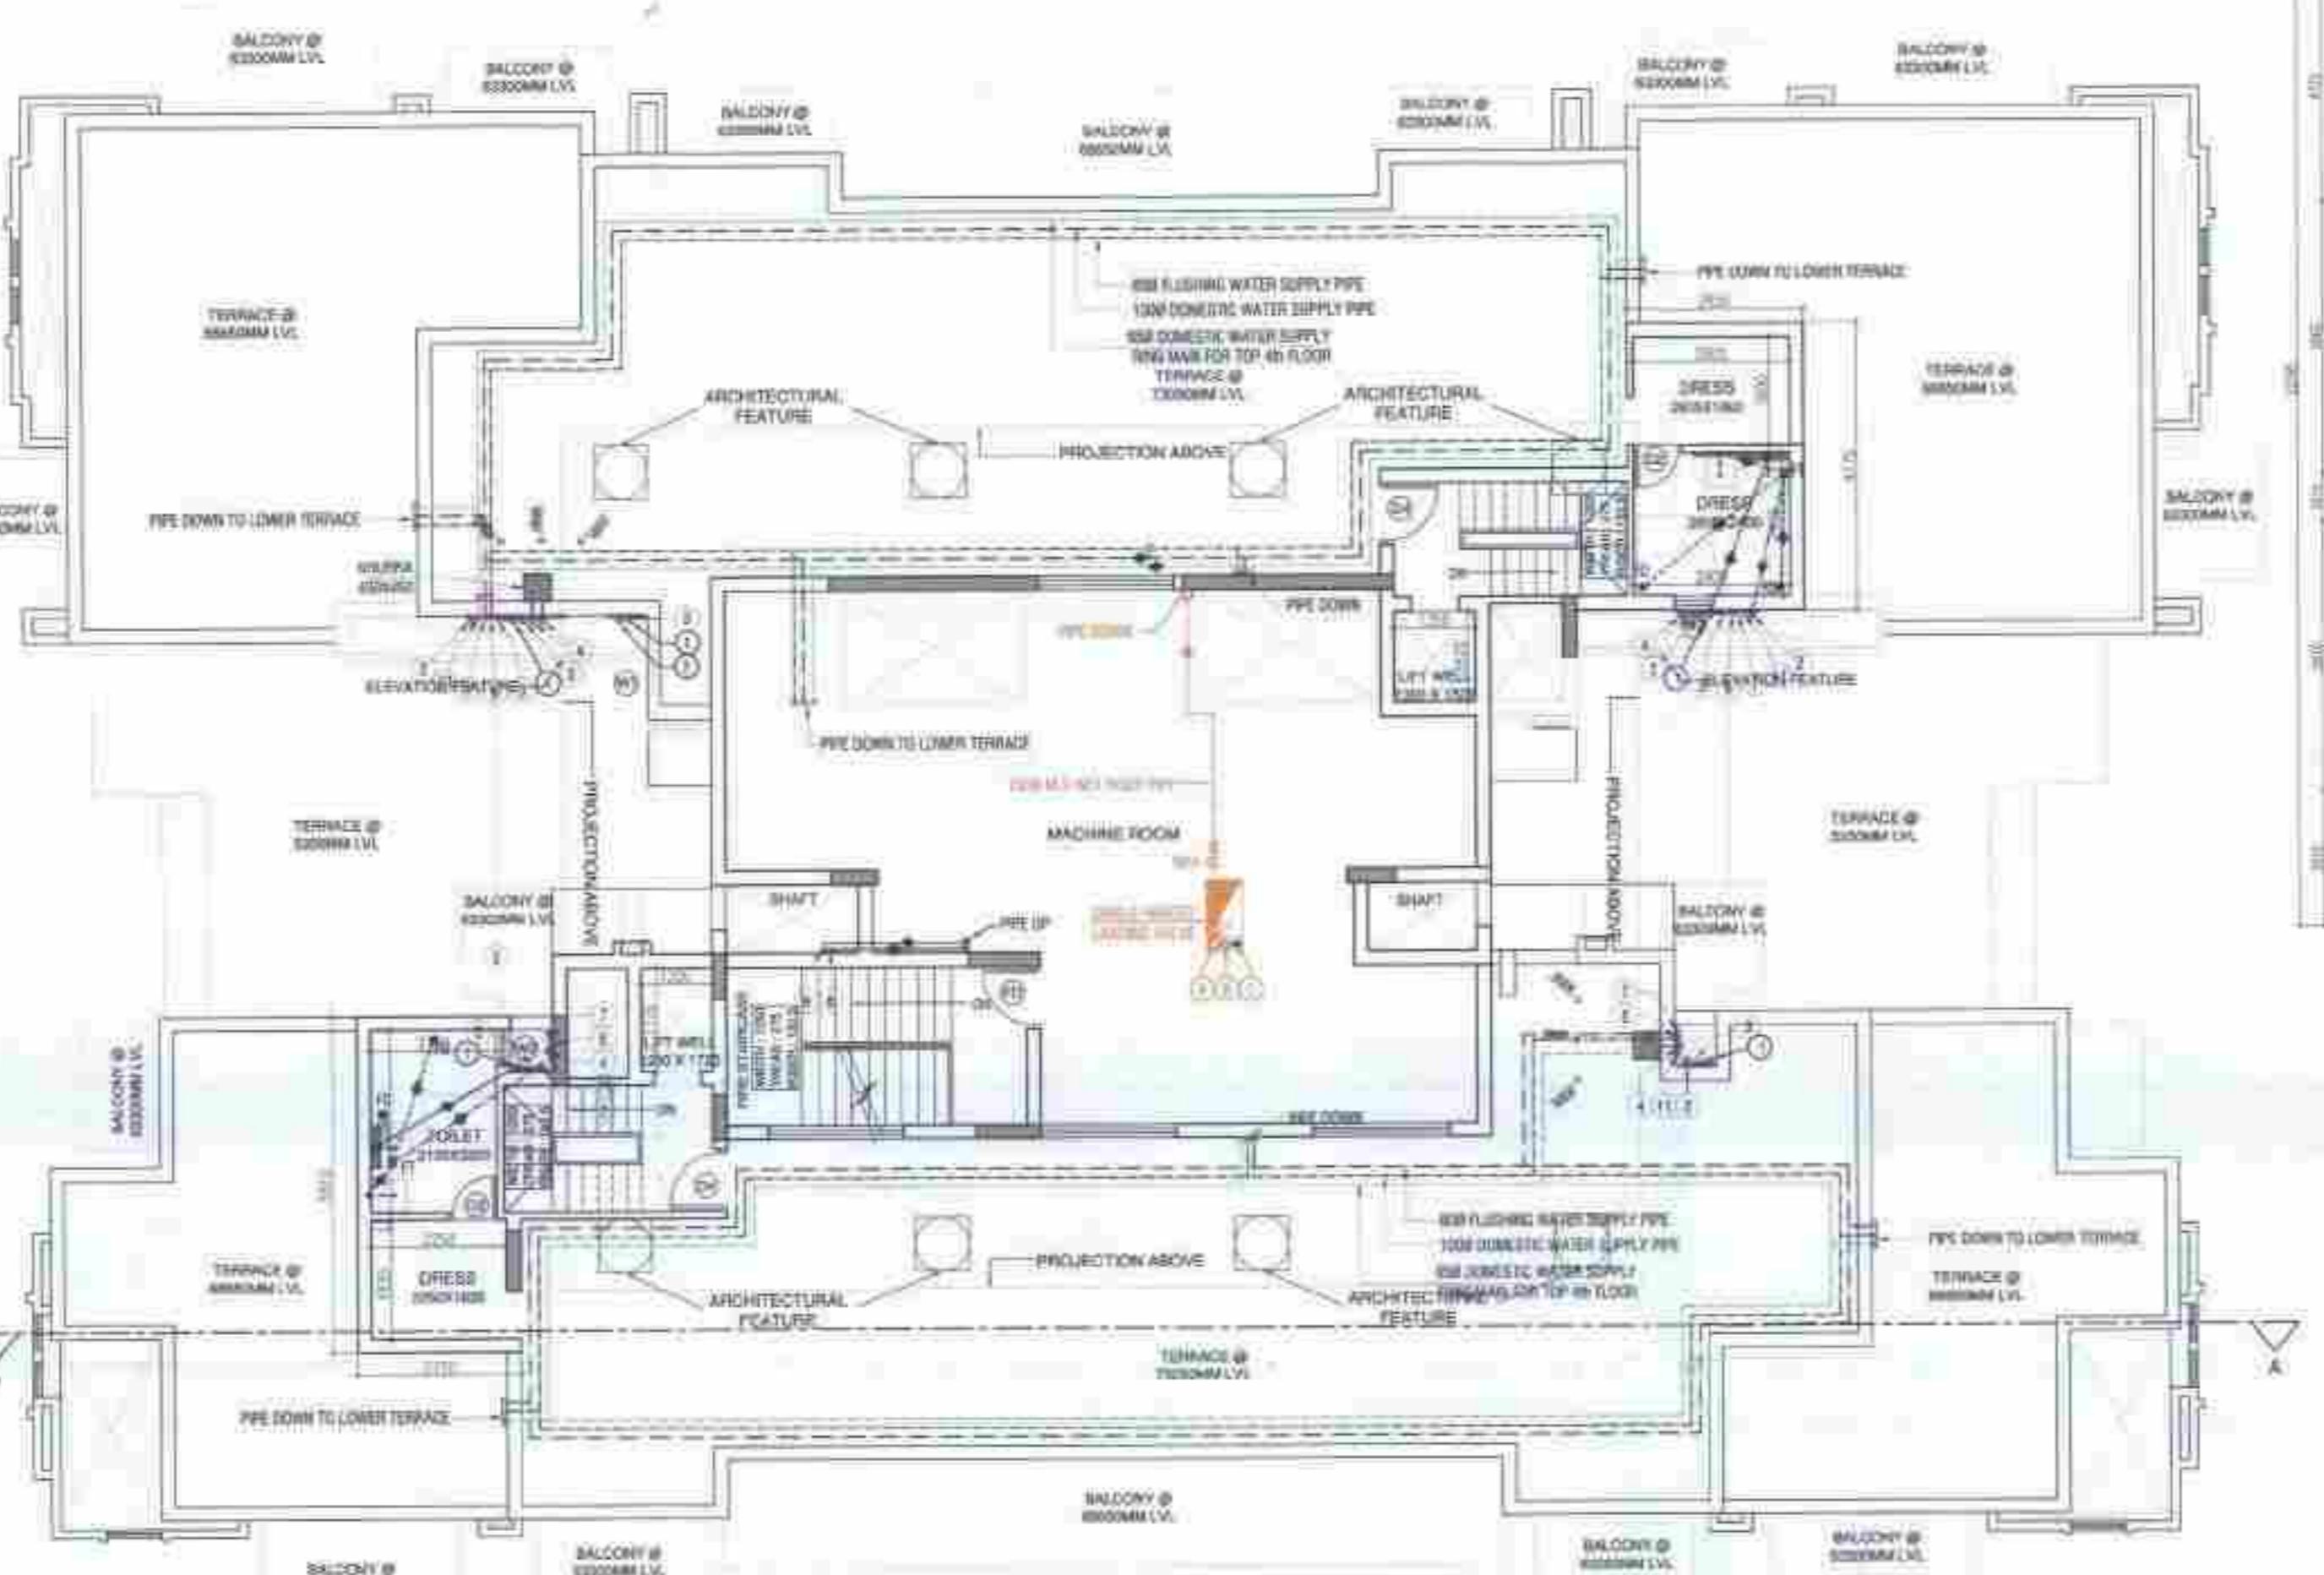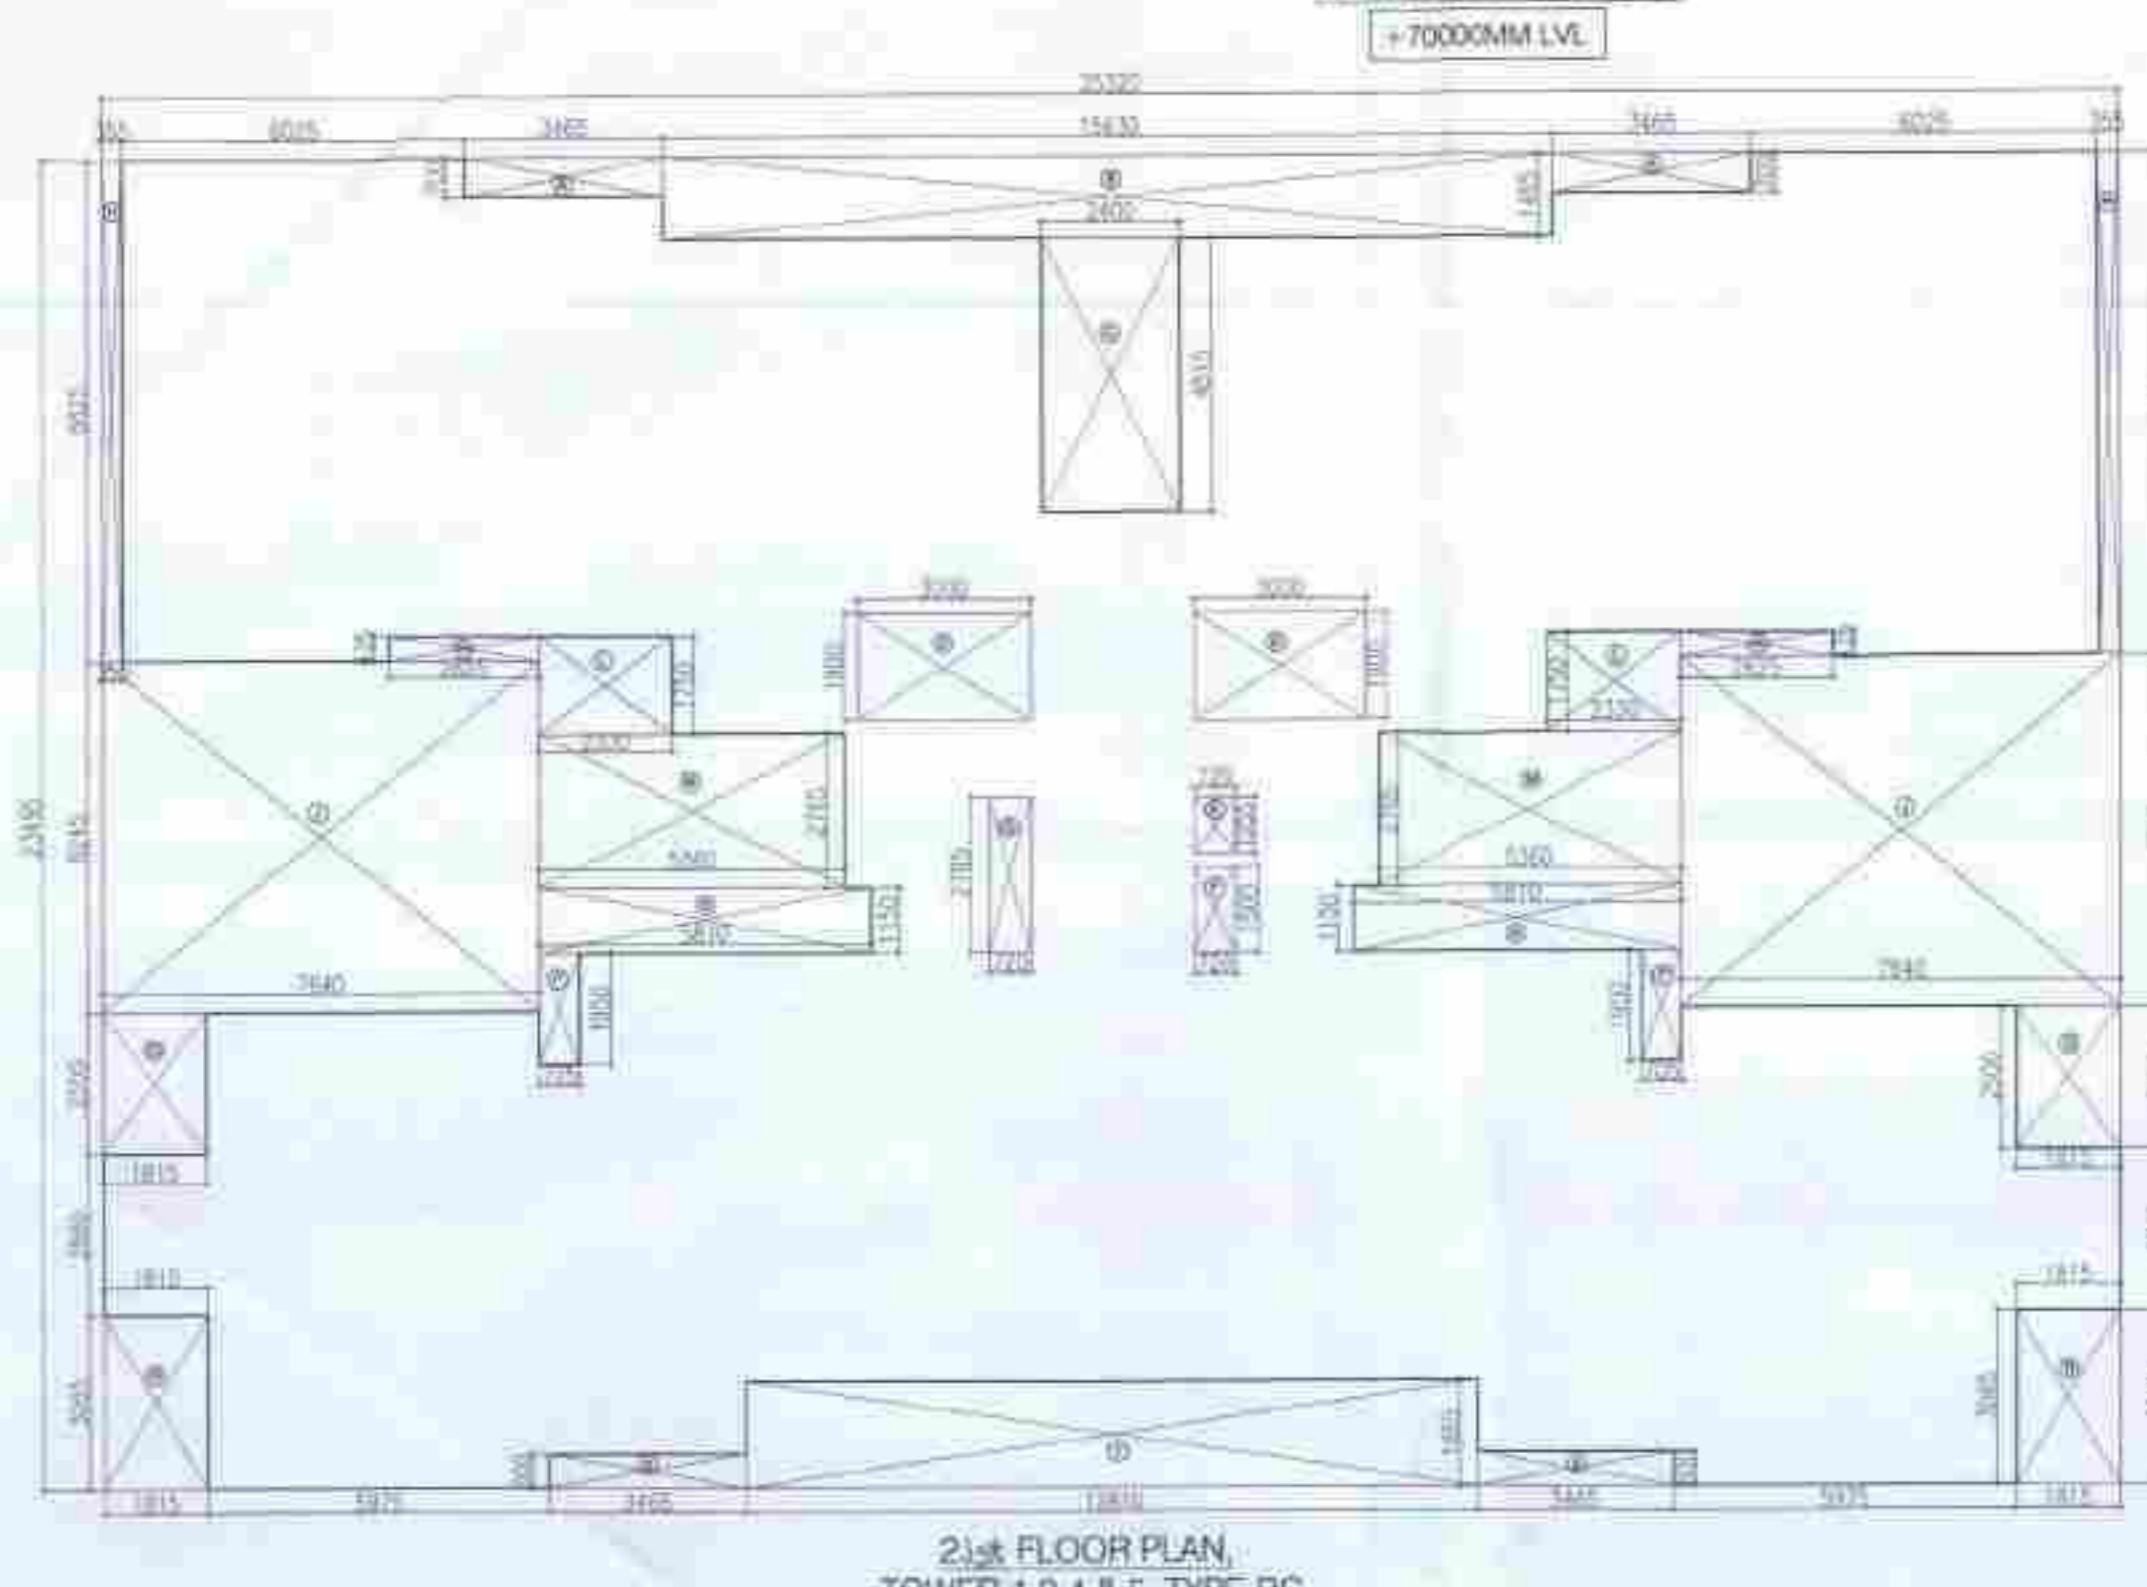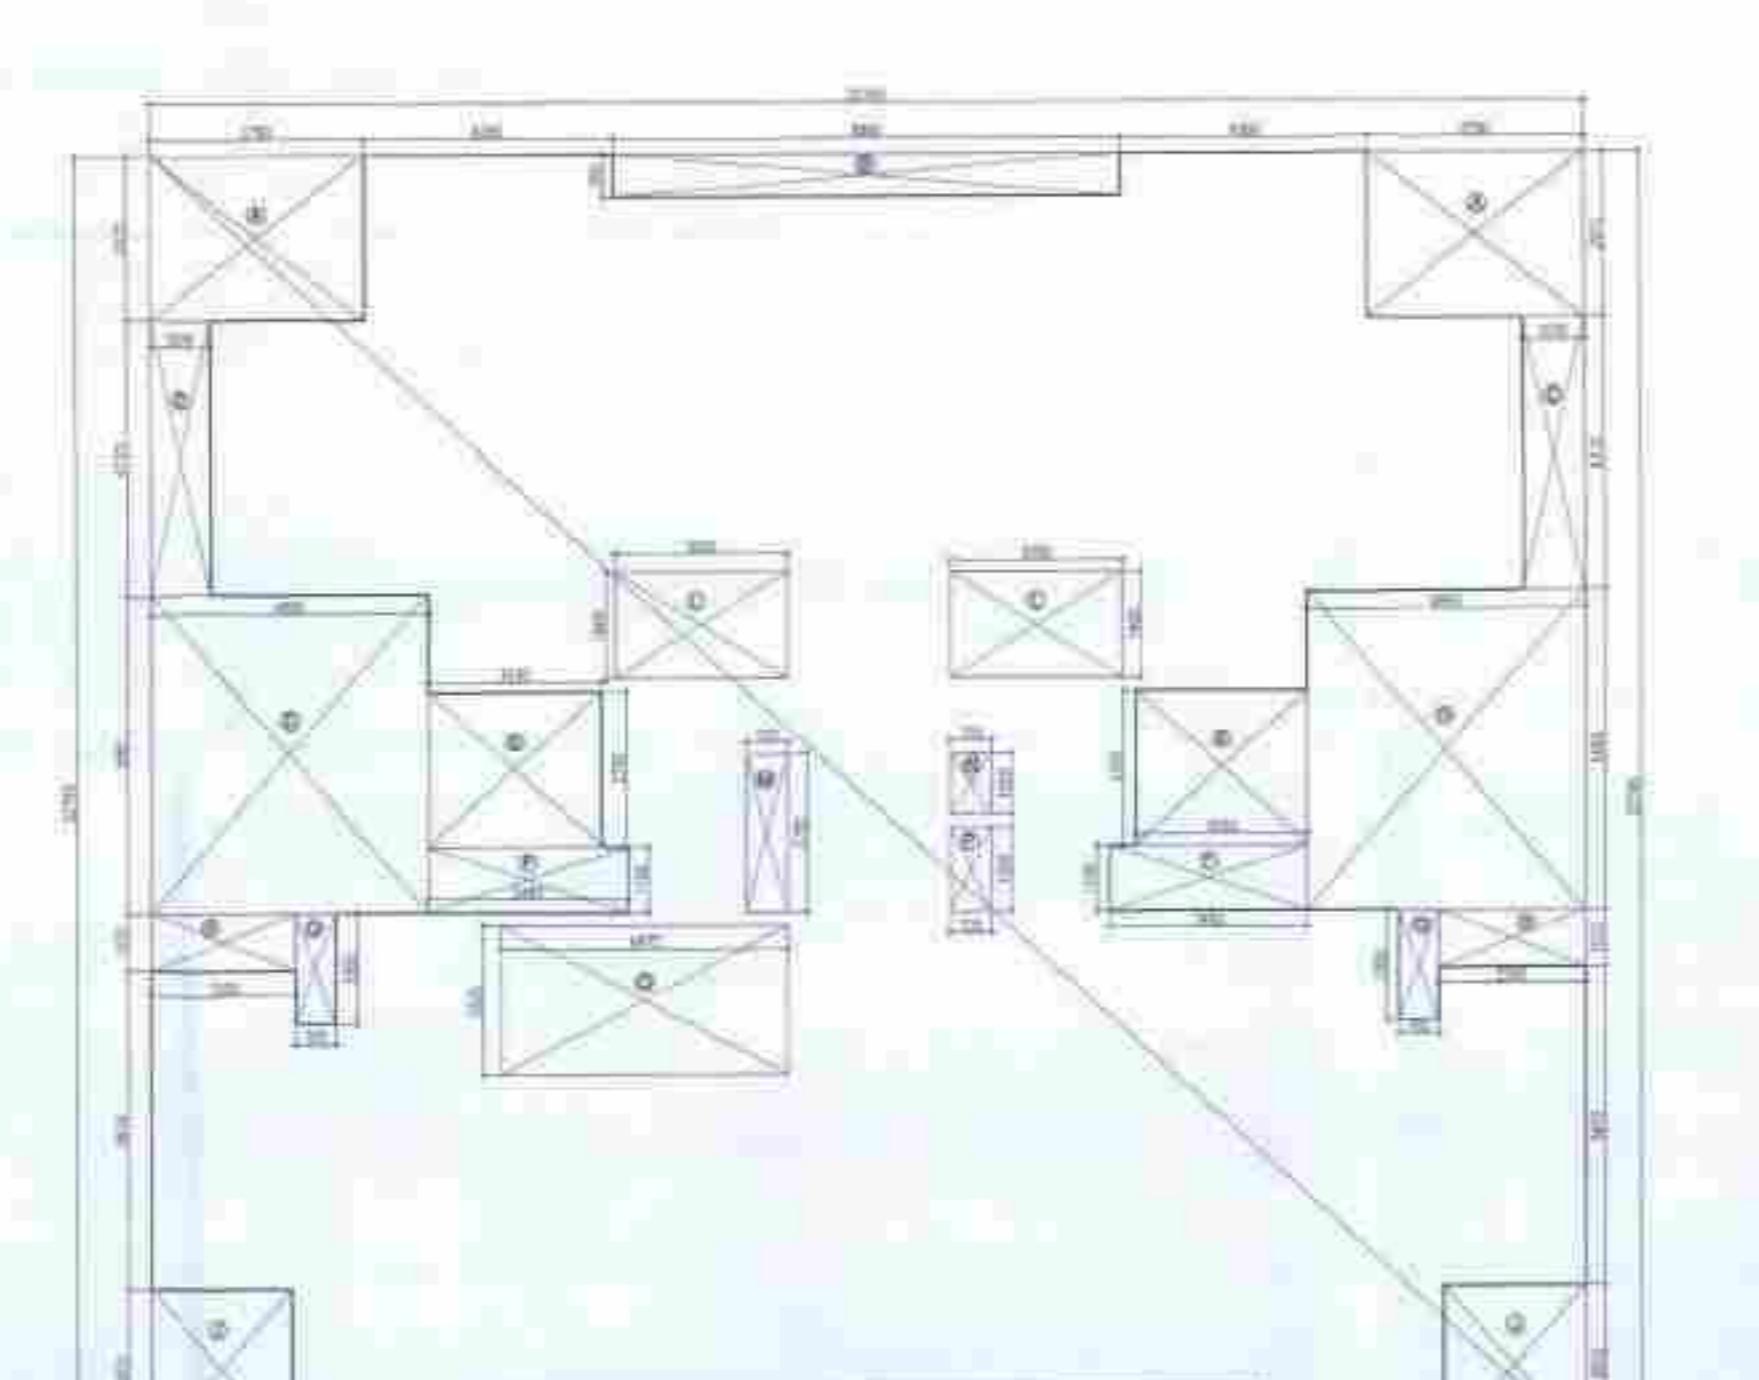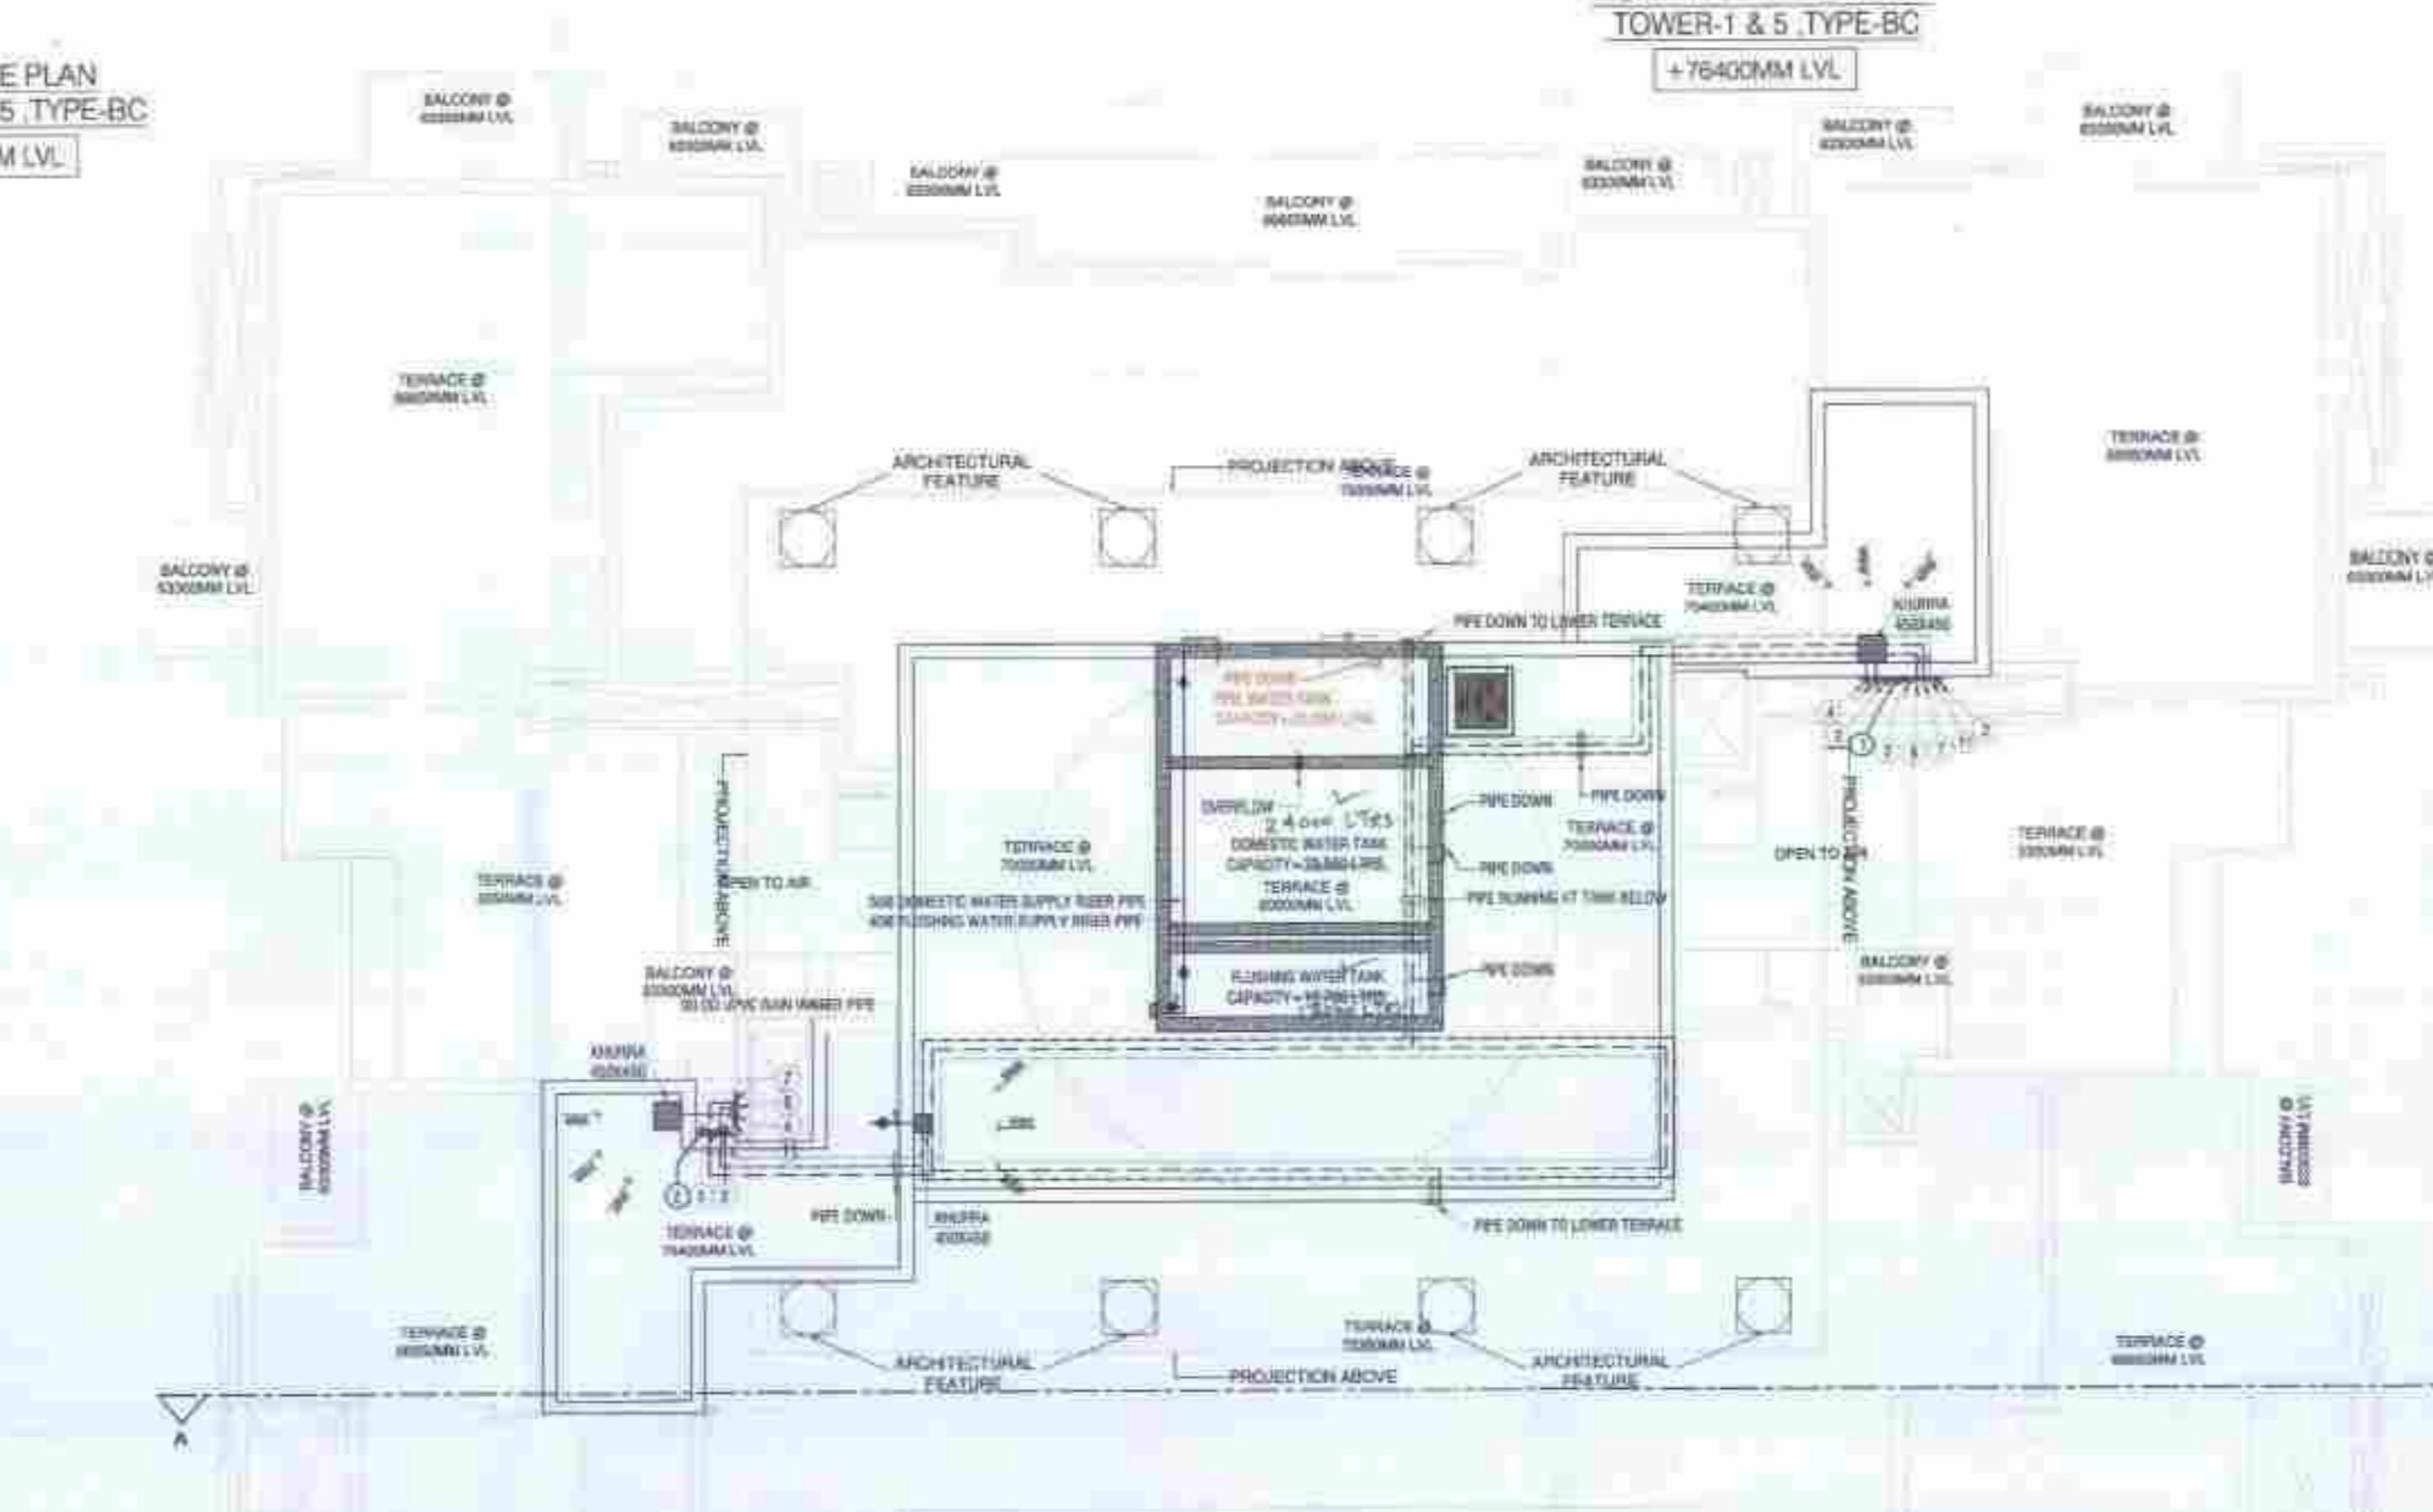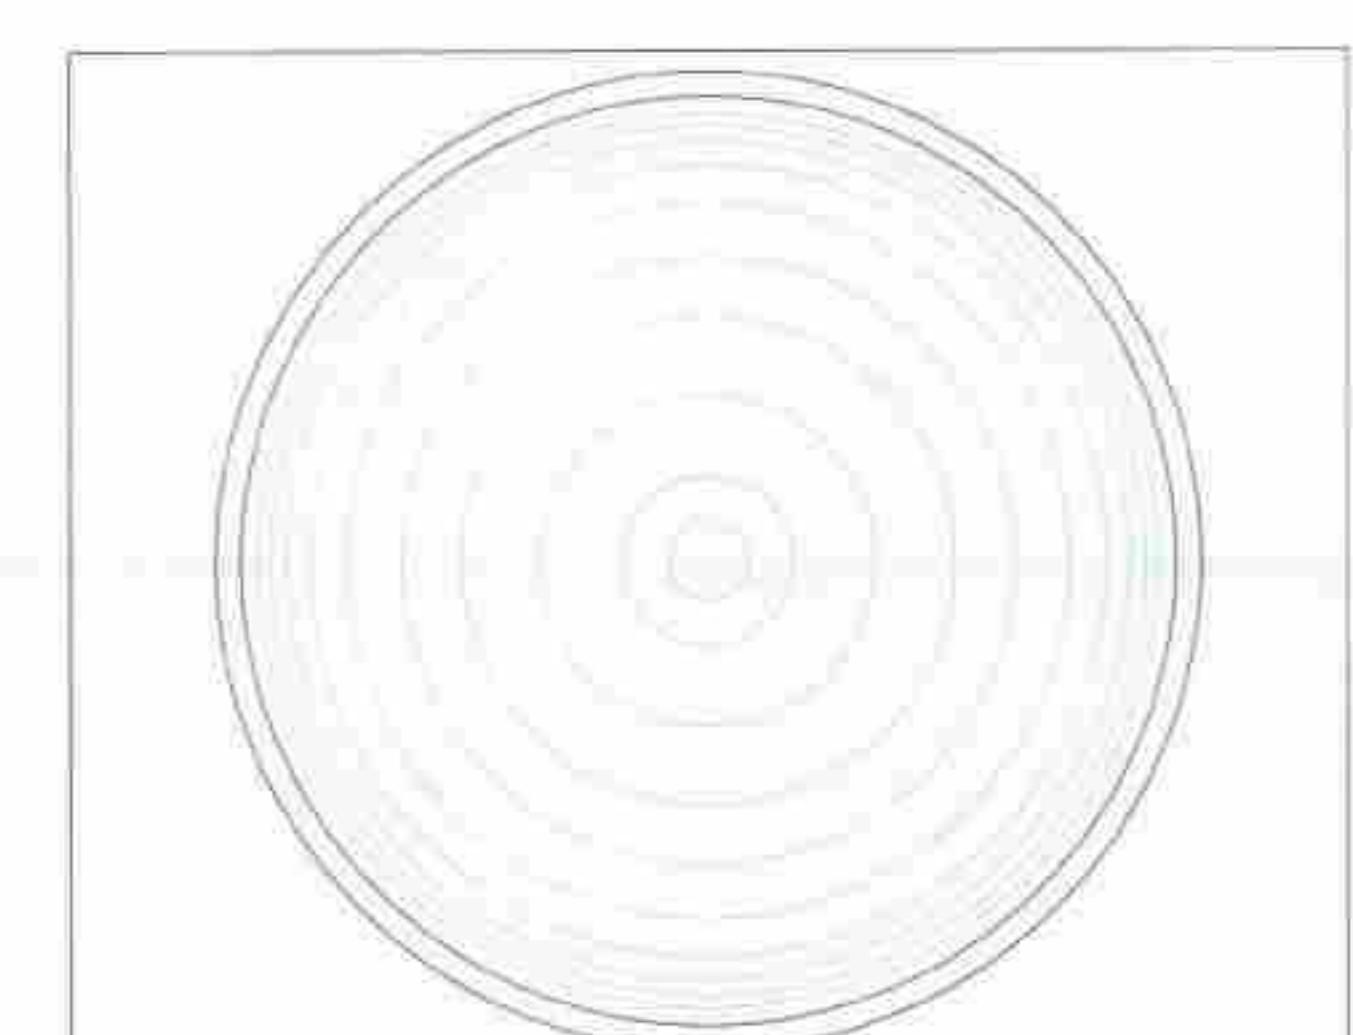

2ND FLOOR PLAN,  
TOWER-1&5 TYPE-BC  
+63300MM LVLLOWER PENTHOUSE PLAN,  
TOWER-1&5, TYPE-BC  
+66650MM LVLUPPER PENT HOUSE  
TOWER-1 & 5, TYPE-BC  
+70000MM LVLTERRACE PLAN  
TOWER-1&5, TYPE-BC  
+73350MM LVL2ND FLOOR PLAN,  
TOWER-1,2,4,5, TYPE-BC  
+63300MM LVLLOWER PENT HOUSE AREA DIAGRAM  
TOWER-1 & 5, TYPE-BC  
+66650MM LVLO.H.T. TOP PLAN  
TOWER-1&5, TYPE-BC  
+80600MM LVLTOWER-1&5  
TERACE TOP  
LVL → 67450

SR. NO.	SIZE	SILL	LINTEL	TYPE
1	900 X 2100	-	2100	D1
2	800 X 2100	-	2100	D2
3	750 X 2100	-	2100	D3
4	1050 X 2400	-	2400	D4
5	900 X 2100	-	2100	D5
6	1050 X 2100	-	2100	FD
7	2100 X 2325	-	2325	DW1
8	1600 X 2325	-	2325	DW2
9	1500 X 2325	1050	2325	DW3
10	1250 X 2325	1050	2325	W1
11	600 X 1275	1050	2325	W2
12	1250 X 1275	1050	B.O.R.	W3
14	2100 X 1275	1050	2325	W4
TOTAL		263.87		

UPPER PENTHOUSE FLOOR AREA =  
ADDITION AREA -DEDUCTION AREA  
573.522-281.827 = 291.705 SQ.MT

SR. NO.	SIZE	SILL	LINTEL	TYPE
A	2,700 X 2,055 X 2	2,055	2,700	
B	1,800 X 2,055 X 1	2,055	1,800	
C	1,070 X 4,775 X 2	4,775	1,070	
D	5,800 X 2,055 X 2	2,055	5,800	
E	1,750 X 3,955 X 2	3,955	1,750	
F	2,200 X 3,955 X 2	3,955	2,200	
G	1,950 X 3,725 X 2	3,725	1,950	
H	2,500 X 1,055 X 2	1,055	2,500	
I	2,450 X 2,615 X 2	2,615	2,450	
J	2,000 X 2,375 X 2	2,375	2,000	
K	1,800 X 2,375 X 2	2,375	1,800	
L	2,000 X 3,855 X 2	3,855	2,000	
M	4,675 X 2,055 X 1	2,055	4,675	
N	0,720 X 2,285 X 1	2,285	0,720	
O	2,700 X 1,150 X 1	1,150	2,700	
P	2,400 X 2,785 X 1	2,785	2,400	
Q	3,000 X 1,300 X 2	1,300	3,000	
R	1,750 X 1,250 X 1	1,250	1,750	
S	1,200 X 1,850 X 2	1,850	1,200	
T	1,250 X 1,250 X 1	1,250	1,250	
U	2,000 X 4,250 X 2	4,250	2,000	
V	1,020 X 1,850 X 1	1,850	1,020	
W	1,020 X 1,720 X 1	1,720	1,020	
X	1,300 X 1,250 X 1	1,250	1,300	
Y	1,020 X 1,720 X 1	1,720	1,020	
Z	1,250 X 1,250 X 1	1,250	1,250	
TOTAL		291.705		

UPPER PENTHOUSE FLOOR AREA =  
ADDITION AREA-DEDUCTION AREA  
573.522-281.827 = 291.705 SQ.MT

TERRACE AREA

ADDITION

SR. NO.	SIZE	SILL	LINTEL	TYPE
A	2,950 X 4,775 X 1	4,775	2,950	
B	1,400 X 1,150 X 1	1,150	1,400	
C	2,400 X 2,375 X 1	2,375	2,400	
D	2,700 X 2,375 X 1	2,375	2,700	
TOTAL		28.554		

TERRACE AREA = 28.554 SQ.MT

**NOTES**

1. DIMENSIONS ARE NOT TO BE SCALED.
2. ALL DIMENSIONS ARE IN MM.
3. ALL ELECTRICAL INSTALLATIONS SHALL BE AS PER PROVISIONS OF NBC.
4. FIRE FIGHTING SAFETY PROVISIONS WILL BE AS PER RELEVANT NBC PROVISIONS.
5. BOUNDARY WALL AND GATE AS PER STANDARDS.
6. ALL WALLS ARE 230/115 MM THK. BRICK WALL.
7. RAIN WATER HARVESTING SYSTEM SHALL BE PROVIDED AS PER CENTRAL GROUND WATER AUTHORITY NORMS/HARYANA GOVT.
8. ALL WINDOWS & VENTILATORS ARE OPENABLE.
9. ALL MECHANICALLY VENTILATED & ARTIFICIALLY LIT TOILET

PROVIDED WITH 24hr POWER BACKUP.

D.T.A (MD)  
Member Secretary  
B.P.A.C  
S.T.R. (O)  
Chairman  
B.P.A.CDEVELOPED BY:  
A.D.  
J.D.  
S.D.  
P.A.  
A.P.PROJECT:  
Eddy  
Sushma Prakash  
Signature

PROPOSED BUILDING PLAN OF GROUP HOUSING COLONY AREA MEASURING 11.125 ACRES (LICENSE NO. 87 OF 2013 DATED 11-10-2013 IN SECTOR-89-A, GURGAON MANESAR URBAN COMPLEX BEING DEVELOPED BY DALE DEVELOPERS PVT. LTD. AND OTHERS IN COLLABORATION WITH VATIKA LTD.

DRAWING TITLE :  
TOWER-1 & 5,TYPE-BC , FLOOR PLAN &  
AREA DIAGRAM  
+63300 TO +80600 MM LVLDEALT BY SCALE 1:100 @ A0 DRG. NO.  
CHECKED BY DATE B-1.2

THROUGH: AUTHORISED SIGNATORY

For VATIKA LIMITED  
Authorized Signatory  
MANOHAR KUMAR GUPTA  
C/2025/5554C



OWNER'S SIGN ARCHITECT'S SIGN

D.T.P.(Hd)  
Member Secretary  
BPAC

S.T.P.(G)  
Member  
BPAC

C.T.P.(H)  
Chairman  
BPAC

ASR  
AD SD PA AP

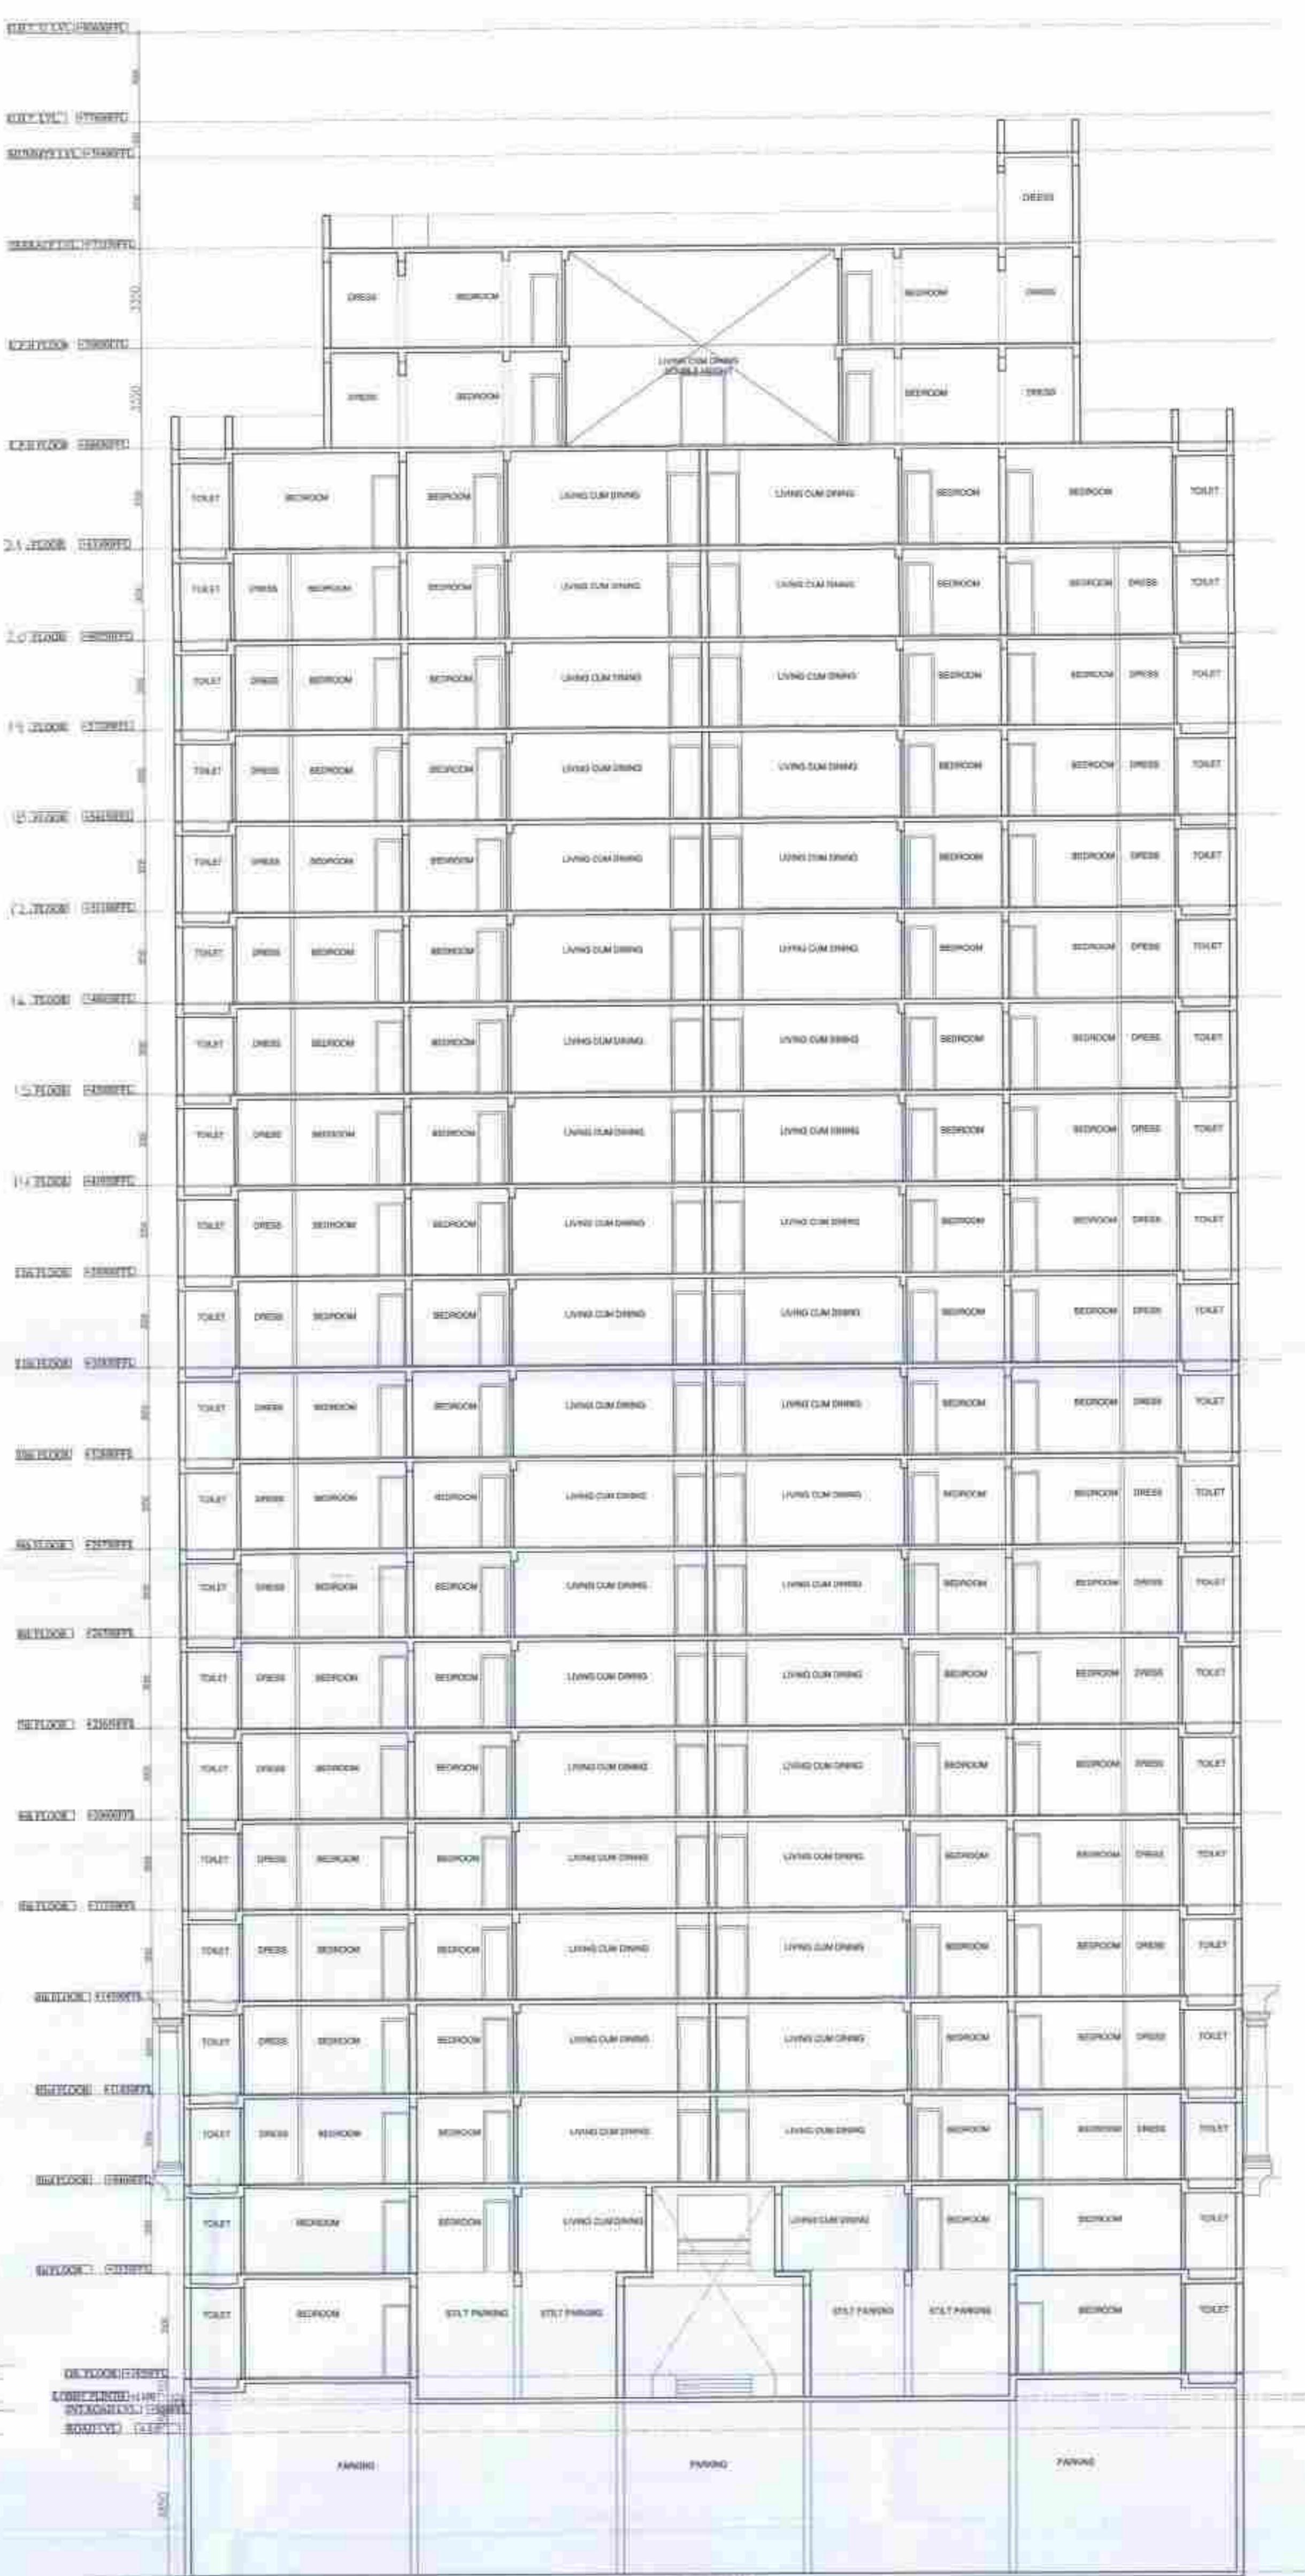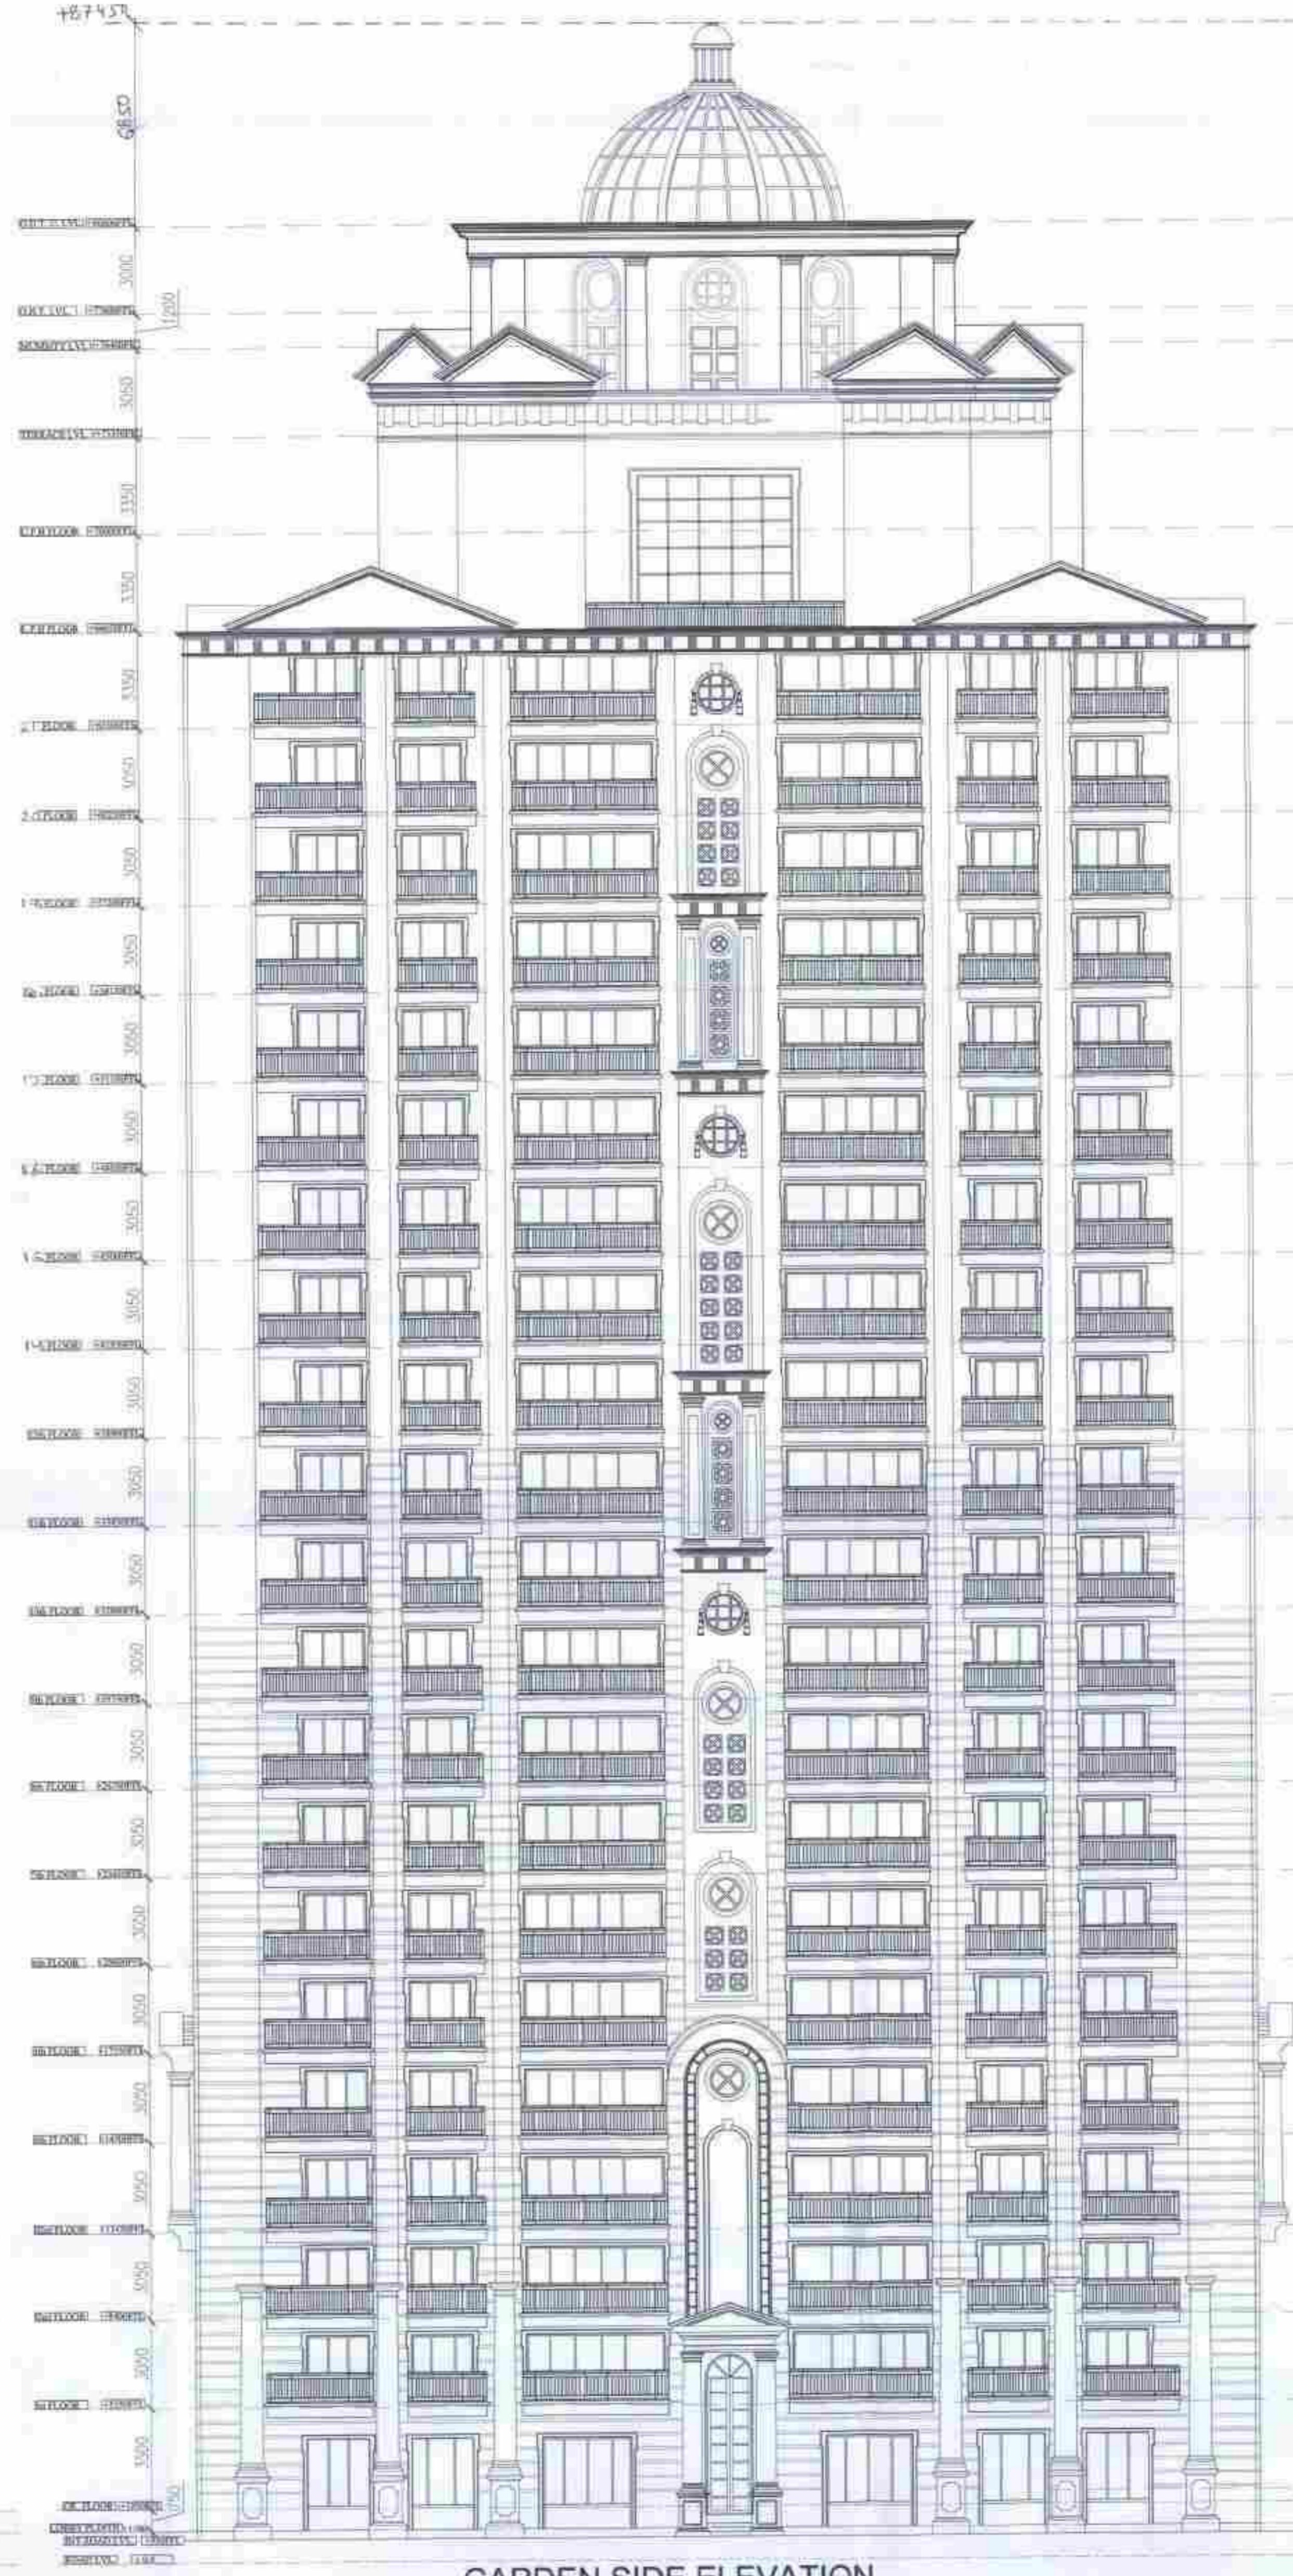

## NOTES

1. DIMENSIONS ARE NOT TO BE SCALED.
2. ALL DIMENSIONS ARE IN MM .
3. ALL ELECTRICAL INSTALLATIONS SHALL BE AS PER PROVISIONS OF NBC.
4. FIRE FIGHTING SAFETY PROVISIONS WILL BE AS PER RELEVANT NBC PROVISIONS.
5. BOUNDARY WALL AND GATE AS PER STANDARDS.
6. ALL WALLS ARE 230/115 MM THK. BRICK WALL.
7. RAIN WATER HARVESTING SYSTEM SHALL BE PROVIDED AS PER CENTRAL GROUND WATER AUTHORITY NORMS/HARYANA GOVT.
8. ALL WINDOWS & VENTILATORS ARE OPENABLE.
9. ALL MECHANICALLY VENTILATED & ARTIFICIALLY LIT TOILET PROVIDED WITH 24hr POWER BACKUP.

DEVELOPED BY:

PROJECT:

PROPOSED BUILDING PLAN OF GROUP HOUSING COLONY AREA MEASURING 11.125 ACRES (LICENSE NO. 87 OF 2013 DATED 11-10-2013 IN SECTOR-89-A, GURGAON MANESAR URBAN COMPLEX BEING DEVELOPED BY DALE DEVELOPERS PVT. LTD. AND OTHERS IN COLLABORATION WITH VATIKA LTD.

DRAWING TITLE :  
TOWER -1 & 5 TYPE -BC ,  
ELEVATION & SECTION

DEALT BY	SCALE	1:150 @ A0	DRG. NO.
CHECKED BY	DATE		B-1.3

THROUGH: AUTHORISED SIGNATORY

For VATIKA LIMITED  
Amrit Kumar Gupta  
CA/2005/3554C

OWNER'S SIGN ARCHITECT'S SIGN.

S.R. NO.	SIZE	FALL	UNTEL	TYPE
1	900 X 2100	-	2100	D1
2	800 X 2100	-	2100	D2
3	750 X 2100	-	2100	D3
4	1050 X 2400	-	2400	D4
5	900 X 2100	-	2100	D5
6	1050 X 2100	-	2100	FD1
7	2100 X 2325	-	2325	DW1
8	1600 X 2325	-	2325	DW2
9	1500 X 2325 (1050)	-	2325	DW3
10	750 X 1275 (1050)	-	2325	W1
11	600 X 1275 (1050)	-	2325	W2
12	1250 X 1275 (1050)	B.O.B.	2325	W3
14	2100 X 1275 (1050)	-	2325	W4

FLOOR LIST	
① GROUND FLOOR	
② 1ST FLOOR	
③ 2ND FLOOR	
④ 3RD FLOOR	
⑤ 4TH FLOOR	
⑥ 5TH FLOOR	
⑦ 6TH FLOOR	
⑧ 7TH FLOOR	
⑨ 8TH FLOOR	
⑩ 9TH FLOOR	
⑪ 10TH FLOOR	
⑫ 11TH FLOOR	
⑬ 12TH FLOOR	
⑭ 13TH FLOOR	
⑮ 14TH FLOOR	
⑯ 15TH FLOOR	
⑰ 16TH FLOOR	
⑱ 17TH FLOOR	
⑲ 18TH FLOOR	
⑳ 19TH FLOOR	
⑳ R.H. FLOOR	
⑳ TERRACE	

IMPORTANT NOTES:

1. DRAUGHTS ARE NOT TO BE SCALLED.  
2. ALL DIMENSIONS ARE IN MM.  
3. ALL ELECTRICAL INSTALLATIONS SHALL BE AS PER PROVISIONS OF NBC.  
4. FIRE FIGHTING SAFETY PROVISIONS WILL BE AS PER RELEVANT NBC PROVISIONS.  
5. BOUNDARY WALL AND GATE AS PER STANDARDS.  
6. ALL WALLS ARE 230/115 MM THK. BRICK WALL.  
7. RAIN WATER HARVESTING SYSTEM SHALL BE PROVIDED AS PER CENTRAL GROUND WATER AUTHORITY NORMS/HARYANA GOVT.  
8. ALL WINDOWS & VENTILATORS ARE OPENABLE.  
9. ALL MECHANICALLY VENTILATED & ARTIFICIALLY LIT TOILET  
PROVIDED WITH 24hr POWER BACKUP.

PLUMBING NOTES:

1. WASH BASIN TO SOFT TRAP (PT) 40 MM PVC PIPE.  
2. KITCHEN BASIN TO FLOOR TRAP (PT) PVC PIPE.  
3. FLUSHING CISTERN TO SOFT TRAP (PT) PVC PIPE.  
4. TOILET CISTERN TO SOFT TRAP (PT) PVC PIPE.  
5. 110 MM PVC PIPE USED FOR SOL. & WASTE.  
6. 110 MM PVC PIPE USED FOR TERRACE RAIN WATER.  
7. 60 MM PVC PIPE USED FOR BALCONY.

SCHEDULE OF PIPES:

Pipe No. Description

(1) 110 MM PVC SOIL & WASTE PIPE

(2) 110 MM PVC SANITARY PIPE

(3) 110 MM PVC RAIN WATER PIPE

(4) 60 MM PVC BALCONY RAIN WATER PIPE

(5) DOMESTIC WATER SUPPLY/DIN TUBE PIPE

(6) FLUSHING WATER SUPPLY/DIN TUBE PIPE

(7) SANITARY WATER SUPPLY PIPE

(8) DOMESTIC WATER SUPPLY/DIN TUBE PIPE

(9) 110 MM PVC RAIN WATER PIPE

(10) 110 MM PVC RAIN WATER PIPE

(11) 110 MM PVC RAIN WATER PIPE

(12) 110 MM PVC RAIN WATER PIPE

(13) 110 MM PVC RAIN WATER PIPE

(14) 110 MM PVC RAIN WATER PIPE

(15) 110 MM PVC RAIN WATER PIPE

(16) 110 MM PVC RAIN WATER PIPE

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(103) 110 MM PVC RAIN WATER PIPE

(104) 110 MM PVC RAIN WATER PIPE

(105) 110 MM PVC RAIN WATER PIPE

(106) 110 MM PVC RAIN WATER PIPE

(107) 110 MM PVC RAIN WATER PIPE

(108) 110 MM PVC RAIN WATER PIPE

(109) 110 MM PVC RAIN WATER PIPE

(110) 110 MM PVC RAIN WATER PIPE

(111) 110 MM PVC RAIN WATER PIPE

(112) 110 MM PVC RAIN WATER PIPE

(113) 110 MM PVC RAIN WATER PIPE


(114) 110 MM PVC RAIN WATER PIPE

(115) 110 MM PVC RAIN WATER PIPE

SR. NO	SIZE	SILL	LINTEL	TYPE
1	900 X 2100	-	2100	D1
2	800 X 2100	-	2100	D2
3	750 X 2100	-	2100	D3
4	1050 X 2400	-	2400	D4
5	900 X 2100	-	2100	D5
6	1050 X 2100	-	2100	F0
7	2100 X 2325	-	2325	DW1
8	1200 X 2325	-	2325	DW2
9	1500 X 2325	1050	2325	DW3
10	750 X 1275	1050	1275	W1
11	600 X 1275	1050	1275	W2
12	1250 X 1275	1050	8.0.B	W3
14	2100 X 1275	1050	2325	W4

D.TIP. (HG)  
MANU. SIGNATURE  
C.P. P.M.  
B.P.A.C.

J.D. SD PA K.P.

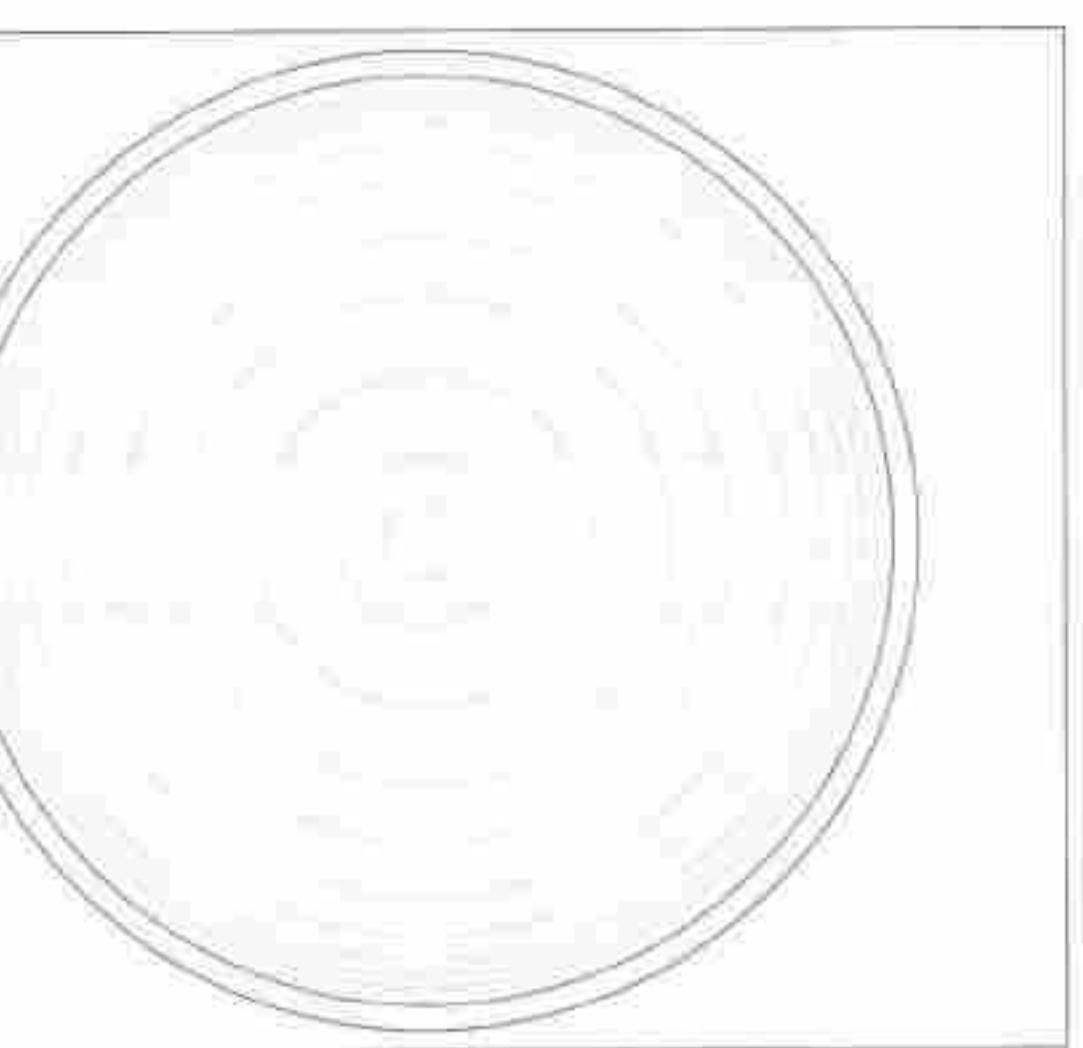

TOP PLAN Tower-2&4  
LVL +64.500

UPPER PENTHOUSE FLOOR AREA =  
ADDITION AREA - (1+1) =  
25.500 X 22.705 = 573.52 SQ.MT

ADDITION AREA = 573.522 SQ.MT

DEDUCTION DETAIL

A 7.29 X 7.515 X 2 22.096  
B 8.660 X 9.565 X 1 5.776  
C 1.079 X 4.775 X 2 10.219  
D 4.980 X 3.945 X 2 5.404  
E 1.079 X 3.150 X 2 1.809  
F 1.079 X 3.150 X 2 1.809  
G 1.150 X 9.595 X 2 2.760  
H 2.500 X 1.025 X 2 5.197  
I 1.240 X 2.815 X 2 3.593  
J 1.240 X 2.815 X 2 3.593  
K 1.000 X 8.855 X 1 34.860  
L 1.000 X 8.855 X 1 34.860  
M 4.975 X 2.855 X 2 5.218  
N 0.720 X 3.790 X 1 2.029  
O 0.720 X 3.790 X 1 2.029  
P 2.400 X 7.790 X 1 18.672  
S 3.000 X 3.900 X 1 11.400  
T 1.150 X 3.150 X 1 1.809  
U 1.240 X 3.150 X 1 1.809  
V 1.240 X 3.150 X 1 1.809  
W 1.000 X 3.855 X 1 3.872  
Y 1.200 X 3.720 X 1 2.064

TOTAL 263.83

UPPER PENTHOUSE FLOOR AREA =  
ADDITION AREA - DEDUCTION AREA  
573.522 - 263.83 = 269.705 SQ.MT

TERRACE AREA

ADDITION

A 3.950 X 4.775 X 1 14.096  
B 2.500 X 1.025 X 1 2.500  
C 4.775 X 1.025 X 1 5.171  
D 2.720 X 2.330 X 1 6.314

TOTAL 26.554

TERRACE AREA = 26.554 SQ.MT

NOTES

1. DIMENSIONS ARE NOT TO BE SCALED.
2. ALL DIMENSIONS ARE IN MM .
3. ALL ELECTRICAL INSTALLATIONS SHALL BE AS PER PROVISIONS OF NBC.
4. FIRE FIGHTING SAFETY PROVISIONS WILL BE AS PER RELEVANT NBC PROVISIONS.
5. BOUNDARY WALL AND GATE AS PER STANDARDS.
6. ALL WALLS ARE 230/115 MM THK. BRICK WALL.
7. RAIN WATER HARVESTING SYSTEM SHALL BE PROVIDED AS PER CENTRAL GROUND WATER AUTHORITY NORMS/HARYANA GOVT.
8. ALL DOORS & VENTILATORS ARE OPENABLE.
9. ALL MECHANICALLY VENTILATED & ARTIFICIALLY LIT TOILET PROVIDED WITH 24hr POWER BACKUP.

DEVELOPED BY:

PROJECT:

PROPOSED BUILDING PLAN OF GROUP HOUSING COLONY AREA MEASURING 11.125 ACRES (LICENSE NO. 87 OF 2013 DATED 11-10-2013 IN SECTOR-89-A, GURGAON MANESAR URBAN COMPLEX BEING DEVELOPED BY DALE DEVELOPERS PVT. LTD. AND OTHERS IN COLLABORATION WITH VATIKA LTD.

DRAWING TITLE :  
TOWER-2&4,TYPE-BC , FLOOR PLAN &  
AREA DIAGRAM  
+60250 TO +77650 MM LVL

DEALT BY SCALE 1:100 @ A0 DRG. NO.  
CHECKED BY DATE B-2.2




THROUGH: AUTHORISED SIGNATORY

For VATIKA LIMITED  
MANISHA GUPTA  
C.A./M.S./3054

OWNER'S SIGN

ARCHITECT'S SIGN

OPENING SCHEDULE OF DOORS &amp; WINDOWS

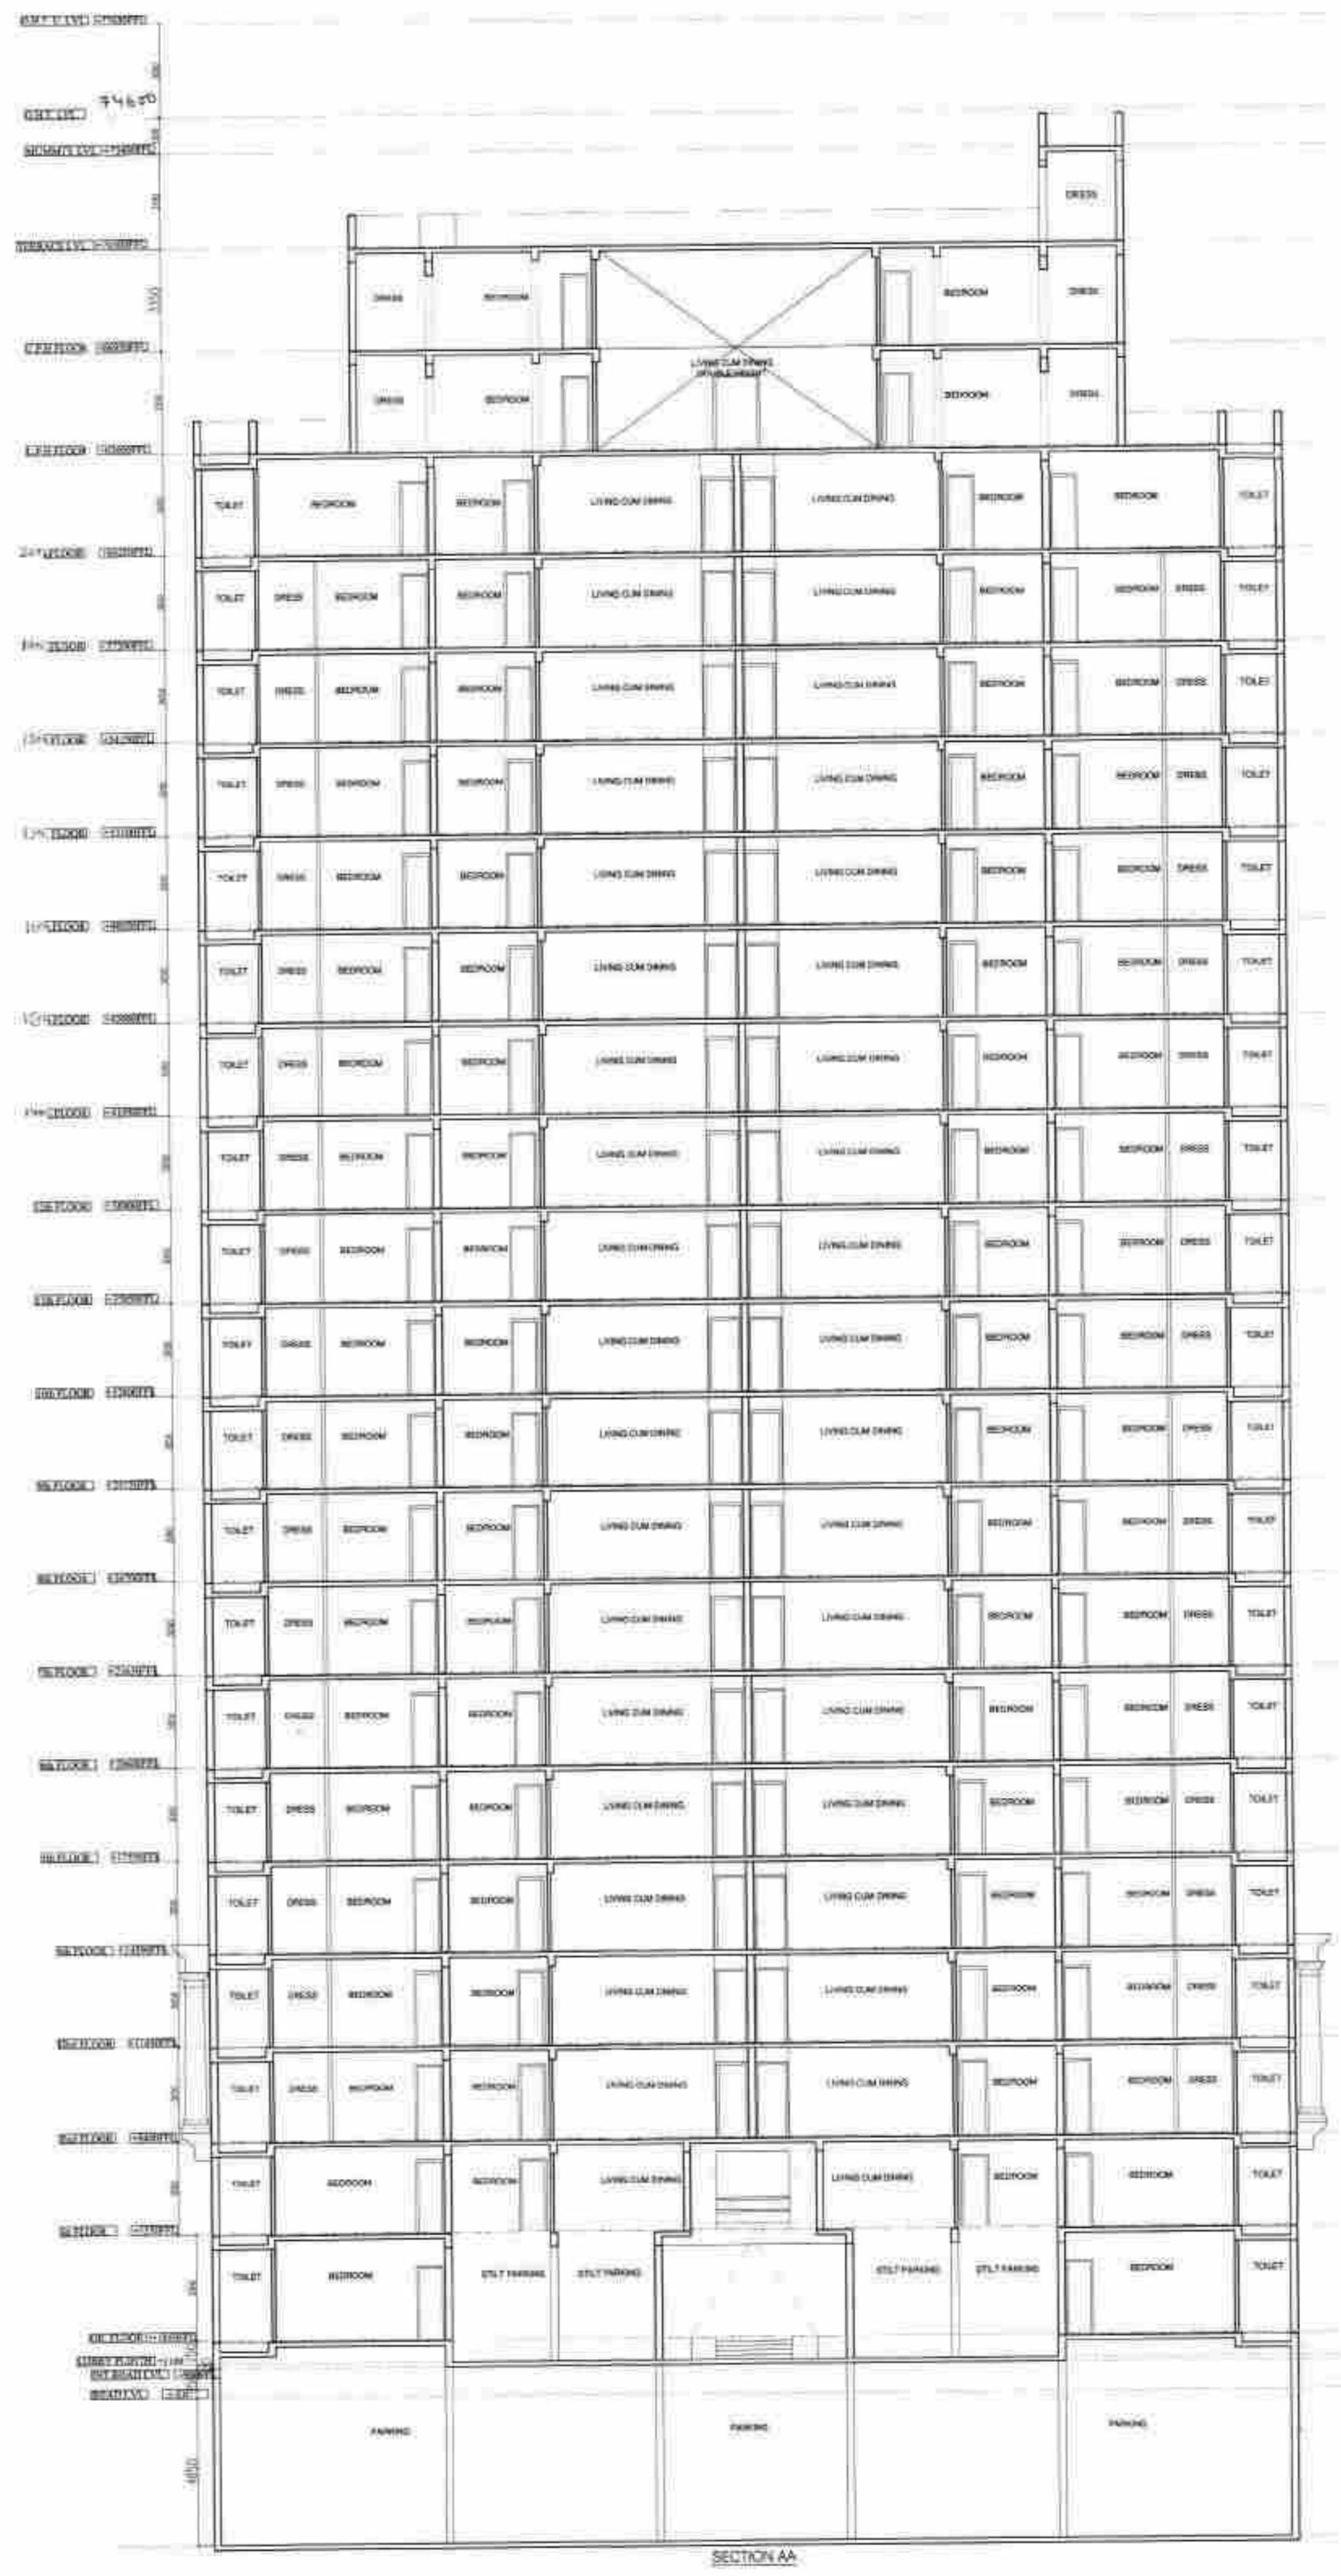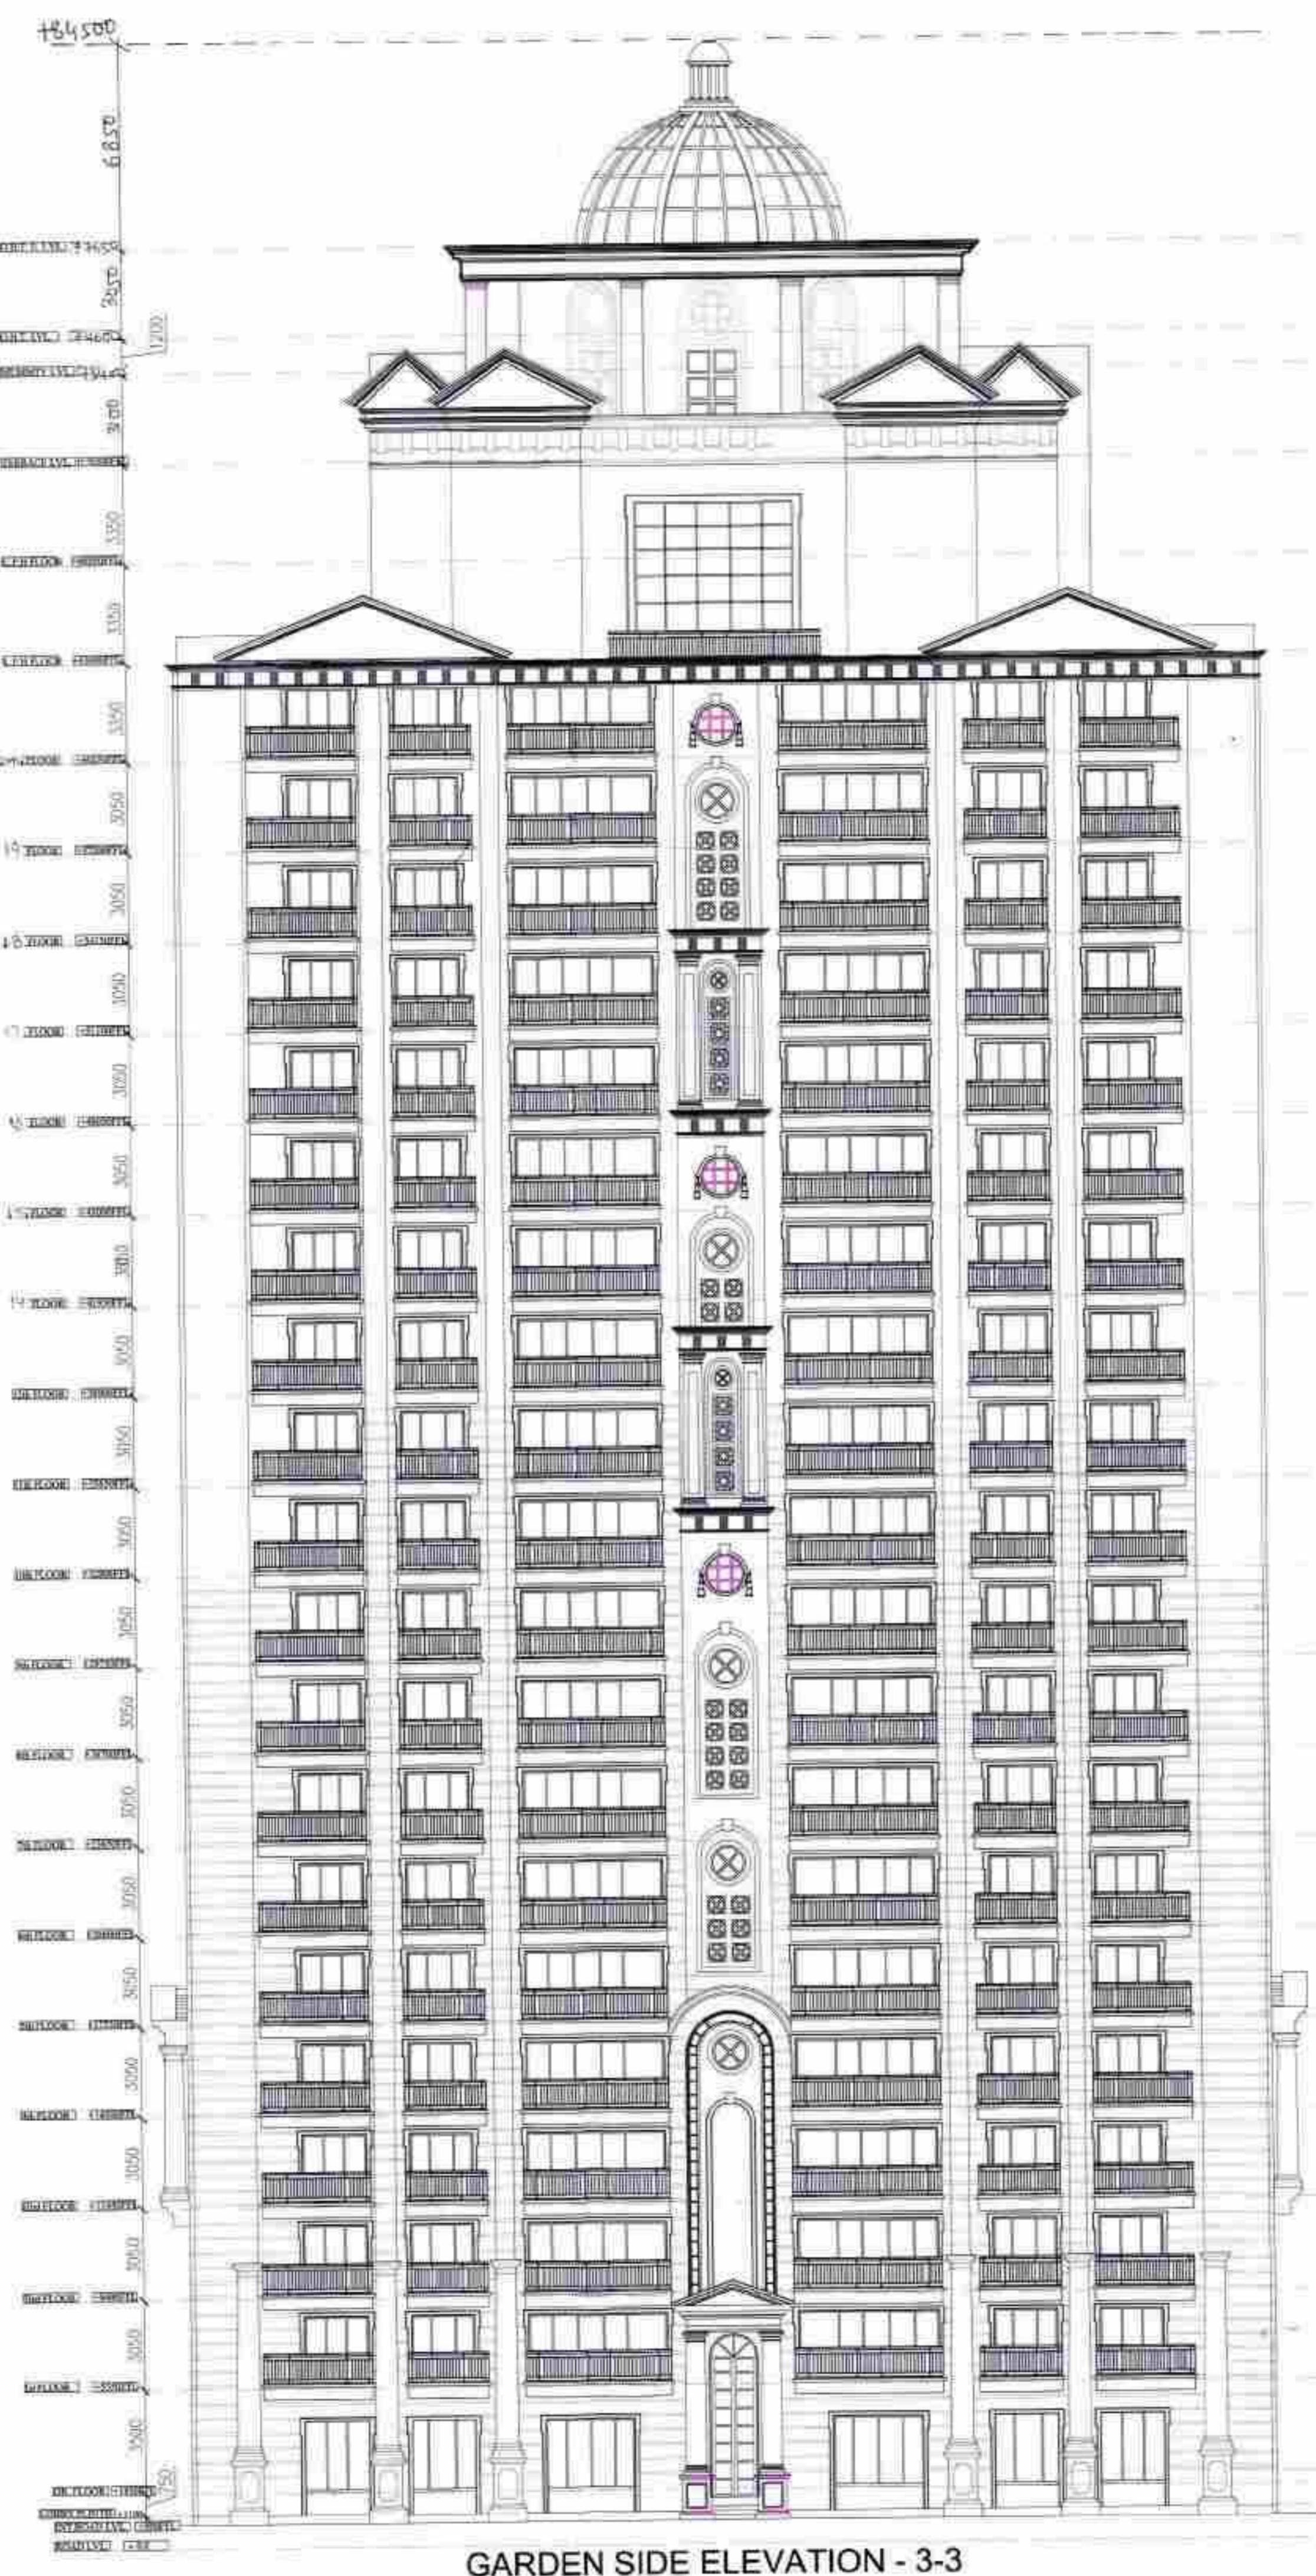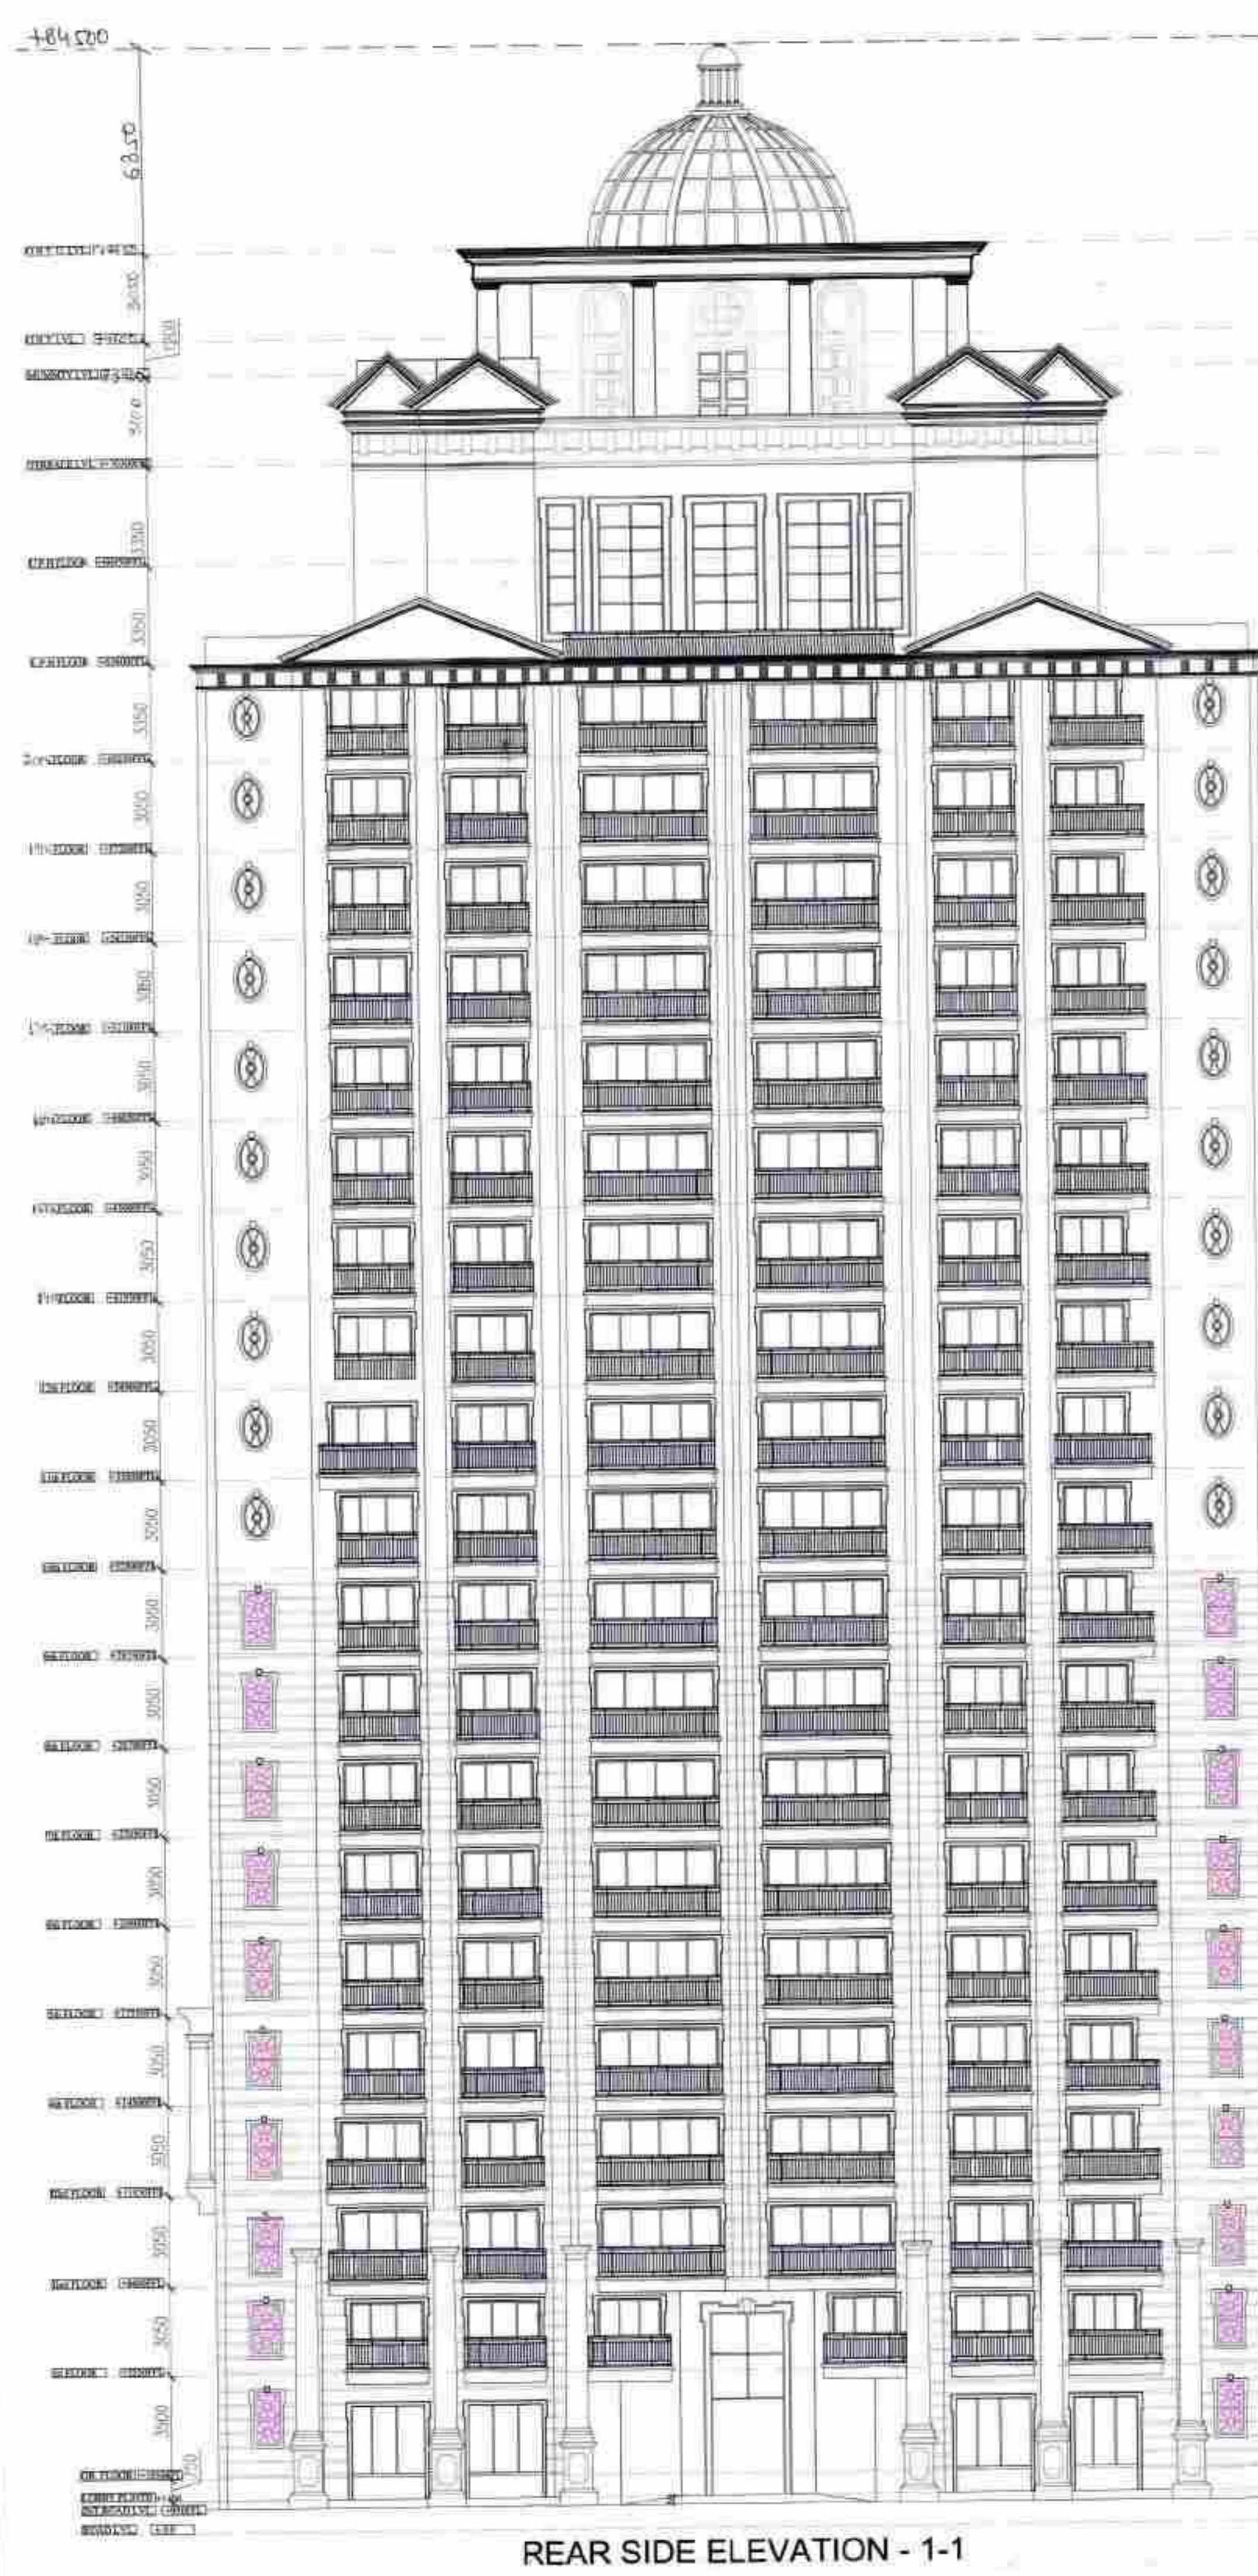

- NOTES**
1. DIMENSIONS ARE NOT TO BE SCALED.
  2. ALL DIMENSIONS ARE IN MM.
  3. ALL ELECTRICAL INSTALLATIONS SHALL BE AS PER PROVISIONS OF IEC.
  4. FIRE LIGHTING SAFETY PROVISIONS WILL BE AS PER RELEVANT NBC PROVISIONS.
  5. BOUNDARY WALL AND GATE AS PER STANDARDS.
  6. ALL WALLS ARE 230/15 MM THK. BRICK WALL.
  7. RAIN WATER HARVESTING SYSTEM SHALL BE PROVIDED AS PER CENTRAL GROUND WATER AUTHORITY NORMS/HARYANA GOVT.
  8. ALL WINDOWS & VENTILATORS ARE OPENABLE.
  9. ALL MECHANICALLY VENTILATED & ARTIFICIALLY LIT TOILET PROVIDED WITH 24hr POWER BACKUP.

DEVELOPED BY:  
AD JO BD PK AP

PROJECT:

PROPOSED BUILDING PLAN OF GROUP HOUSING COLONY AREA MEASURING 11.125 ACRES (LICENSE NO. 87 OF 2013 DATED 11-10-2013 IN SECTOR-89-A, GURGAON MANESAR URBAN COMPLEX BEING DEVELOPED BY DALE DEVELOPERS PVT. LTD. AND OTHERS IN COLLABORATION WITH VATIKA LTD.)

DRAWING TITLE :  
TOWER-2 & 4 TYPE -BC ,  
ELEVATION & SECTION

DEALT BY      SCALE 1:150 @ A0      DRG. NO.  
CHECKED BY      DATE      B-2.3

THROUGH: AUTHORISED SIGNATORY

For VATIKA LIMITED  
AUSTINIAN SIGNATURE  
MASTER KUMAR GUPTA  
CA/2005/3554

OWNER'S SIGN

ARCHITECT'S SIGN.

OPENING SCHEDULE OF DOORS & WINDOWS					
SR. NO	SIZE	SILL	LINTEL	TYPE	
1	900	X	-	2400	D1
2	800	X	-	2400	D2
3	1800	X	-	2400	D3
4	2500	X	900	2400	W1
5	3000	X	900	2400	W2
6	600	X	1200	2400	V
7	1200	X	1200	2400	V1
8	2750	X	-	2400	DW1
9	6970	X	-	2400	DW2
10	1950	X	-	2400	DW3
11	5270	X	-	2400	DW4

PLUMBING NOTES:-	
● FT	FLOOR TRAP (110x110) MM
● FD	FLOOR DRAIN (110x63) MM
OD	OUTER dia OF PIPE
OD	WASH BASIN
FT	— WALL
FT	— 40 OD UPVC WASTE PIPE
FT	— FD
	89 OD UPVC WASTE PIPE
SCHEDULE OF PIPES :-	
PIPE NO.	
DESCRIPTION	
1	110 OD UPVC SOIL & VENT PIPE
2	110 OD UPVC WASTE & VENT PIPE
3	100 OD UPVC TERRACE RAIN WATER PIPE
4	DOMESTIC WATER SUPPLY DN TAKE PIPE *
5	DOMESTIC WATER SUPPLY DN TAKE PIPE *
6	DOMESTIC WATER SUPPLY DN TAKE PIPE *
7	FLUSHING WATER SUPPLY DN TAKE PIPE *
8	SOW DOMESTIC WATER SUPPLY RISER *

(A)	1000 M.S. PVC DN TAKE PIPE				
(B)	1000 M.S. SPRINKLER FEEDER PIPE				
(C)	800 M.S. SPRINKLER DRAIN PIPE				
	FHC FREE HOSE CARRIET				
	FS FLOW SWITCH				
	PENCOAT SPRINKLER				
	SPRINKLER FEEDER LINE				
<u>IMPORTANT NOTES:</u>					
	300 x 3000's CUT OUT IN FHC.				
	1.) 1500' WET FEEDER.				
	2.) 800 DRAIN PIPE				

**NOTES**

I. DIMENSIONS ARE NOT TO BE SCALED.

2. DIMENSIONS ARE IN MM.

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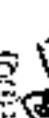
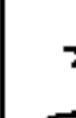
8. ALL WINDOWS & VENTILATORS ARE OPENABLE.

9. ALL MECHANICALLY VENTILATED & ARTIFICIALLY LT TOILET PROVIDED WITH 24hr POWER BACKUP.


DEVELOPED BY

PROJECT		PROPOSED BUILDING PLAN OF GROUP HOUSING COLONY AREA MEASURING 11.125 ACRES (LICENSE NO. 87 OF 2013 DATED 11-10-2013 IN SECTOR-89-A, GURGAON, MANESAR URBAN COMPLEX BEING DEVELOPED BY DALE DEVELOPERS PVT. LTD. AND OTHERS IN COLLABORATION WITH VATIKA LTD.			
CONVENTIONAL SHOPPING GROUND FLOOR AREA		SECTION BIMLAL		SECTION AREA	
		X	Y	Area	Area
1	1.110	X	3.410	1	12.425 SQM
2	14.670	X	8.710	1	127.776 SQM
3	1.730	X	6.920	1	36.234 SQM
4	3.065	X	6.925	1	20.578 SQM
					200.990 SQM

DRAWING TITLE: COMMUNITY BUILDING & CONVENIENT SHOPPING, PLAN & AREA DIAGRAM + 6000 MM LVL		DRG. NO. C-1.1
SCALE 1:100 @ A0	DATE	
CHECKED BY		
S.NO. FLOOR	1 LOWER GROUND FLOOR	
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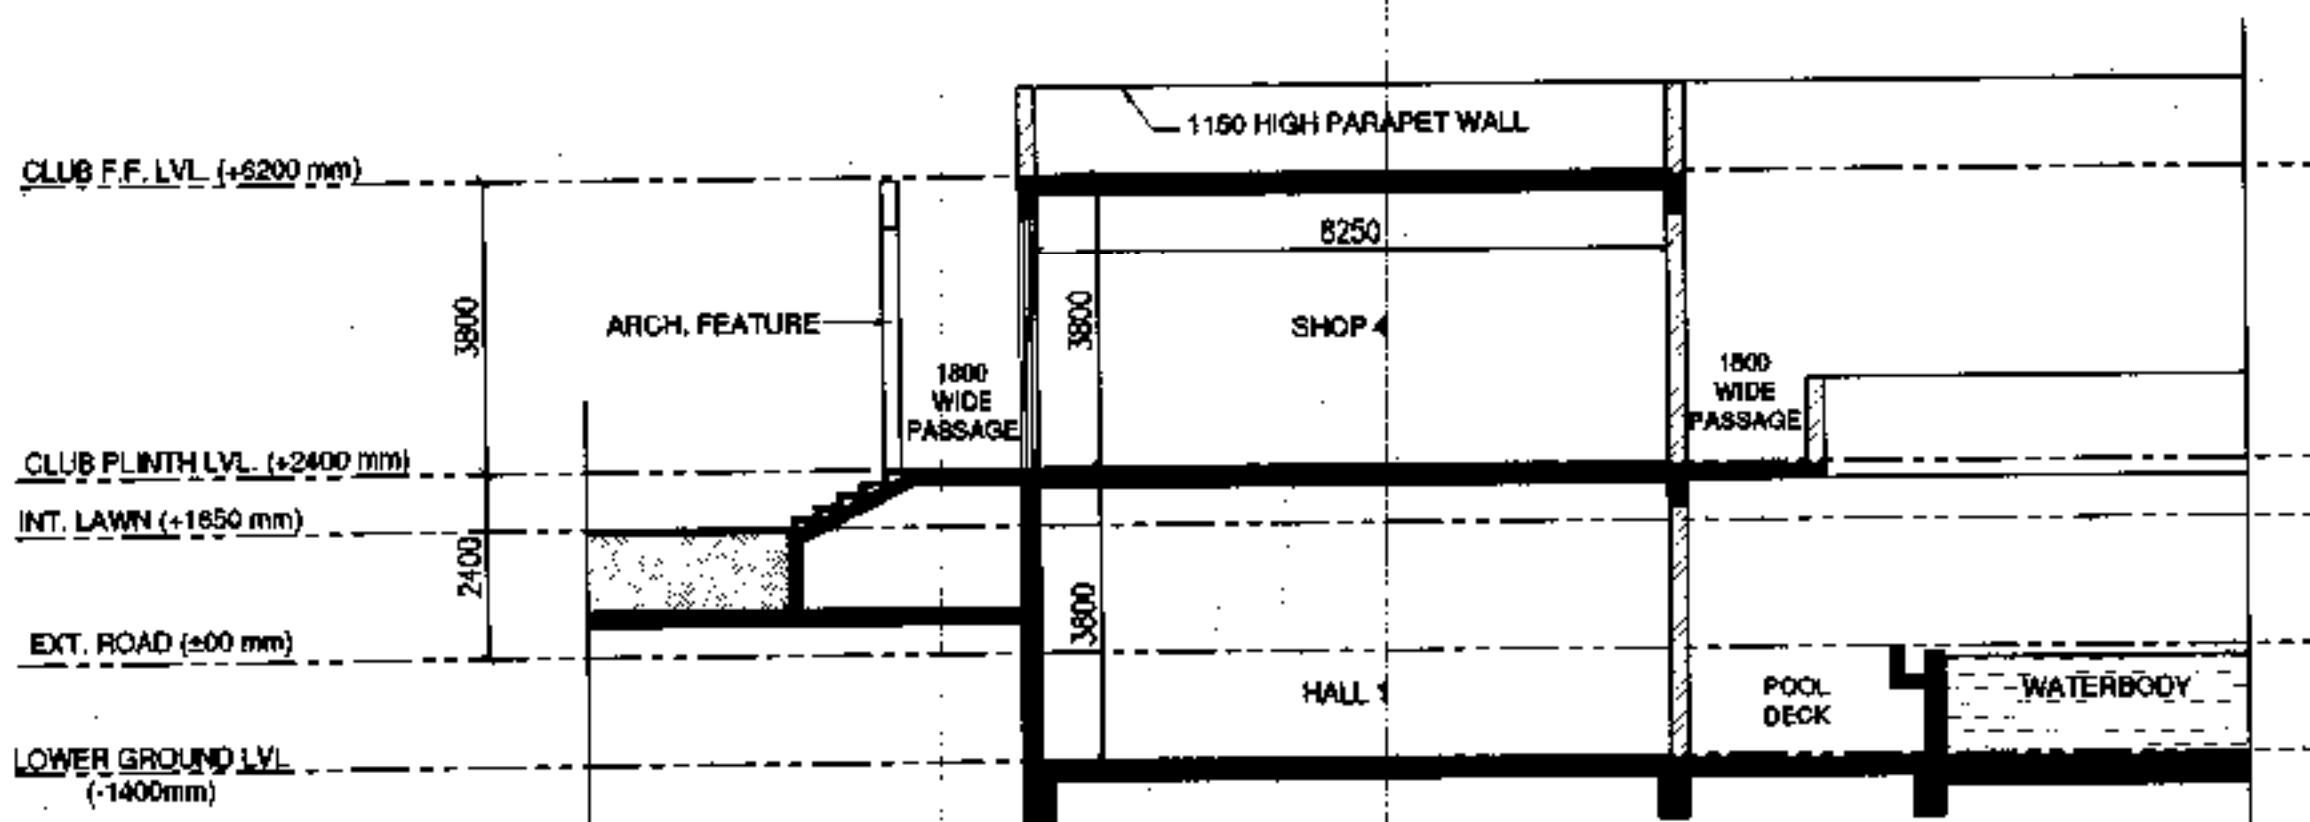
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<p style="text-align: right;">     <b>MANISH KUMAR GUPTA</b>  <b>CA/2005/385545</b> </p>	
<p style="text-align: center;"><b>PER UNITA LIMITED</b></p>	

**ARCHITECTS SIGN  
NEW CONVENTION**

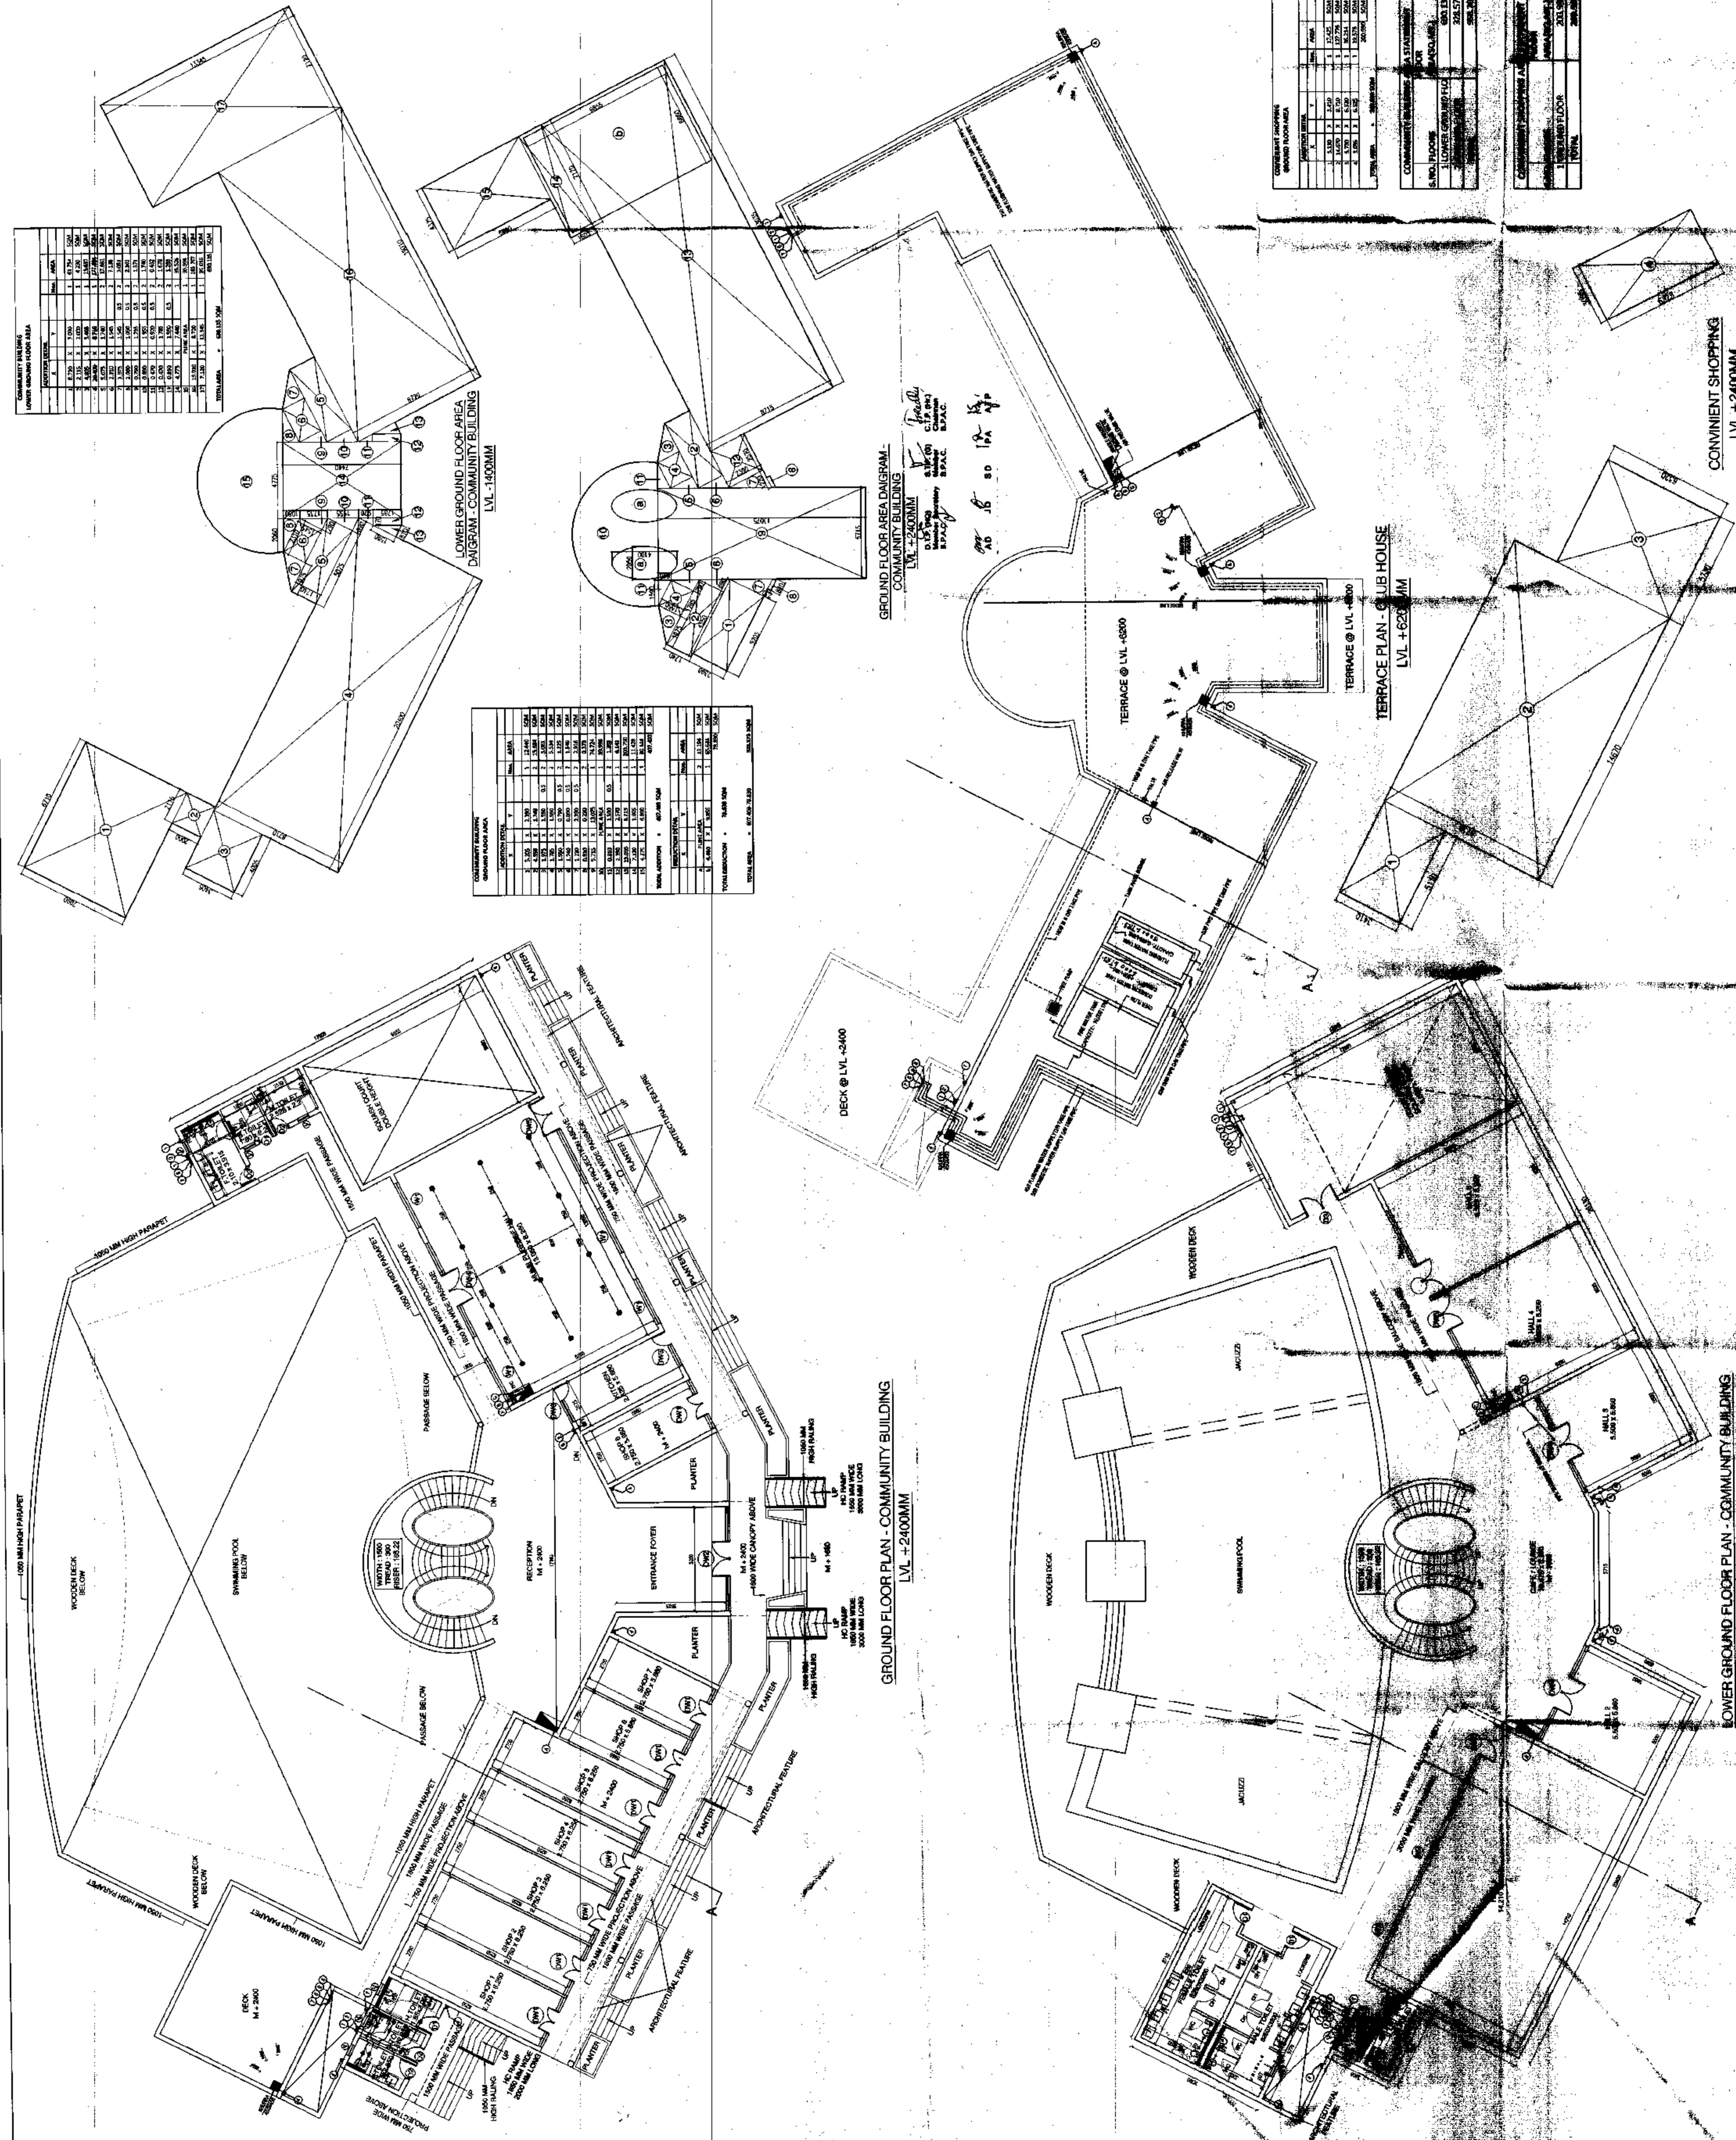


D.T.P. (HO) S.T.P. (HO)  
Member Secretary Member Chairman  
S.P.A.C. S.P.A.C.

AD JD SD MR NS  
A.Y.



SECTION AA

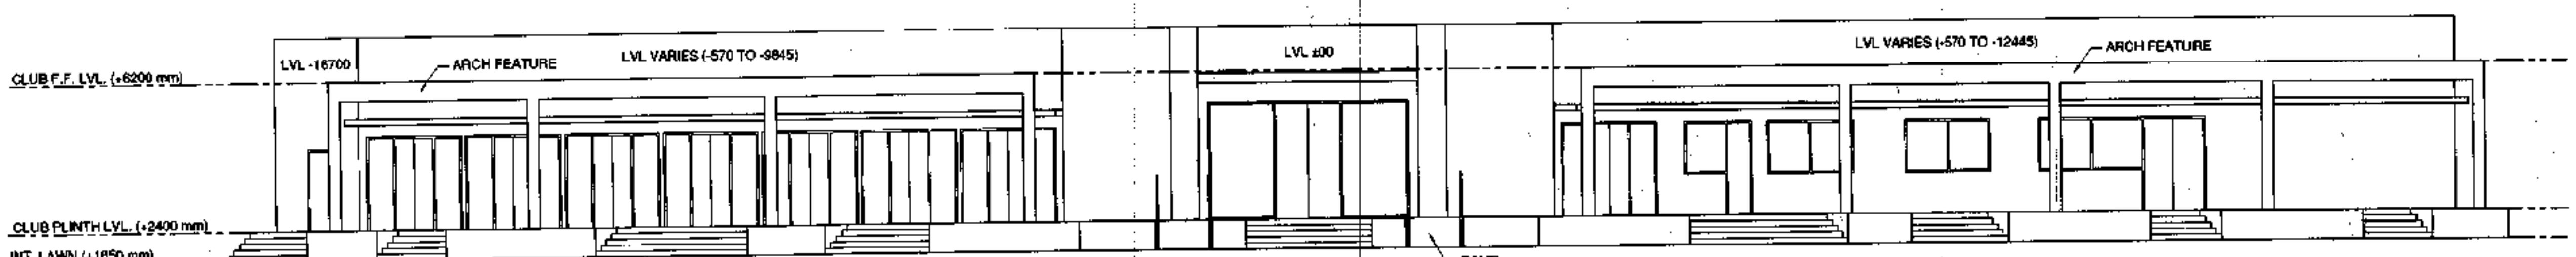

FRONT ELEVATION

- NOTES**
1. DIMENSIONS ARE NOT TO BE SCALED.
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  6. ALL WALLS ARE 230/115 MM THK. BRICK WALL.
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  8. ALL WINDOWS & VENTILATORS ARE OPENABLE.
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DEVELOPED BY:


PROJECT:

PROPOSED BUILDING PIAN OF GROUP HOUSING COUNTRY AREA MEASURING 11.25 ACRES (LICENSE NO. 97 OF 2013 DATED 21-10-2013 IN SECTOR-89-A, GURGAON MANESAR URBAN COMPLEX BEING DEVELOPED BY DALE DEVELOPERS PVT. LTD. AND DIVISION IN COLLABORATION WITH VATIKA LTD.


DRAWINGS TITLE: COMMUNITY BUILDING SECTION & ELEVATION		DRG. NO.
DEALT BY	SCALE 1:100 @ A1	C-1.2
CHEKED BY	DATE	

THROUGH : AUTHORISED SIGNATORY	
For VATIKA LIMITED  MANISH KUMAR GUPTA CA/2005/3554C	SIGNER'S SIGN ARCHITECT'S SIGN




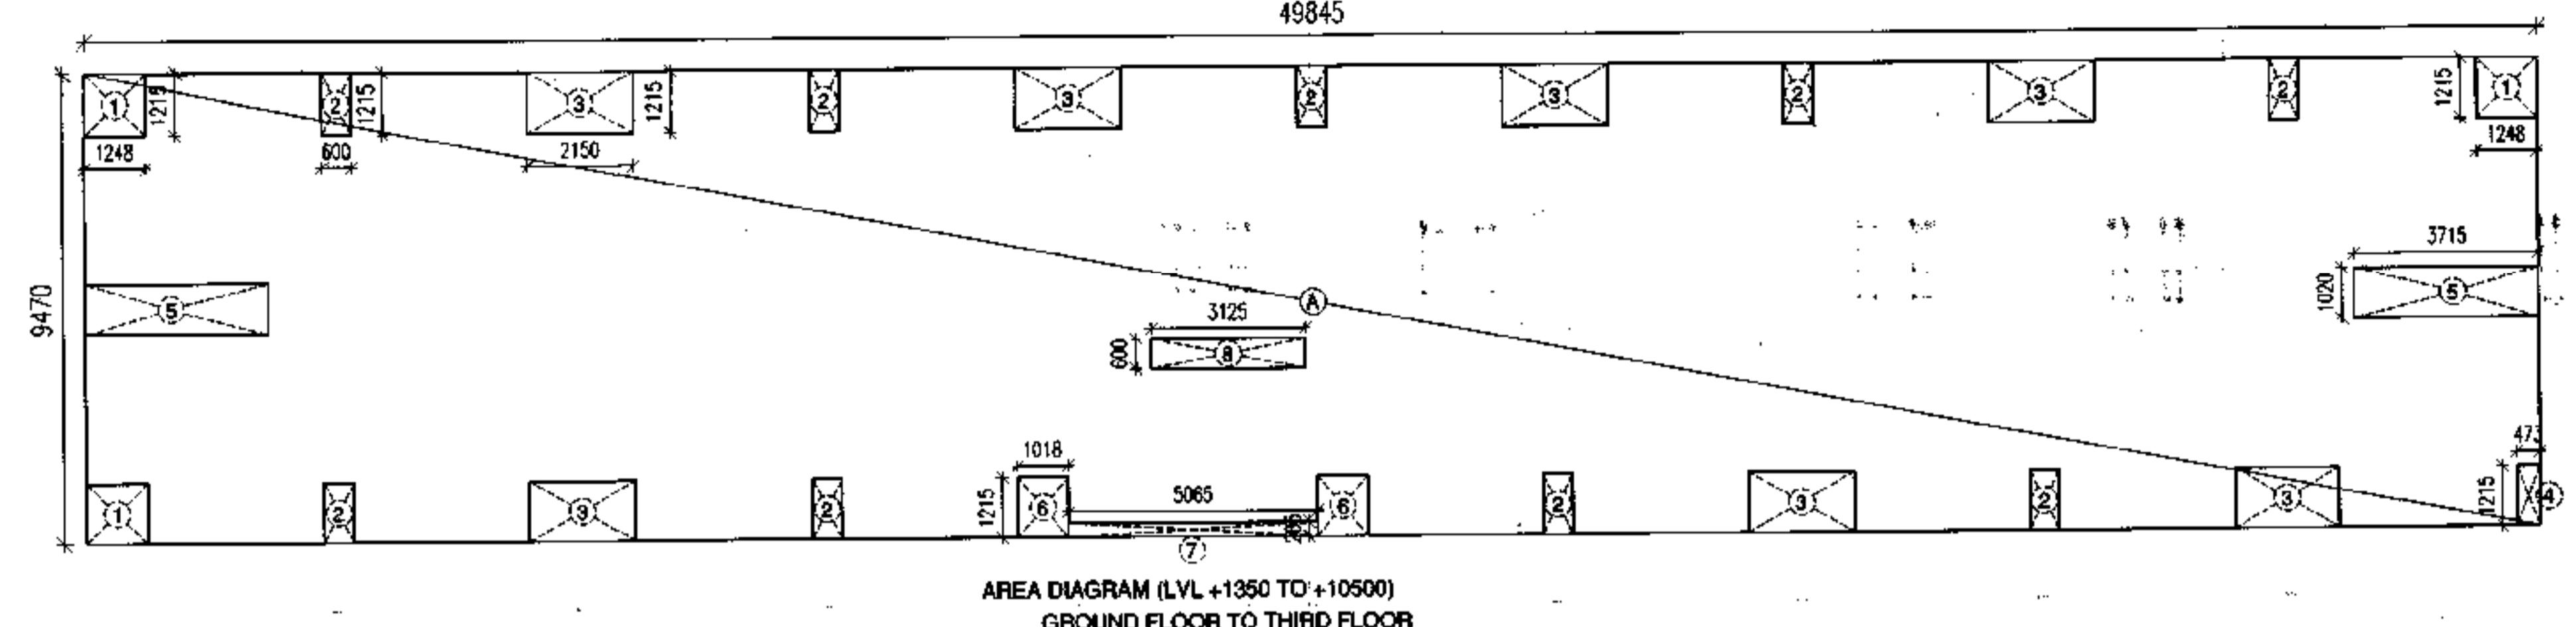

**AREA DIAGRAM (LVL +1350 TO +10500)  
GROUND FLOOR TO THIRD FLOOR**

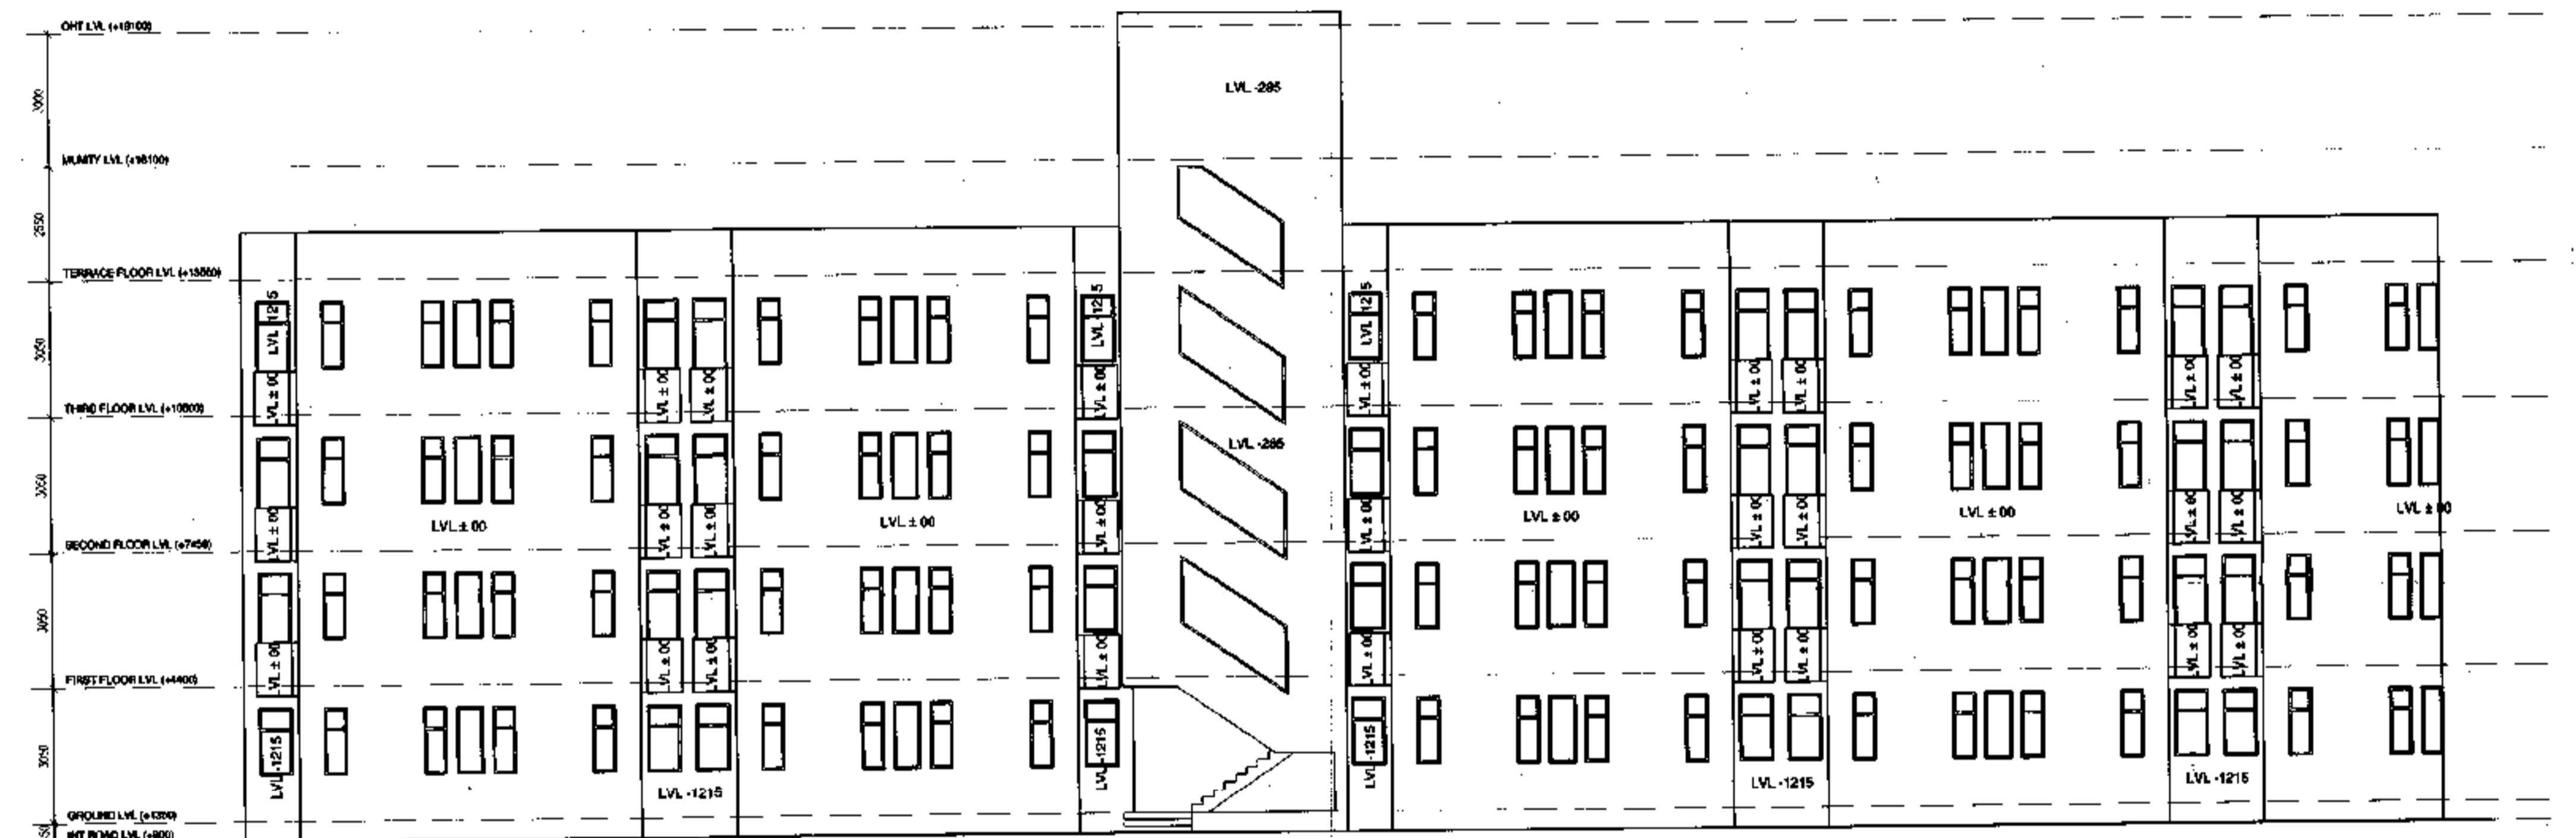

ELEVATION @ X

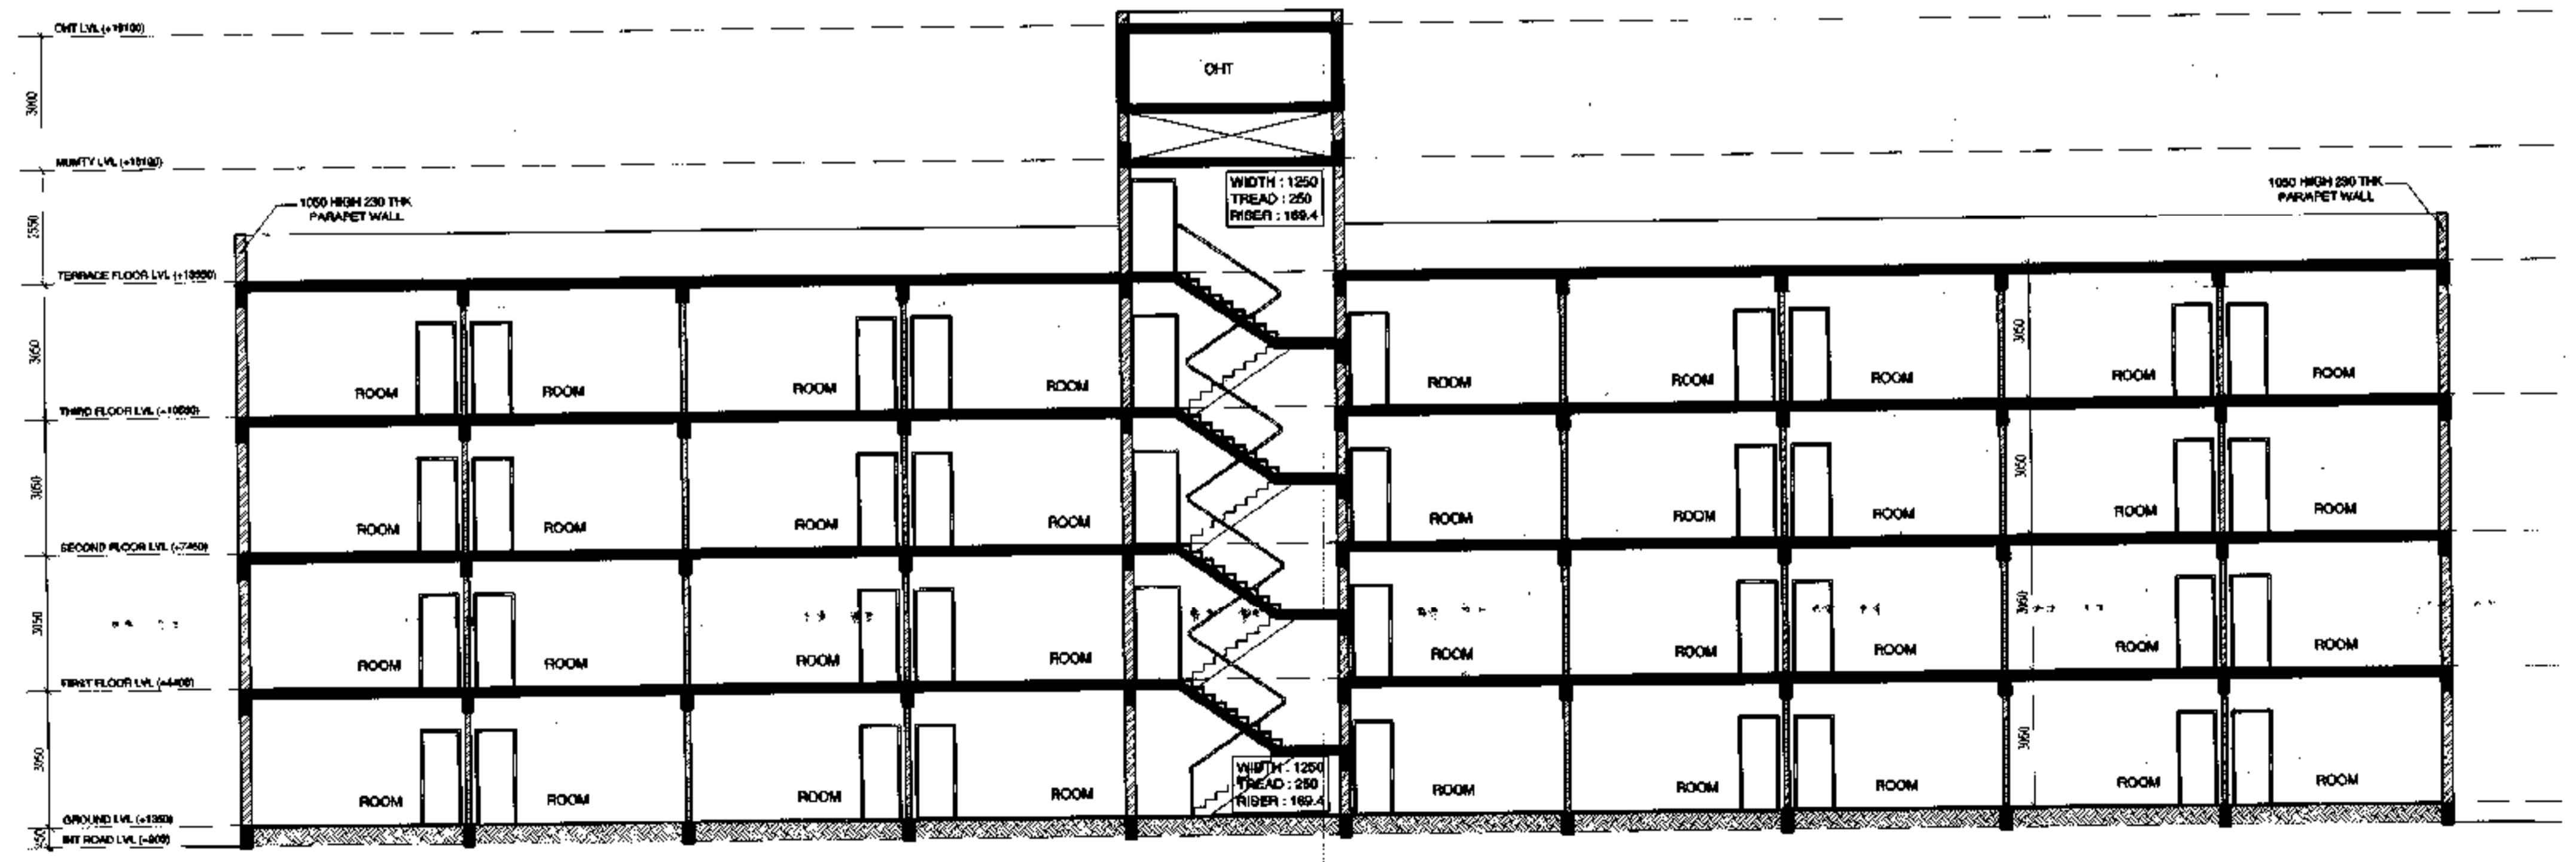

SECTION AT A

*J. S. P.*  
S.T.P. (G)  
Member  
S.P.A.C.  
*J. S. P.*  
S.T.P. (H)  
Chairman  
S.P.A.C.

AREA STATEMENT			
S.NO.	FLOORS	FLOOR AREA(SQ.MT.)	UNITS ON EACH FLOOR
1	GROUND FLOOR	428.69	19
2	1st FLOOR	428.69	19
3	2nd FLOOR	428.69	19
4	3rd FLOOR	428.69	19
	TOTAL	1714.76	76

#### **AREA STATEMENT**

## NOTES

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ALL WINDOWS & VENTILATORS ARE OPENABLE.  
ALL MECHANICALLY VENTILATED & ARTIFICIALLY LIT TOILET  
PROVIDED WITH 24hr POWER BACKUP.

DEVELOPED BY:

---

#### PROJECTS

**PROPOSED BUILDING PLAN OF GROUP HOUSING COLONY  
AREA MEASURING 11.125 ACRES (LICENSE NO. 87 OF 2013  
DATED 11-10-2013 IN SECTOR-89-A, GURGAON MANESAR  
URBAN COMPLEX BEING DEVELOPED BY DALE DEVELOPERS  
PVT. LTD. AND OTHERS IN COLLABORATION WITH VATIKA  
LTD.**

**DRAWING TITLE :**  
**E.W.S. - ELEVATION, SECTION & AREA  
DIAGRAM**



DEALT BY	SCALE 1:100 @ A1	DRG. NO. EWS-2
SURVEYOR BY	DATE	

2025 RELEASE UNDER E.O. 14176

MANISH KUMAR GUPTA  
CA/2005/36545

OWNER'S SIGN

ARCHITECT'S SIGN.

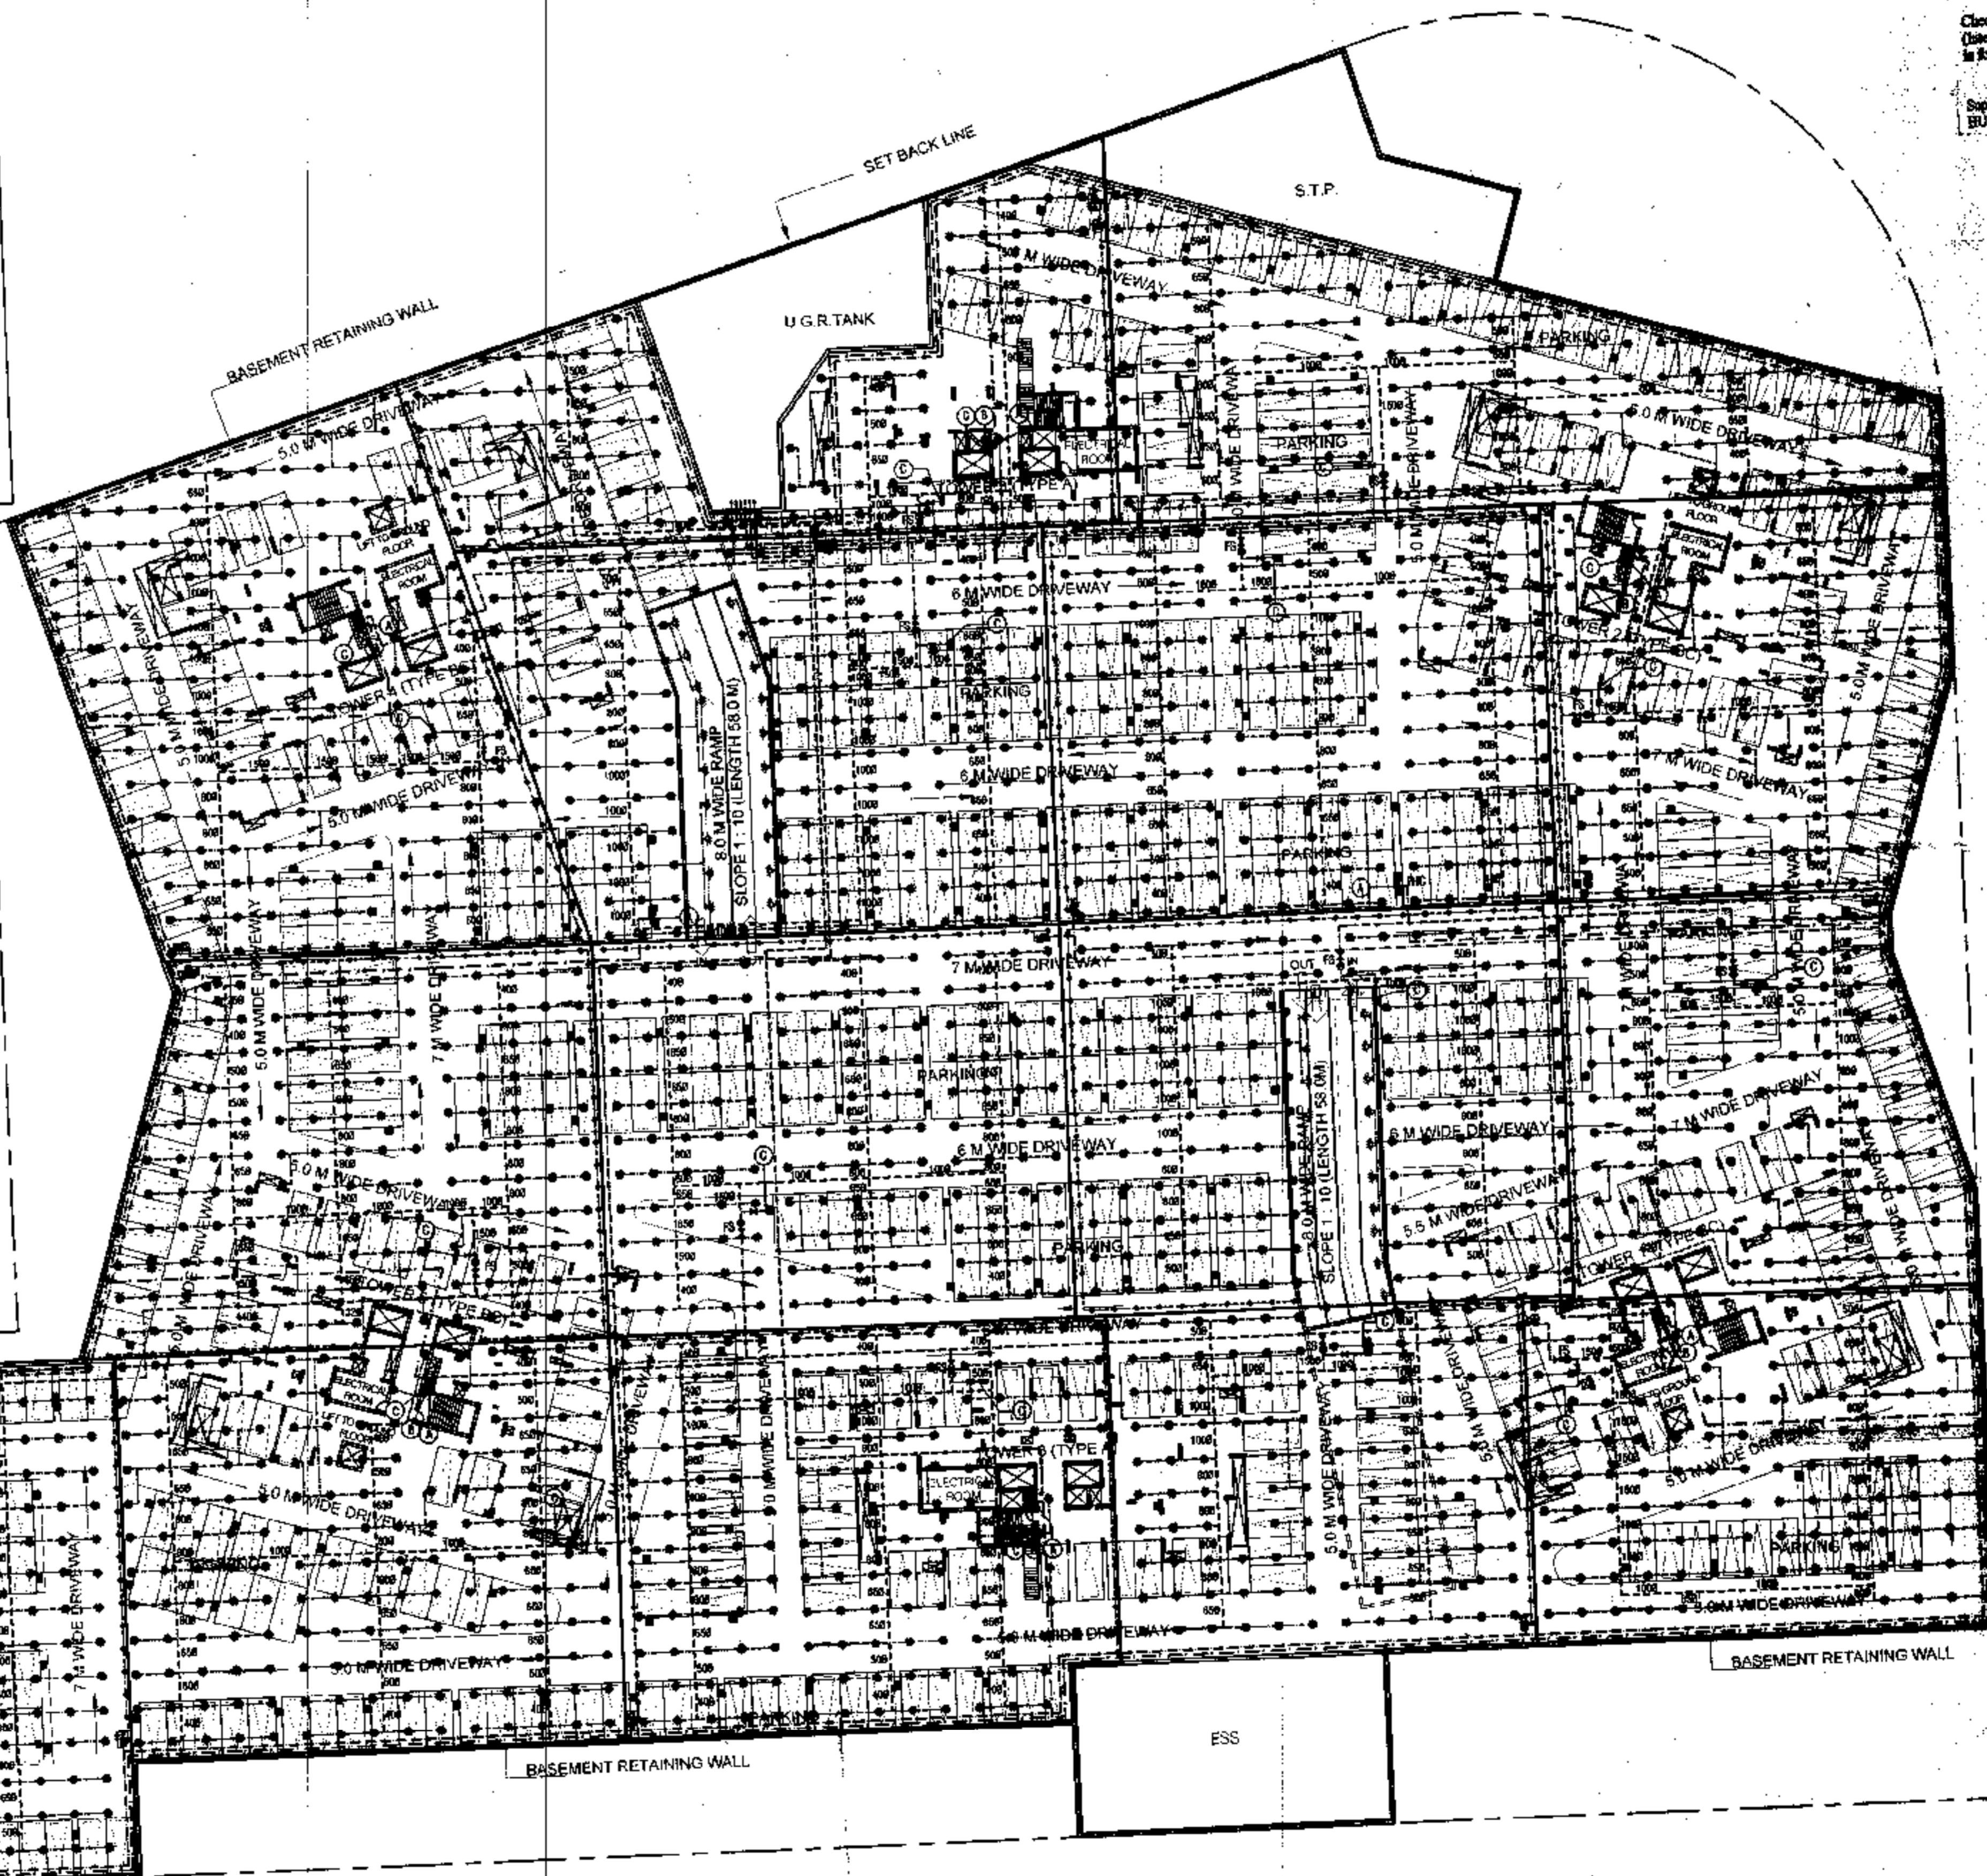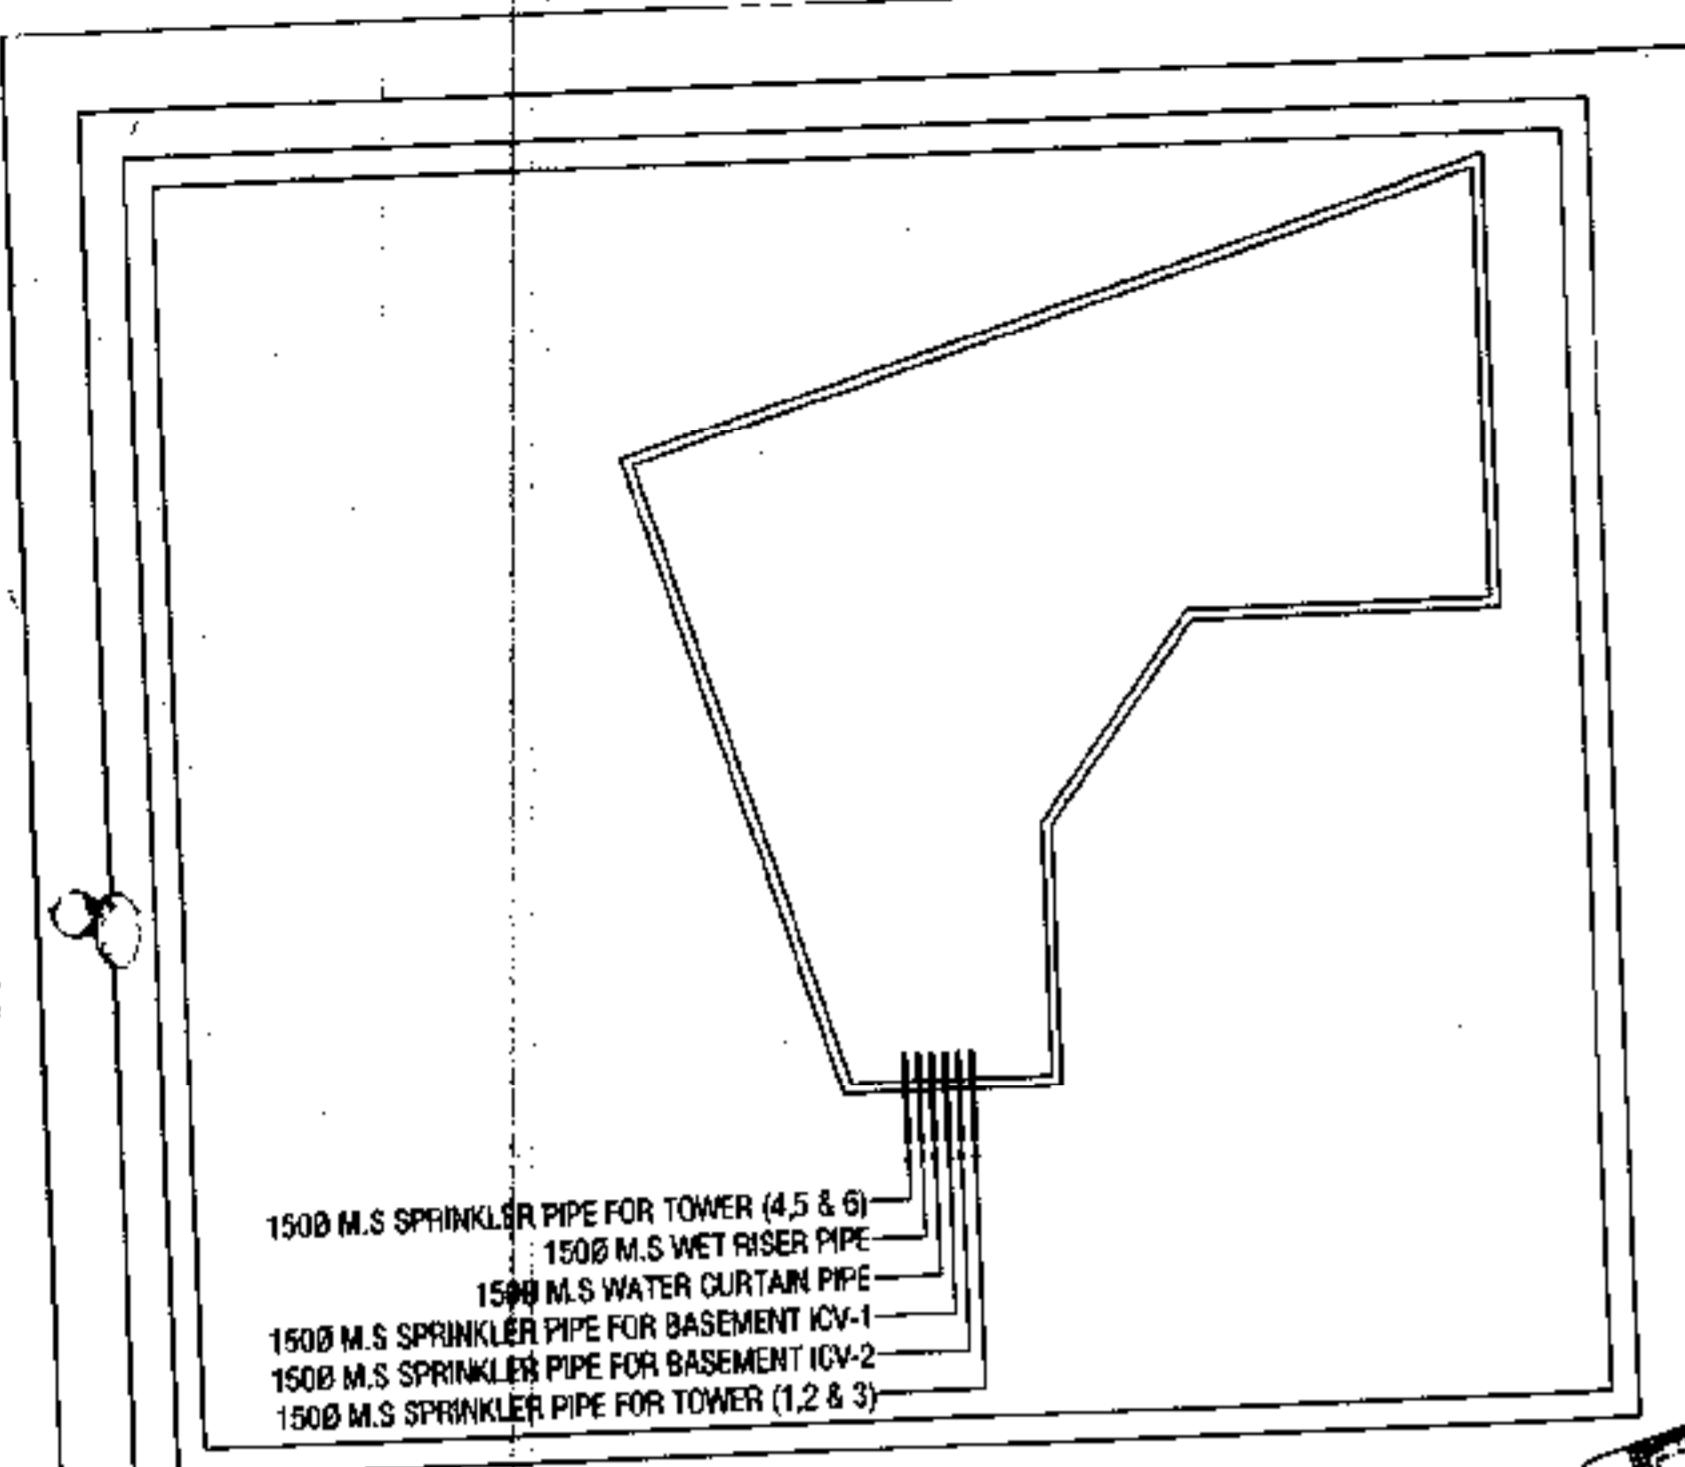

RECEIVED BY	DIA
RECEIVED ON	

**SPRINKLER**

SPRINKLER	DIA
1,2	250
3,	320
4,5,	400
5,10,	500
11,20,	650
21,40,	800
41,100,	1000
100, ABOVE,	1500


DEVELOPED BY:

PROJECT  
PROPOSED BUILDING PLAN OF ABSOLUT HOUSING CO.  
LAND MEASURING 11.125 ACRES SITE NO. 57 OF  
BLOCK 11-10-1933 IN SECTOR 10, GURGAON,  
HARYANA, COMPLEX BEING DEVELOPED BY ABSOLUT  
HOLDINGS PVT. LTD. AND OTHERS IN COLLABORATION WITH  
LTD.

**DRAWING TITLE:**  
**BASMENT PLAN**  
**FIRE LAYOUT**

DEALT BY	SCALE 1:350 <input checked="" type="checkbox"/>	DRG. NO.
CHECKED BY	DATE	FF-B

TYMENON: AUTHORISED SIGNATORY

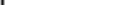 MANISH KUMAR  
CA/2005/3654

OWNER'S SIGN ARRESTED 95

## DOOR WINDOW SCHEDULE

S.R. NO	SIZE	STL	LINTEL	TYPE
1	900 X 2100	-	2100	D
2	750 X 2100	-	2100	D1
3	1500 X 2100	1050	2100	M
4	600 X 1275	1050	2100	M1

D.T.P. (HQ)  
Member Secretary  
B.P.A.C.

S.T.P. (G)  
Member  
B.P.A.C.

C.T.P. (W)  
Chairman  
B.P.A.C.

*W.H.* *J.D.* *SD* *R.A.* *S.A.P.*

**PART ELEVATION**

→ B

## BOUNDARY WALL PART PLAN

LVL +2750

LVL +950

ROAD LVL ±0

## ELEVATION

**AREA DIAGRAM  
GUARD ROOM 2**

AREA DIAGRAM  
GUARD ROOM 1

**GUARD ROOM**

ADDITION DETAIL				
1	3000 X	3500 X	1	10.500
2	4000 X	4360 X	1	17.440
<b>TOTAL</b>				<b>27.940</b>

**GUARD ROOM**

ISSN: 0022-278X • 100(1) 1-220 (2008)

NOTES

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9. ALL MECHANICALLY VENTILATED & ARTIFICIALLY LIT TOILET PROVIDED WITH 24HR POWER BACKUP.

PART PLAN  
GUARD ROOM 1

PART PLAN  
GUARD ROOM 2

**DRAWING TITLE:**  
**BOUNDARY WALL & GUARD**  
**NO. 1 USE DETAIL**

DEALT BY \_\_\_\_\_

CHECKED BY	DATE
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THROUGH AUTHORIZED SIGNATORY

For VATIKA LIMITED


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MANISH

CA2

OWNER'S COPY

[View Details](#)

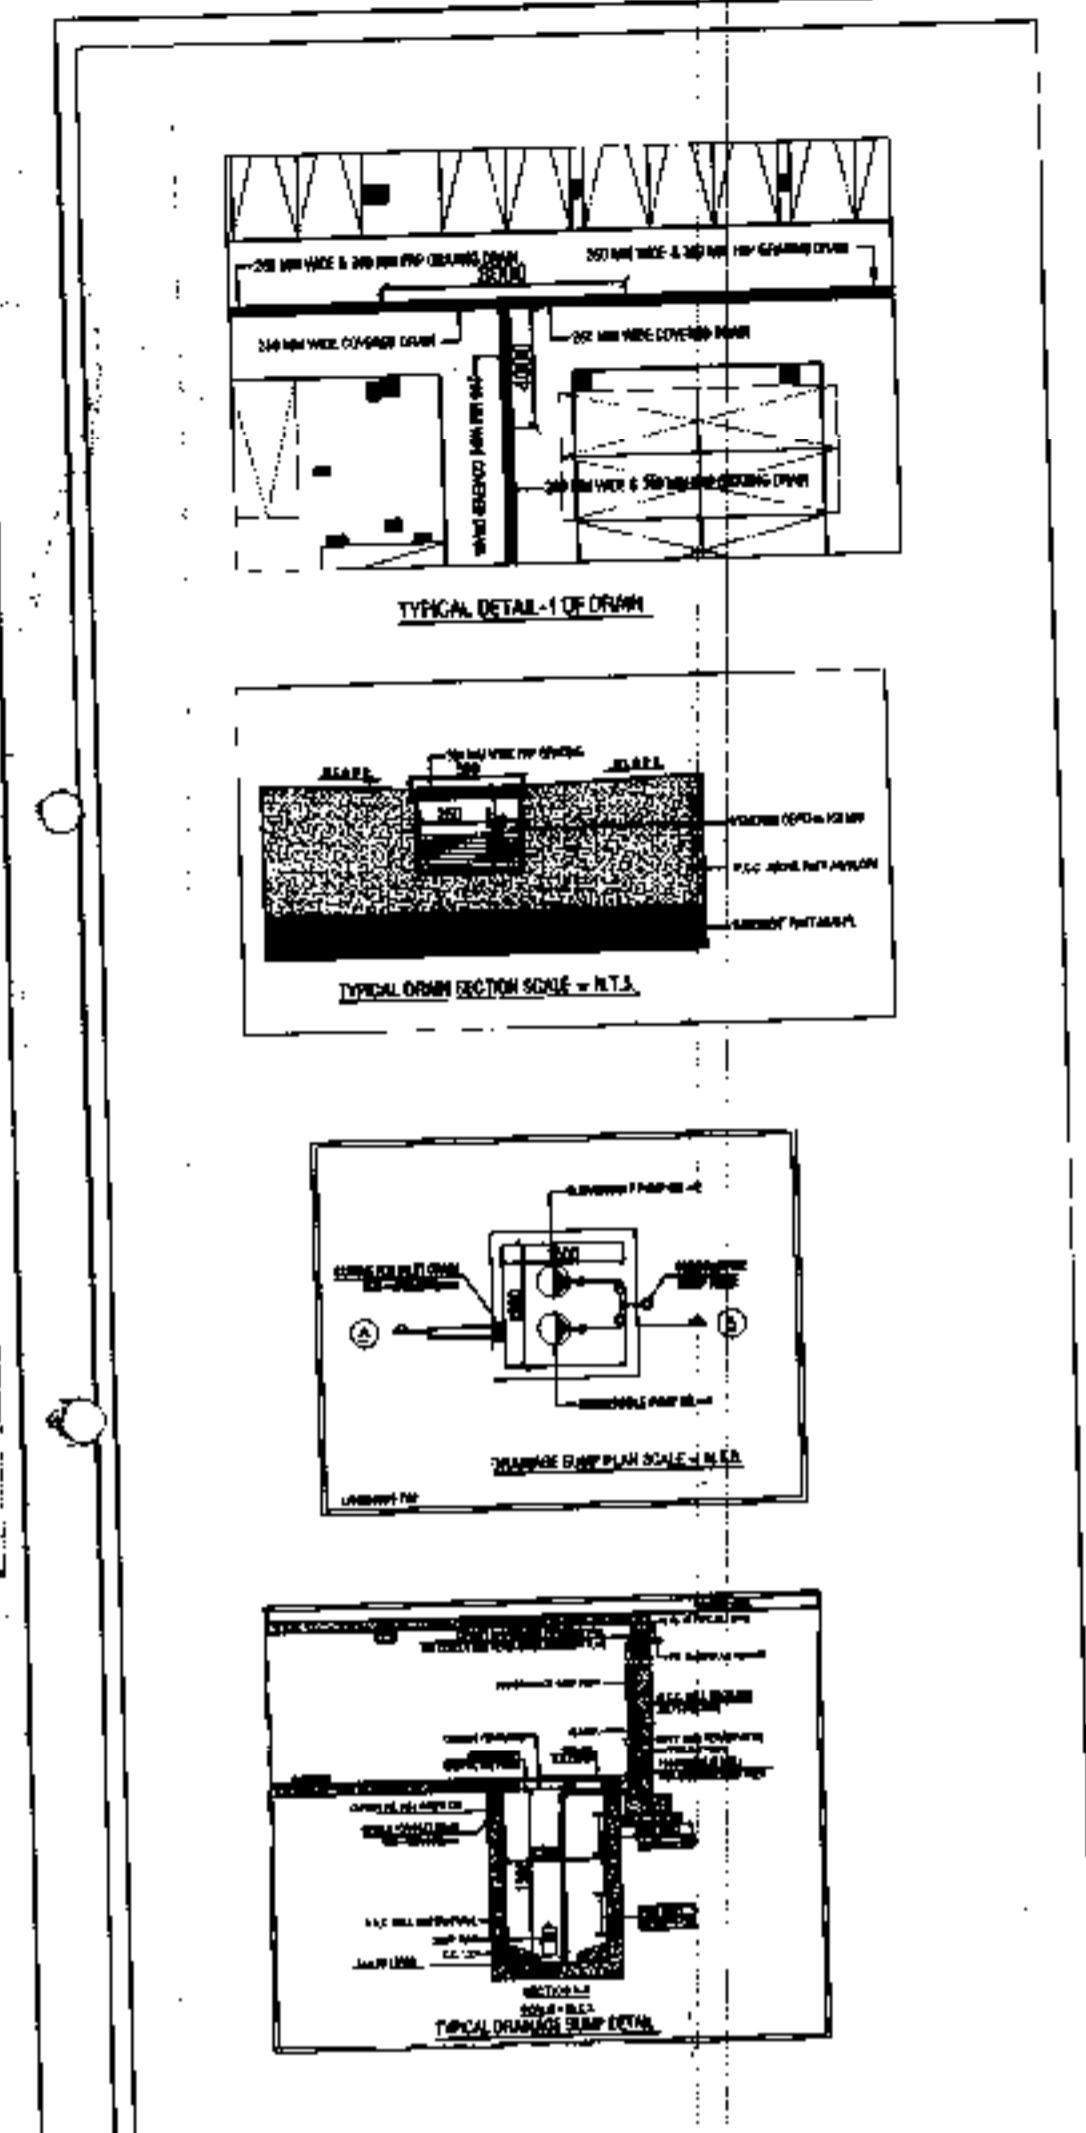

**L.P.** **S.T.P. (H.O.)** **C.T.P. (W.H.)**  
**Member Secretary** **Member** **Chairman**  
**E.P.A.C.** **E.P.A.C.** **E.P.A.C.**

Checked and found ok for Public Health  
(Internal) Service only subject to comments in  
forwarding letter No. SE/HQ/194.D/5844

Superintending Engineer (HQ)  
HUDA, Panjabhla.

