



			WANGAL	AALARAA			
			#10007 NO	YARAMA			
		Access to the second	Addiso	i V			
Description	Langith (mill)	Bread R.(not)	Super [Tril]	Height test?	Aires boyes	No. of Egores.	Nation Arms (sept)
1	4.800	1.314			U1.	4	2634
	1,400	1.196			3.24	1	54.30
		Total or	Tall Additions. Y			_	41.04
		Andrew Salar		Salar Salar			
	30	HAL THYEAL PLO	DIKMALCONT N	Oly FAIR Area			40.04
Debat Papital Francis	50.0						
	Total Bakery	NON TAN ASSOCI	The last Plans I	idamy NOVER	Angli .		364.56
			TH - 160 ATTEN TAX	OCHON CALLANA			
				A SUSTEMANIA AND	-		
			Autoble				
		The second secon	Basic (mill)	Height (mil)	Acres (seem)	No. of Egyptes	Total Area (sign
Description	Largeth (rect)	Breedth (mt)	The second particular and the second particu				
Description	Sangth (wt)	7,613	- Complete		73.61	1	47.65
Description	3,400	7.8%	151.044				
		7.8%	ful Additions		73.63	1	47.65

12 EWS- WATER TANK NON FAR AREA

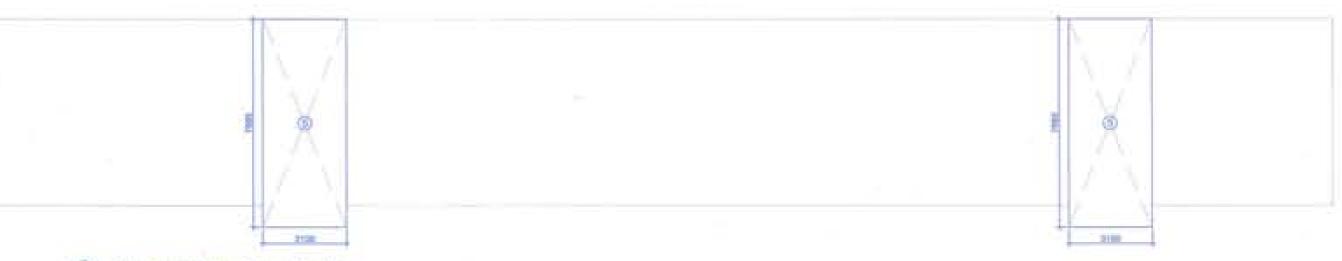

EWS-MUMTY NON FAR AREA

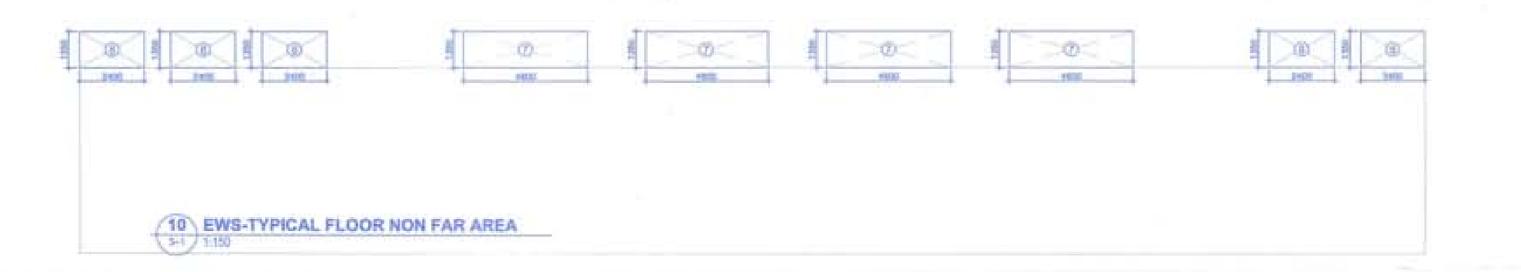



OF THE SAFETY MEASURES AS PEW AND COMPLANCES SHOULD SHOULD



Project

PROPOSED GROUP HOUSING SCHEME MEASURING 17.55 ACRES JUCENCE NO. 16 OF 2008) IN SECTOR-59 GURGAON MANESAR URBAN COMPLEX BEING DEVELOPED BY M/S BTVs BUILDWELL PVT. LTD. M/S ORNAMANTAL REALTORS PVT. LTD. M/S ADSON SOFTWARE PVT. LTD. C/O M/S BASE EXPORTS PVT. LTD.

Authorized Signature

STRUCTURAL CONSULTANT

Consulting MEP

Architect's Sign

CA / 2006 / 37819


Morphogenesis

N-858, Ponchabeel Pork, New Dethi, 110017, India. TEL: 91 11 41828070 FAX: 91 11 25490351 E Moll studio@morphogenesis.org

Drawing Title

EWS: NON FAR AREA CALCULATION

Drowing No. EW5-02/02a Scale 1:150 Dote JAN' 14

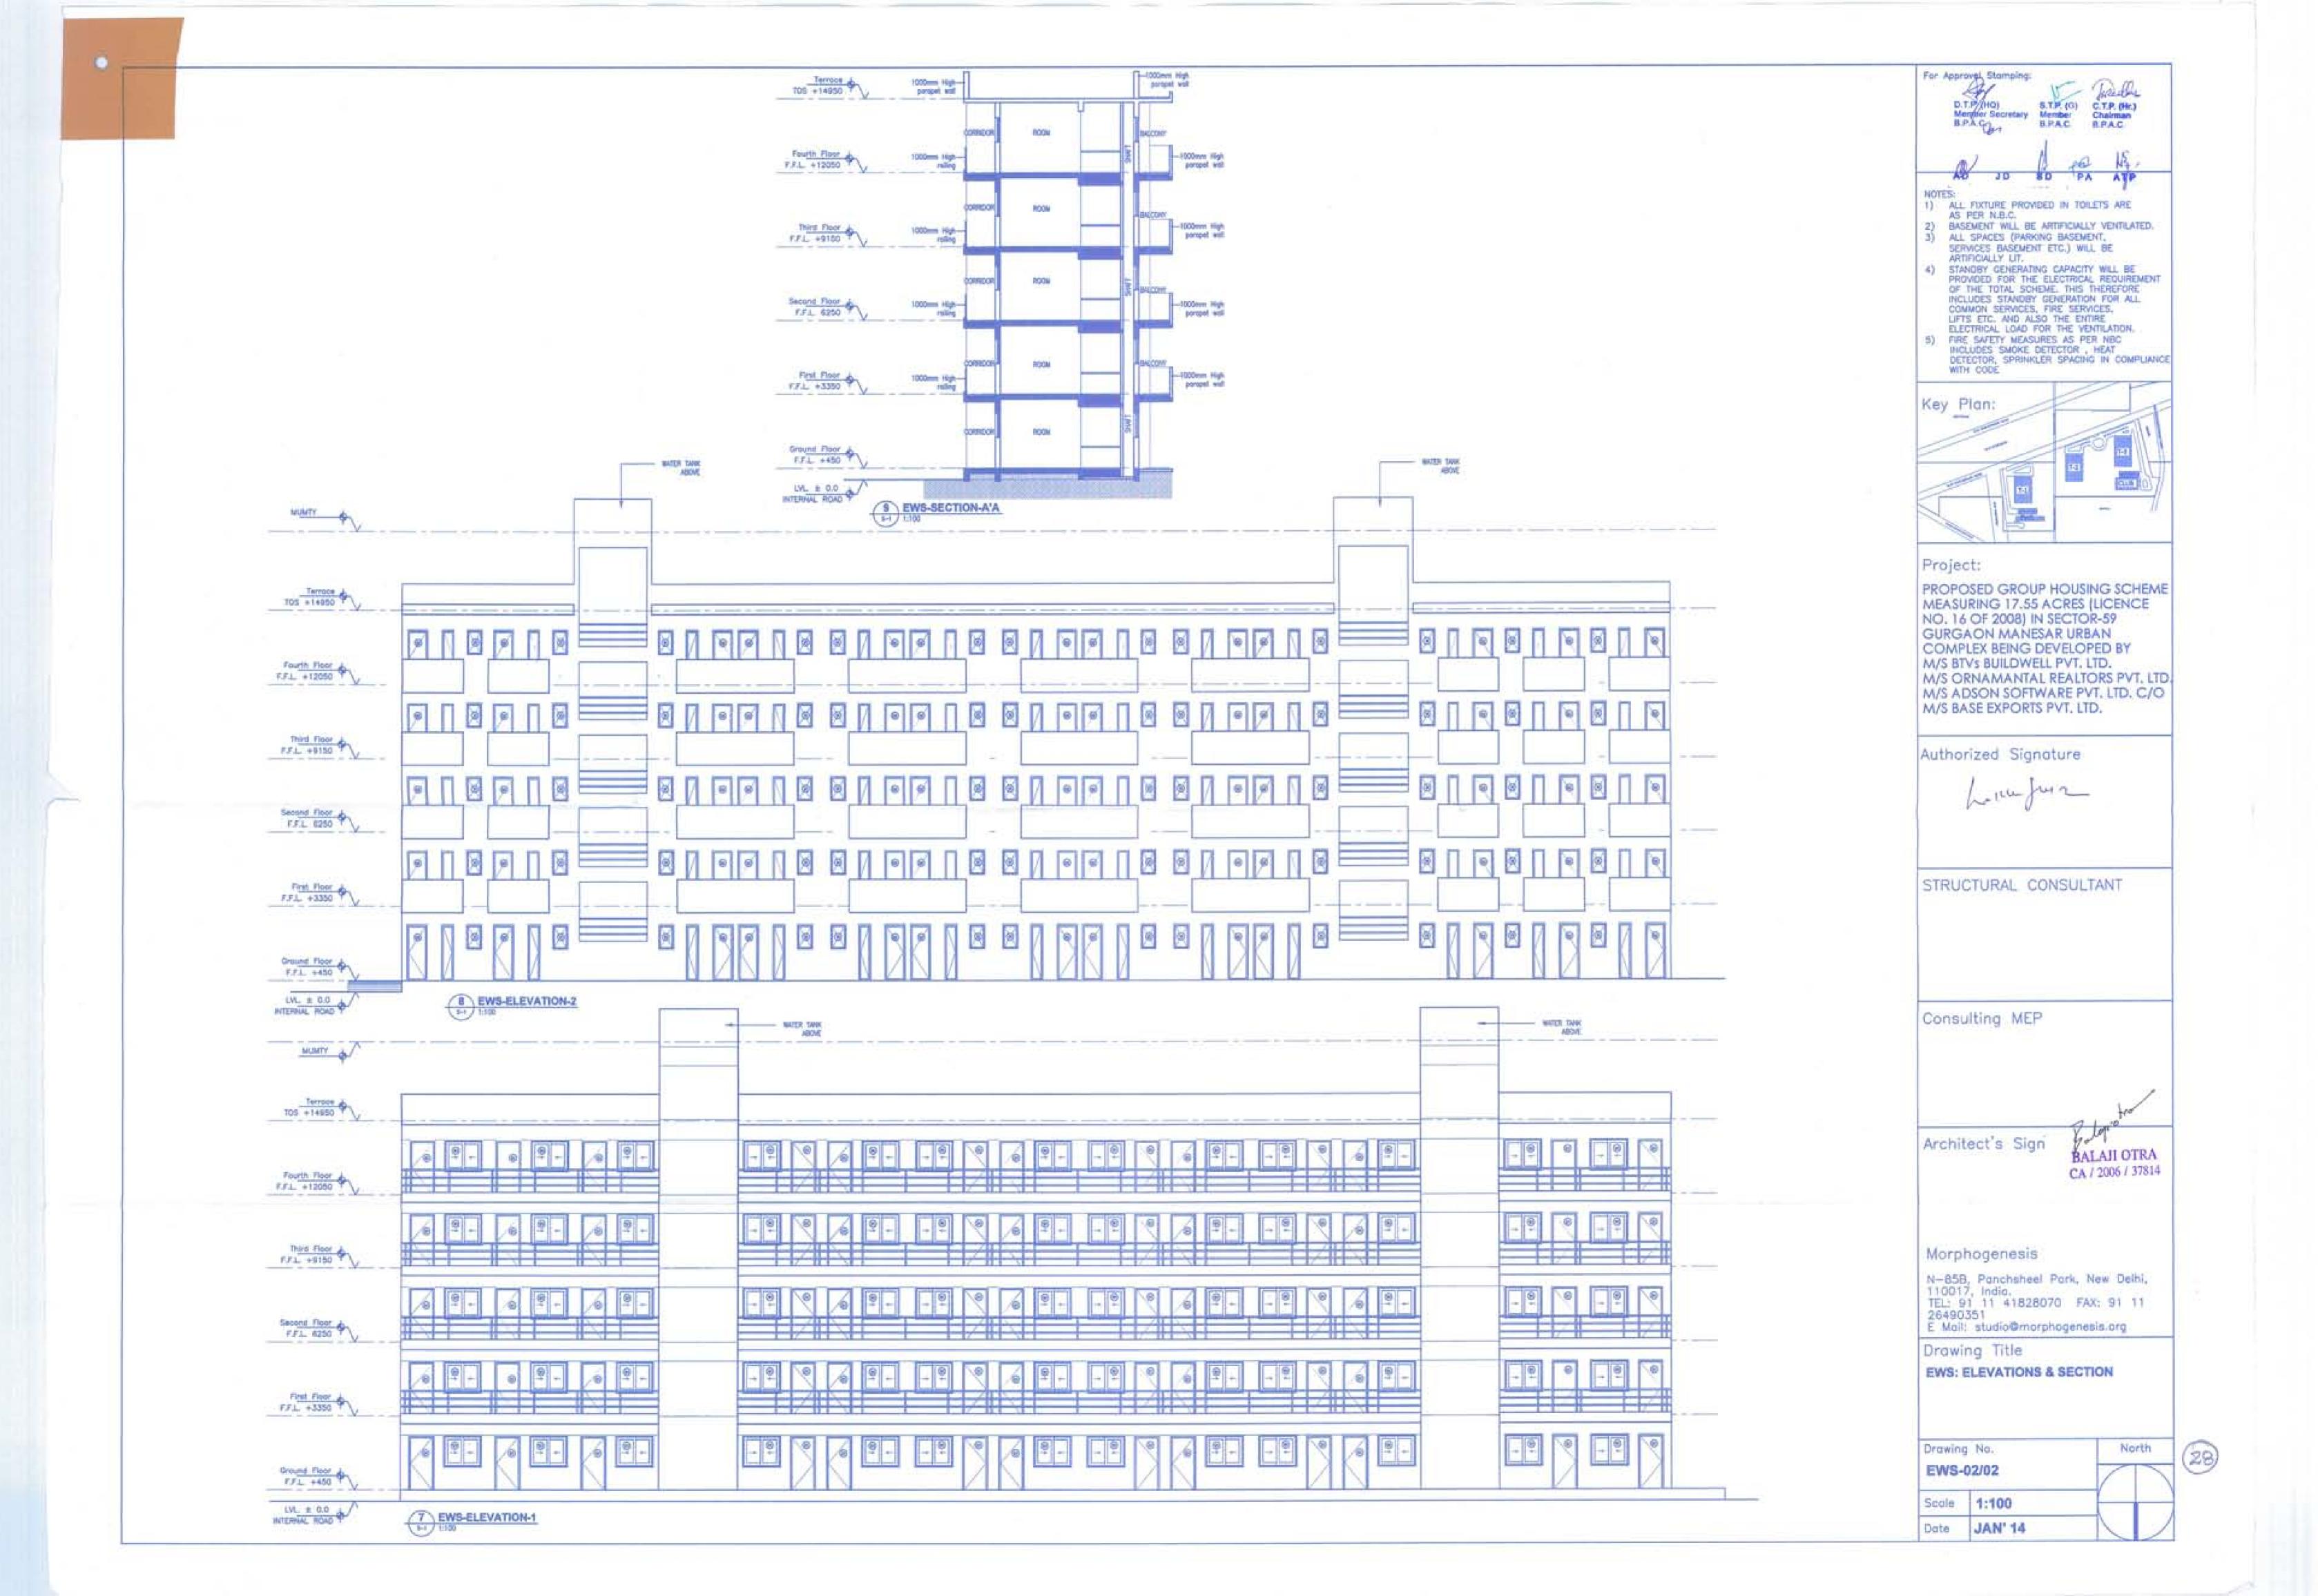

		LO	WER BASEME	NT			
			BASEMENT A				
			Additions 'A'				
Description	Length (mt)	Breadth (mt)	Base (mt)	Height (mt)	Area (sqm)	No. of figures	Total Area (sqm)
Area of triangle A	927	-	72.660	26.820	974.371	1	974.371
Area of rectangle B	72.660	21.310			1548.385	1	1548.385
Area of rectangle C	130.390	27.830		-	3628.754	1	3628.754
Area of triangle D	3#3	-	75.960	14.640	556.027	1	556.027
Area of rectangle E	145.025	34.230	125		4964.206	1	4964.206
Area of triangle F	240		51.155	18.885	483.031	1	483.031
Area of rectangle G	6.575	0.680			4.471	1	4.471
		Total of all add	ditions 'A'				12159.244


			BASEMENT B							
Additions 'B'										
Description	Length (mt)	Breadth (mt)	Base (mt)	Height (mt)	Area (sqm)	No. of figures	Total Area (sqm)			
Area of rectangle H	76.395	17.545	= 547	-	1340.350	1	1340.350			
Area of rectangle J	82.695	24.910	50	2	2059.932	1	2059.932			
Area of rectangle K	60.201	23.315		-	1403.586	1	1403.586			
Area of triangle L	(*)	-	27.595	10.185	140.528	1	140.528			
Area of rectangle M	39.425	4.280	(m)	-	168.739	1	168.739			
Area of rectangle N	12.300	11.015			135.485	1	135.485			
Area of object O		4	-		118.822	1	118.822			
		Total of all add	ditions 'B'				5367.442			


Total Floor Area of Upper Basement (C)= (A+B)	17526.686
	11.


			Additions 'D'				
Description	Length (mt)	Breadth (mt)	Base (mt)	Height (mt)	Area (sqm)	No. of figures	Total Area (sqm
Area of rectangle 1	16.040	5.845	-	, N. A.	93.754	1	93.754
Area of rectangle 2	8.070	4.360	191	×	35.185	1	35.185
Area of rectangle 3	10.770	6.025	.4:		64.889	1	64.889
Area of rectangle 4	16.040	5.420	2-2-		86.937	1	86.937
Area of rectangle 5	7.415	5.220			38.706	1	38.706
Area of rectangle 6	2.900	1.135	-	×	3.292	4	13,166
Area of rectangle 7	3.735	1.200	14.1	2	4.482	1	4.482
Area of rectangle 8	1.370	0.435	<u> 527</u>	2	0.596	1	0.596
Area of rectangle 9	2.900	1.565			4.539	1	4.539
Area of rectangle 10	7.960	3.500			27.860	1	27.860
Area of rectangle 11	6.780	3.905	(4)		26.476	1	26.476
Area of rectangle 12	14.800	6.300	14	2	93.240	1	93.240
Area of rectangle 13	32.345	6.730		3	217.682	1	217.682
Area of rectangle 14	8.300	4.445	-	-	36.894	1	36.894
Area of rectangle 15	10.240	5.850		-	59.904	1	59.904
Area of rectangle 16	10.640	0.435		9	4.628	1	4.628
Area of rectangle 17	6.700	3.300			22.110	1	22.110
Area of rectangle 18	6.650	5.500		-	36.575	1	36.575
Area of rectangle 19	16.040	5.420	-		86.937	1	86.937
Area of rectangle 20	6.985	2.900	54	-	20.257	2	40.513
Area of rectangle 21	6.680	4.275			28.557	1	28.557
Area of triangle 22		-	37.750	13.935	263.023	1	263.023
Area of rectangle 23	37.750	4.135	-		156.096	1	156.096
Area of rectangle 24	21.810	10.770	5-8	-	234.894	1	234.894
Area of rectangle 25	5.850	5.270	-	-	30.830	1	30.830
Area of rectangle 26	3.735	2.570	_		9.599	1	9.599
Area of rectangle 27	5.580	5.270			29.407	1	29.407
Area of rectangle 28	11.055	5.220	+		57.707	1	57.707
Area of rectangle 29	2.900	1.405	34		4.075	1	4.075
Area of rectangle 30	7.500	4.405	1-		33.038	1	33.038
Area of rectangle 31	20.895	11.265			235.382	1	235.382
Area of rectangle 32	7.010	4.105		T T	28.776	2	57.552
	Tot	tal Lower Basemen	t Service Area	'D'			2135.231
Area of Lower Basement	t (C)						17526.686
Area provided for Service		ment (D)		1			2135.231

Area provided for Parking on Lower Basement (C-D)

500 CO. ET			F9100022 0132		Shaka kala kara
TYPE	WIDTH	CILL LVL.	LINTEL LVL.	SIZE (HxW)	REMARK
FD1	1200		2400	2400x1200	Fire Door
FD2	1100	721	2400	2400x1100	Fire Door
FD3	1200	g=1	2400	2400x1200	Fire Door
FD4	1500	(#)	2400	2400x1500	Fire Door
FD5	1200	(e)	2150	2150x1200	Fire Door
RS	3000	3.5	2750	2750x3000	Fire Door
D1	2000	727	2400	2400x2000	Door
D2	1200		2400	2400x1200	Door

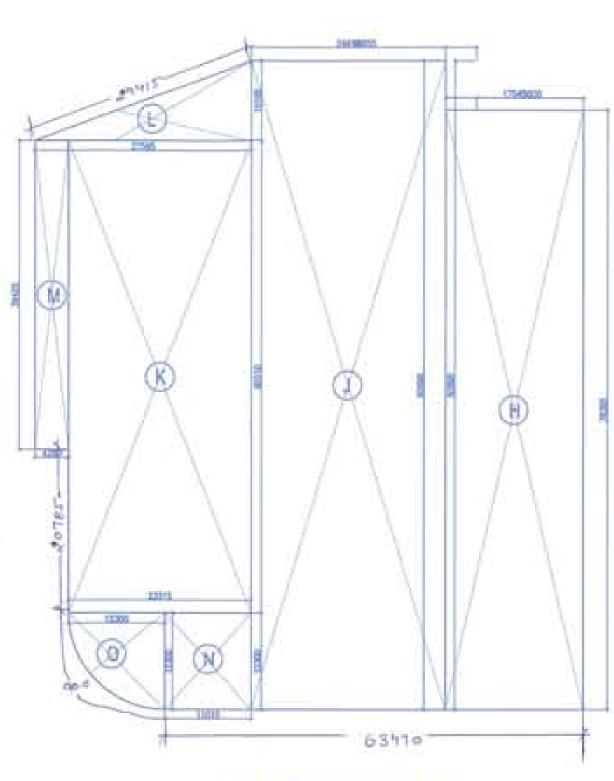


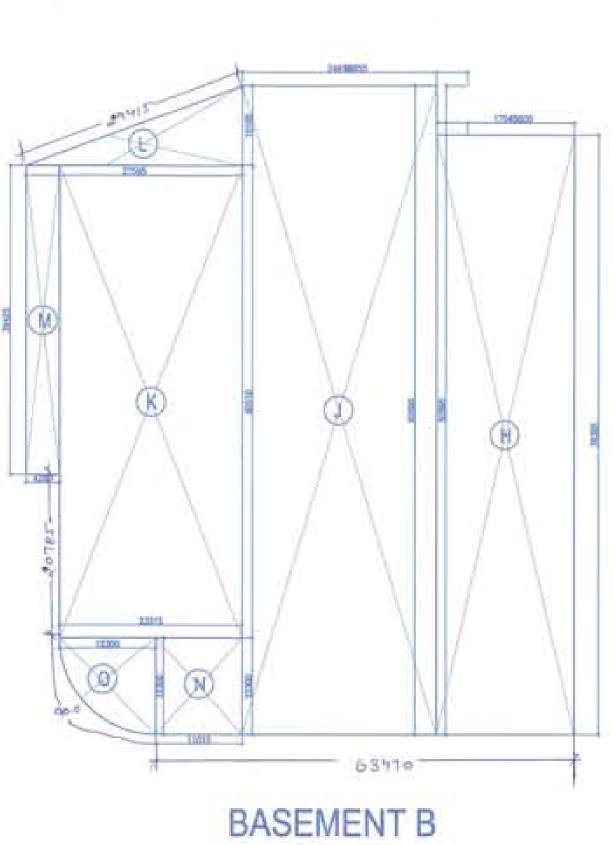

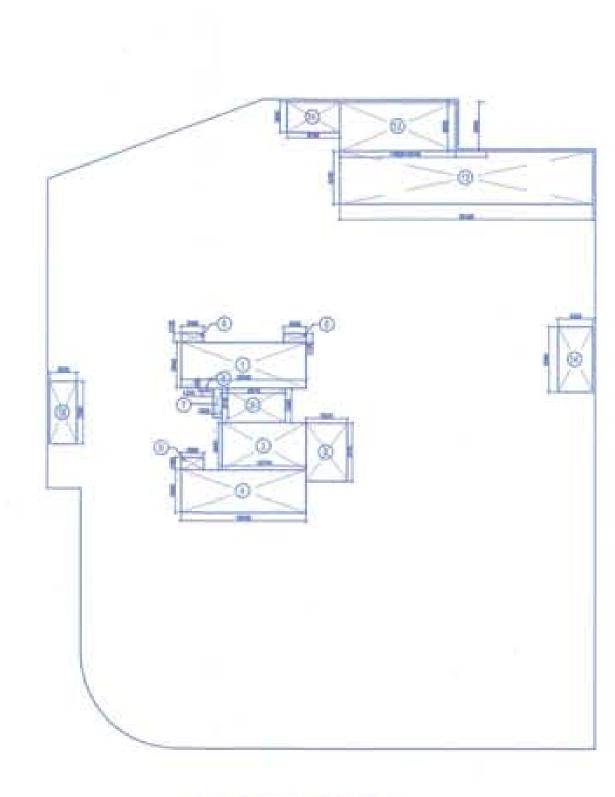


15391.455

BASEMENT B

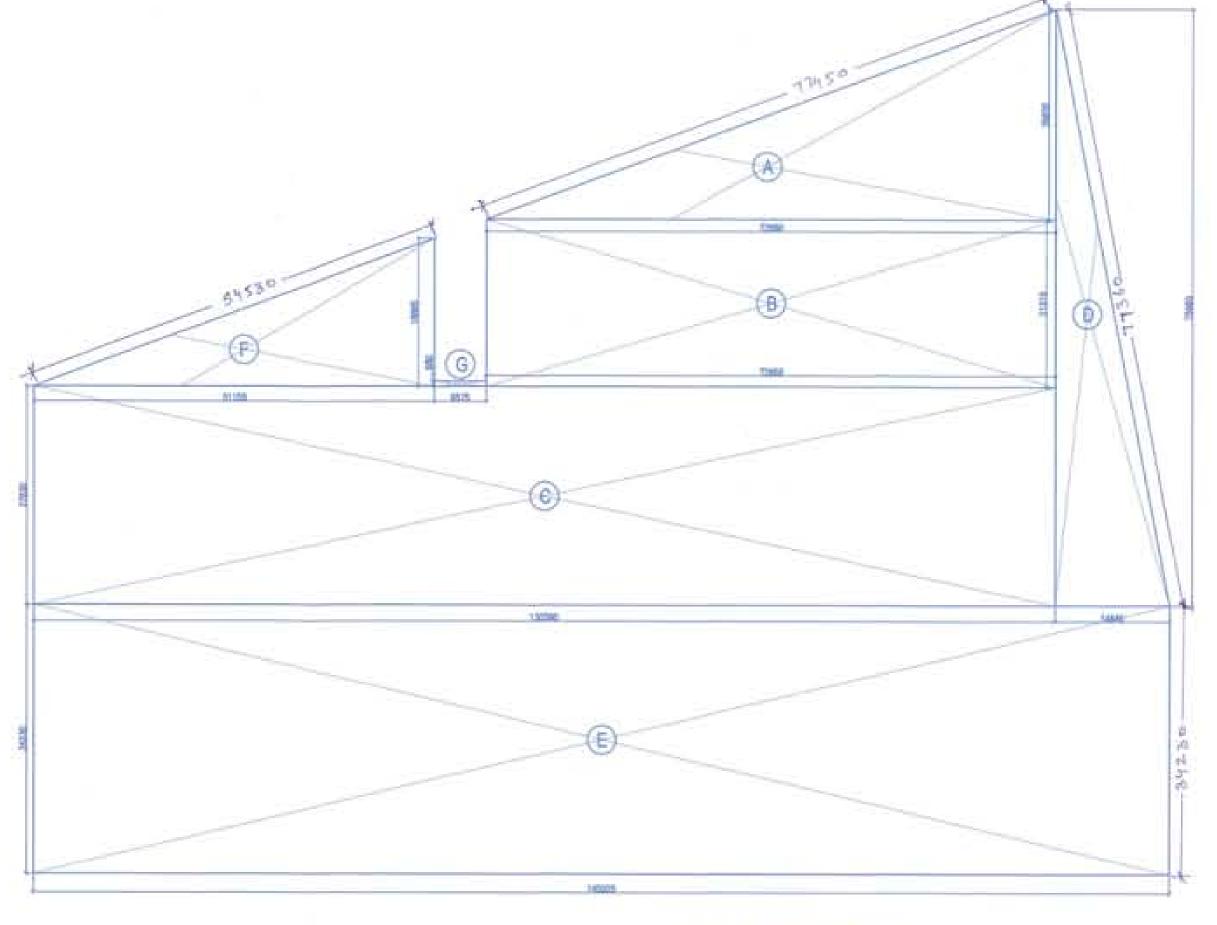


BASEMENT A

LOWER BASEMENT FLOOR- AREA CALCULATION SCALE 1:500

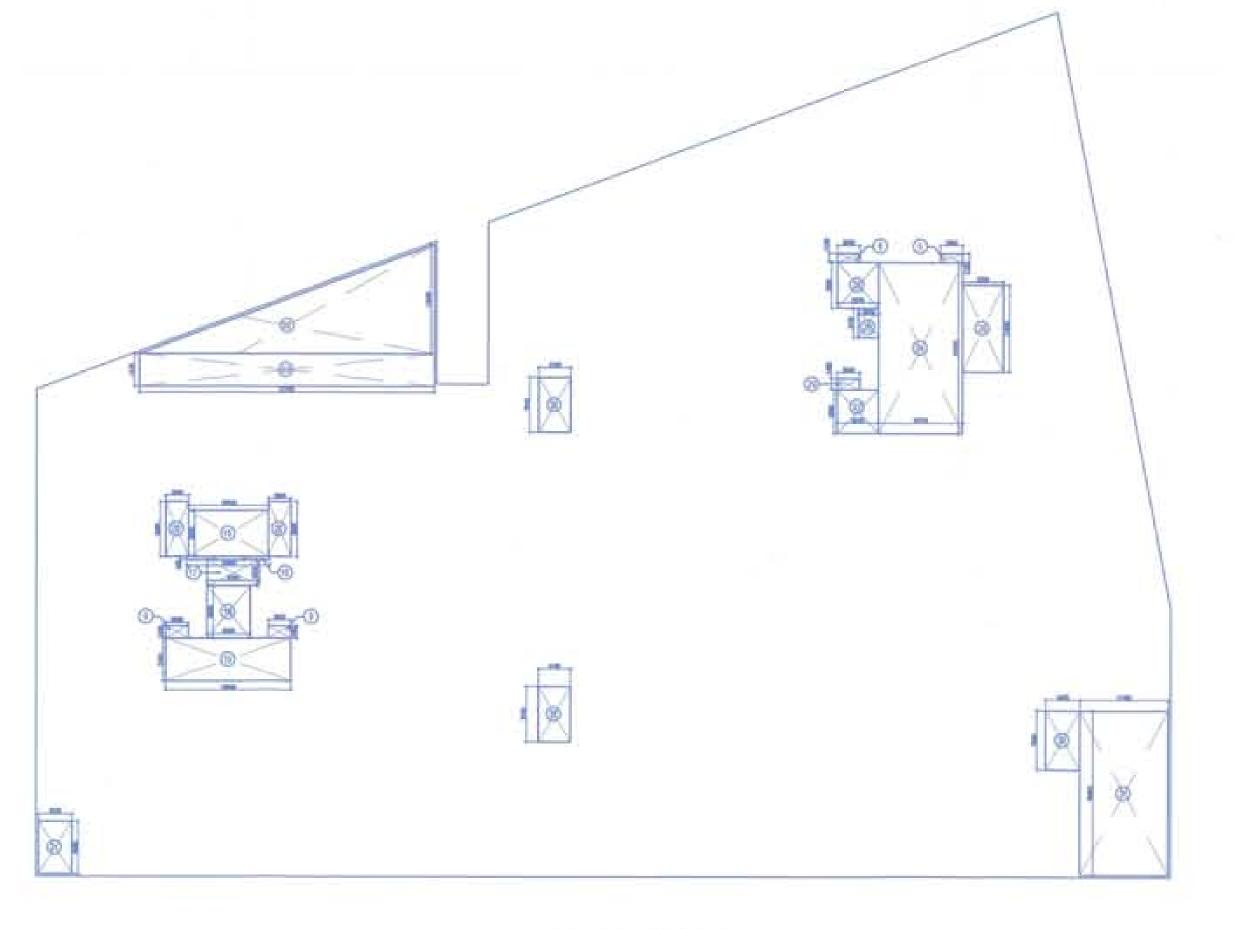

BASEMENT A

LOWER BASEMENT - SERVICE AREA CALCULATION SCALE 1:500

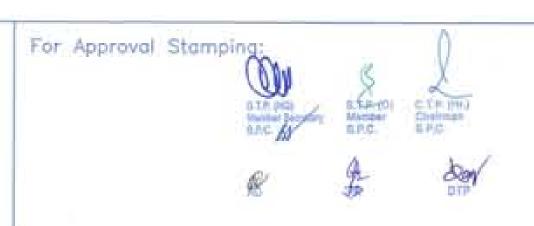

NOTES:

1) ALL FIXTURE PROVIDED IN TOILETS ARE AS PER N.B.C.

2) BASEMENT WILL BE ARTIFICIALLY VENTILATED. 3) ALL SPACES (PARKING BASEMENT, SERVICES BASEMENT ETC.) WILL BE

ARTIFICIALLY LIT. 4) STANDBY GENERATING CAPACITY WILL BE PROVIDED FOR THE ELECTRICAL REQUIREMENT OF THE TOTAL SCHEME. THIS THEREFORE INCLUDES STANDBY GENERATION FOR ALL COMMON SERVICES, FIRE SERVICES, LIFTS ETC. AND ALSO THE ENTIRE ELECTRICAL LOAD FOR THE VENTILATION.

5) FIRE SAFETY MEASURES AS PER NBC INCLUDES SMOKE DETECTOR . HEAT DETECTOR, SPRINKLER SPACING IN COMPLIANCE WITH CODE

Key Plan:

REVISED BASEMENT PLAN IN GROUP HOUSING SCHEME MEASURING 17.55 ACRES (LICENCE NO. 16 OF 2008) IN SECTOR-59 GURGAON MANESAR URBAN COMPLEX BEING DEVELOPED BY M/S BTVs BUILDWELL PVT. LTD. M/S ORNAMANTAL REALTORS PVT. LTD.

M/S ADSON SOFTWARE PVT. LTD Bythomized Baisen of MPORTS PVT. LTD.



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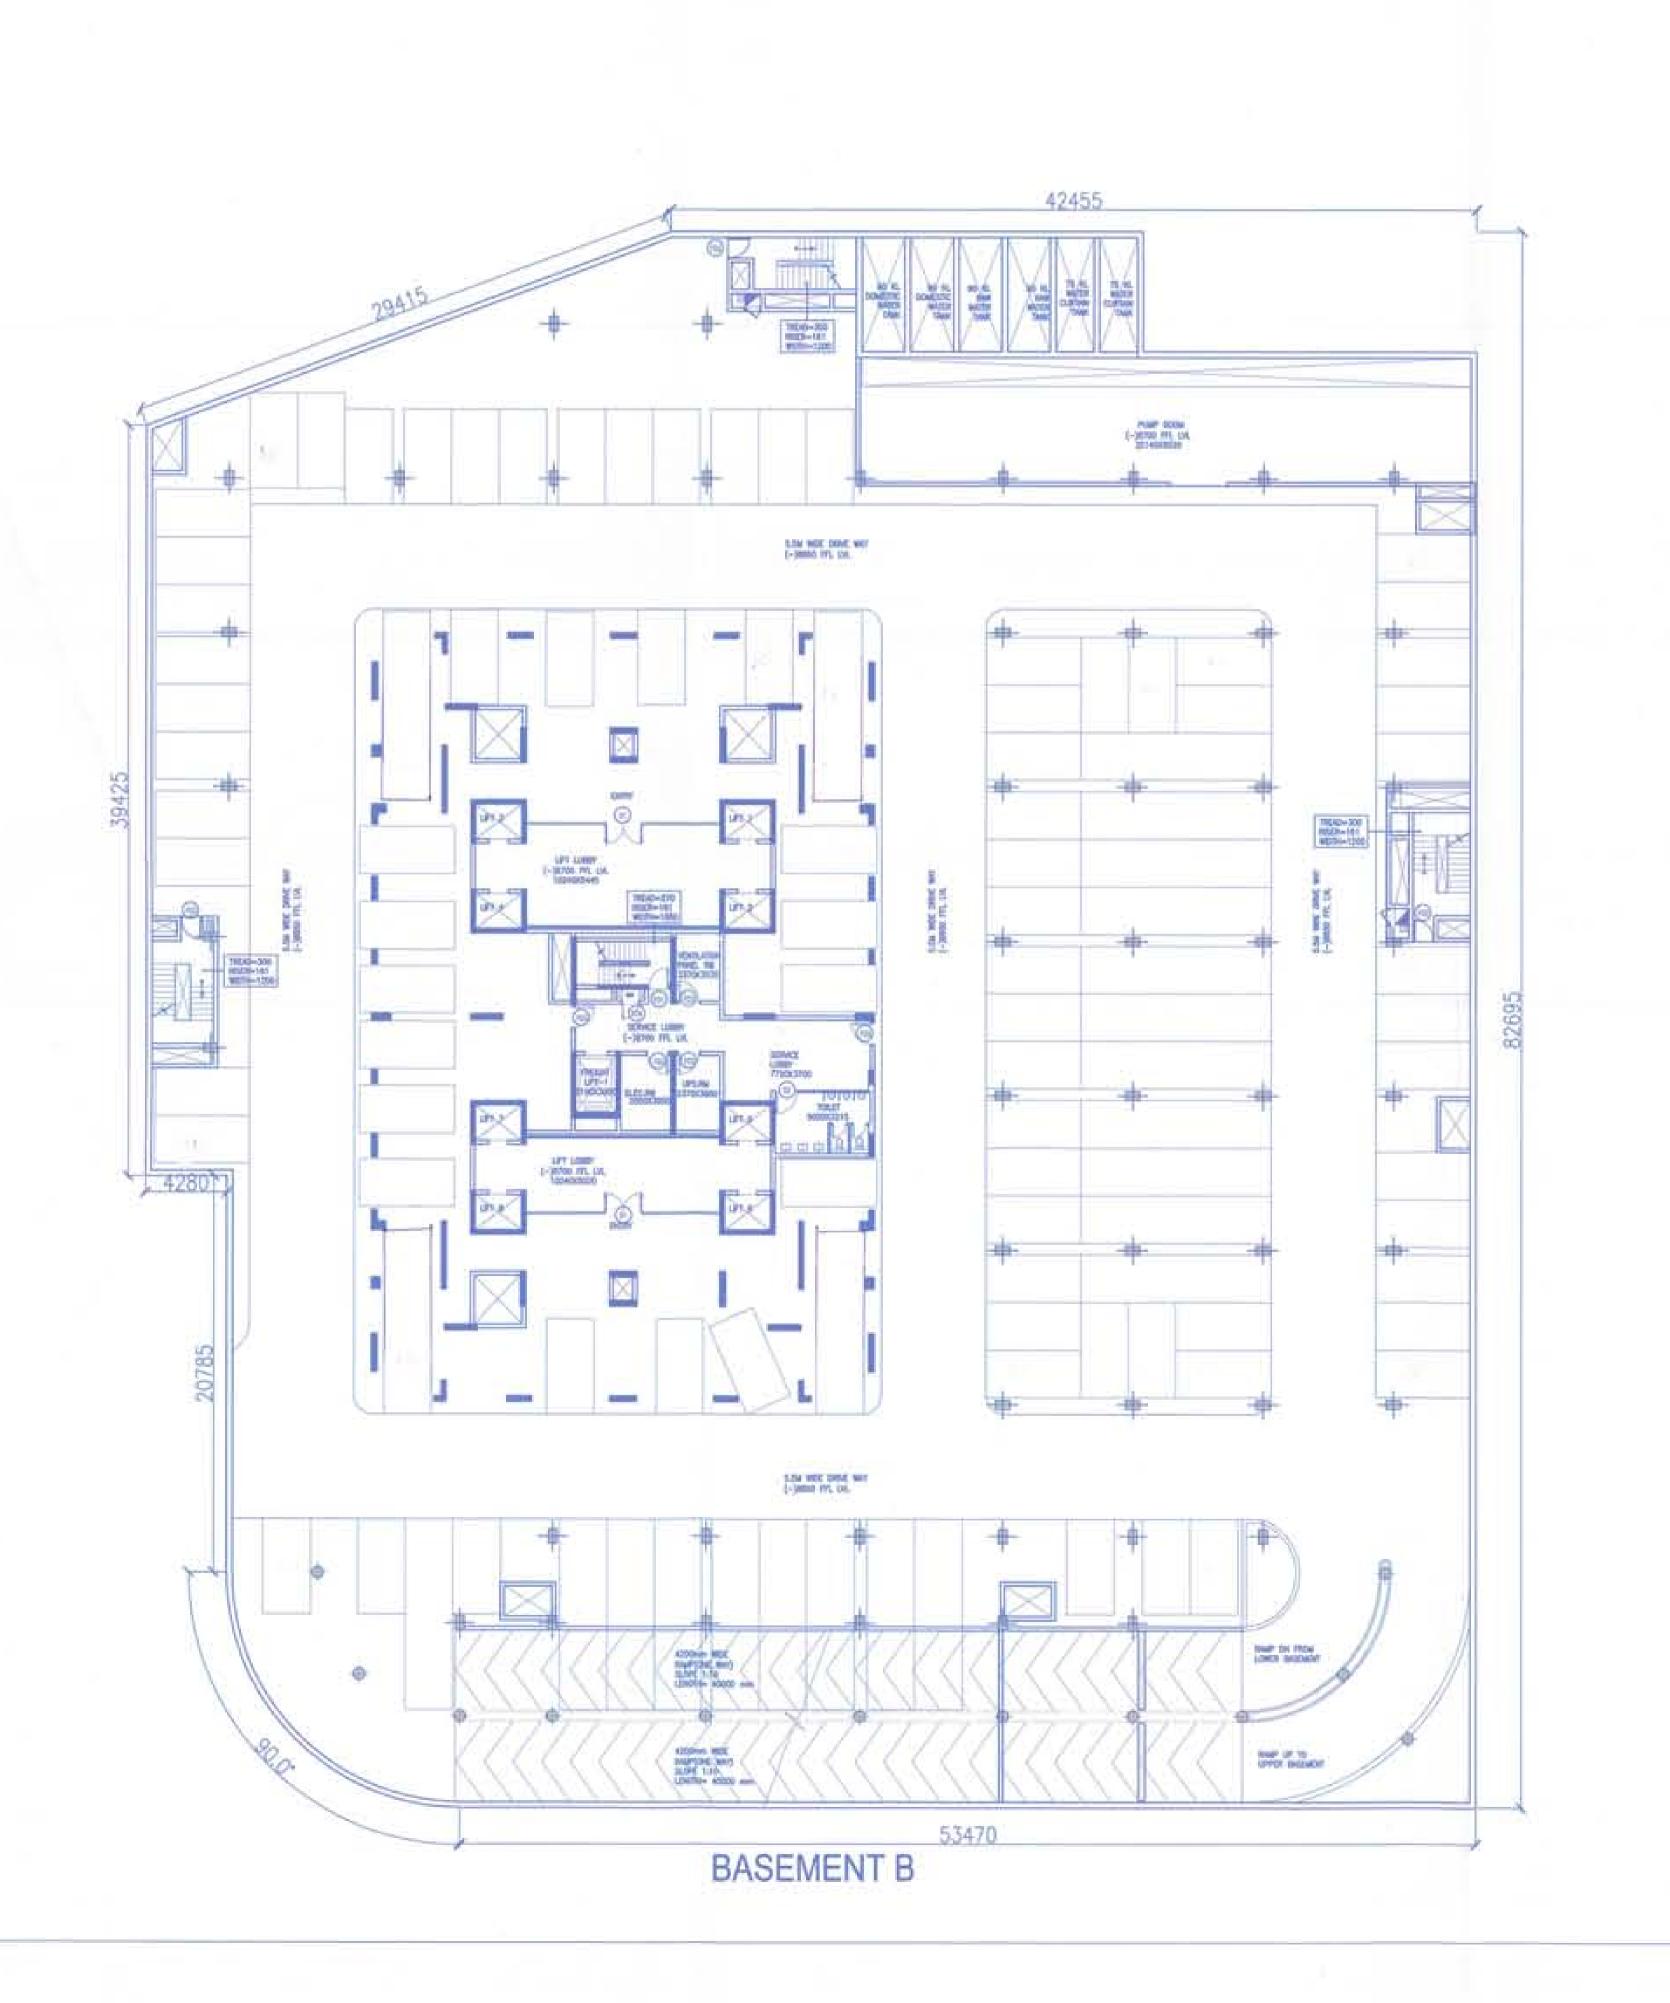
Morphogenesis


N-85B, Panchsheel Park, New Delhi, 110017, India. TEL: 91 11 41828070 FAX: 91 11 26490351 E Mail: studio@morphogenesis.org

Drawing Title

LOWER BASEMENT AREA CALCULATION:

VG-Drawing No. North BS-06.1/06 Scale Date JAN '16



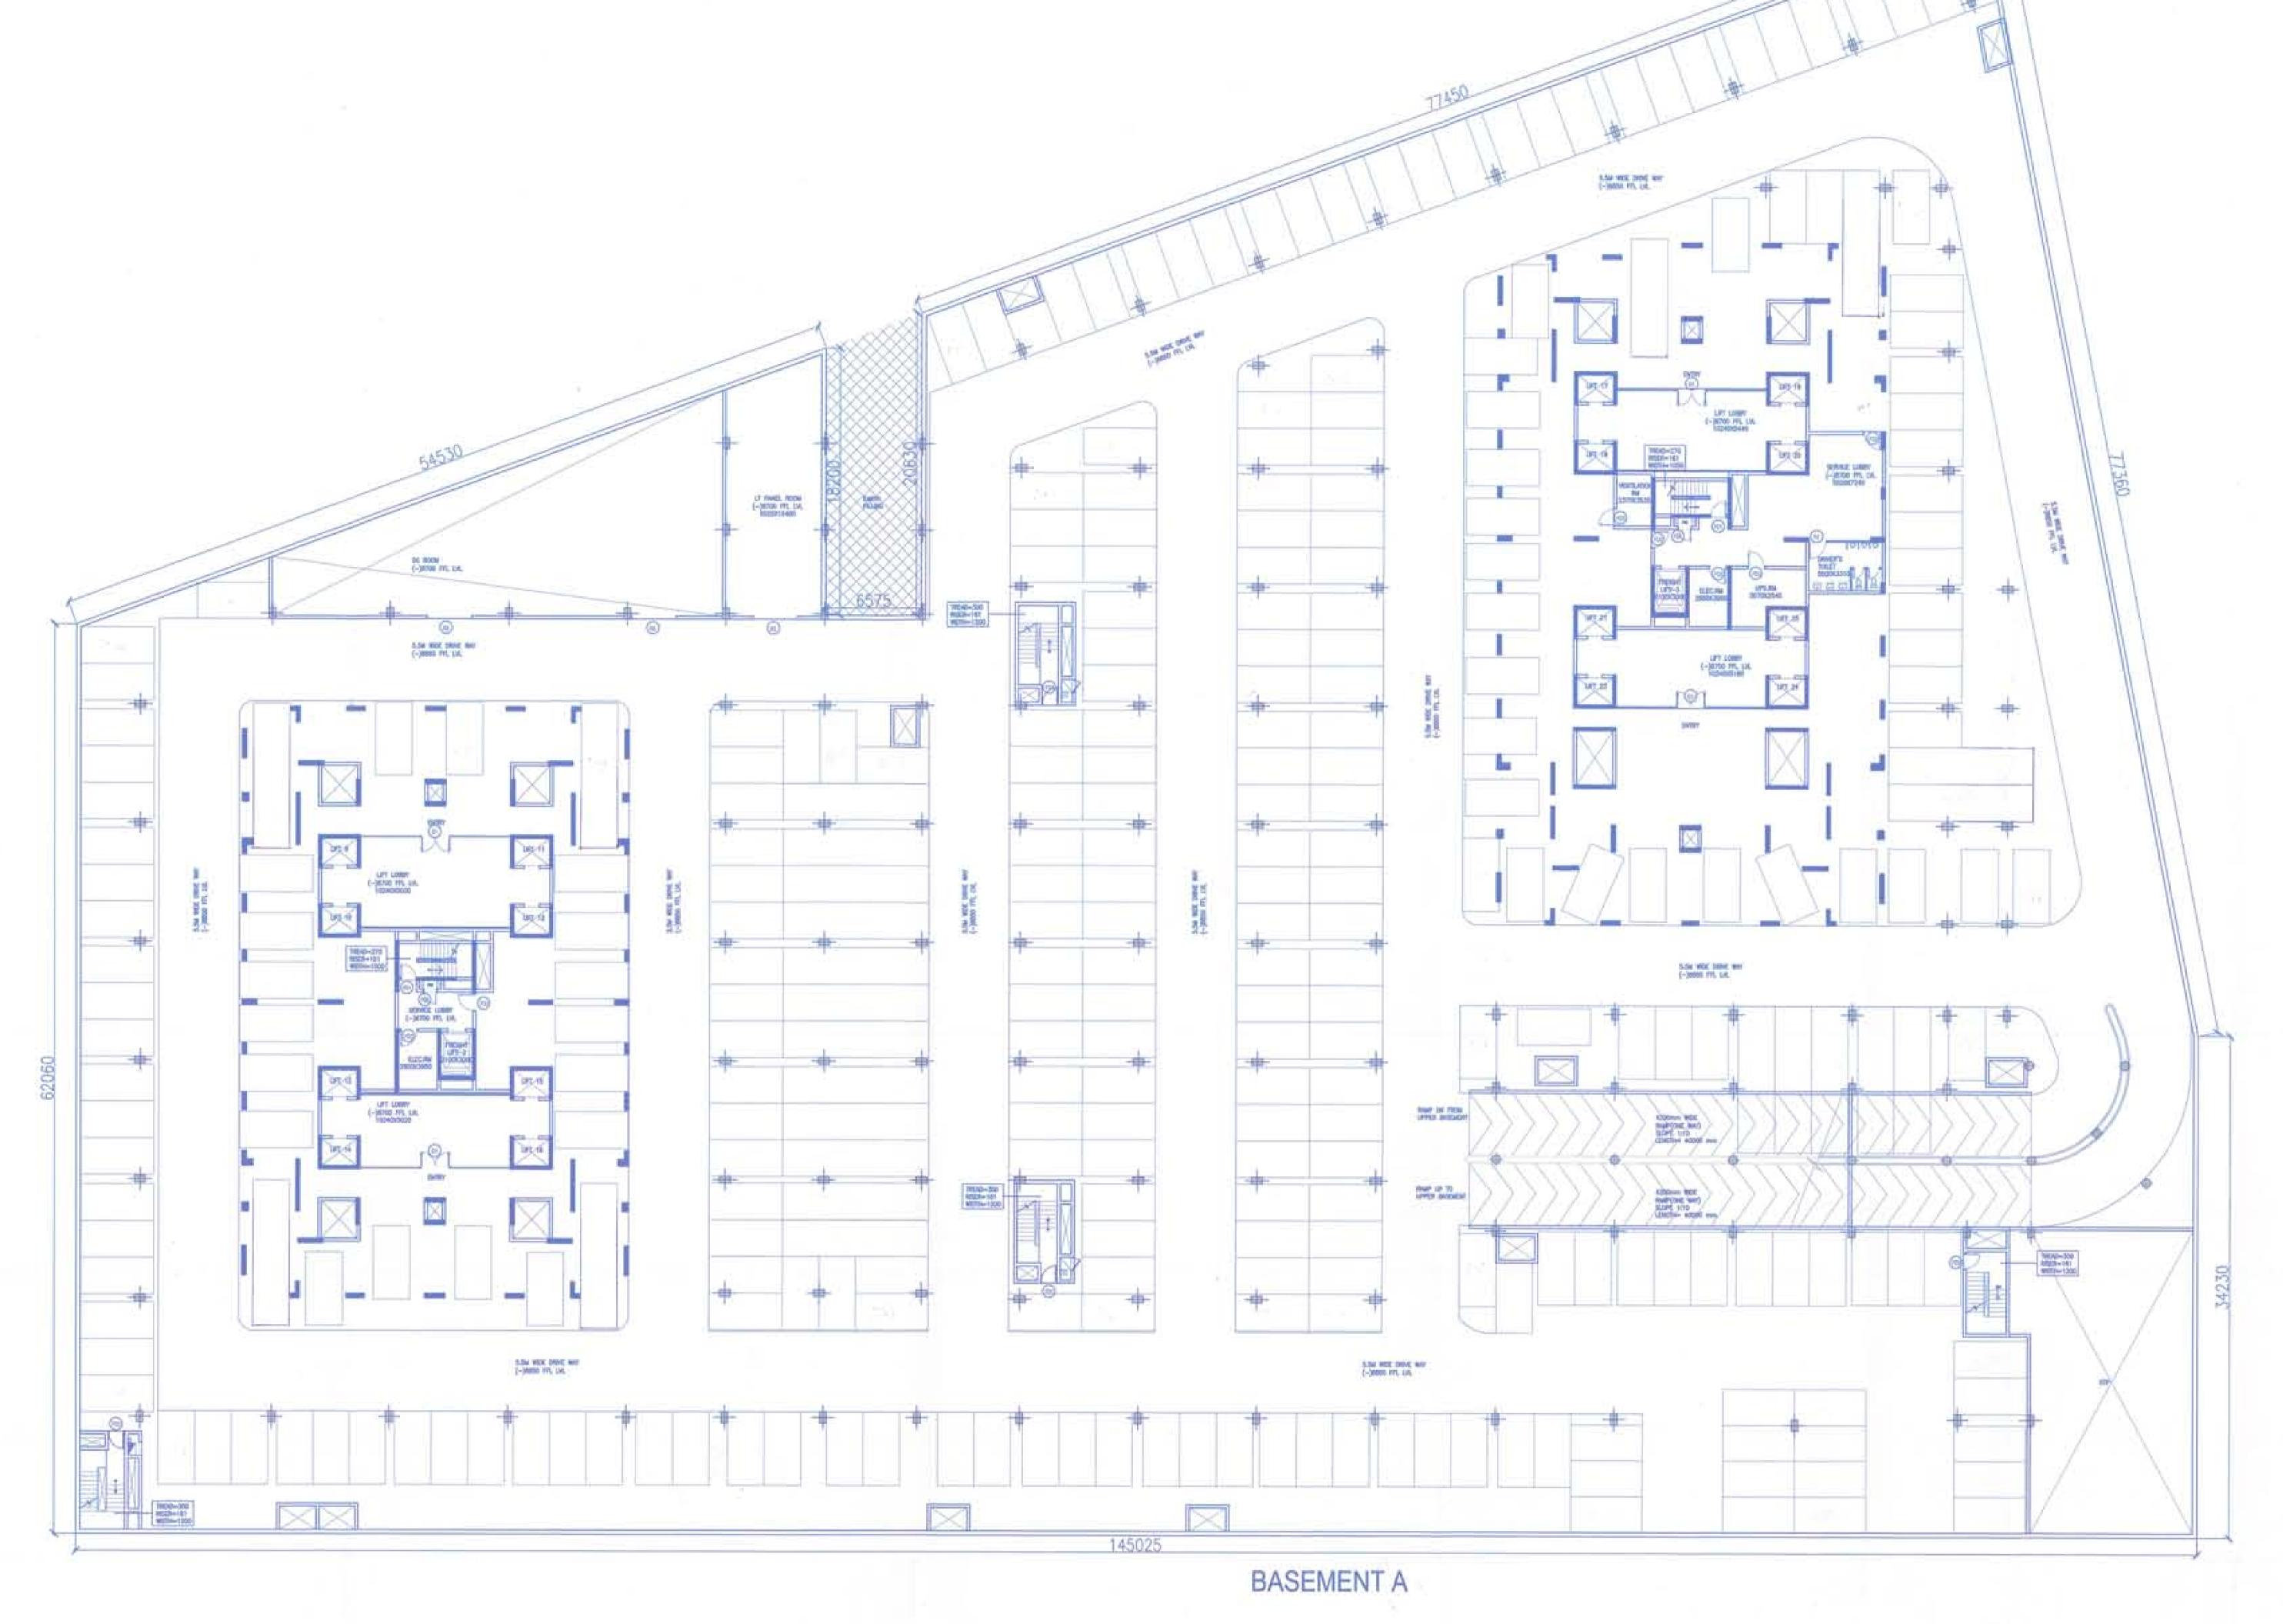

OI LOWER BASEMENT FLOOR PLAN @ -8700 LVL. SCALE 1:200

PARKING CALCULATIONS LOWER BASEMENT(A&B)

BASEMENT AREA = 17526.686 DEDUCTIONS = 2135.213 PARKING AREA = 15391.455 ECS @ 35 SQM / CAR = 439 PROPOSED = 410 CARS

1) ALL FIXTURE PROVIDED IN TOILETS ARE AS PER N.B.C.

2) BASEMENT WILL BE ARTIFICIALLY VENTILATED. 3) ALL SPACES (PARKING BASEMENT, SERVICES BASEMENT ETC.) WILL BE

ARTIFICIALLY LIT. 4) STANDBY GENERATING CAPACITY WILL BE PROVIDED FOR THE ELECTRICAL REQUIREMENT OF THE TOTAL SCHEME. THIS THEREFORE INCLUDES STANDBY GENERATION FOR ALL COMMON SERVICES, FIRE SERVICES, LIFTS ETC. AND ALSO THE ENTIRE ELECTRICAL LOAD FOR THE VENTILATION.

INCLUDES SMOKE DETECTOR , HEAT DETECTOR, SPRINKLER SPACING IN COMPLIANCE WITH CODE


Ayro ONIZED BAISEN OF XPERTS PVT.



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Consulting MEP

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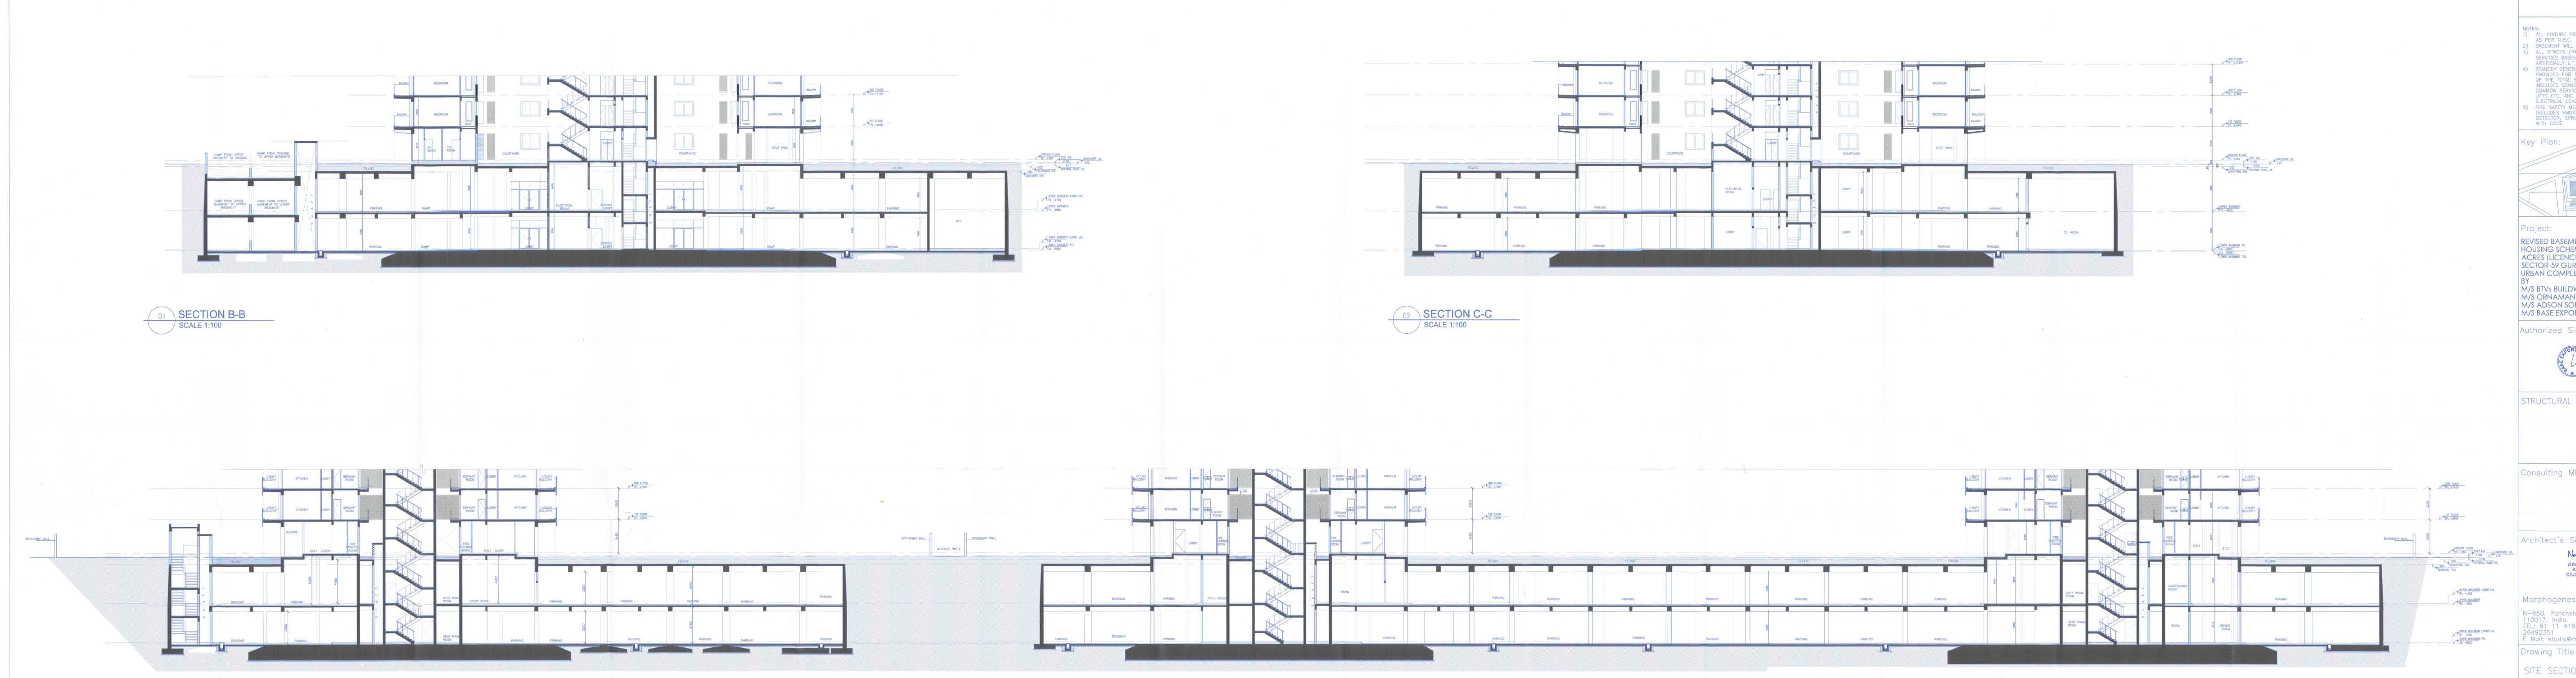
Morphogenesis

N-85B, Panchsheel Park, New Delhi,
110017, India.
TEL: 91 11 41828070 FAX: 91 11
26490351
E Mail: studio@morphogenesis.org

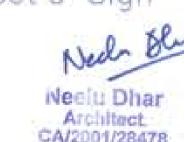Drawing Title

LOWER BASEMENT FLOOR PLAN & PARKING AREA CALCULATION:

Drawing No. BS-06/06 JAN '16



1) ALL FIXTURE PROVIDED IN TOILETS ARE
AS PER N.B.C.

2) BASEMENT WILL BE ARTIFICIALLY VENTILATED.

3) ALL SPACES (PARKING BASEMENT,
SERVICES BASEMENT ETC.) WILL BE
ARTIFICIALLY LIT.

4) STANDBY GENERATING CAPACITY WILL BE
PROVIDED FOR THE ELECTRICAL REQUIREMENT
OF THE TOTAL SCHEME, THIS THEREFORE
INCLUDES STANDBY GENERATION FOR ALL
COMMON SERVICES, FIRE SERVICES,
LIETS FTC. AND ALSO THE ENTIRE


LIFTS ETC. AND ALSO THE ENTIRE ELECTRICAL LOAD FOR THE VENTILATION. 5) FIRE SAFETY MEASURES AS PER NBC INCLUDES SMOKE DETECTOR, HEAT DETECTOR, SPRINKLER SPACING IN COMPLIANCE


REVISED BASEMENT PLAN IN GROUP HOUSING SCHEME MEASURING 17.55 ACRES (LICENCE NO. 16 OF 2008) IN SECTOR-59 GURGAON MANESAR URBAN COMPLEX BEING DEVELOPED

M/S BTVs BUILDWELL PVT. LTD.
M/S ORNAMANTAL REALTORS PVT. LTD.
M/S ADSON SOFTWARE PVT. LTD. C/O
M/S BASE EXPORTS PVT. LTD.



STRUCTURAL CONSULTANT

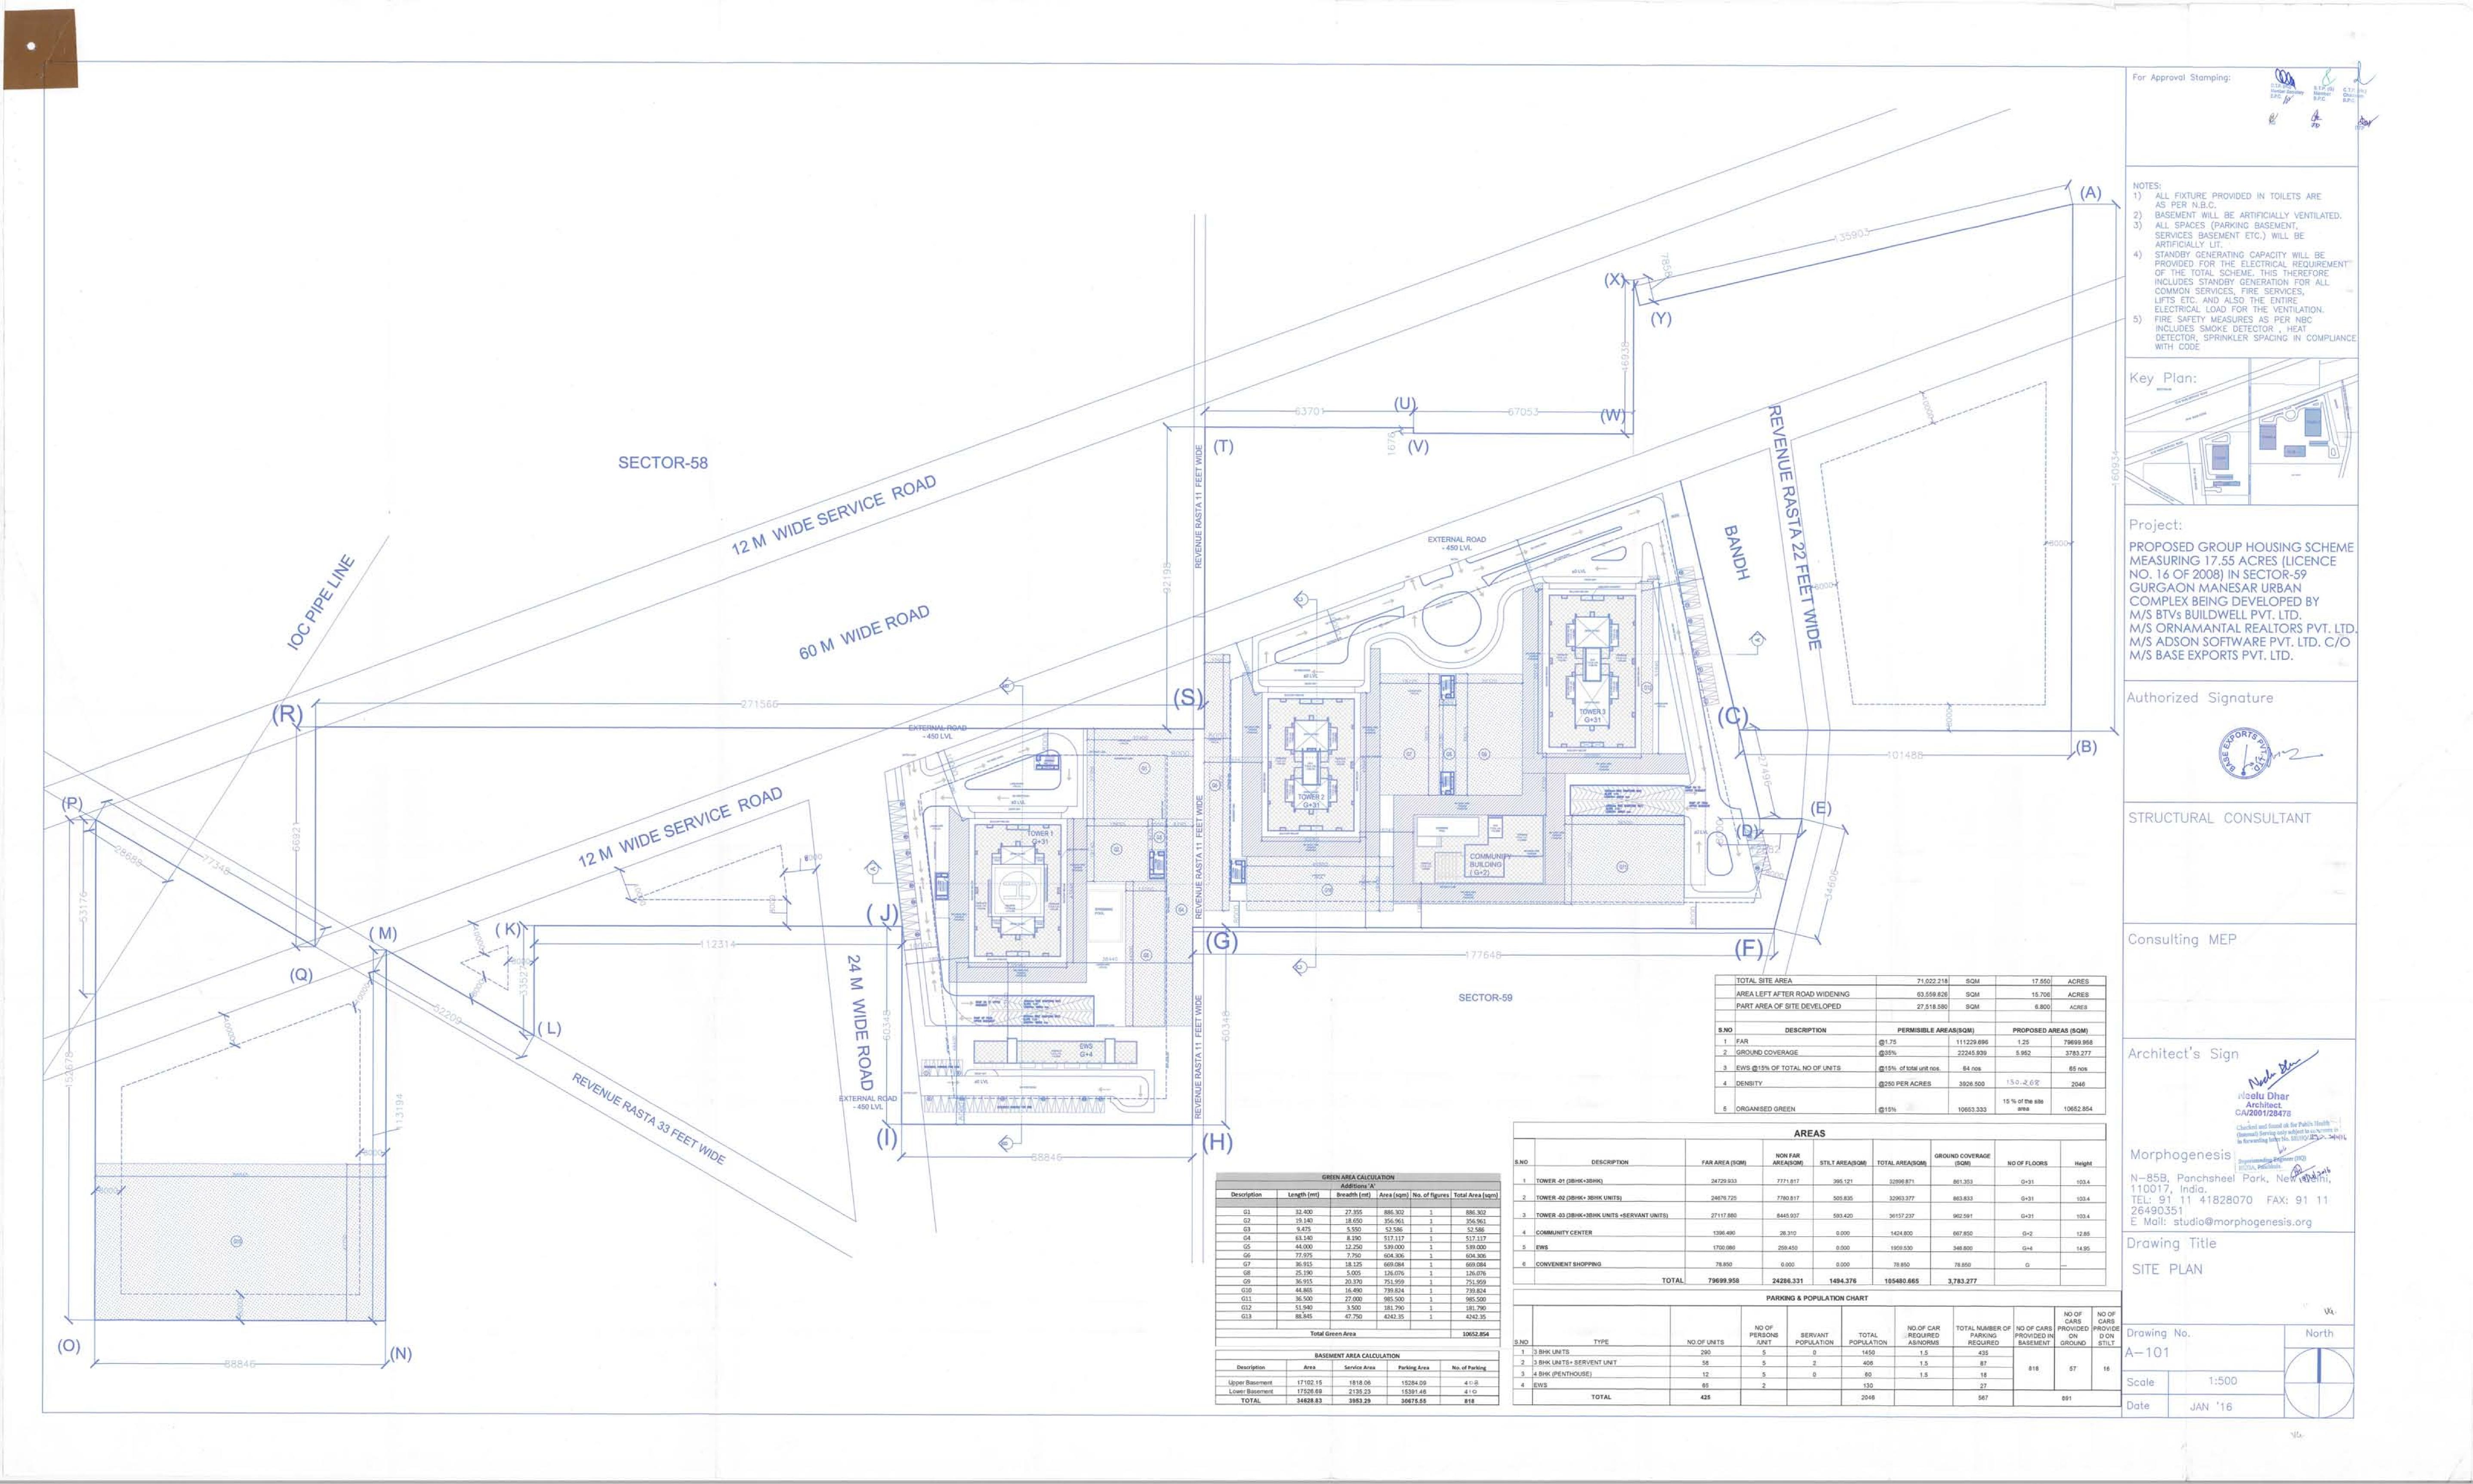


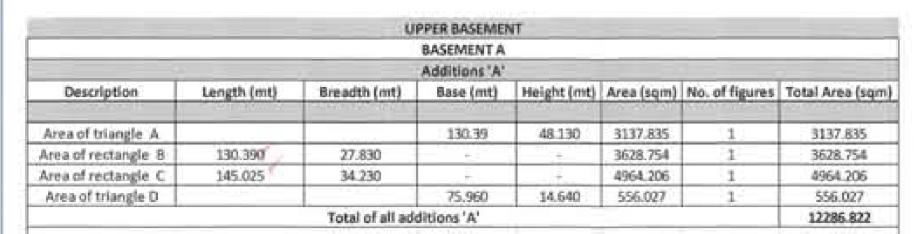


Additions 'B' Description Length (mt) Breadth (mt) Base (mt) Height (mt) Area (sqm) No. of figures Total Area (sqm) 82.695 42.455 3510.816 1 27.595 10.185 140.528 Area of triangle G Area of rectangle H 4.280 135.485 Area of rectangle J 11.015 118.822 Area of object K Total of all additions 'B'

			Deductions				
Description	Length (mt)	Breadth (mt)	Base (mt)	Height (mt)	Area (sqm)	No. of figures	Total Area (sqm)
Area of triangle A	Season Supplied to	The state of the s	30.825	11.38	175,39	1	175.39
Area of rectangle B'	30.825	4.010			123.61	1	123.61
Area of rectangle C	20.700	11.065	-		229.05	1	229.05
Area of rectangle D'	7,100	1.455			10.33	1	10.33
Area of rectangle E	2.575	2.500			6.44	9	57.94
Area of rectangle F	3.695	2.500		12	9.24	2	18.48
Area of rectangle G	32.045	1.500			48.07	1	48.07
		Total of all Ded	luctions 'C'				662.86


		UPPER BA	SEMENT - SERV	ICE AREA						
Additions 'E'										
Description	Length (mt)	Breadth (mt)	Base (mt)	Height (mt)	Area (sqm)	No. of figures	Total Area (sqr			
Area of rectangle 1	13.140	5.850		-	76.869	1	76.869			
Area of rectangle 2	8.970	3.535	H.3	-	31.709	1	31.709			
Area of rectangle 3	13.340	5.285	-		70.502	1	70.502			
Area of rectangle 4	16.040	6.985	-		112.039	11	112.039			
Area of rectangle 5	10.520	2.900	-	-	30.508	1	30.508			
Area of rectangle 6	11.975	5.220			62.510	15	62.510			
Area of rectangle 7	2.900	1.135	-		3.292	1	3.292			
Area of rectangle 8	1.470	0.435			0.639	11	0.639			
Area of rectangle 9	7.960	3.500			27.860	-1	27,860			
Area of rectangle 10	6.780	3.905			26.476	1	26.476			
Area of rectangle 11	32.345	6.300	-	-	203.774	1	203.774			
Area of rectangle 12	8.300	4,445	-	2-	36.894	1	36.894			
Area of rectangle 13	10.240	5,435		-	55.654	1	55.654			
Area of rectangle 14	9.235	8.970		1.0	82.838	1	82.838			
Area of rectangle 15	16.040	6.985			112.039	1	112.039			
Area of rectangle 16	15.805	2.900			45.835	1	45.835			
Area of rectangle 17	6.985	2.900			20.257	1	20.257			
Area of rectangle 18	5.285	1.470	-	13-11	7,769	1	7.769			
Area of rectangle 19	6.780	4.205			28.510	1	28.510			
Area of triangle 20	- 1		13.900	5.130	35.654	1	35.654			
Area of rectangle 21	15.590	13.900	-		216,701	- 1	216.701			
Area of rectangle 22	7.010	4.105			28,776	1	28.776			
Area of rectangle 23	7.010	4.105	-		28.776	1	28.776			
Area of rectangle 24	10.240	5.845	- 80	1	59.853	1	59.853			
Area of rectangle 25	10.440	8.980	-		93.751	- 1	93.751			
Area of rectangle 26	16.040	6.985		133	112.039	1	112.039			
Area of rectangle 27	6.985	2.900	-		20.257	1	20.257			
Area of rectangle 28	15.965	2.900		-	46.299	1	46.299			
Area of rectangle 29	11.055	5.220			57,707	1	57.707			
Area of rectangle 30	7.100	3.150	4-1	12	22.365	(1)	22.365			
Area of rectangle 31	13.600	4.405			59.908	1	59.908			
	To	tal Upper Basemen	nt Service Area	'E'			1818.057			
Area of Upper Basement	(D)		_				17102.15			
Area provided for Service	the state of the s	ment (F)					1818.057			
Area provided for Parkin							15284.092			

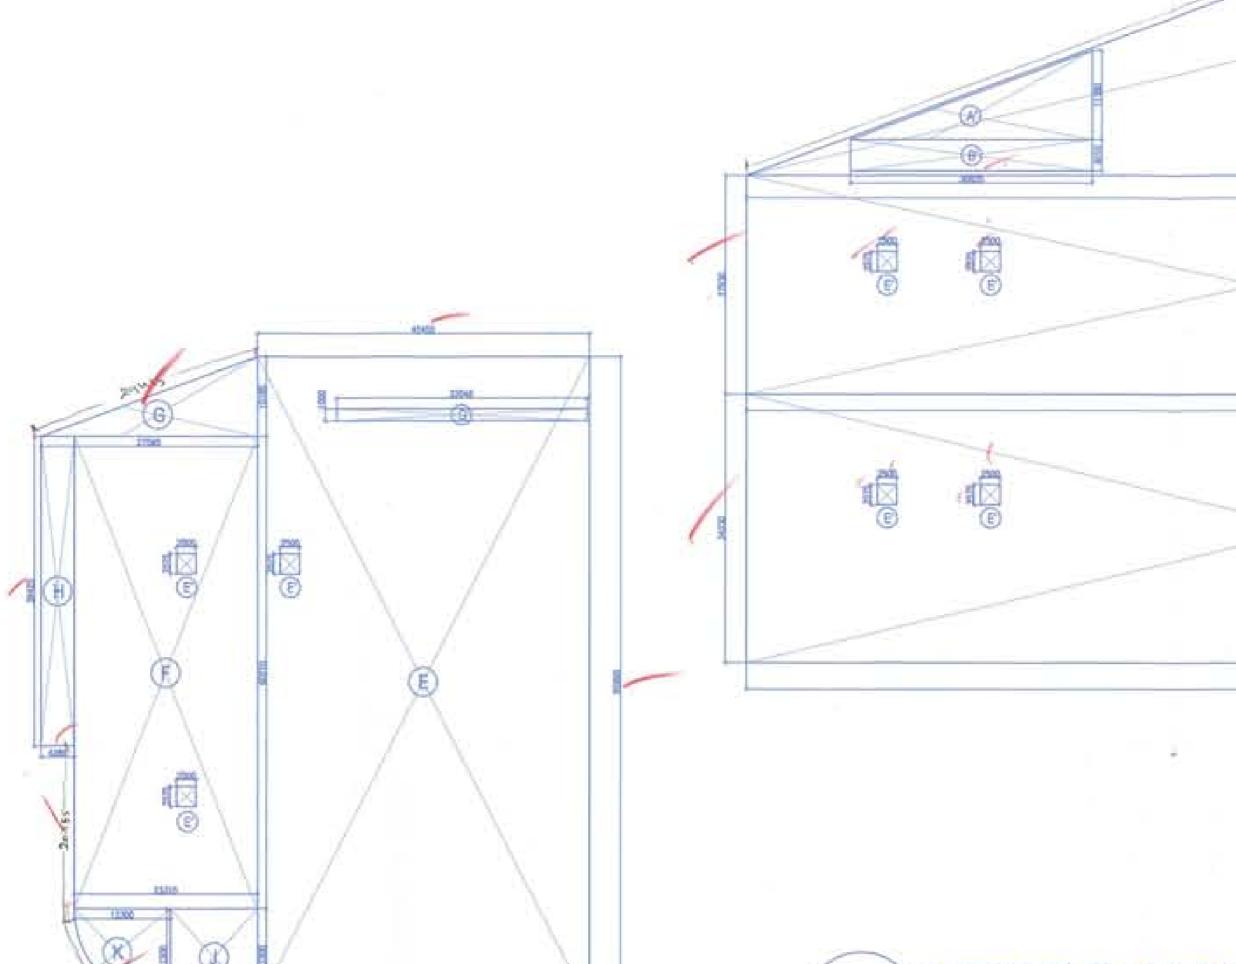

BASEMENT B

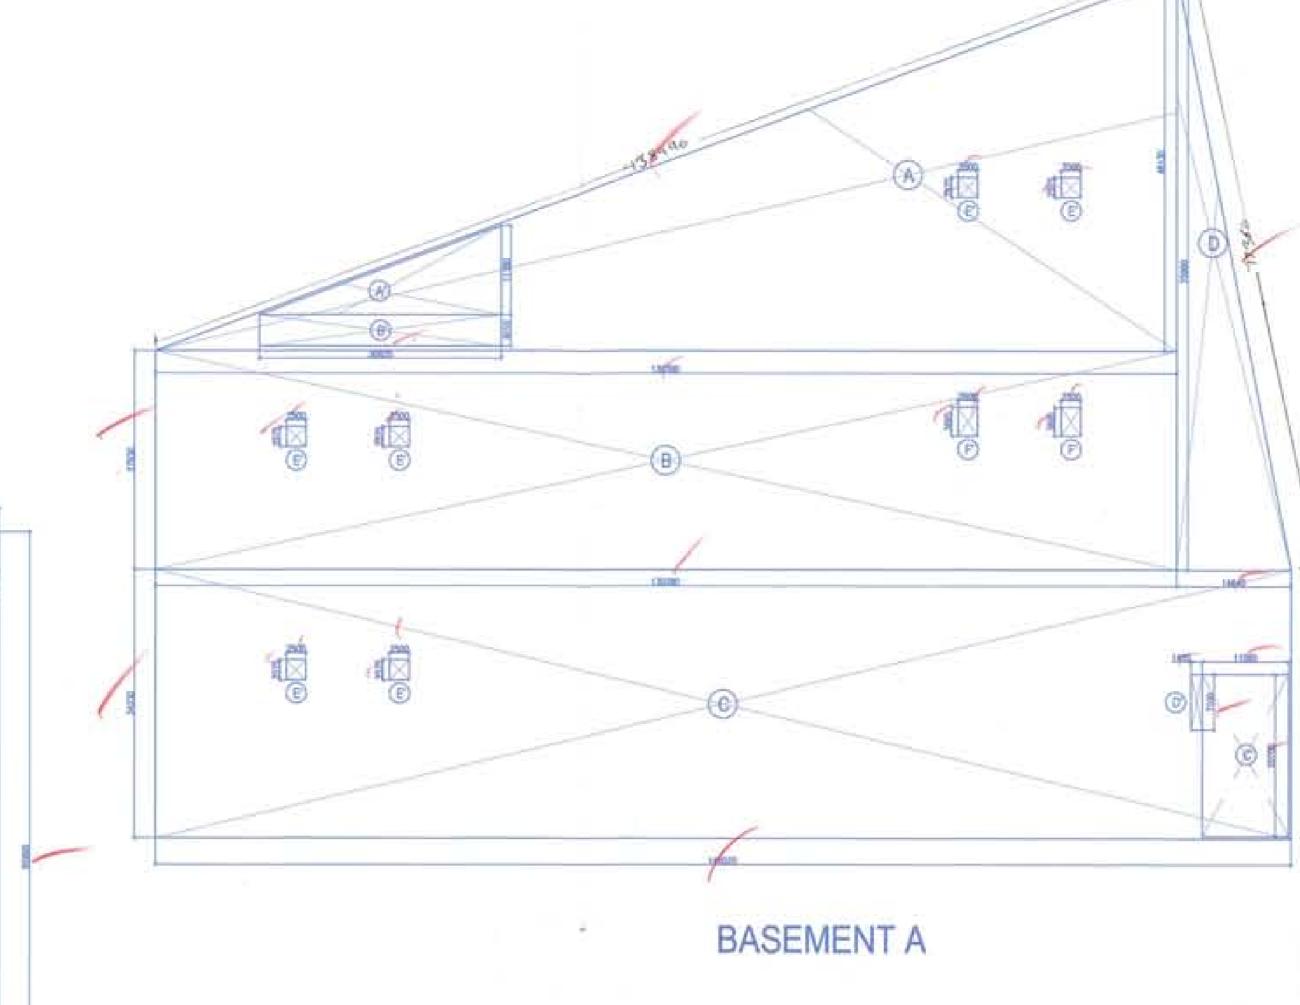

UPPER BASEMENT FLOOR- AREA CALCULATION SCALE 1:500

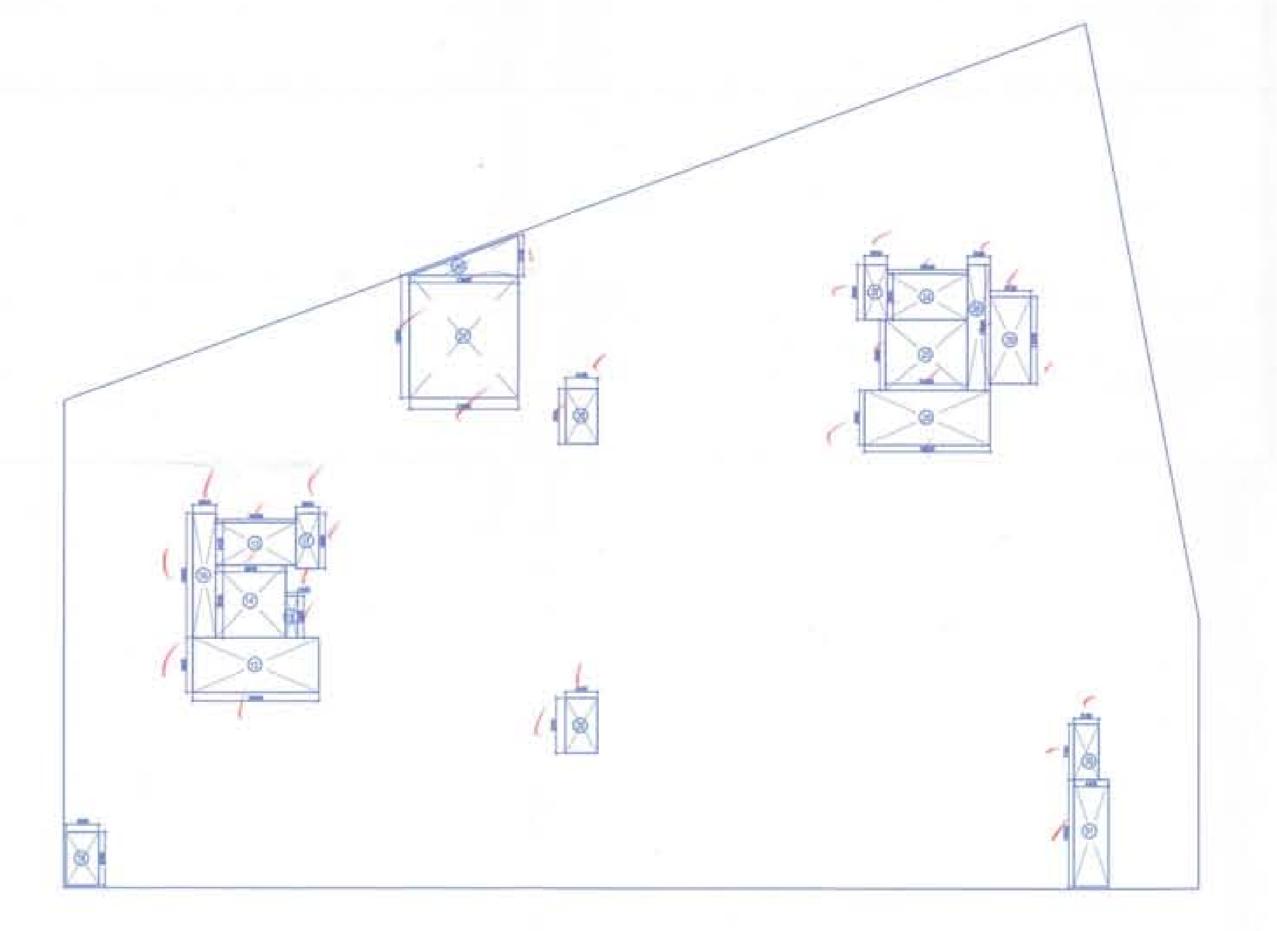


BASEMENT A

	non cours			
	H CILL LVL.	LINTEL LVL.	SIZE (HxW)	REMARK
1200 1100 1200		2400 2400 2400	2400x1200 2400x1100 2400x1200	Fire Door Fire Door
1500 1200 3000	<u> </u>	2400 2150 2750	2400x1500 2150x1200 2750x3000	Fire Door Fire Door
2000		2400	2400x2000 2400x1200	Door Door

BASEMENT B

UPPER BASEMENT -SERVICE AREA CALCULATION SCALE 1:500

For Approval Stamping:

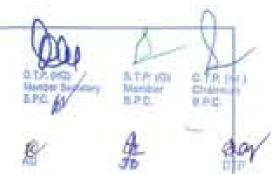

1) ALL FIXTURE PROVIDED IN TOILETS ARE AS PER N.B.C.

2) BASEMENT WILL BE ARTIFICIALLY VENTILATED. ALL SPACES (PARKING BASEMENT, SERVICES BASEMENT ETC.) WILL BE

ARTIFICIALLY LIT. 4) STANDBY GENERATING CAPACITY WILL BE PROVIDED FOR THE ELECTRICAL REQUIREMENT OF THE TOTAL SCHEME, THIS THEREFORE INCLUDES STANDBY GENERATION FOR ALL COMMON SERVICES, FIRE SERVICES, LIFTS ETC. AND ALSO THE ENTIRE

ELECTRICAL LOAD FOR THE VENTILATION. 5) FIRE SAFETY MEASURES AS PER NBC INCLUDES SMOKE DETECTOR . HEAT DETECTOR, SPRINKLER SPACING IN COMPLIANCE WITH CODE

Project:

REVISED BASEMENT PLAN IN GROUP HOUSING SCHEME MEASURING 17.55 ACRES (LICENCE NO. 16 OF 2008) IN SECTOR-59 GURGAON MANESAR URBAN COMPLEX BEING DEVELOPED BY M/S BTVs BUILDWELL PVT. LTD. M/S ORNAMANTAL REALTORS
PVT. LTD.

M/S ADSON SOFTWARE PVT. LTD EYTO OM 78 BAISE OF MPORTS PVT.



STRUCTURAL CONSULTANT

Consulting MEP

Architect's Sign




Morphogenesis

N-85B, Panchsheel Park, New Delhi, 110017, India. TEL: 91 11 41828070 FAX: 91 11 26490351 E Mail: studio@morphogenesis.org

Drawing Title

UPPER BASEMENT AREA CALCULATION:

VG. Drawing No. North BS-05.1/06 Scale JAN '16

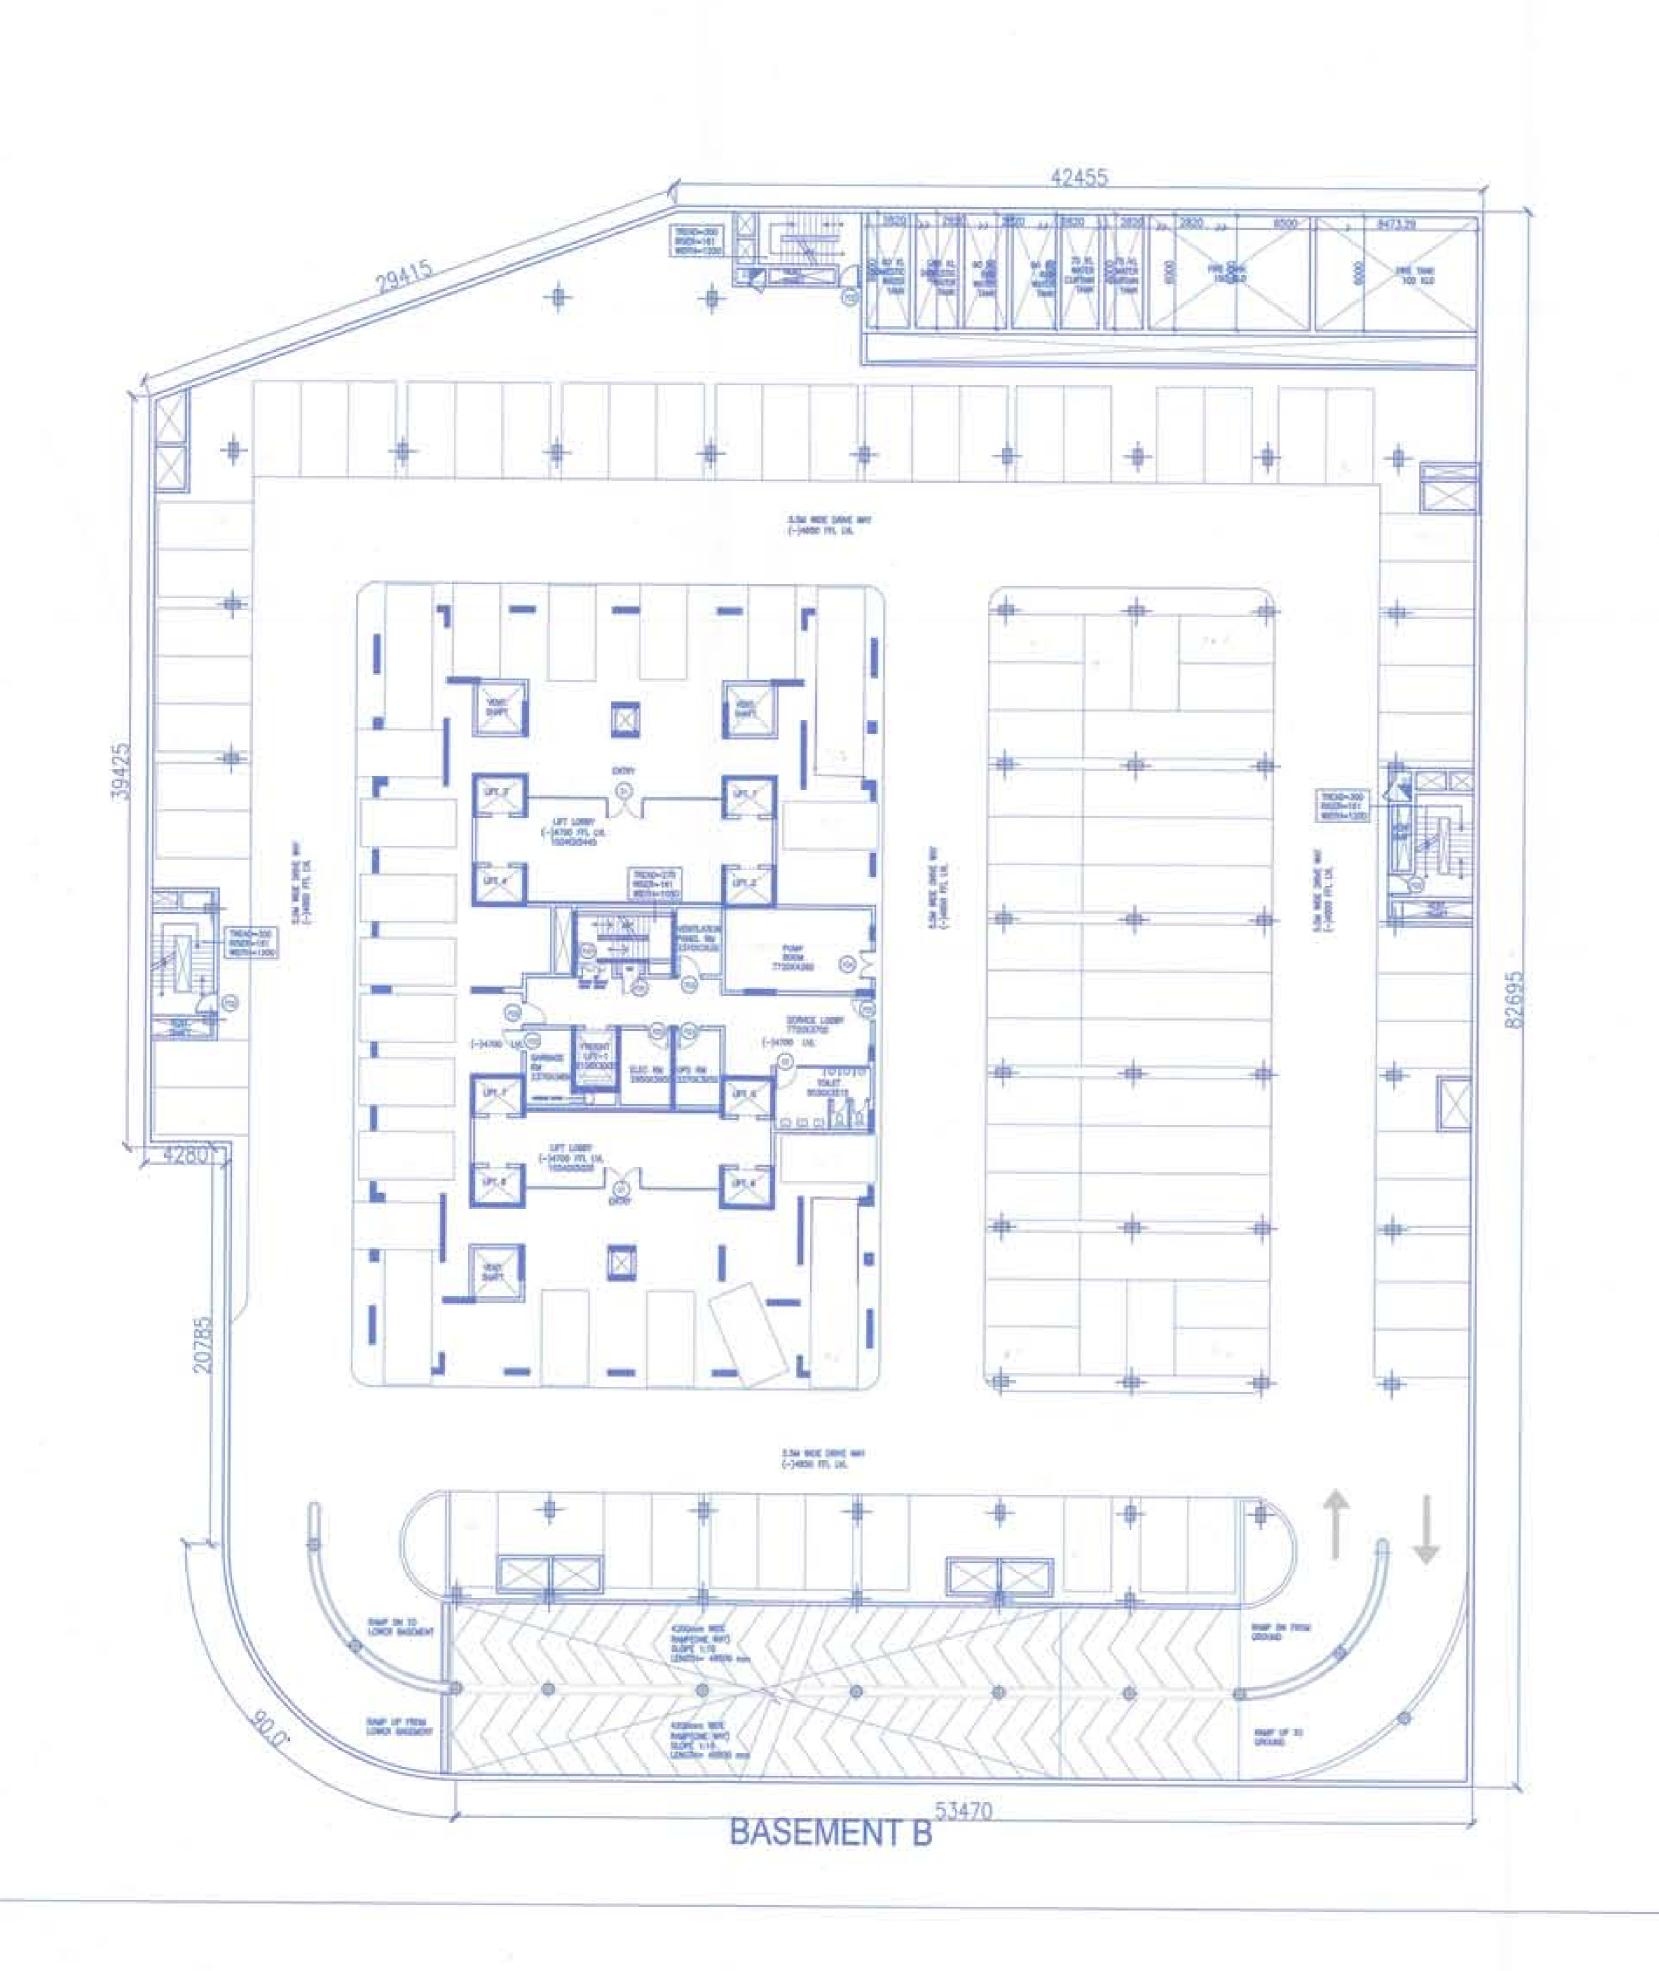



UPPER BASEMENT FLOOR PLAN @ -4700 LVL.
SCALE 1:200

PARKING CALCULATIONS UPPER BASEMENT (A&B)

BASEMENT AREA = 17102.15 **DEDUCTIONS** = 1818.057 PARKING AREA = 15284.092 ECS @ 35 SQM / CAR = 436 PROPOSED = 408 CARS

1) ALL FIXTURE PROVIDED IN TOILETS ARE AS PER N.B.C.

2) BASEMENT WILL BE ARTIFICIALLY VENTILATED. 3) ALL SPACES (PARKING BASEMENT, SERVICES BASEMENT ETC.) WILL BE

ARTIFICIALLY LIT. 4) STANDBY GENERATING CAPACITY WILL BE PROVIDED FOR THE ELECTRICAL REQUIREMENT OF THE TOTAL SCHEME. THIS THEREFORE INCLUDES STANDBY GENERATION FOR ALL COMMON SERVICES, FIRE SERVICES, LIFTS ETC. AND ALSO THE ENTIRE

ELECTRICAL LOAD FOR THE VENTILATION. 5) FIRE SAFETY MEASURES AS PER NBC INCLUDES SMOKE DETECTOR , HEAT DETECTOR, SPRINKLER SPACING IN COMPLIANCE WITH CODE



STRUCTURAL CONSULTANT

Consulting MEP

Architect's Sign


N-85B, Panchsheel Park, New Delhi, 110017, India.
TEL: 91 11 41828070 FAX: 91 11 26490351
E Mail: studio@morphogenesis.org


Drawing Title


UPPER BASEMENT FLOOR PLAN & PARKING AREA CALCULATION:


Drawing No. BS-05/06


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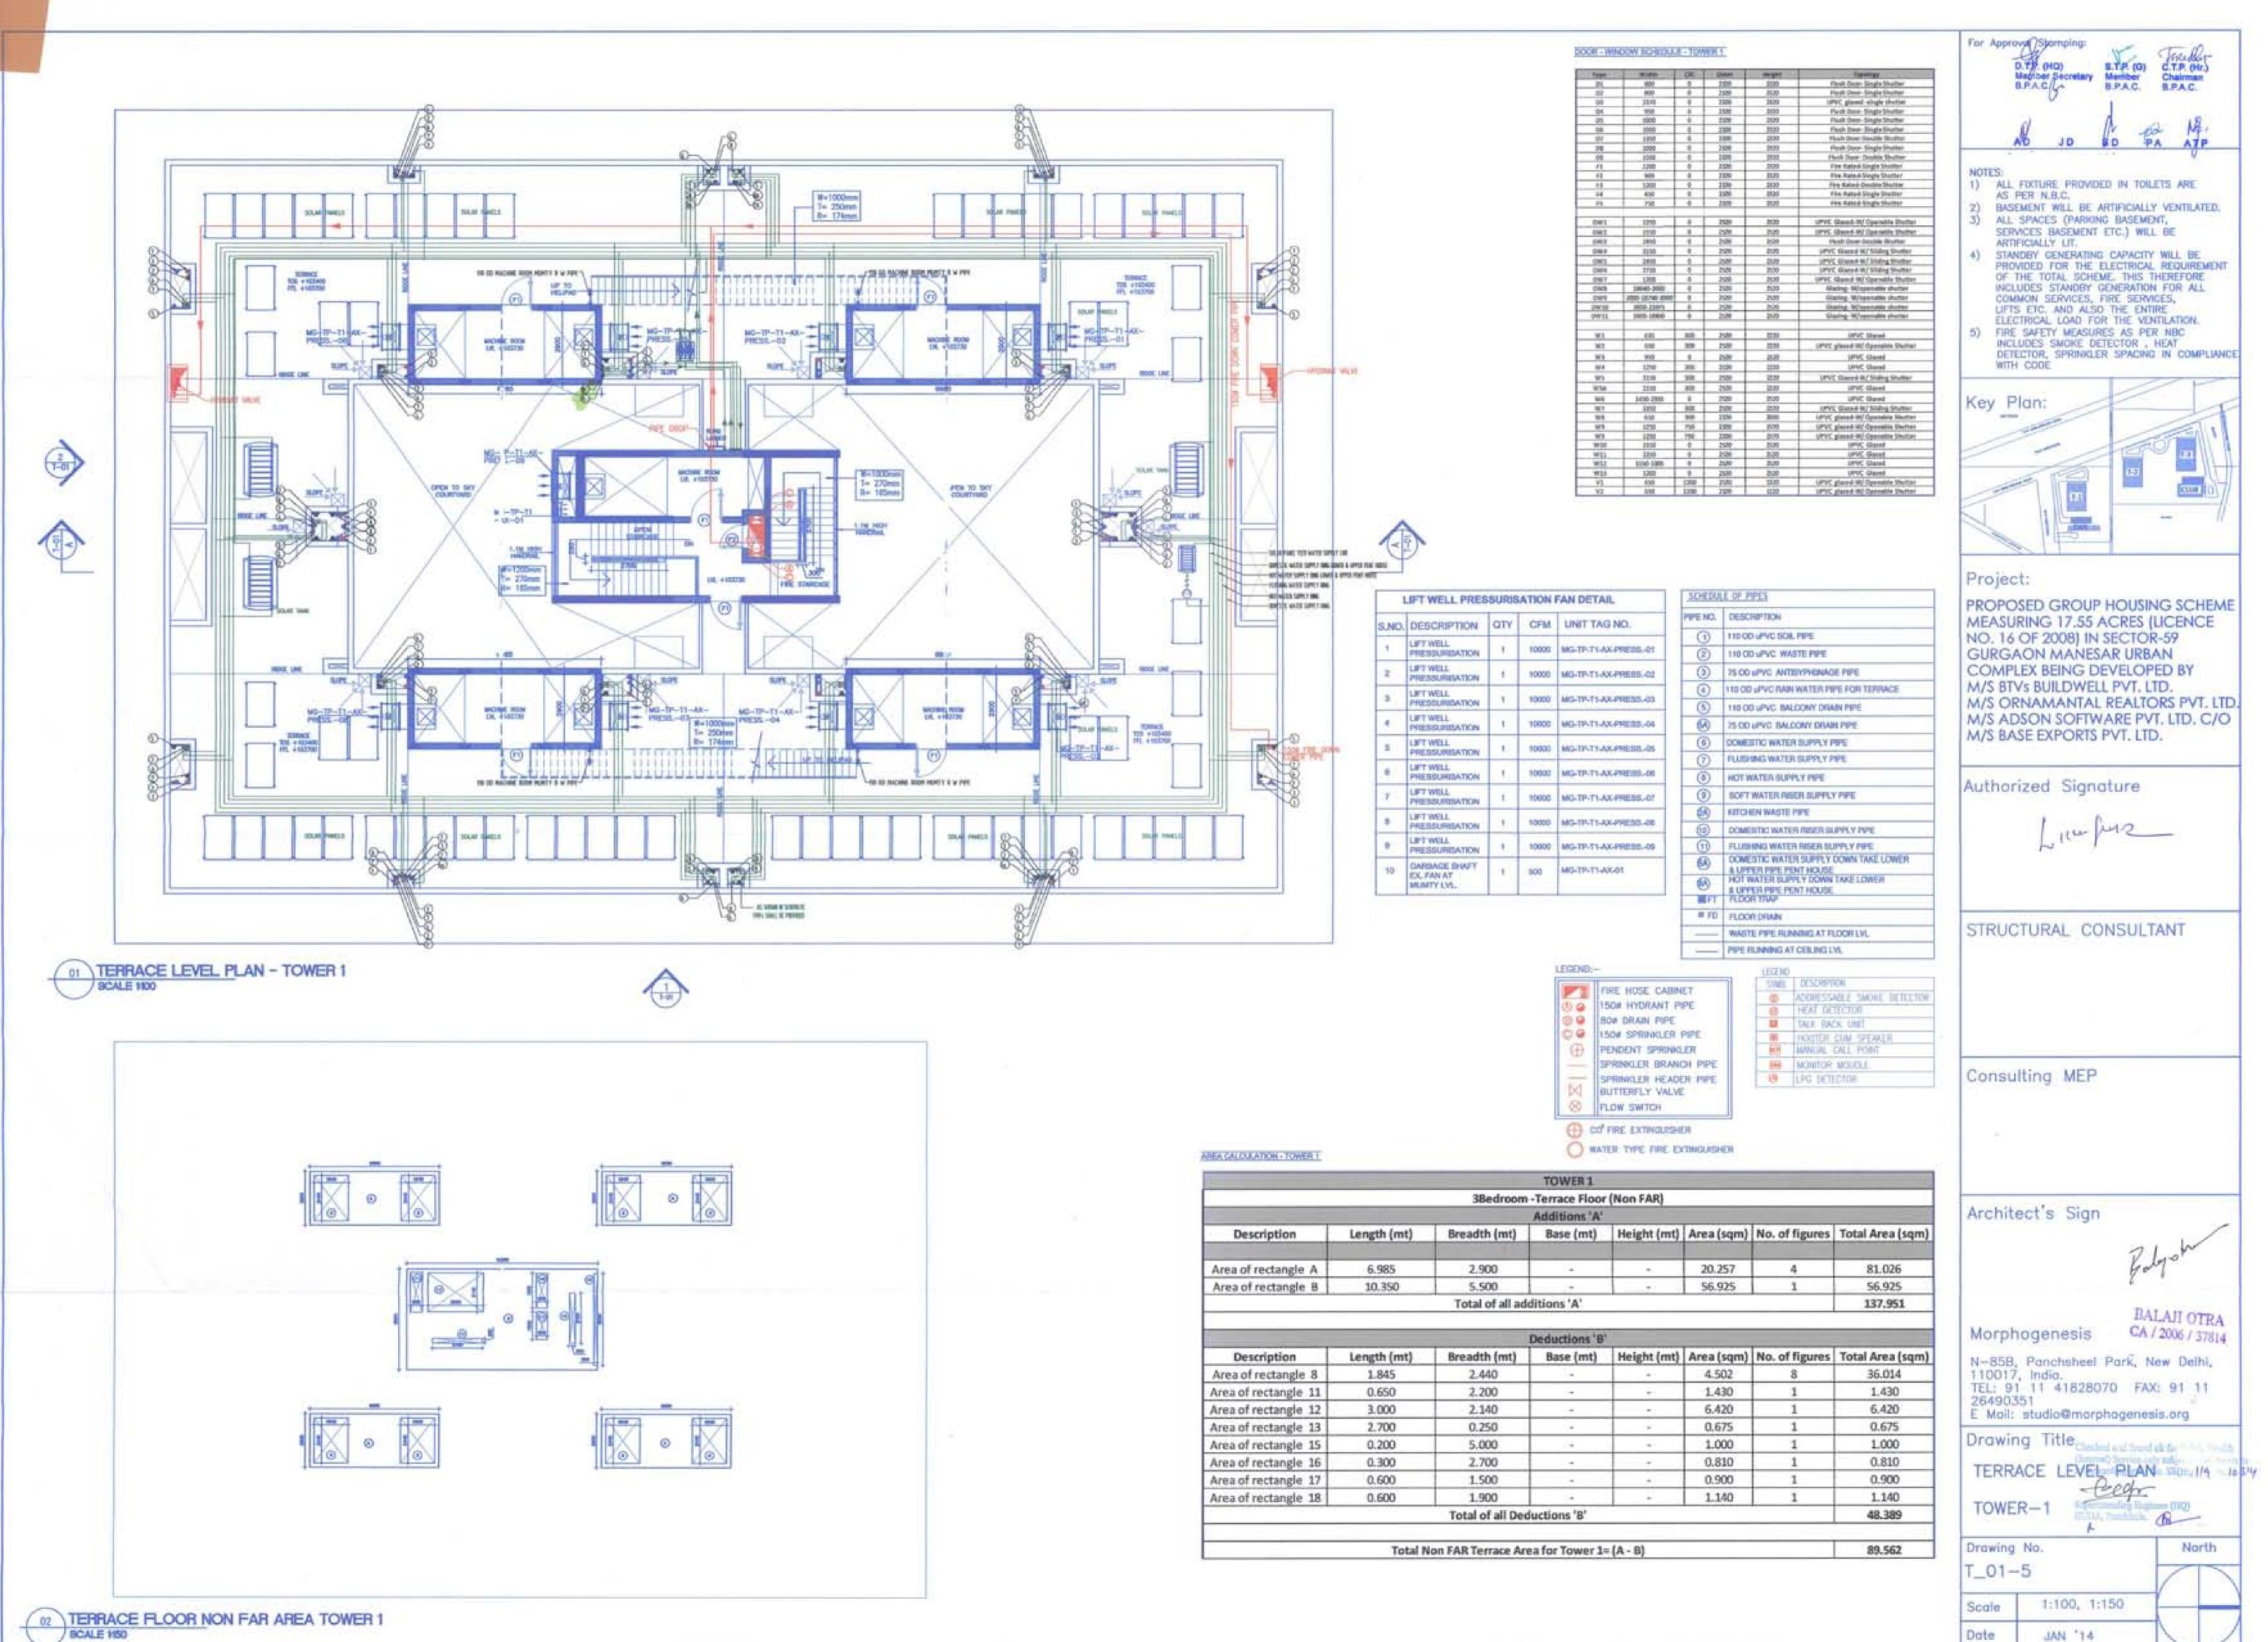


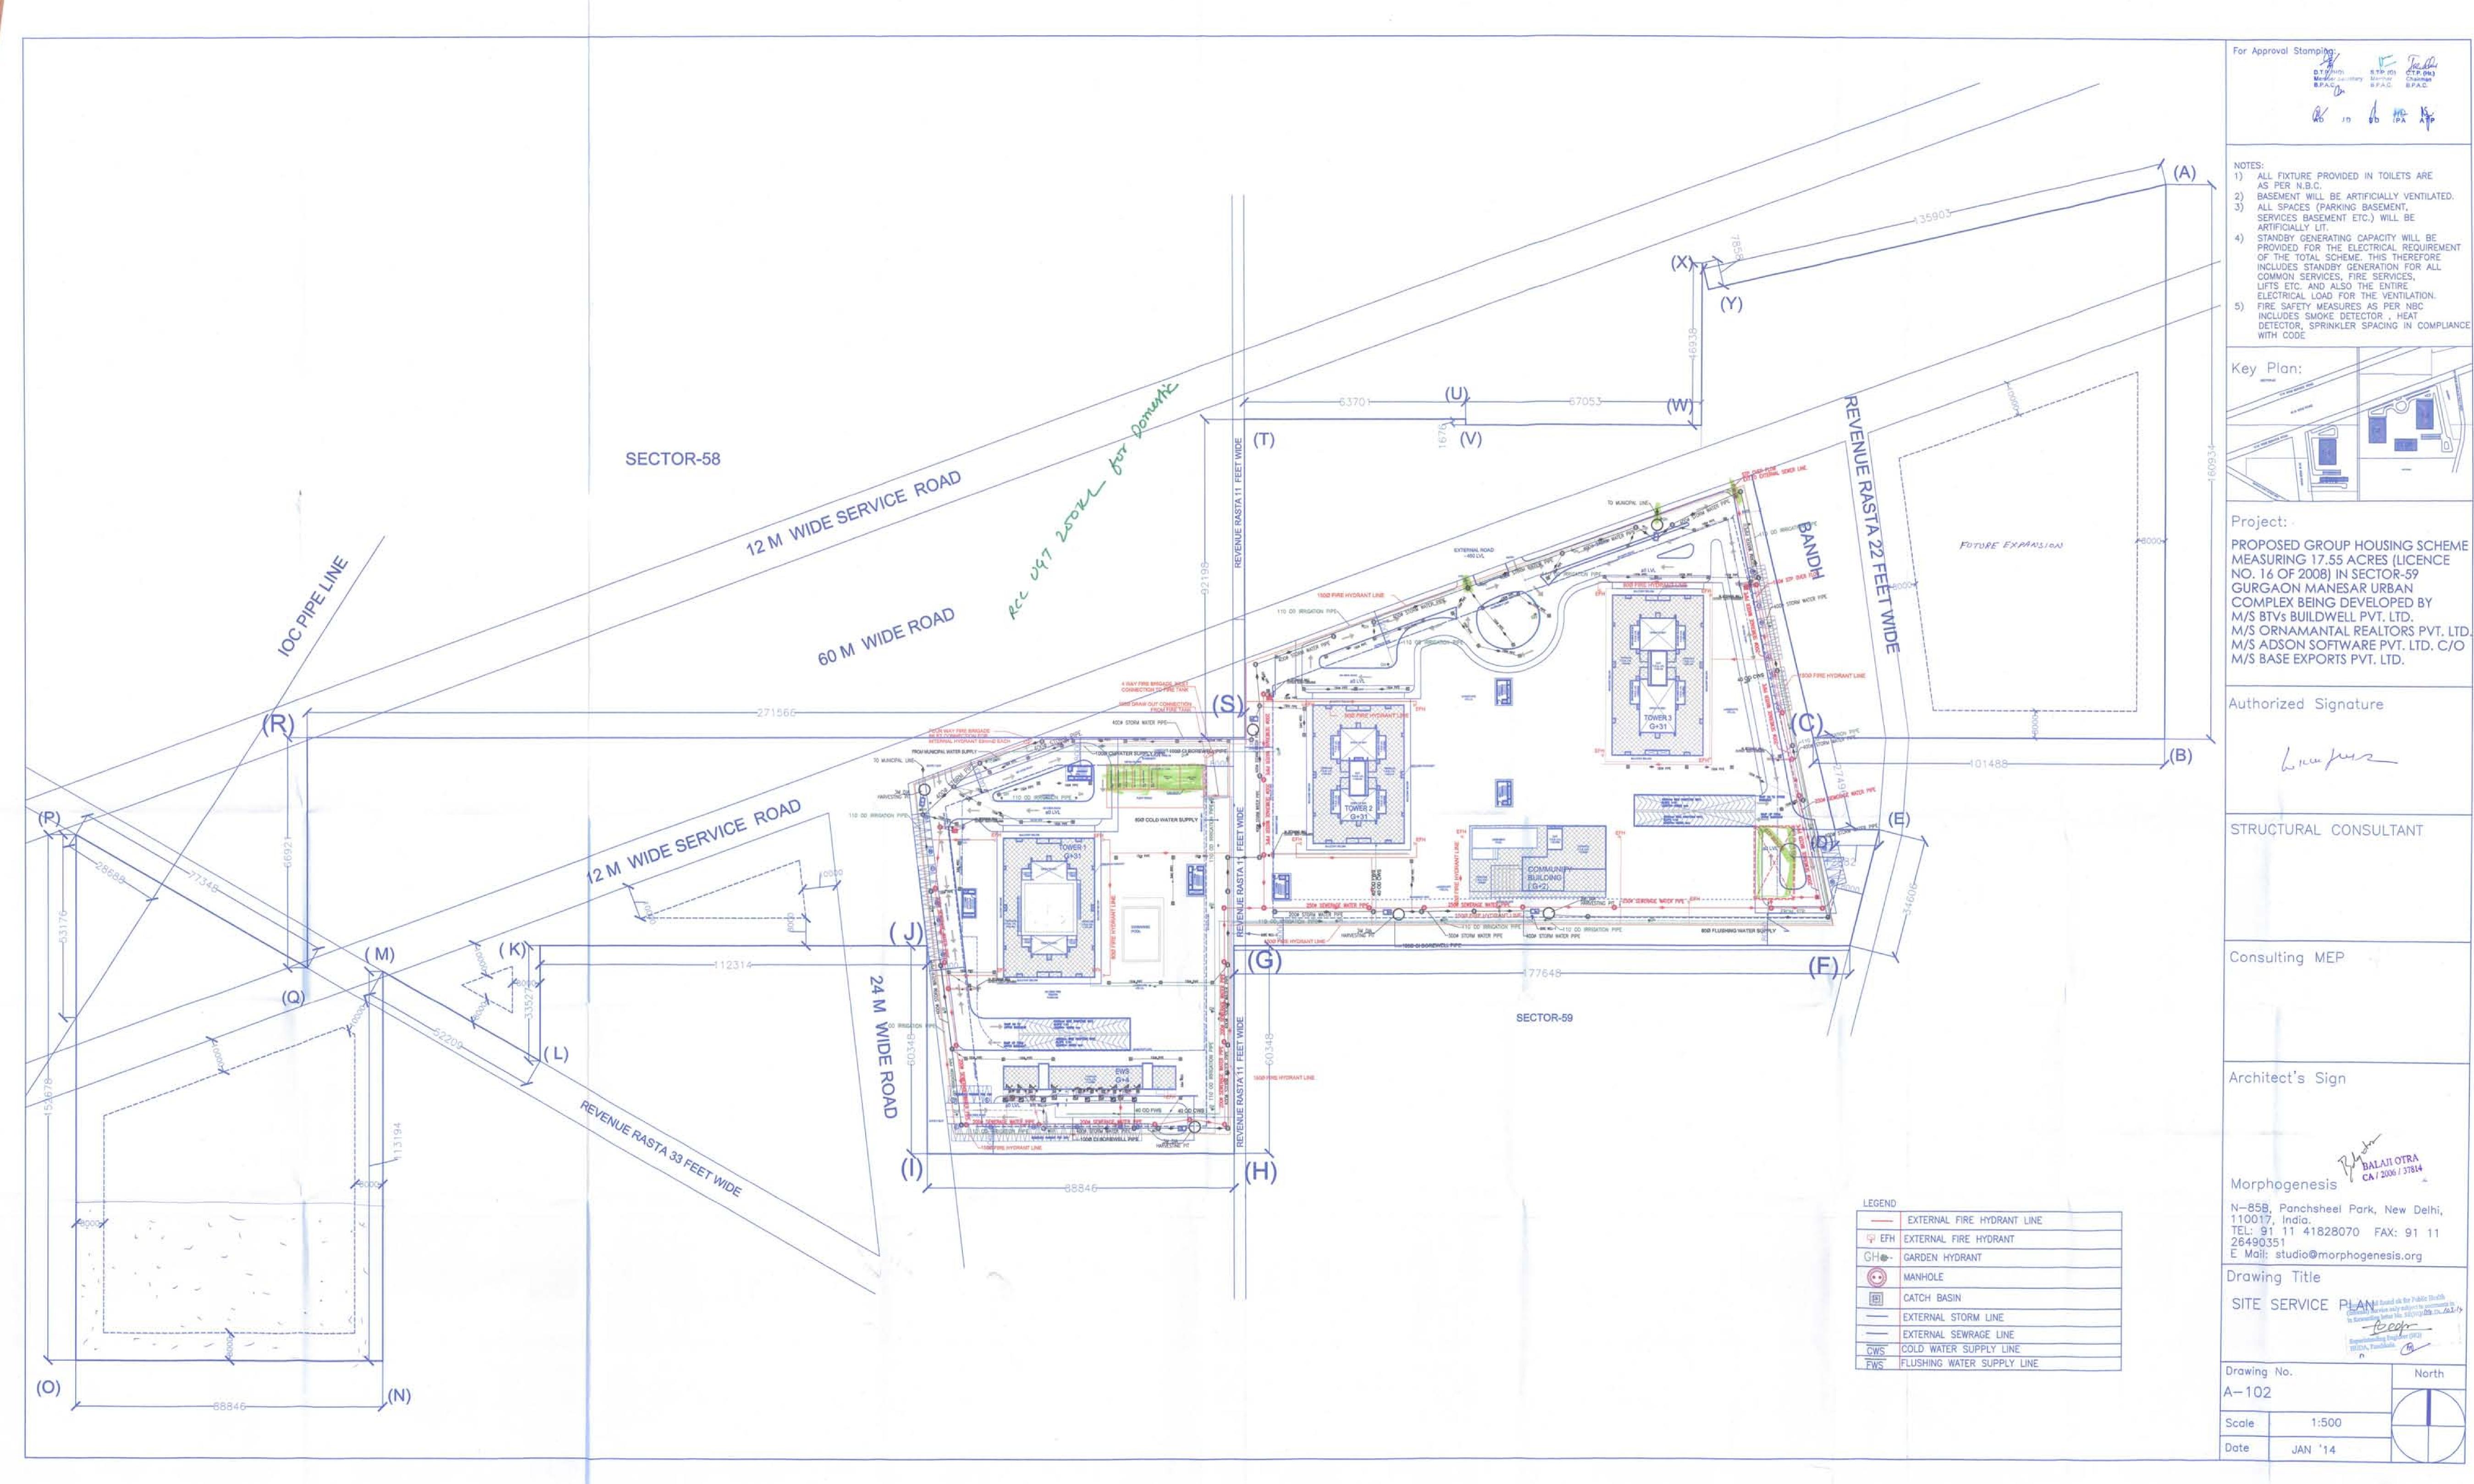


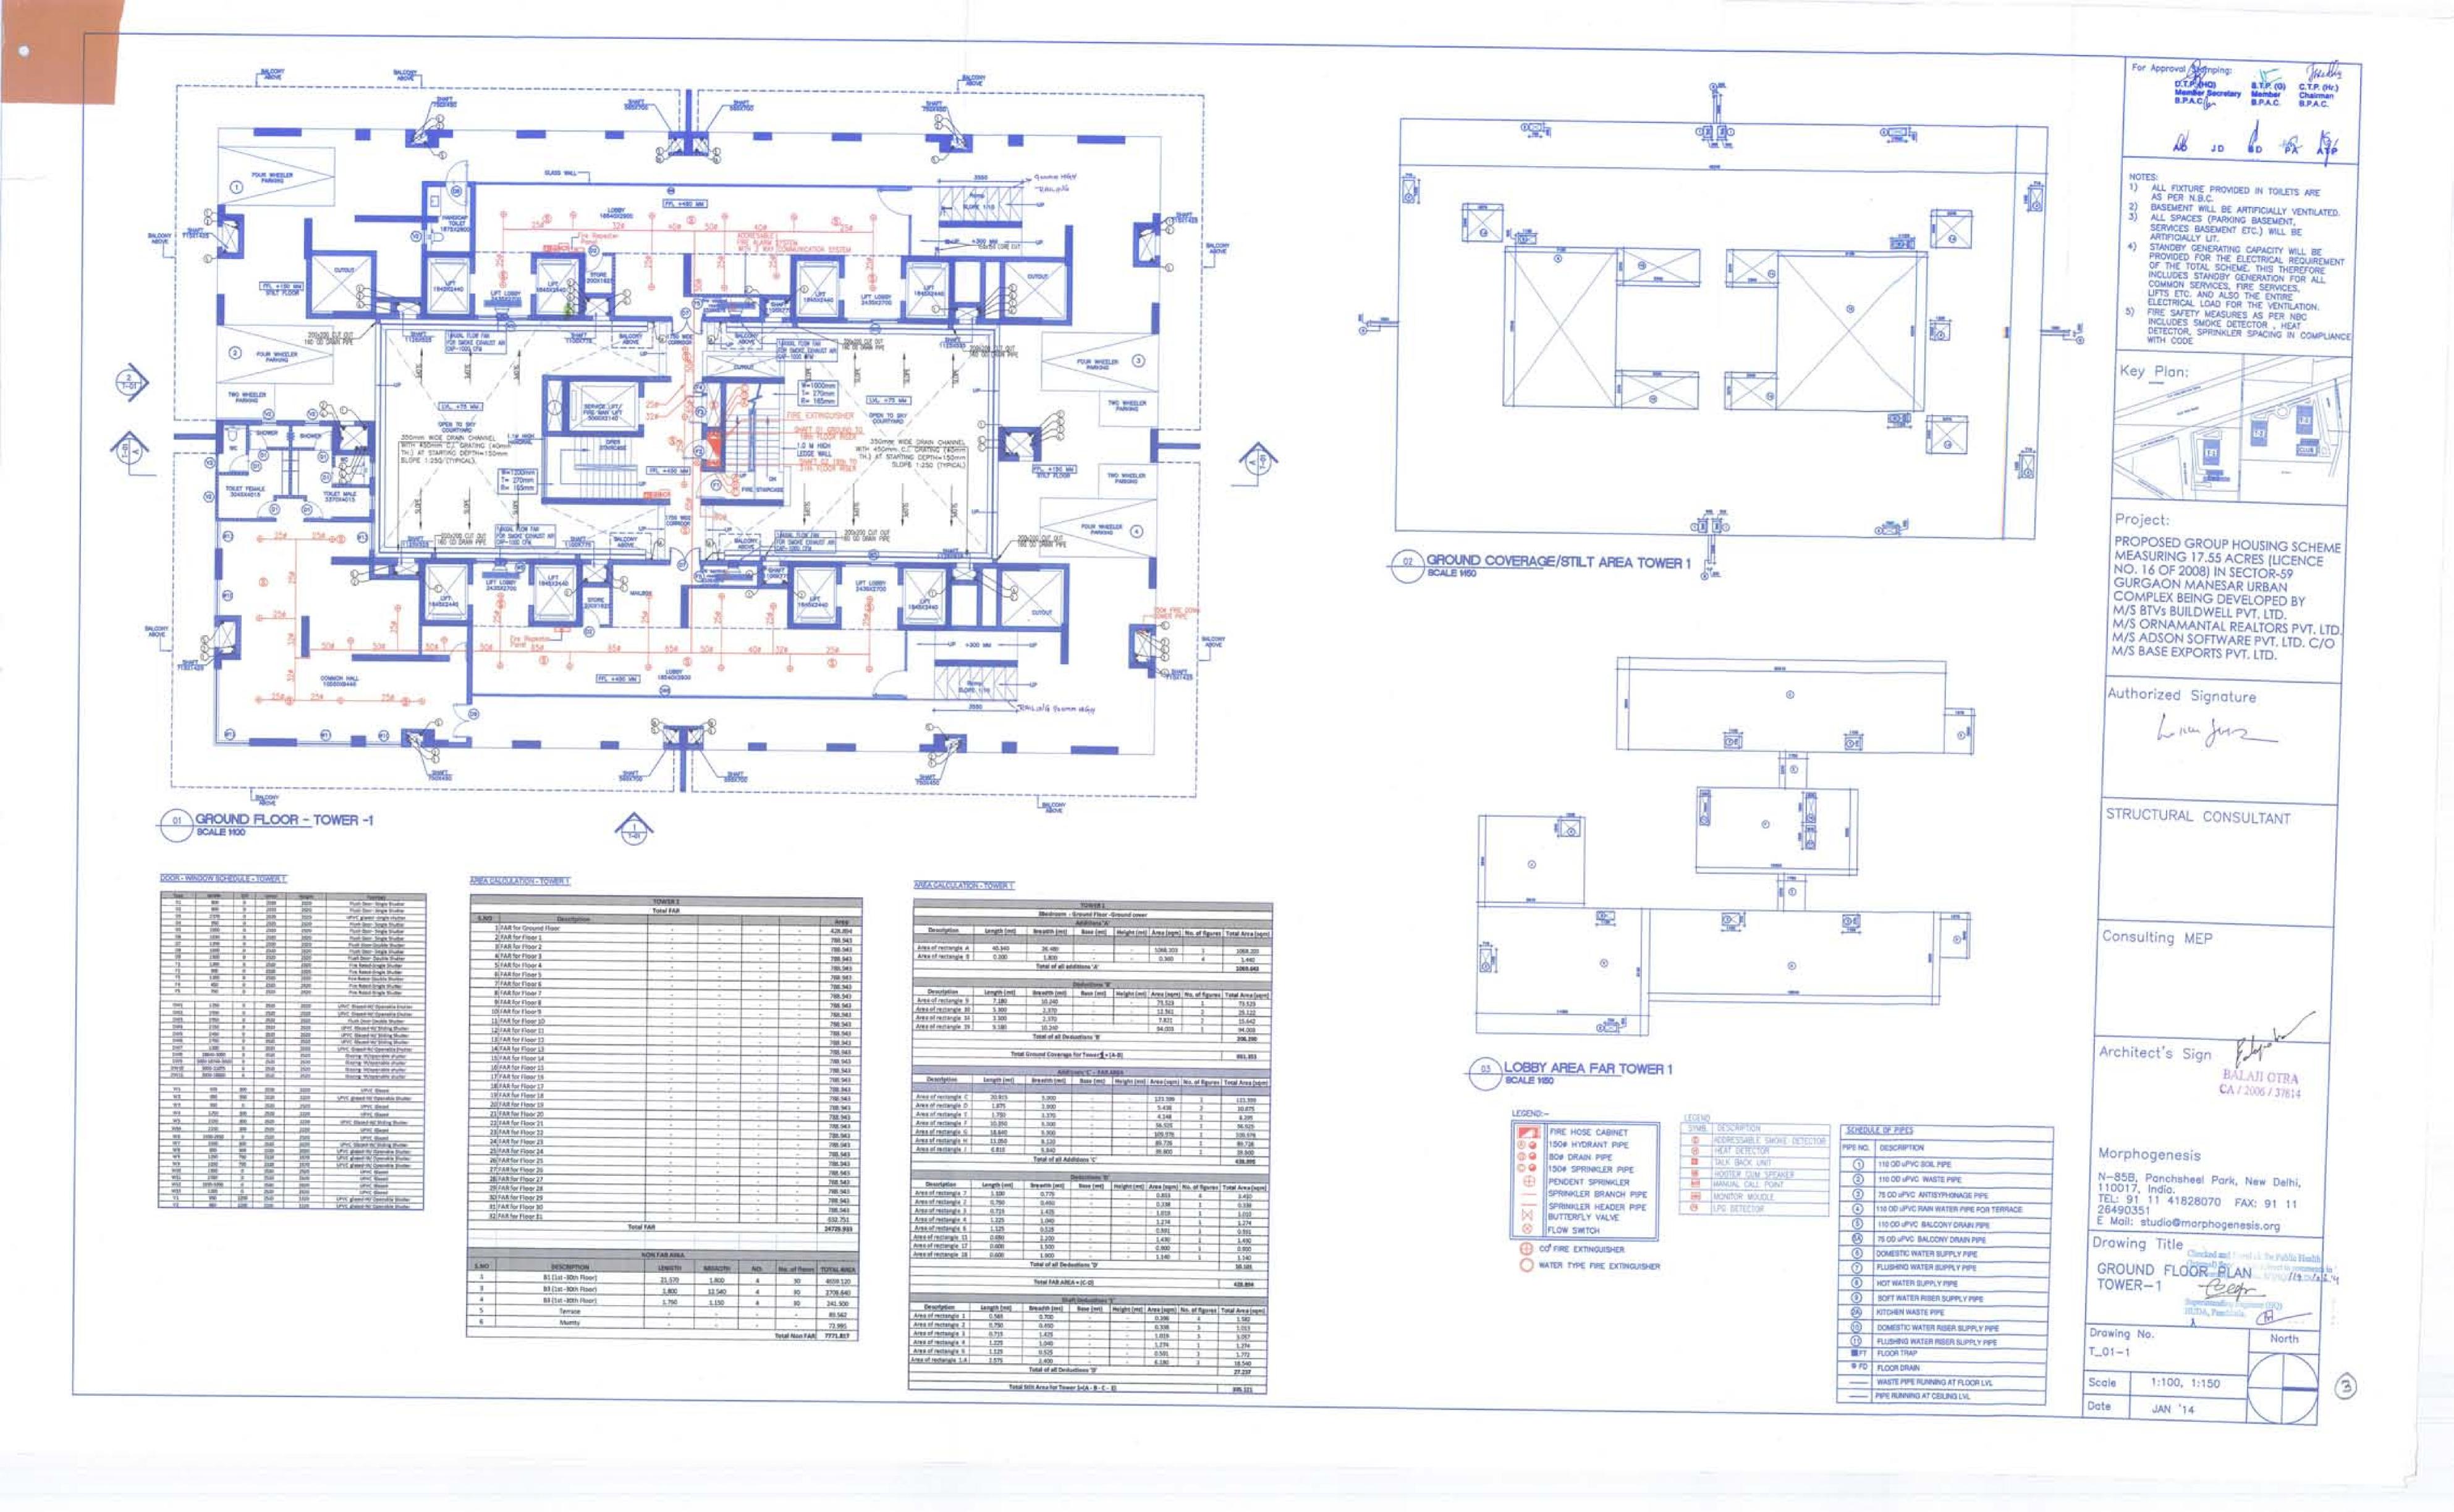

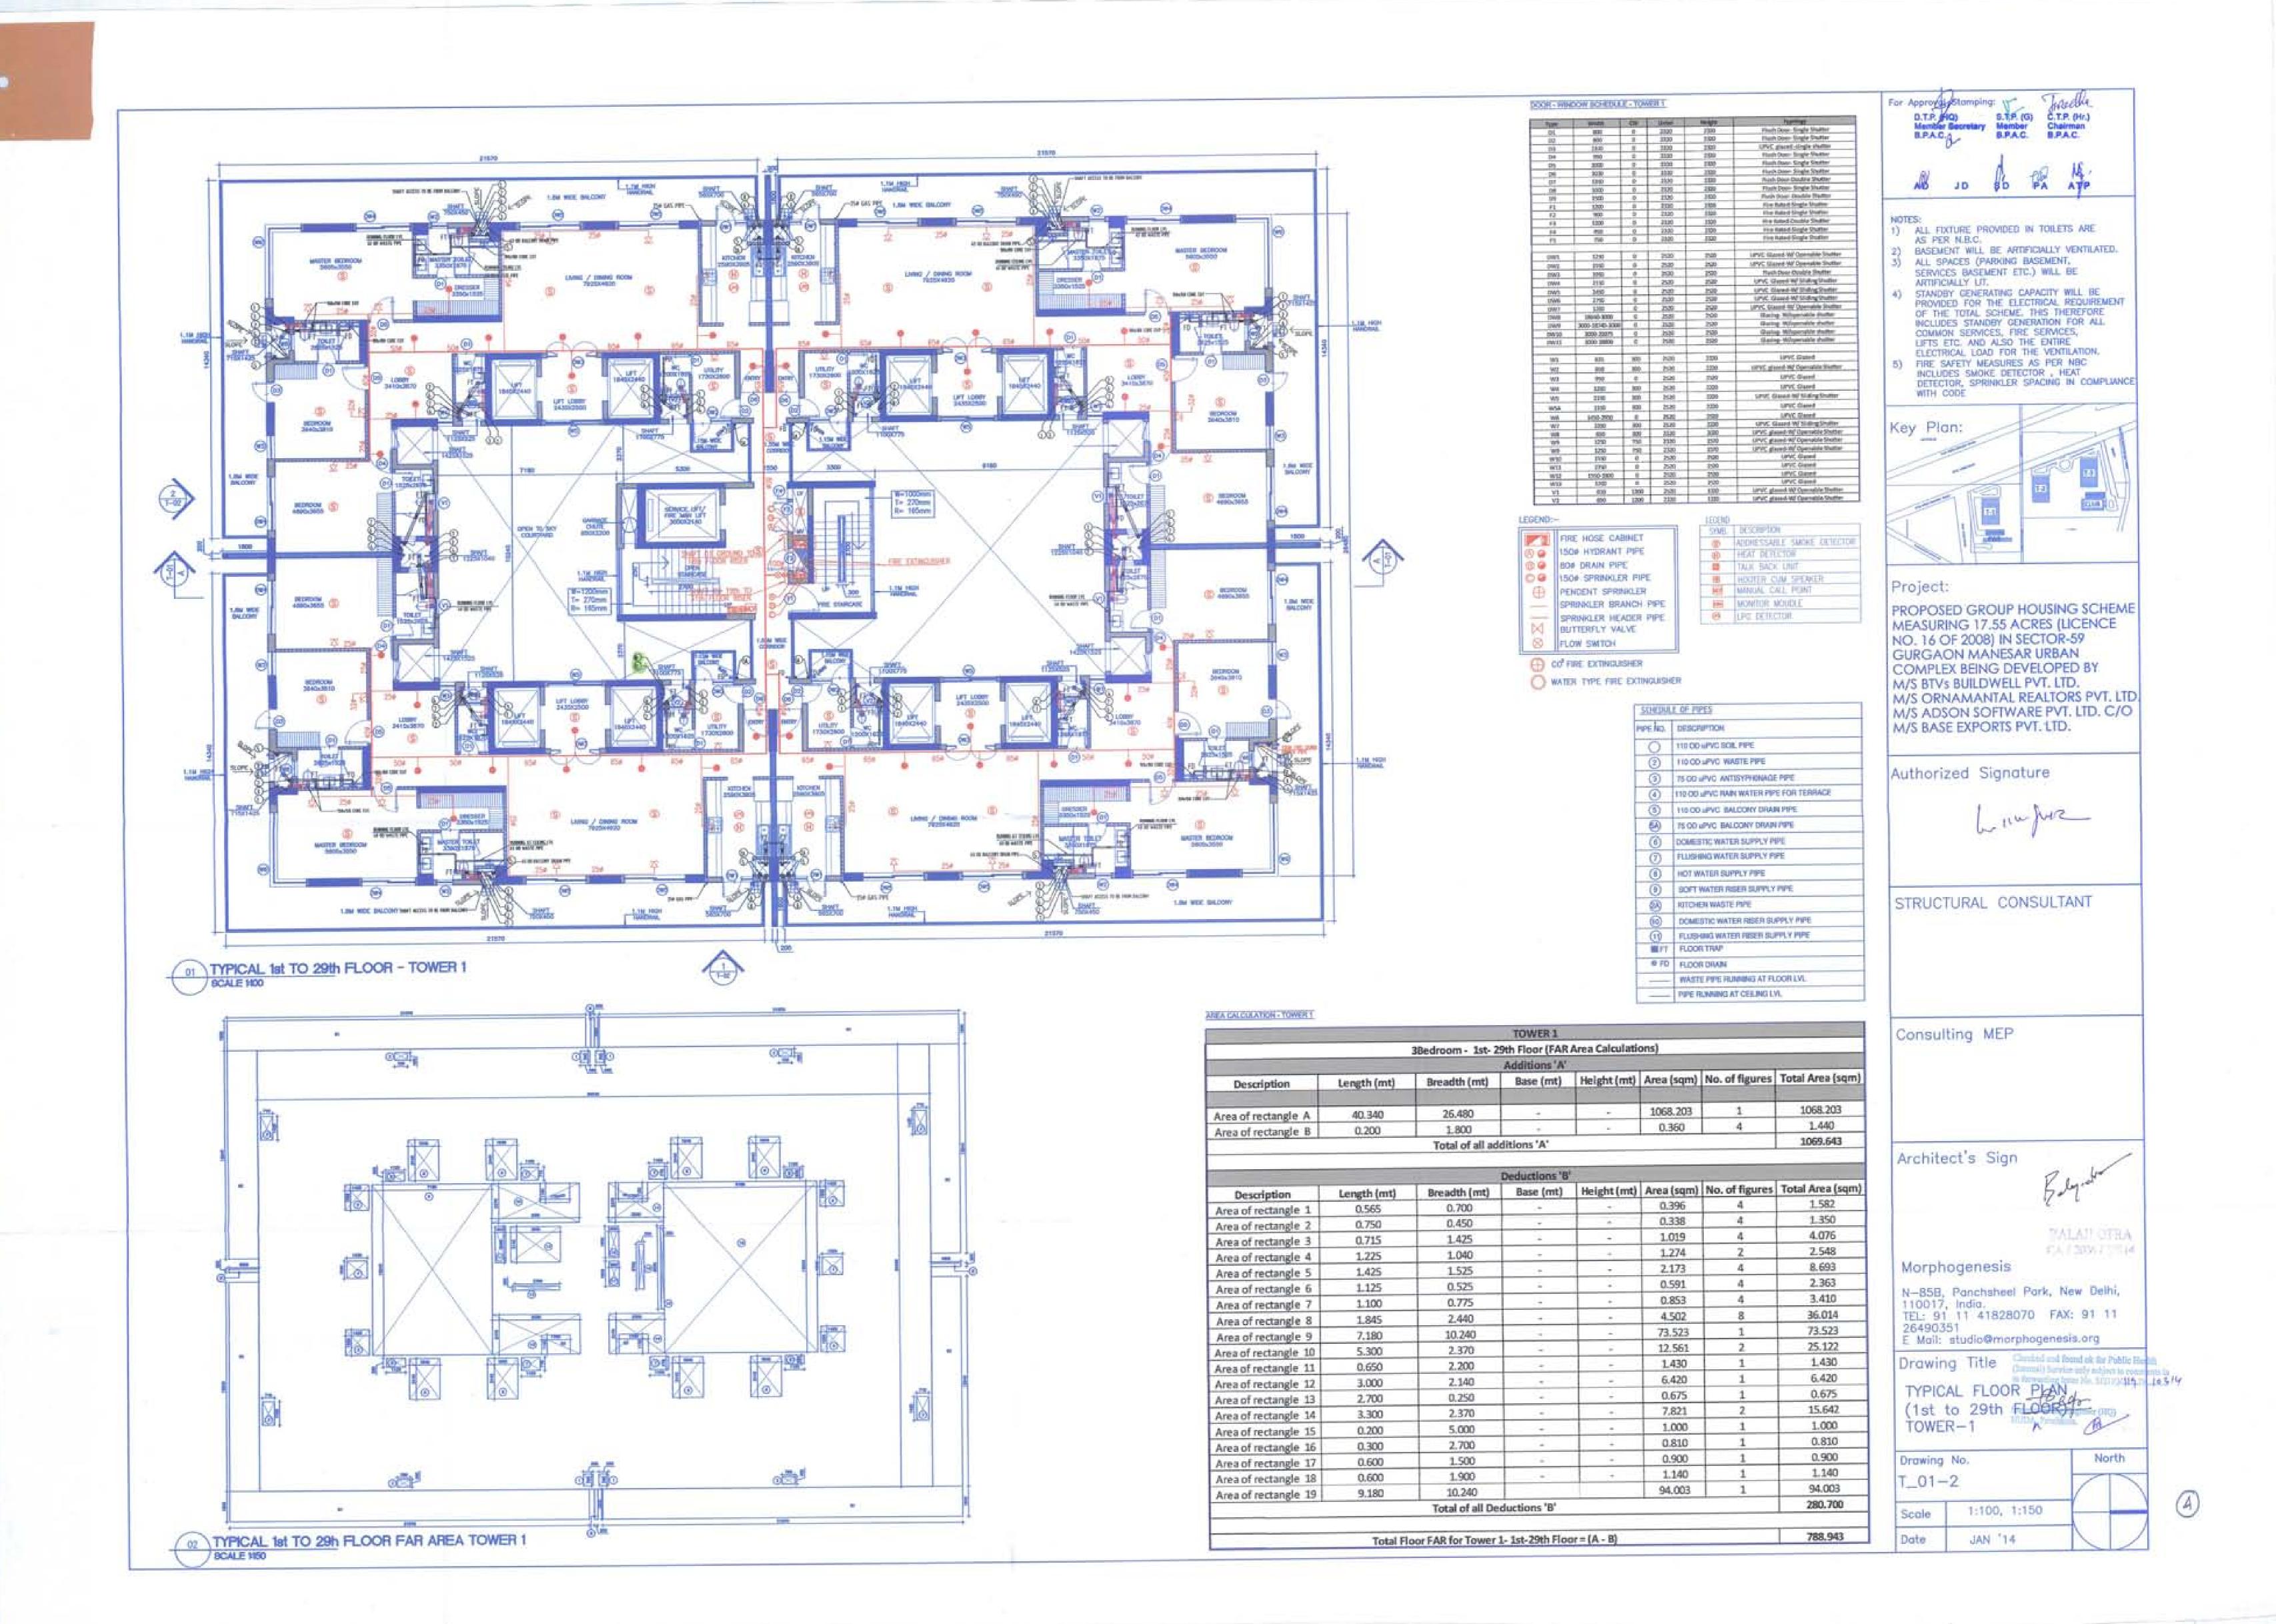

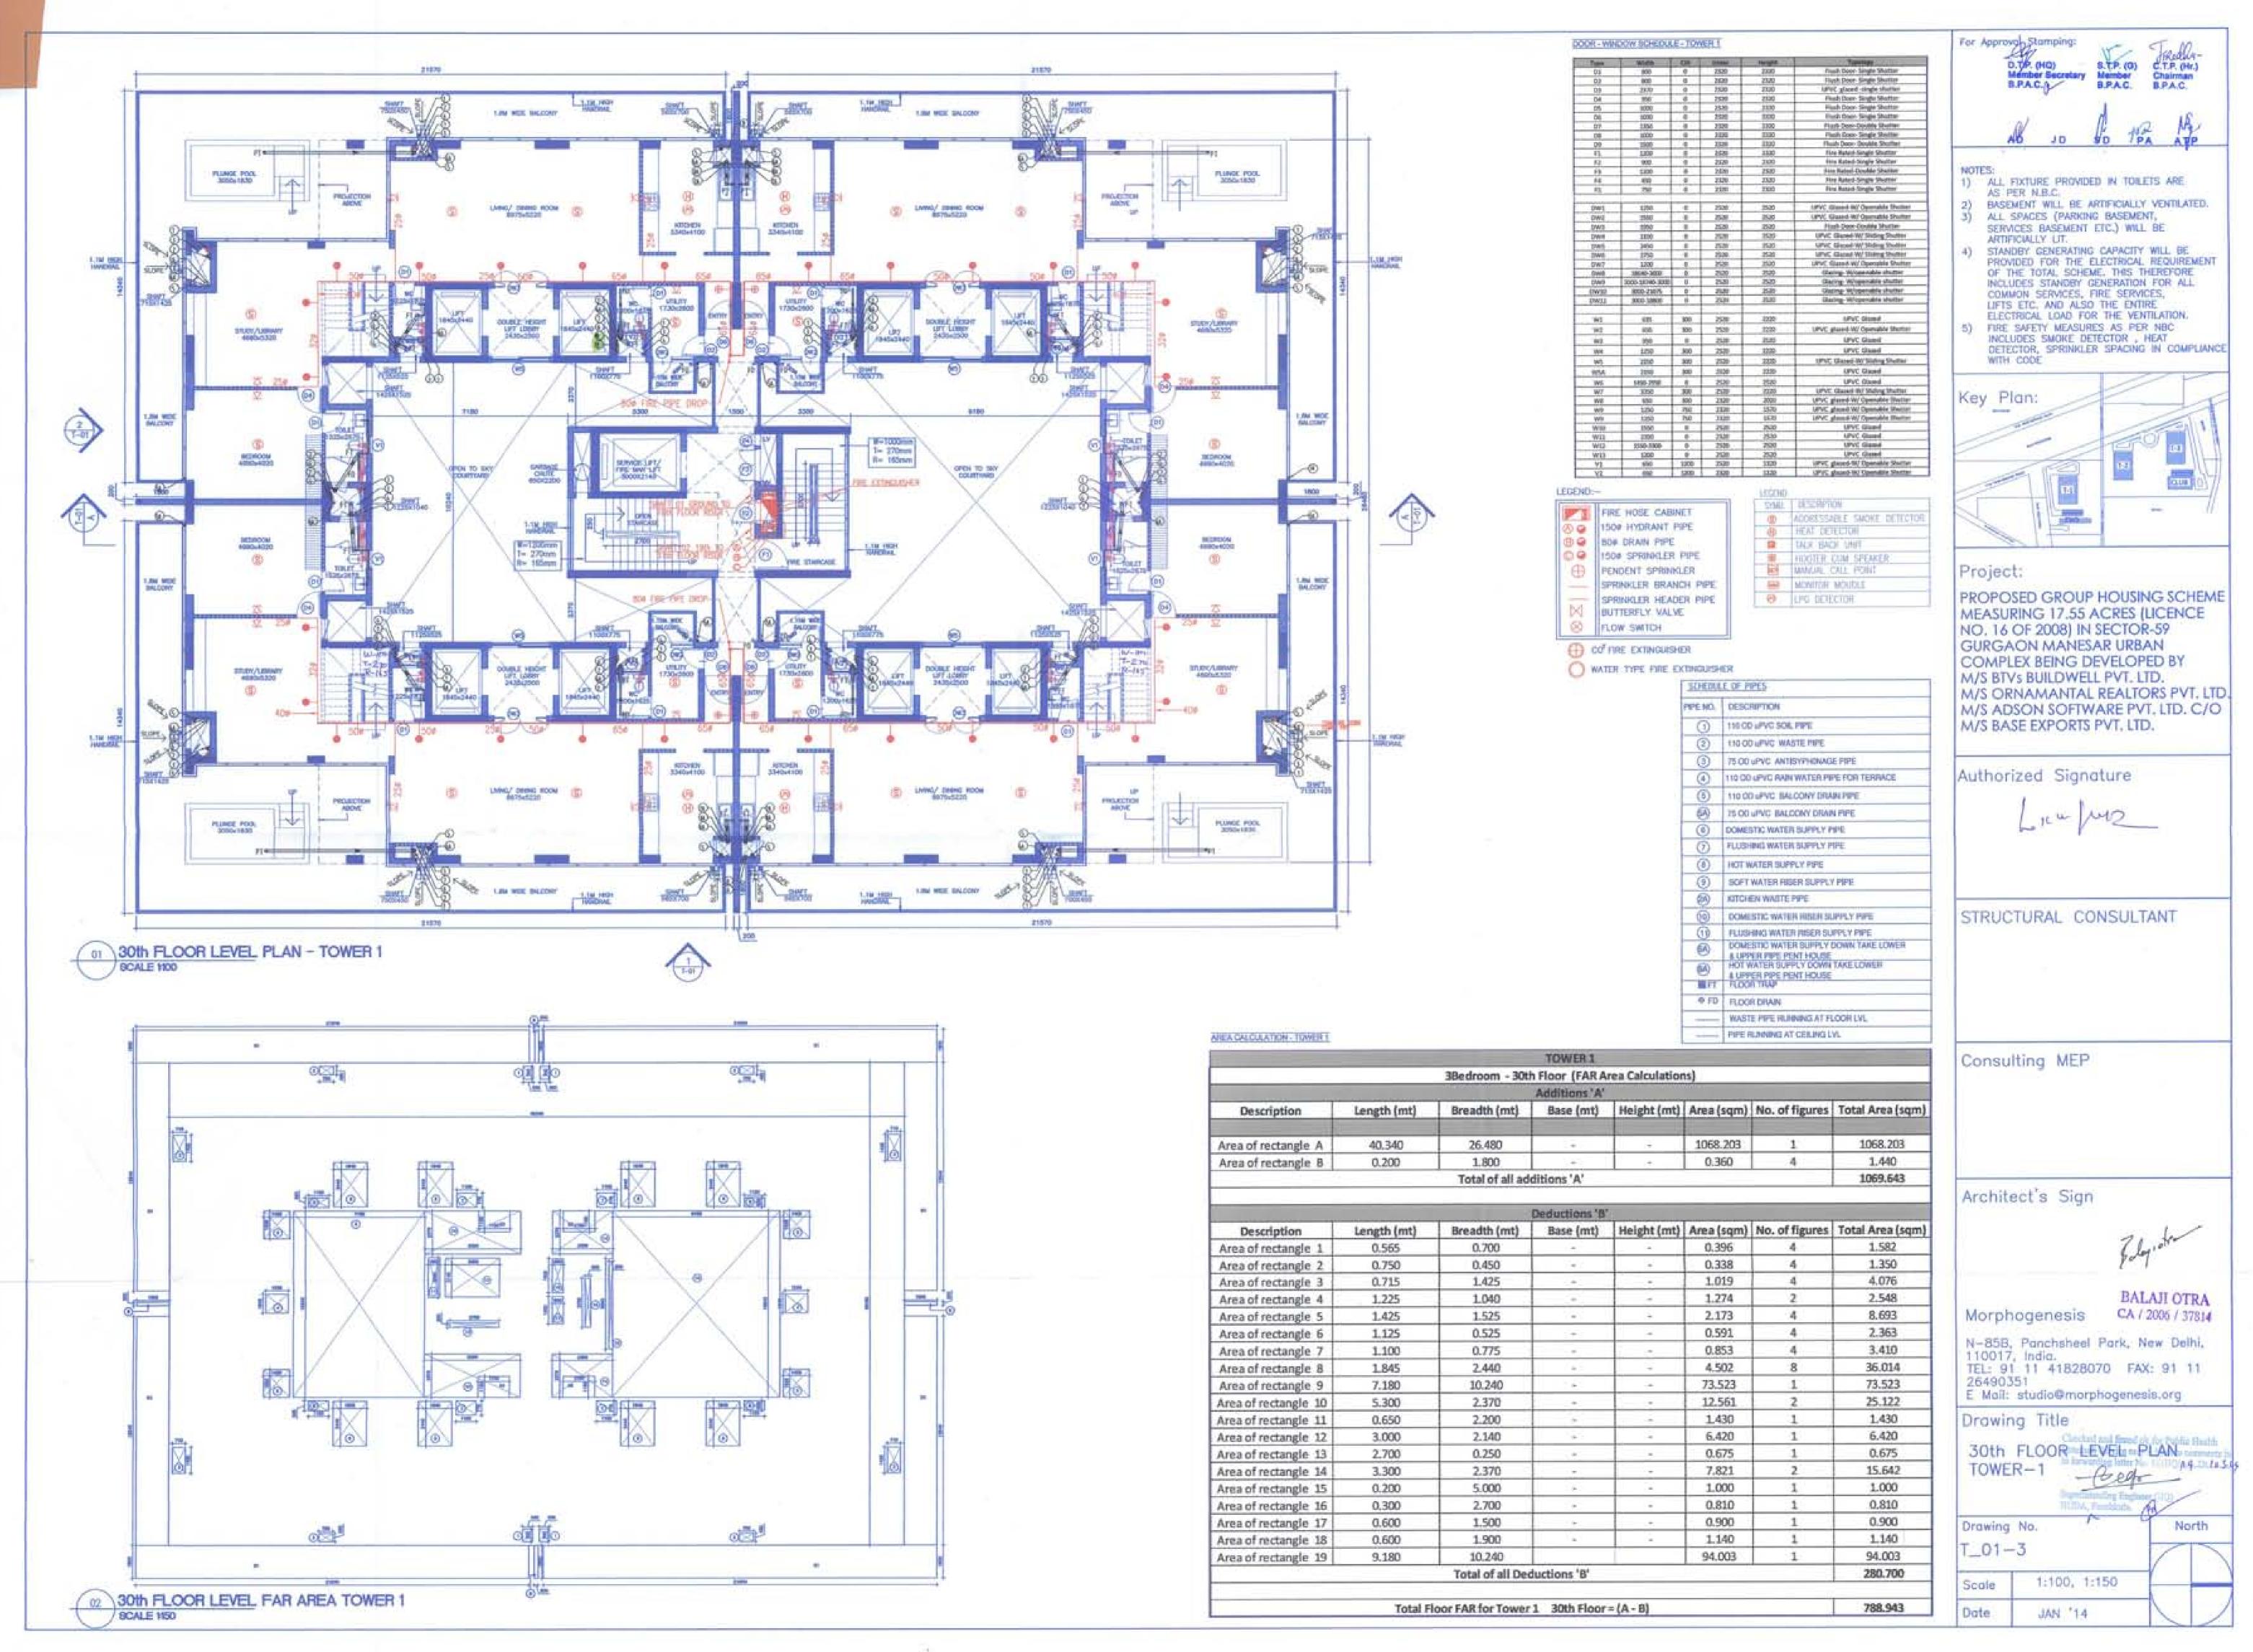

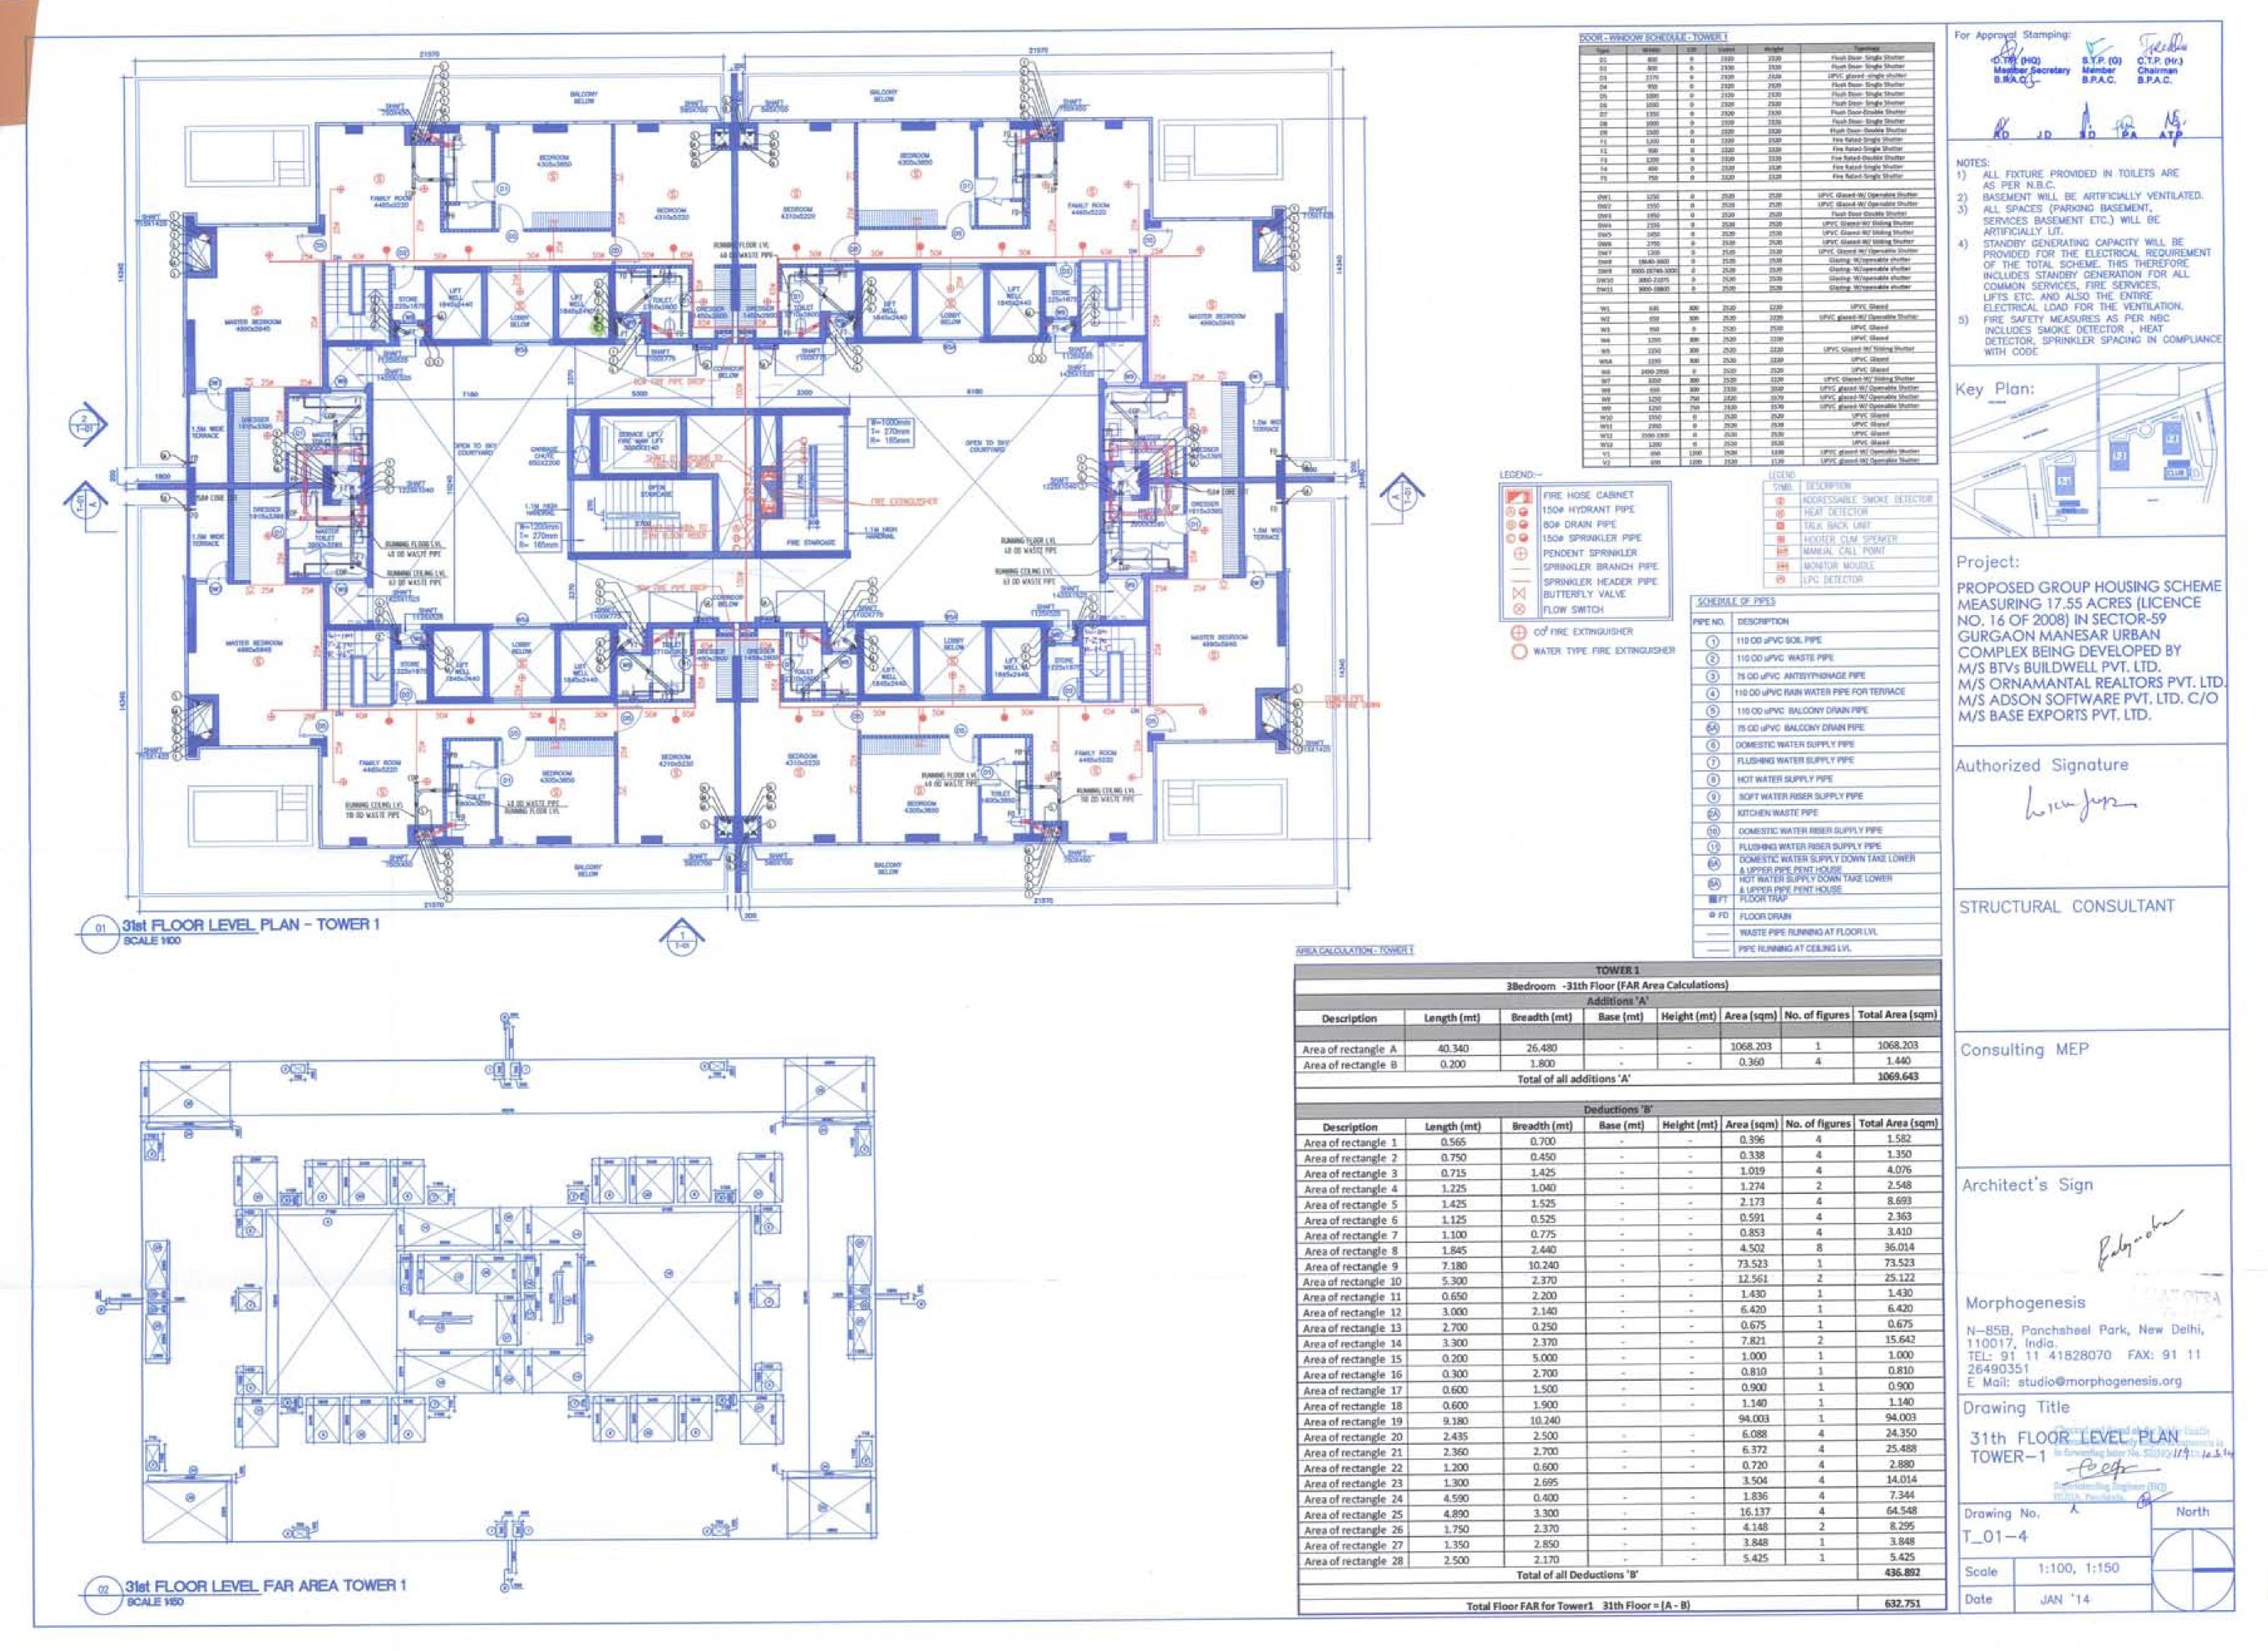

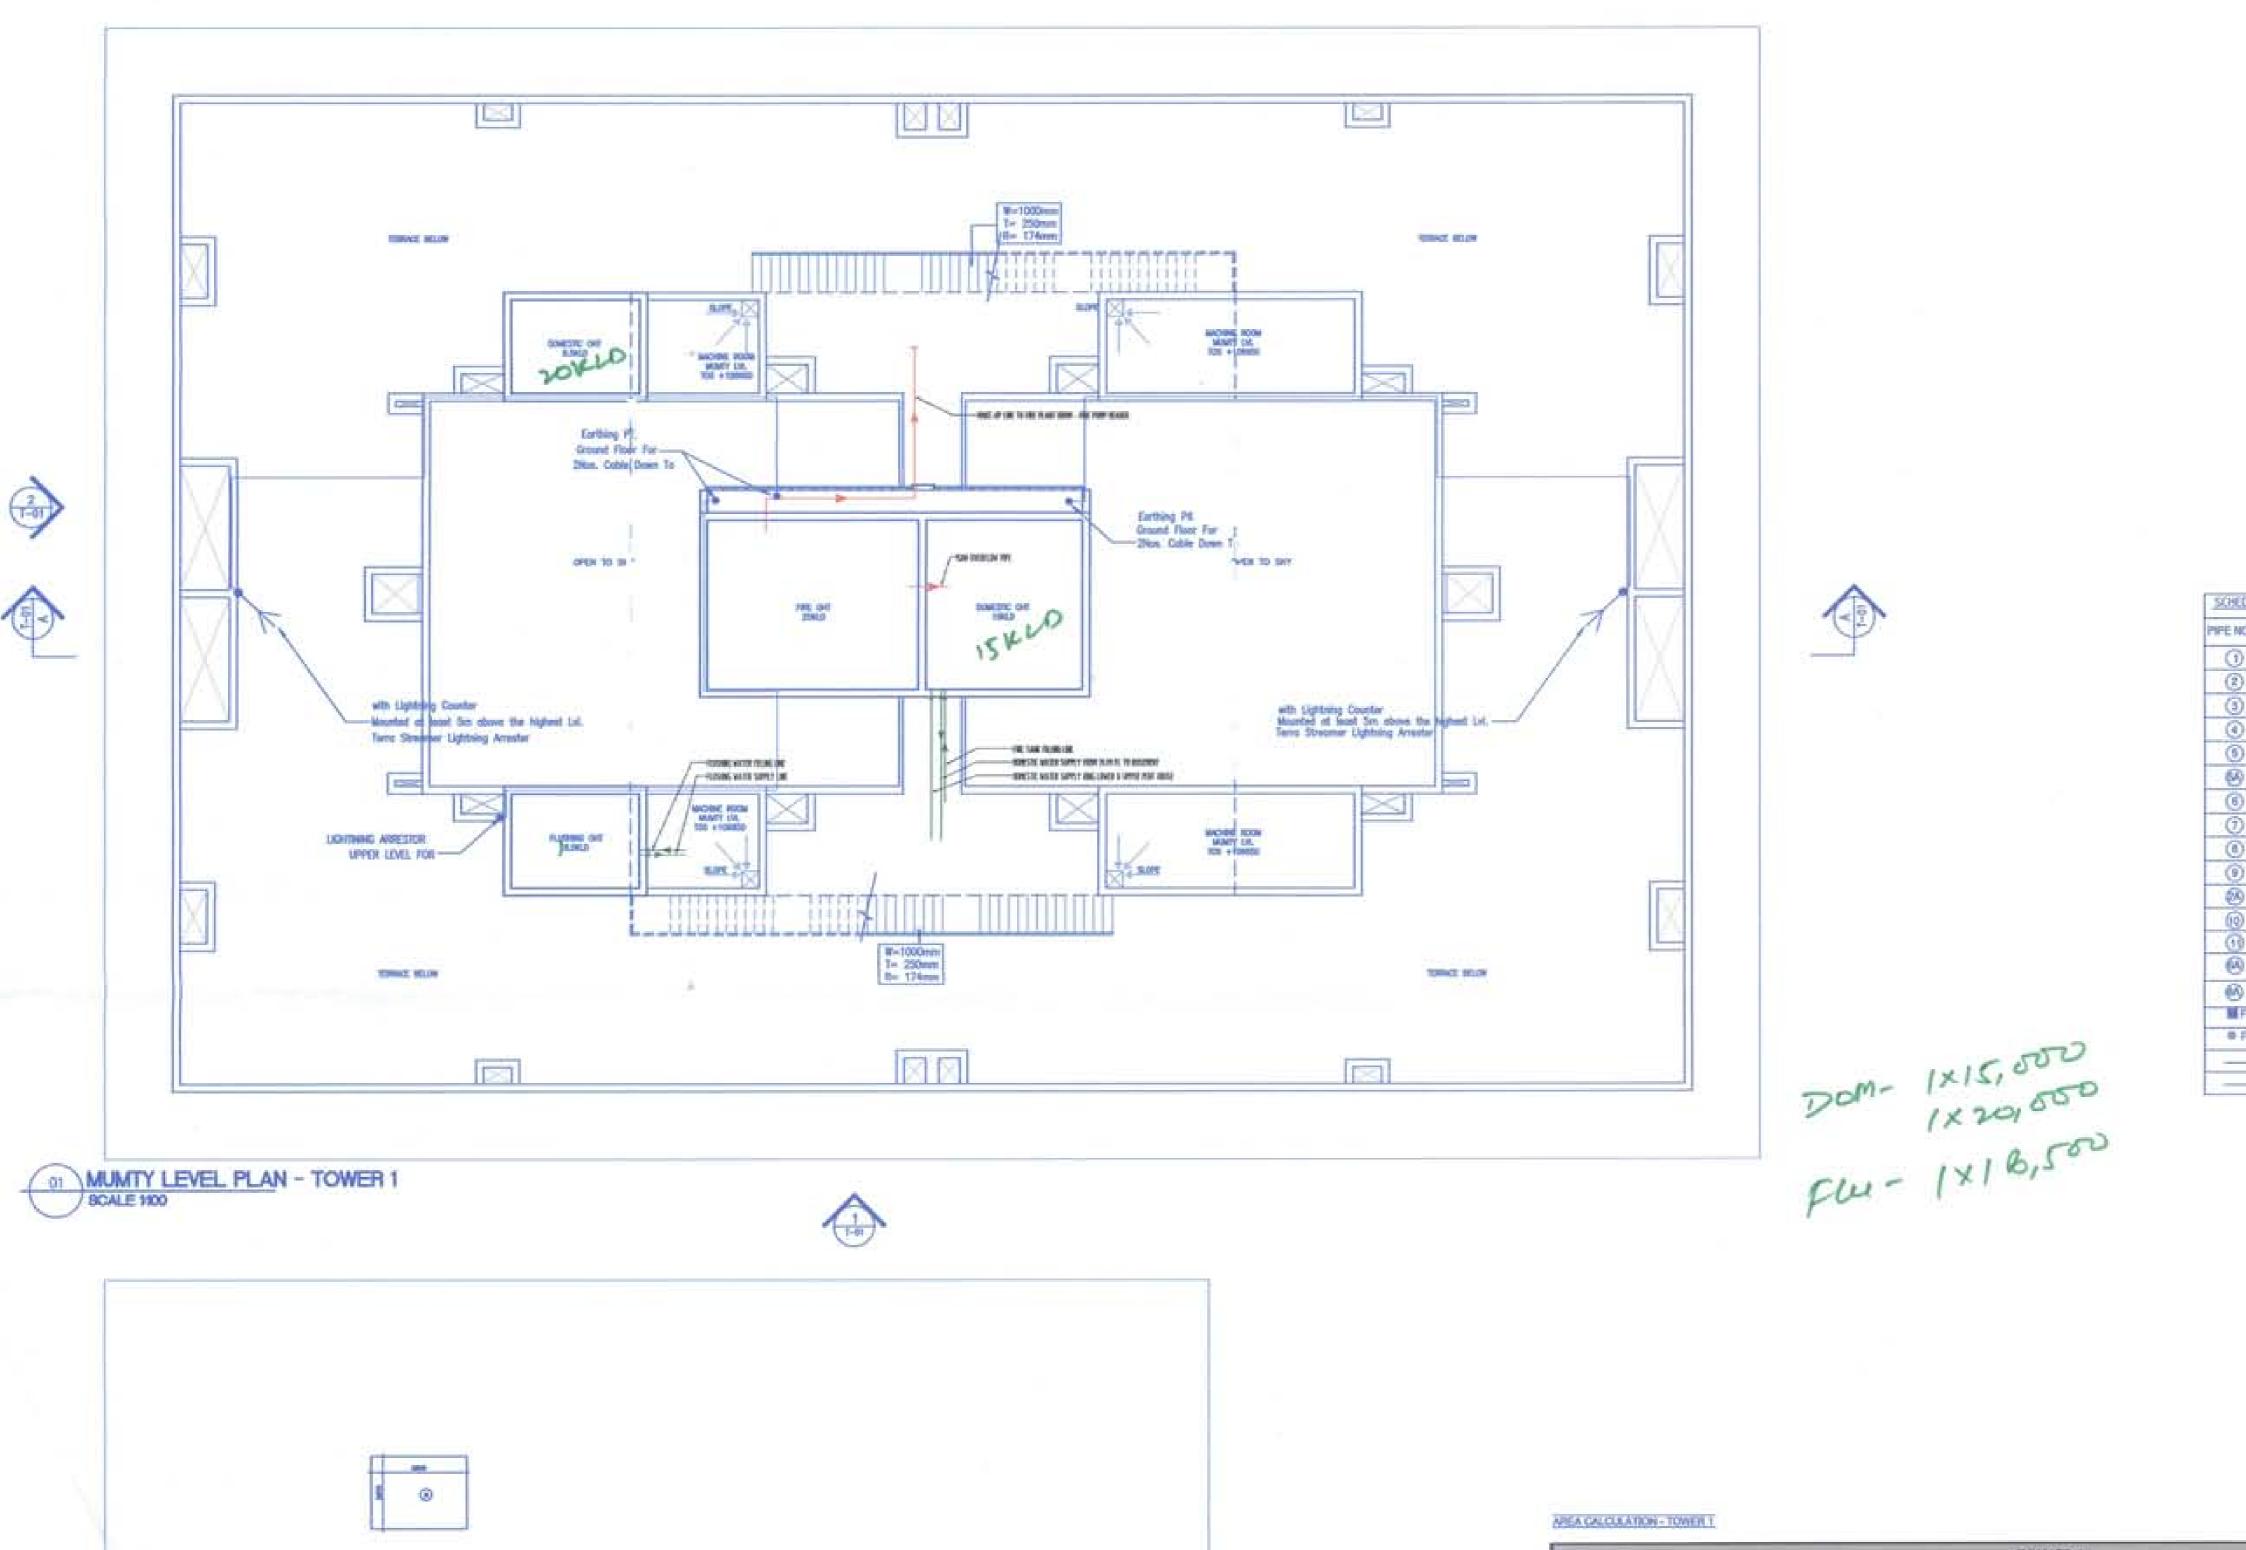

SYMEL LIGHTWING ARRESTON

THE RECEPTOR ACORESSABLE SMOKE DETECTOR
BEAT DETECTOR D. TALK BACK SAST INCOTER CUM SPEAKER. MONTOE MODELE HOTELETCH BYLL

FIRE HOSE CARNET (5) G 150¢ HYDRANT PIPE @ @ BO# DRAIN PIPE 150# SPRINKLER PIPE PENDENT SPRINKLER SPRINKLER BRANCH PIPE SPRINKLER HEADER PIPE BUTTERFLY VALVE FLOW SWITCH

CO PRE EXTINQUISHER WATER TYPE FIRE EXTINGUISHER

PIPE NO.	DESCRIPTION
0	110 OD uPVC BOIL PIPE
(2)	110 CD uPVC WASTE PIPE
(3)	75 00 LEYC ANTISYTHONAGE PIPE
(0)	110 CO aPVC RAIN WATER PIPE FOR TERRACE
(3)	110 OD JPYC. BALCONY DRAW PIPE
(8)	75 OD LIFY'C BALCONY DRAIN PIPE
(6)	DOMESTIC WATER SUPPLY PIPE
(1)	FLUSHING WATER SUPPLY PIPE
(0)	HOT WATER SUPPLY PIPE
(9)	SOFT WATER RISER SUPPLY FIPE
(8)	KITCHEN WASTE PIPE
(0)	DOMESTIC WATER RISER SUPPLY PIPE
(0)	FLUSHING WATER RISER SUPPLY PIPE
(0)	DOMESTIC WATER SUPPLY DOWN TAKE LOWER A UPPER PIPE PEAT HOUSE
(6)	NOT WATER SUPPLY DOWN TAKE LOWER & UPPER PAPE PENT HOUSE
MFT	PLOOR THUP
0.10	FLOOR DRAIN
	WASTE PIPE RUNNING AT FLOOR LVL.
	PIPE RUNNING AT CELING LVL

AS PER N.B.C. 2) BASEMENT WILL BE ARTIFICIALLY VENTILATED. 3) ALL SPACES (PARKING BASEMENT, SERVICES BASEMENT ETC.) WILL BE ARTIFICIALLY LIT. STANDBY GENERATING CAPACITY WILL BE PROVIDED FOR THE ELECTRICAL REQUIREMENT. OF THE TOTAL SCHEME, THIS THEREFORE INCLUDES STANDBY CENERATION FOR ALL COMMON SERVICES, FIRE SERVICES, LIFTS ETC. AND ALSO THE ENTIRE ELECTRICAL LOAD FOR THE VENTILATION. 5) FIRE SAFETY MEASURES AS PER NBC INCLUDES SMOKE DETECTOR . HEAT DETECTOR, SPRINKLER SPACING IN COMPLIANCE WITH CODE Project:

1) ALL FIXTURE PROVIDED IN TOILETS ARE

S.T.P. (G) G.T.P. (Hr.) Member Chairman B.P.A.C. B.P.A.C.

For Approval Agriping

PROPOSED GROUP HOUSING SCHEME MEASURING 17.55 ACRES (LICENCE NO. 16 OF 2008) IN SECTOR-59 GURGAON MANESAR URBAN COMPLEX BEING DEVELOPED BY M/S BTVs BUILDWELL PVT. LTD. M/S ORNAMANTAL REALTORS PVT. LTD. M/S ADSON SOFTWARE PVT. LTD. C/O M/S BASE EXPORTS PVT. LTD.

Authorized Signature

STRUCTURAL CONSULTANT

Consulting MEP

Architect's Sign

Morphogenesis (1) 120/12/014

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Drawing Title Classical and Stand on the Patitic Health

TOWER-1

72.995

Drawing No. T_01-6 1:100, 1:150 Scale Date JAN 14

			TOWER 1				
		3Bedroom	-Mumty Level	(Non FAR)			
			Additions 'A'	- 60			
Description	Length (mt)	Breadth (mt)	Base (mt)	Height (mt)	Area (sqm)	No. of figures	Total Area (sqm)
Area of rectangle A	10.350	5.500	- 5	-	56.925	1	56.925
Area of rectangle B	3.800	2.900	7.		11.020	2	22.040
		Total of all add	ditions 'A'				78.965
			Deductions '8'				
Description	Length (mt)	Breadth (mt)	Base (mt)	Height (mt)	Area (sqm)	No. of figures	Total Area (sqm)
Area of rectangle 1	9.950	0.600	+ :	[-0]	5.970	1	5.970

Total NON FAR for Tower 1(Mumty Level)= (A-B)

02 MUMTY LEVEL NON FAR AREA TOWER 1 8CALE 1650



ARTMENT SPACES	FEATURES	FINISHES
	WALLS	LOW VOC ACRYLIC EMULSION PAINT
LIVING ROOM/ DINING	FLOORING	ITALIAN MARBLE
ROOM/FAMILY LOUNGE	CEILING	LOW VOC ACRYLIC EMULSION PAINT & PART GYPSUM FALSE CEILING
,	DOORS	BOTH SIDE VENEER FINISH FLUSH DOOR WITH HARDWOOD FRAME
	WINDOWS	DOUBLE GLAZED UPVC FRAMED UNIT
	WALLS	LOW VOC ACRYLIC EMULSION PAINT
BEDROOMS	FLOORING	LAMINATED WOODEN FLOORING
	CEILING	LOW VOC ACRYLIC EMULSION PAINT & PART GYPSUM FALSE CEILING
	DOORS	BOTH SIDE VENEER FINISH FLUSH DOOR WITH HARDWOOD FRAME
	WINDOWS	DOUBLE GLAZED UPVC FRAMED UNIT
		WALL TILES UPTO TWO FEET ABOVE THE COUNTER AND ACRYLIC EMULSION
MITCHEN	WALLS	PAINT IN BALANCE AREA
KITCHEN	FLOORING	ANTI-SKID VITRIFIED TILES
	CEILING	LOW VOC ACRYLIC EMULSION PAINT & PART GYPSUM FALSE CEILING
	WHITE GOODS	MODULAR KITCHEN WITH CHIMNEY AND HOB
	FLOORING	ANTI-SKID VITRIFIED TILES
	CEILING	LOW VOC ACRYLIC EMULSION PAINT WITH GYPSUM FALSE CEILING
TOILETS	DOORS	BOTH SIDE LAMINATED FINISH FLUSH DOOR WITH HARDWOOD FRAME
TOILE 13	WINDOWS	SINGLE GLAZED UPVC WINDOWS WITH FROSTED GLASS
	CP & SANITARY FITTINGS	TOTO, GROHE OR EQUIVALENT
	WALLS	VITRIFIED TILES UPTO FALSE CEILING WITH ITALIN MARBLE COUNTER TOP
	RAILING	SS HANDRAIL WITH LAMINATED TOUGHENED GLASS AND STONE COPING
BALCONIES/TERRACES	FLOORING	ANTI-SKID VITRIFIED TILES
	CEILING	SUPERIOR QUALITY EXTERIOR GRADE PAINT

APARTMENT SPACES	FEATURES	FINISHES	
SERVANT ROOM/TOILET	FLOORING	ANTI-SKID VITRIFIED TILES	
	CEILING	LOW VOC OBD	
	DOORS	BOTH SIDE LAMINATED FINISH FLUSH DOOR WITH HARDWOOD FRAME	
	WINDOWS	SINGLE GLAZED UPVC FRAMED UNIT	
	CP & SANITARY FITTINGS	JAQUAR, HINDWARE OR EQUIVALENT	
	WALLS	LOW VOC OBD	
PRIVATE APARTMENT LIFT LOBBIES			
	FLOORING	ITALIAN MARBLE	
	CEILING	LOW VOC ACRYLIC EMULSION PAINT	
	DOORS	BOTH SIDE VENEER FINISH FLUSH DOOR WITH HARDWOOD FRAME	
	WINDOWS	SINGLE GLAZED UPVC FRAMED UNIT	
	WALLS	STONE CLADDING WITH LOW VOC ACRYLIC EMULSION PAINT	

ADDITIONAL CHARGABLE FEATURES* - SOLARIS (TOWER-C)			
WHITE GOODS IN KITCHEN	MICROWAVE, DISHWASHER, OVEN AND BUILT-IN-REFRIGERATOR		
WARDROBES	MADE FROM MR PLY & GERMAN HARDWARE IN PU AND VENEER FINISH IN ALL BEDROOMS		
I AUTOMATION/OTHERS	CENTRAL AC CONTROL, CURTAIN CONTROL - LIVING AND DINING AREA, ELECTRONIC MAINDOOR LOCK &		
	OCCUPANCY SENSORS IN TOILETS		

