

| Decodpision | 100 100 100 100 100 100 Total of all Deductions 1 48652 1004 Floor FAR for First Floor - (A - S)

(6)- Domestic rester Rise 19 - Flushing water River Domestic bown take DOWN take cushing SMOKE DETECTOR **HEAT DETECTOR** M The DEJECTOR # 900TER CLM STROBE TIDGON BOTINGN IN MARIAL CALL FORT

SUCIE-CE NODRY-1000						
5.7%.	Type.	IMOD.	CRUA	SPRING.	Star (W. c 10).	THE
Pl.	DH	1500	-	2400	1500 X 2400	GLAZED DOOR
CI.	00	900		1700	100 X 2100	Rush door
65.	03	1300		270	1200 X 2100	Florit door
04.	D4	750		2900	798 X 2008	Plant decr
Di.	DS-	1300		3800	1200 X:2400	GLAZED DODG
06.	No	2100		3800	2700 X 2000	MERCLING SHUTTER
.12	RS1	1900	-	9400	278 X 2486	MEROLUNG BHUTTER
08.	WI	900	100	265	988 X 2000	SLAZED WHIDOW

WE MG	20339709
0	110 GE WHE SOL & YOU PAR
8	TO SO JAC WHEEL & YOR PAYS
0	SE OD UPIC MEDIFICIALS THE
00	TO SO UNIO BUY MICH AND ADD TOWNS
0	TO SO UNIT THE MEET THE TOP BLOOM
.00	SOURCE WITH SUPER PAY
0	PLIBRIE WITH SHYST PRE
00	CONCRETE WATER SEPTER SINCE PARTY
Φ.	TUDOR WAS SITTLY BUT ITTE
0	SECTION AND ADDRESS.
=11	5.00 TeV
9.50	NUMBER OF STREET
1.004	Differ Sci. Nam.

The state of the s (I) PONDAT SPRINGER (E) PENSON SPRINGER SOC WALL SPENNIGH SPERMILE SELECT FIFE SPERMILE SCHOOL FIFE DE BATTORIA VINE S 104 SHIDI or see prisoners MATER THE PARK SCHOOLSE



ALL PLOTER WOVERS IN TRAITS ARE
ALL PLOTER WOVERS IN TRAITS ARE
MADDINESS (WHEN SHOULDER,
SCHOOLS DOWNED SHOULDER,
SCHOOLS DOWNED SHOULDER,
SCHOOLS DOWNED FOLLOW,
STRONG FOR THE ELECTRON, PROUMBOUND
TO THE TEXT. SCHOOLS OF THE PERSONNEL
WOLLDES SCHOOLS FOLLOWING ALL
COMMON SERVICE, FIRE SCHOOLS
LITTLE, AND ALL DO SE DIRECT
THE SHATT MEDICARIO AN FIRE MICH.
AND LICET SLOWE STRONG
AND LICET SLOWE
AND LICET SLOWE STRONG
AND LICET SLOWE



Project

PROPOSED GROUP HOUSING SCHEME MEASURING 17.55 ACRES (UCENCE NO. 16 OF 2008) IN SECTOR-59 GURGACH MANESAR URBAN COMPLEX BEING DEVELOPED BY M/S BTVs BUILDWELL PVT, LTD. M/S ORNAMANTAL REALTORS PVT. LTD. M/S ADSON SOFTWARE PVT, LTD, C/O MUS BASE EXPORTS PVT. LTD.

Authorized Signature

STRUCTURAL CONSULTANT

Consulting MEP

Architect's Sign

BALAJI OTRA Morphogenesis


N-858, Ponchabad Pork, New Dehi, 110017, India. TEL 91 11 41828070 FMC 01 11 20480251 E Noil studio@morphogenesis.srg


Orawing Title

COMMUNITY CENTER GEORE 0


Drowing No. North CC_02 Scole 1:100, 1:150 Dots JAMUARY '14


117 11-1179

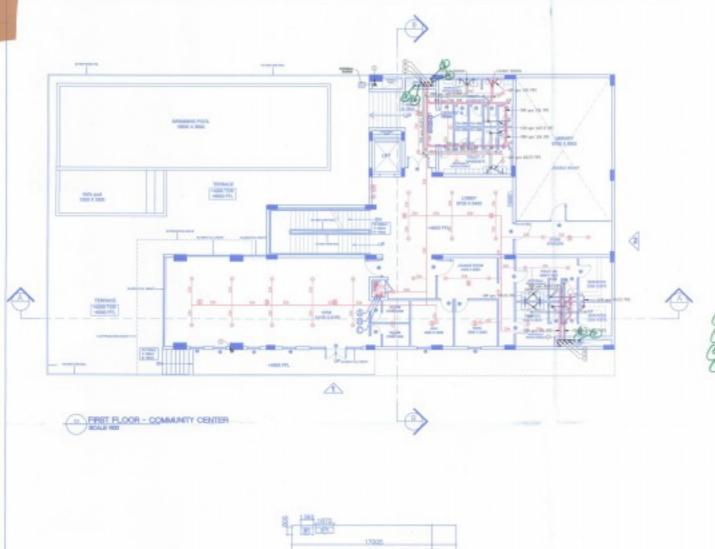

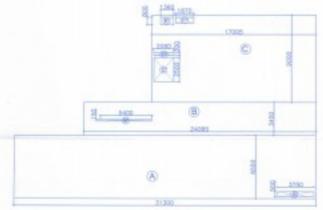

FRET FLOOR FAR AREA-COMMUNITY CENTER

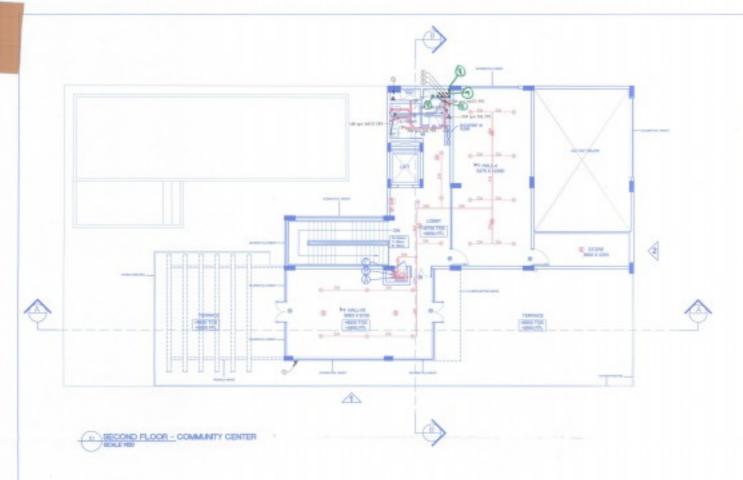

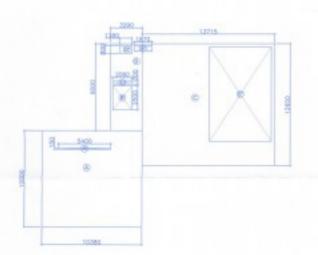

SECOND FLOOR FAR AREA-COMMUNITY CENTER

		-	штанр гуаа	I.			
			Additions X				
Description	Length (ne)	Broakh (nd)	too jed	reight led	Anabari	No. of Figures	fotol Area (spr
Area of rectangle A	18.600	10.98		-	301-80	1	100.66
Assault recipegle Til	1,290	1.00	-	-	29-10	1	29.61
Axes of rectangle C	13,725	12,658		-	173.49	1	179.46
		Total of all Ad	W modifie				300.40
THE RESERVE OF THE PERSON NAMED IN		901111111111111111111111111111111111111	Dedactor: Y	100000	100000	1000	100000
	Local Lad	T no -441 (-4		Telebras	Annah and	Mary Mary	Paril bank
be solution.	Longth Lond	Broadth (mb	Bess (Im)	Reight (m)		No. of Figures	
Area of restangle X	5.400	0.358	Best (MS)	-	688	No. of Figures	840
Annual rectangle X' Annual rectangle X'	5.400 2,860	0.358 2.588	Best (let)		68L	No. of Egents	3,13
Around rectangle IV Arrived rectangle IV Area of rectangle C	5.40 2,84 2,84	0.558 2.568 0.368	Rese (let)		58 1.B 66	No. of Figures	5.00
Around rectangle W Arrived rectangle W Rives of rectangle C Around rectangle D	5.48 2.88 2.88 1.88	0,558 2,568 0,868 0,868	Best (let)		68 1.0 66 100	1	8.60 5.00 6.62 5.00
Around rectangle IV Arrived rectangle IV Area of rectangle C	5.40 2,84 2,84	0.59 2.58 0.88 0.88 0.88	Resi (MS)		58 1.B 66	An of Spens	8.60 5.00 0.62 1.69 1.10
Around rectangle W Arrived rectangle W Rives of rectangle C Around rectangle D	5.48 2.88 2.88 1.88	0,558 2,568 0,868 0,868	Resi (MS)		68 1.0 66 100	1	8.60 5.00 6.62 5.00

(3) - Domestic water Riser (3) - flushing water Riser (3) - Domestic Down take (3) - Flushing Down take

SUMBOL	DESCRIPTION
(8)	SMIRKE DETECTOR
00	HEAT SETECTOR
(8)	LPE DETECTOR
	HOUTER CLAN STRONG
MAG	MONITOR MODULE
10.0	MANUAL CALL PORT

DOOR VINDOW SCHEDULE								
53h.	Type	Miles	CHEV	SPRESS.	Star (W. + 1).	THRE		
BI.	01.	1900		2400	1586 3(2400	GLAZED DODA		
13.	10	100		2100	MIX2M	Flush door		
10.	03	1300		2100	1290 X 2100	Plaid dear		
N.	04	750		2100	79EX298	Florit door		
15.	26	1300	-	2100	1200 1/2400	GLAZED DOOR		
84.	RE.	2100		2100	2760 X 2400	MERCLINE BALTER		
67.	101	1800	-	2400	278 X 248	MERCLING BATTER		
in.	RT -	800	199	248	800 X 2000	GLAZED WHIDDW		

9T H0	SSSPICK
0	THE RESIDENCE SERVICE AND PARTY.
8	THE GO LEVEL BROTE & YOR THE
0	SE OF ANY AMERICAN PRO
8	TO GO JAK THE METS THE TO THREE
0	TO JO JPS THE MICE FIT FOR BUILDING
8	CONTRACTOR SERVICE PRINCIPLE
0	SUBMIC MICE SUPPLY RISK
0	COMMERC MADE SUPPLY MISCH PIPE
0	NUMBER WAS SHOT THE PER
0	CHEST DAY TO THE THE
m III	AUR THY
+10	ALTOR OHIER
100	Side Of Fasi
	Section than with deaths Milestone.

200	THE HOSE CHAME!
	1006 HICKART PRIC TO 1 TO 120 FLESS
0.8	MER DRIVE PART TO 1 TO 1256 PLANE
0.9	150e SPREALSP PAYS TO 1 TO 10H FLOOR
60 P	THE HOUSEN'S FORE TO US TO DRIVE FURTHER
01-8	BOX BRAIN FIRT'S 13 TO 38th FLESK
0.9	THOS SPRINGER PAPERS AS TO JOHN TAXON
di	POSSOCI SPRINGER
(8)	PORON' SPRINGER
	SOC WALL OWNERS.
	SPRINGER BRUNDS TWY.
_	SHEWLER READS THE
04	BUTTERLY INLECT
8	now seros
0	OF THE EXTREMENTS

AL PURINE PROMOTO IN TOLETS ARE AS PURINELL SE APPRICALLY VINELATIO. AL SPACES (PARODIC BASINESS). SERVICES SPESSARS (FE) FILL SE APPRICALLY (ET.



Project:

PROPOSED GROUP HOUSING SCHEME MEASURING 17.55 ACRES (JUCSINCE NO. 16 OF 2008) IN SECTOR-59 GURGAON MANESAR URBAN COMPLEX BEING DEVELOPED BY M/S GIFN BUILDWELL PVT. LTD. M/S ADSON SOFTWARE PVT. LTD. C/O M/S ADSON SOFTWARE PVT. LTD. MUS BASE EXPORTS PVT. LTD.

Authorized Signoture

Luther

STRUCTURAL CONSULTANT

Consulting MEP

Architect's Sign


BALAN OTRA CA / 2006 J 27814 Morphogenesis

N-858. Panchaheel Park, New Delhi, 110017, India. TEL: 91 11 41828070 FAX: 91 11 2646035 E Melt shuder@marghogeneels.org

Drawing Title and all the to the late late.

COMMUNETY GENTER A BETTAT /41/4 SECOND FLOOR (Sept

Drowing No. Dierth Scole 1:100, 1:150 Dots MINISTY '14

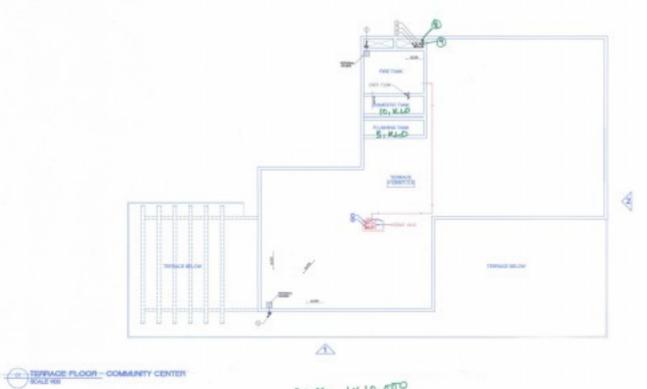

pom- 1x10,000

8

| COMMISSION | COMISSION | COMMISSION | COMMISSION | COMMISSION | COMMISSION | COMI

(8-Domeste water liver 3-flushing water liver (6-Domestic Down take 3-flushing Down take.

STARCE	BESCRIPTION
(S):	SMOKE DETECTOR
080	HEAT DETECTOR
(2)	LPG DETECTOR
78	HOOTER CLM STROBE
[66]	MONTOR MODULE
63	WANGAL CALL POINT

DOOR - MNEON SCHEDULE							
53%:	Toro	VMM.	OFFI	Load Let.	Sim (Wint)	TYPE	
Et.	21	1500		3400	1900 X 2400	GLAZES COOR	
Ei.	bit	100		2100	900 X 2100	Rup-too	
п.	18	1200	4	210	1300 X 2100	Plush-door	
BI.	04	758		2100	750.0 2100	Plash-door	
m.	26	1300		266	1000 X 2400	GLAZED 0000F	
ш,	85	2988	-+	2400	2700 £ 3400	ME ROLLING SHUTTER	
Ø,	.901	1900	131	348	2700 (3400	MS ROLLING SHUTTER	
н.	781	900	100	2400	800 X 2300	GLAZED WWOON	

YS N	DESCRIPTION
0	THE SHIPPING BOX & YOM PARK
0	THE RESIDENCE SHOPE & HOLE PART
0	10 IS you will receive the
8	THE RES WHICE THE WHITE PARK THE TERROR.
8	15 IN JUNE THE BUILD PAY THE BULLOW
8	SOUTH WITH SHIPLY PIPE
-0	FEMALE SAIDS SHAPLY SAID
8	DOMESTIC WATER SUPPLY RESER PERSON
8	FEMALES WITH SHIPLY WERE PART
9	2012 201 TAX TAX Tax on
m/T	ruppe tree
+/3	FLOOR SWAR
100	GOV SIT PLIE
	Section two sector section associations

P3	THE HOSE CARNET
0.0	TOOK INDICATE FREE TO 1 TO 1000 FLORE
	10V DOM: YET, 10 1 10 13th 7L00F
0.9	150e SPRINCES PARE TO 1 TO 12th FLOOR
80-4	1509 HISBORY PRE TO 13 TO 200 FLOOR
0.4	Mile Diller PAPETO IZ TO DIRECTABLE
0.0	100 STREET, PACID 12 TO DEP FLOOR
di	POSCOYT OPENILER.
(8)	POMICKT SPRINKLER
	SOC WALL SPRINGER
	SPERGLAR MINISTER PRE
_	SHEWITH HOUSE LINE
M	BUTERRY YAVE
0	NUMBER OF THE PARTY.
	OF RECEIVED

when many to high
SPACE BRAG
A 10 A0 A 15

MOTISS

ALL SPICES PROMOTED IN TRUETS AND PER MALE OF ANTHONESS AND MALE OF ANTHONESS AND ANT



Projects

PROPOSED GROUP HOUSING SCHEME MEASURING 17.55 ACRES (LICENCE) NO. 18 OF 2008) IN SECTOR-99 GURGAON MANESAR LIBBAN COMPLEX BEING DEVELOPED BY MYS BTYL BUILDWELL PVT. LID, MYS ADSON SOFTWARE PVT. LTD. MYS ADSON SOFTWARE PVT. LTD. C/O MYS BASE EMPORTS PVT. LTD.

Authorized Signature

for how from

STRUCTURAL CONSULTANT

Consulting MEP

Architect's Sign

AIL OTRA

BALAILOTRA McAphogenesis


N-858. Pandraheel Park, New Dehi, 110017, India. TD.: 91 11 41828070 FWC: 91 11 26490331 E Mail: studio@morphagenesis.org

Drawing Title Cheletal

COMMUNITY CENTER 19 424

IS TERRACE FLOOR NON FAR AREA-COMMUNITY CENTER

(39)

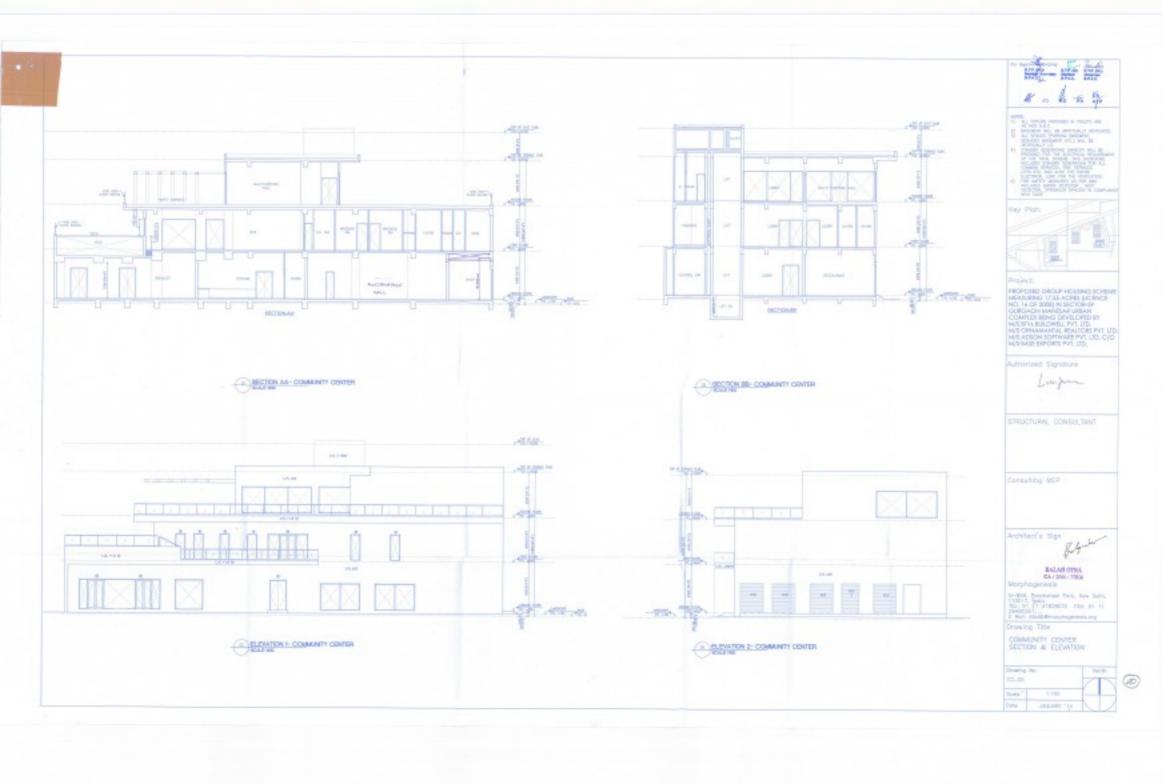


			BASEMENT A				
			Additions W				
Description	Length (mt)	Breadth (mt)	Base (mt)	Height (we)	Area (sqrs)	No. of figures	Total Area (sqm)
Area of triangle A			72.000	26.620	974,373	1	974.371
Area of rectangle 8	72,660	21.500	-		1548,385	1	1546.365
Area of rectangle <	180.890	27.890	- 1	-	3838,754	1	5628.754
Area of triangle ©		4.	75.960	14,640	556.027	1	556.027
Area of rectangle 5	545.085	34.290	-	142	4964,306	1	4964.206
Area of triangle F		1	51.355	18.685	483,031	1	483.03£
Area of restangle (i)	6.575	0.680			4.471	- 1	4.471
		Total of all ad-	distans 'A'				32599.344

			BASEMENT B				
			Additions W				
Description	Length (mt)	Breadth (mt)	Base (mt)	Height (wit)	Area (signi)	No. of figures	Total Area (sqm)
Area of rectangle H	36.306	17.946	-	2.4	1340.350	1	1940,390
Area of rectangle 3	\$2.005	24.930	-	-	2019,902	i	3059-812
Area of rectangle K	60,200	23.305	-		1403.586	1	3403.586
Area of triangle 1.		1.6	27.595	10.185	343.528	1	140.538
Area of rectangle to	29.425	4.280		-	368.739	1	168.739
Area of restangle N	12:300	11.015		100	535.465	1	135,485
Area of object O			-		118.622	1	118.872
		Tetal of all ad-	Wildens '8'				5567.442


Total Floor Area of Upper Basement (C) = (A+8)	27526.686

LOWER BASEMENT - SERVICE AREA								
			Addition 'II'	-				
Description	Length (int)	Breadth (int)	Rese (mt)	Height (red)	Area (sqm)	No. of figures	Total Area (say	
Area of rectargle 1	36.043	5.865	-	1	93.754	1	99.794	
Area of rectangle 2	8.070	4.360	-	(6)	25.285	1	35.185	
Area of rectangle 3	30,770	6.025	-		64.800	1.	GLSB9	
Area of rectangle 4	36,040	5.420	-	2.8	86.537	1	96,907	
Area of rectangle 5	2.435	5.230		- 2	35,706	1	38.796	
Area of rectangle 6	2.900	3.13%	-		8.292	4	13.186	
Area of rectangle 7	3.795	1.200	-	-	4.692	1	4.482	
Area of rectangle 8	1370	6.405	-	-	0.596	1	0.586	
Area of rectangle 9	2.900	1.565	-	1.0	4.530	1	4,539	
Area of rectangle 10	2.960	3.500			27.860	1	27.860	
Area of rectangle 11	6.780	1.90%	-	- 6	26.476	1	26.476	
Area of rectangle 12	34.800	6,300		7.6	99.340	1	99.240	
Area of rectangle 13	32.345	6.730	-	1	217,682	1	217,662	
Area of rectangle 14	8.500	4.445	-		36,894	1	36,094	
Area of rectangle 15	30.240	5.850	-		59.900	1	19.1004	
Area of rectangle 16	20,640	0.485	-	1 2	4.628	1	4.628	
Area of rectangle 17	6.700	3.200		100	22.110	1	22.130	
Area of rectangle 18	6,650	5.500		1.0	36.575	1	36.575	
Area of rectangle 15	36.040	5.430	- 4	1.0	86.957	1	86.937	
Area of rectangle 20	6.985	2.900	-	100	20.297	2	40.503	
Area of rectangle 20	6.680	4.2%	-	-	26.557	1	28.557	
Area of triangle 32	-	120	37.750	13,995	369,029	1	363,033	
Area of rectangle 23	31.750	4.135	-		156,096	1	156,096	
Area of rectangle 24	21.830	18.770		1	234.894	1	254.854	
Area of rectangle 25	5.850	5.220		+:	90.880	1	30.890	
Area of rectangle 26	3.795	2.570			9.590	1	9.596	
Area of rectangle 27	5.580	5.270	-	1.	29.407	1	29.407	
Area of rectangle 28	11.095	5.220	-		57,707	1	57,707	
Area of rectangle 29	2.900	1.40%	-	100	4.075	3	4.025	
Area of rectangle 30	7.580	4.405	-	191	31.238	3	33.DB	
Area of rectangle 30	20.895	11,265	-	- 1	285,362	1	335,362	
Area of rectangle 32	7,000	4.18	-		26.736	2	57.552	
	Tor	tal Loover Basemen	Service Area	T			2195.291	
	+							
Area of Lower Basemen	t. (C)						17526.696	
Area provided for Servis	es on Lewer Base	ment (III)					2135.231	
Area provided for Parkin	ne on Lower Bases	next (C-D) trees					15391.495	


	000	OR SCHED	ULE		
TYPE	WIDTH	CILLEVL	LINTEL LVL.	SIZE (HxW)	REMARK
FD1	1200		2400	2400×1200	Fire Door
FD2	1100	-	2400	2400x1100	Fire Door
FD3	1200		2400	2400×1200	Fire Door
FD4	1500		2400	2400x1500	Fire Door
FD5	1200		2150	2150x1200	Fire Door
RS	3000	-	2750	2750x3000	Fire Door
D1	2000		2400	2400×2000	Door
D2	1200		2400	2400x1200	Door

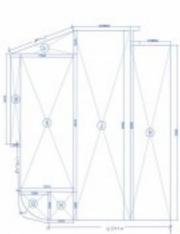



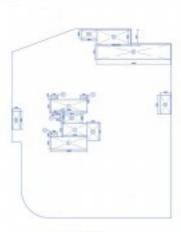


BASEMENT B

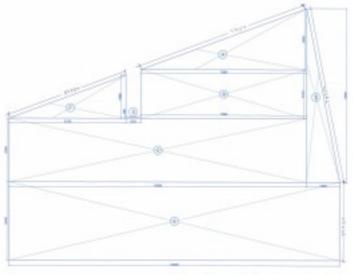

BASEMENT A

LOWER BASEMENT FLOOR- AREA CALCULATION SCALE 1:500

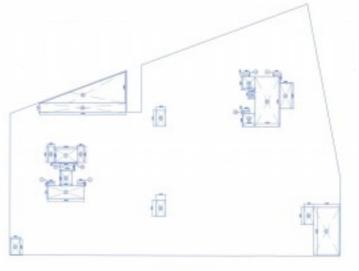

BASEMENT A

03 LOWER BASEMENT -SERVICE AREA CALCULATION SCALE 1:500



NOTES:

1) BLI FIXTURE PREMISED IN TOLLTS ARE SEE PER HISK.

2) BANDMEN BLL SE ARTHROALLY VENTLATED.

30 BLI SPACES FOARBOOK DECEMBRY.

20 DECEMBRY OF THE SEE PARTY SEL SE.

4) STANGES FOARBOOK CARROTY VALL SE.

30 FRE WITH SERVICE SERVICES, HOUSEMENT OF THE WITH SERVICES FREE SERVICES, LETS SEL MAD FOR THE MEMBRY SEL MAD FOR THE MEMBRY SEL SERVICES STANGES FOR SERVICES FREE SERVICES.

LETS SEL MAD AND THE ENTRY HOS DECLEDES SERVICES FREE SERVICES.

3) FREE SERVICE MANAGER AS PER HISC SELLIDES SERVE DESISTER; HAN DESISTER, SARVED DESISTER; HAN DESISTER, SARVED DESISTERS FROM COMPLIANCE.

Key Plan:

Project:

REVISED BASEMENT PLAN IN GROUP HOUSING SCHEME MEASURING 17.55 ACRES (LICENCE NO. 18 OF 2008) IN SECTOR—59 GURGAON MANESAR URBAN COMPLEX BEING DEVELOPED BY M/S BTVs BUILDWELL PVT, LTD. M/S ORNAMANTAL REALTORS PVT, LTD. M/S ADSON SOFTWARE PVT, LTD MANOMORE PVT, LTD. MANOMORE PVT,

CADORIFE BASE ENPORTS PVT.



STRUCTURAL CONSULTANT

Consulting MEP

Architect's Sign




Morphogenesis

N-859, Ponchaheel Pork, New Delhi, 110017, India. TELI 91 11 41829070 FAX: 91 11 26490301 E Mait: studio@morphogenesis.org

Drawing Title

LOWER BASEMENT AREA

Orawing No. North 85-06.1/06 Scole Dobe JAN 116

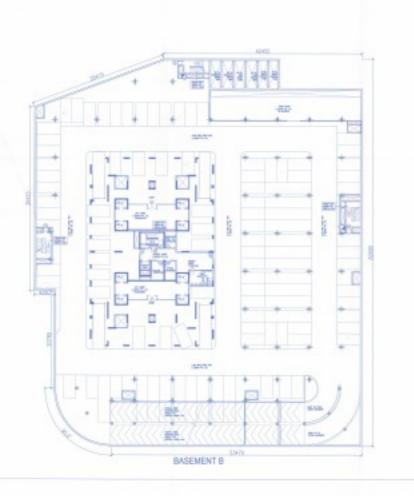



01 LOWER BASEMENT FLOOR PLAN @ -8700 LVL.

PARKING CALCULATIONS LOWER BASEMENT(A&B)

BASEMENT AREA = 17526.686 DEDUCTIONS = 2135.213 PARKING AREA = 15391.455 ECS @ 35 SQM / CAR = 439 PROPOSED = 410 CARS

THE MALE PROVIDED IN TOLITE AND AS POR PLACE. IN APPROVIDED AS TOLITE AND ASSOCIATED ASSOCIATED AND ASSOCIATED ASSOC

PROJECT BASEMENT PLAN IN GROUP HOUSING SCHEME MEASURING 17.55 ACRES (LUCENCE NO. 16 OF 2008) IN SECTOR-59 CURGACIN MANESAR URBAN COMPLEX BEING DEVELOPED BY M/S BTVS BULDWELL PVT. LTD. M/S OFNAMINATIAL REALTORS PVT. LTD.

M/S ADSON SOFTWARE PVT. LTD 84/000/Pst BASD GMPDRTS PVT. LTD.



Consulting MEP.

Architect's Sign




Morphogenesis (1979)


110017, beide.
TEL: 91 -11 41829070 Fixt 91 -11 20490301
E Mill: studie@residesgreeds.org


Drawing Title

PLAN & PARKING AREA

HS-05/06 Scole 444 716

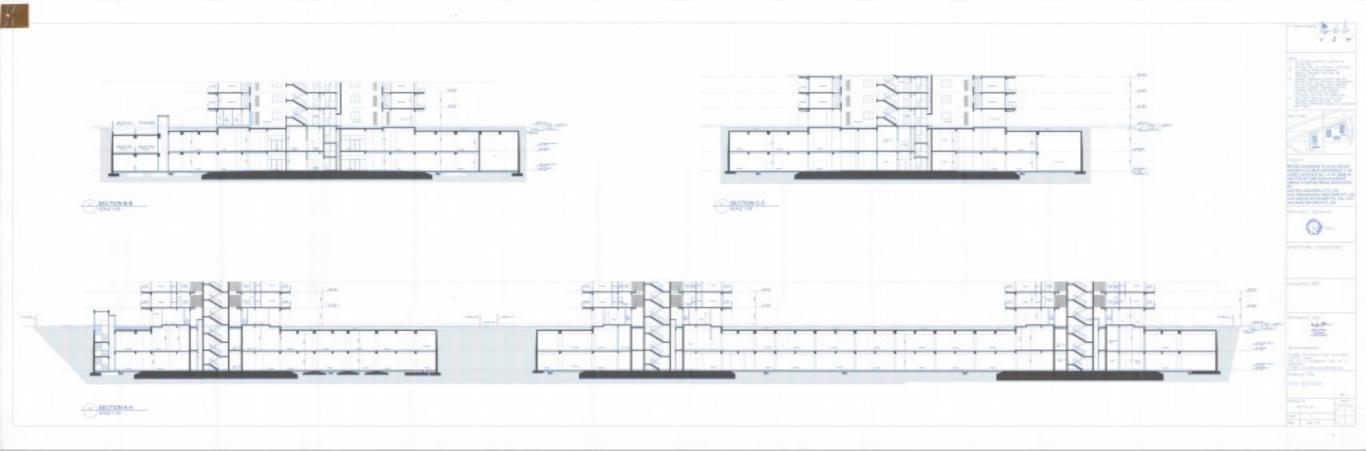


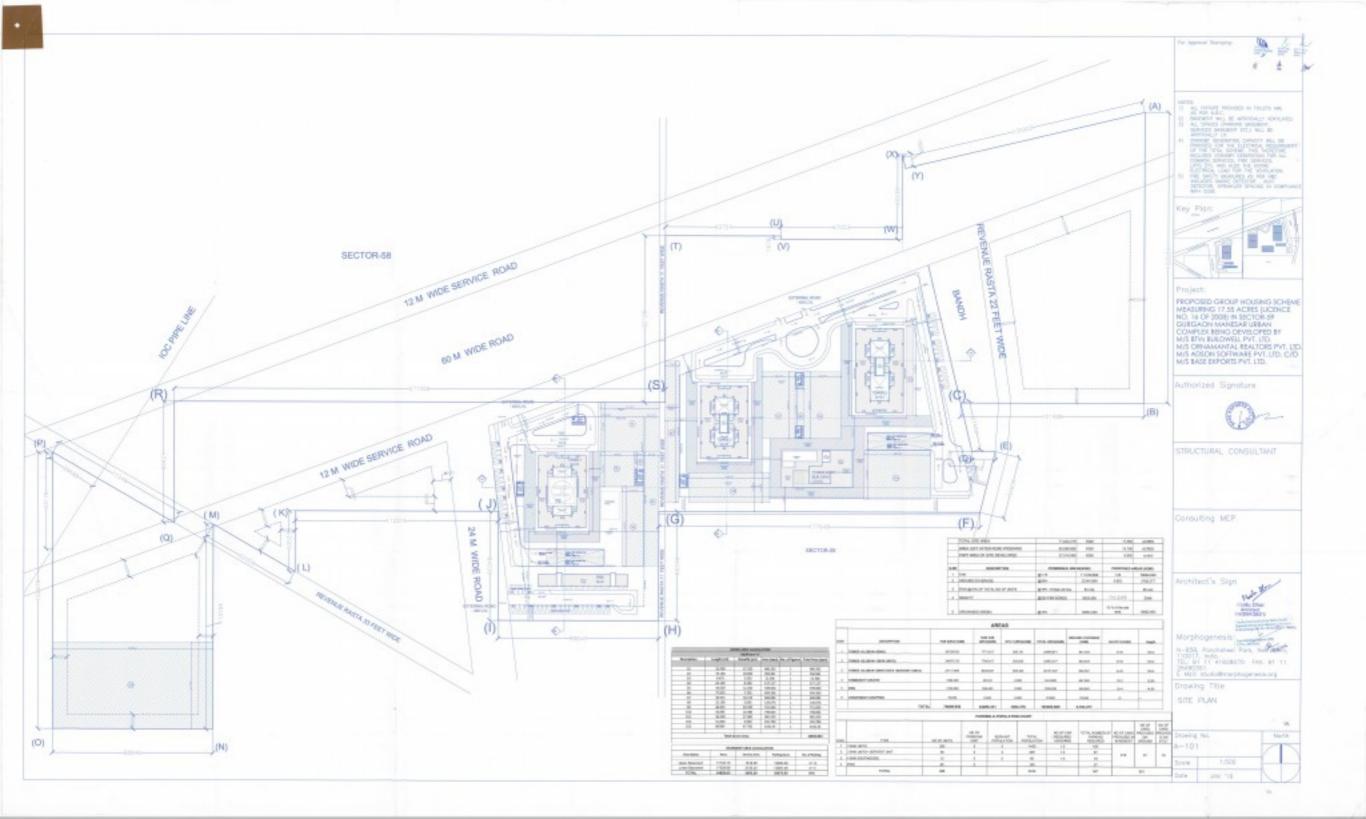

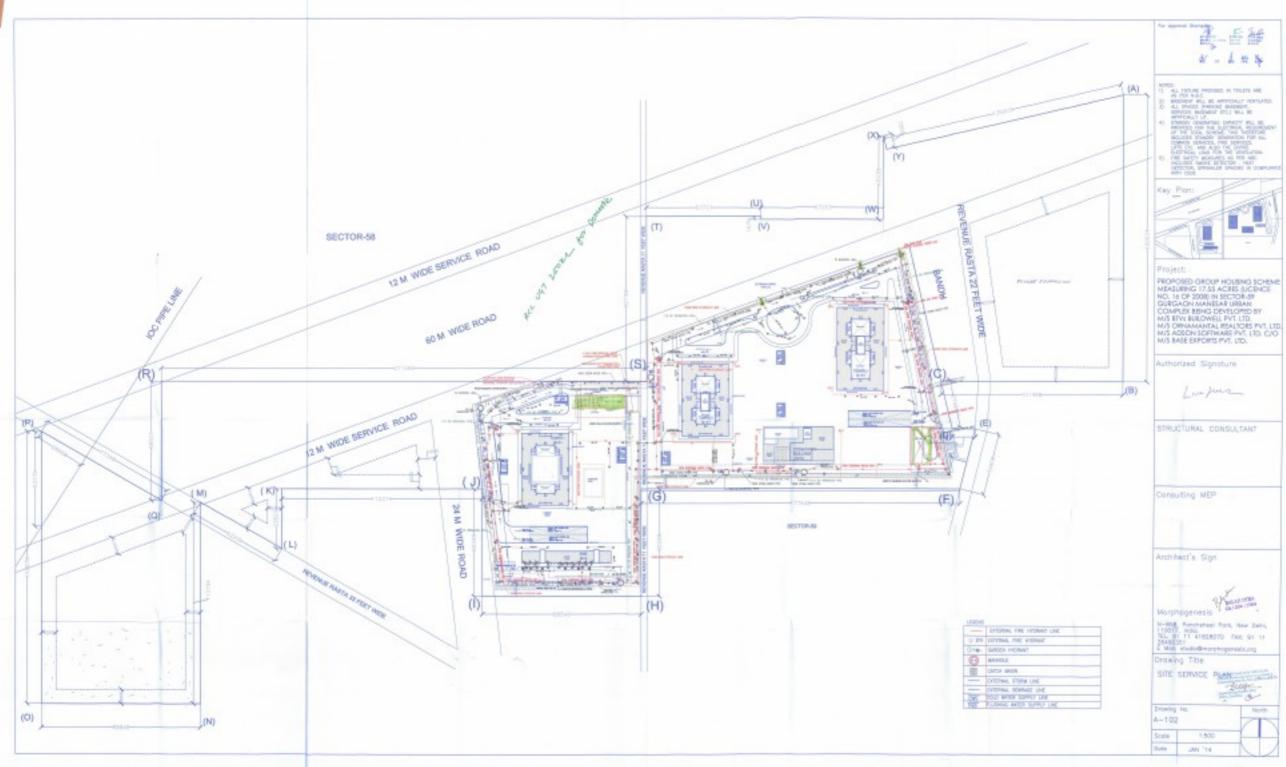





		se insed type!	-	person.			598.5
11		LARRES	SEMENT-307	ACE AREA			
			Addition T	100			
Oncerption	large (m)	Breakle jord	Ama jest	(MATING	Area (squr)	No. of Spores	Total Area (say
ting of somegic 1	0.00	1.664	_		29.001		75.000
free of extending (889	3.180			11,704	3.	31,796
Area of recturgly 5	21.540	5.005			70,500	2.	75,000
fore of motorgie d	846.	4.861			303,089	- 2	163,369
Aries of rectungle 5	proces.	1,900	-		90,000	3.	90.000
Arms of rentarigie of	1.6%	1,261			58,580	1	58,586
Amenitordingly 7	0.86	1.189			5398	3.	1.00
Artisa of reimorglo. If	1-670	5.95	-		245	- 1	149
heat of reclaration 8	7.80	1.101			20,660	3	25,960
trouch solvegie 10	5.00	0.90%			(9.48)	2	(8.4%)
francoi mobergio (2)	6.16	4.90			208,754	2.7	38.79
mount witings 11	8.88%	4.46			36,694	2	36,694
ionical materials (1)	0.140	1.481			15.604	- 1	15.674
monet inchanges 14	8.08-	8,989			10,000	2.	10,404
import voltarigis, 15	SEASO	4.985			10.3.000		111.101
tioned makes by	25.406	1.900			45,681	- 3	45,600
mount notargle 11	1/98	1,996			10.097	- 2	(8)(9)
School waterpla 18	1,246	1.601			2.768		2.86
throad widespie 19	1/100	4.00		. 4.	08.501	2	28,700
Article (Strategis 20)	1.4		13.500	5.000	76,684	1	35.654
items of well people [1]	20,000	23.940			204.703	3.	394.701
strough technique \$1	768	4.0%			(8.7%	- 1	18.5%
forced materials [3]	700	4309			38.7%	3	34.79
Brissof technolis 58	20.00	3.86		1	24.001	3.	58.884
Smarl mangle 25	20.00	A Miles	1		96,764	1	18,754
Microff midangle 26	3676	4.00			303,089	3	22,109
Amond totaligis 47	1.00	A.7600			20257	- 1	201001
interferings (t	20.000	1.800			46,289	3	46,396
Pi algoritor buscos	2.405	1.290			14.707		56188
timed missage M	7.80	3.184	-		24,365	- 1	26,366
monet notinge 11	21400	4.40	-		14.904	- 1	26,009
	No.	Actions bearing	e Namino, Iran	T.			800 PC
treat of Hyper Resources	191						37991.0
							2000

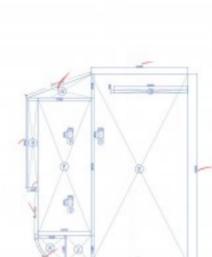

BASEMENT B

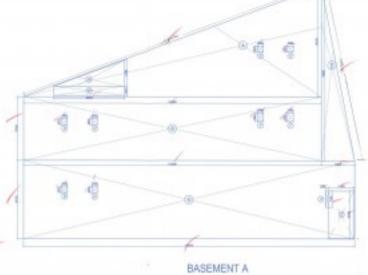

UPPER BASEMENT FLOOR- AREA CALCULATION SCALE 1:500

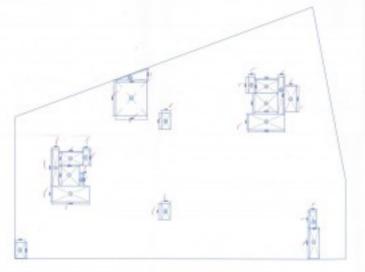

BASEMENT A

							1
	800	HICHER	AL.				
THE			DESIDE	820 (9990)	REHAME	The state of the s	
75%	1300	-	360	2600-1200	Fre Saur		
FDE	1300	-	360	2000-000	Fire Boar		
FDE	4300		3490	2600-220	Fre Bur		
104	1901	100	3400	PR04:500	Kirp Storr		
FREE	1,000		2130	1230-1270	Ryle Steer		
155	3001		276	250000	Frie Sone		
	300	-	2400	2900-2000	See:		
- 04	ERGE	-	2400	2400-1200	Engr	1	

BASEMENT B

UPPER BASEMENT -SERVICE AREA CALCULATION SCALE 1:500

For Approve Stamping



MOTES

1) ALL PRIMITE PROVIDED IN TOLETS ARE
AS PER HAZ.

2] BECONDIN INL. BE ATTRICALLY VOYENED.

2] ALL SPICES (PROVIDE BASIMENT, SPINCES BASIMENT EXT.) WILL BE
ATTRICALLY LIF.

4] STRUCKET DEPOSITION OF OPENITY BILL BE
PROVIDED FOR THE DESCRIPTION OF THE TOTAL STRUCKET.

ATTRICALLY THROUGH CONVENTION FOR ALL
COMMAN SERVICES. HOW SERVICES,

LET'S CTO. WID ASO THE DETERM.

ELETIS CTO. WID ASO THE VOYEN, FOR ALL
COMMAN SERVICES. BY THE MEDITAL BE
WOLUMES SAMEN RESERVED IN THE TOTAL

ELETIS CO. WID ASO THE VOYEN, AND

ELETIS CO. WID ASO THE VOYEN ASO THE VOYEN ASO

ELETIS CO. WID ASO THE VOYEN ASO THE VOY

Key Plan:

Project:

REVISED BASEMENT PLAN IN GROUP HOUSING SCHEME MEASURING 17.55 ACRES (LICENCE NO. 16 OF 2008) IN SECTOR-59 GURGAON MANESAR URBAN COMPLEX BEING DEVELOPED BY M/S BTVs BULDWELL PVT. LTD. M/S ORNAMANTAL REALTORS PVT. LTD.

e Abonized Bäigereberen rvt. LTD.



STRUCTURAL CONSULTANT

Consulting MEP

Architect's Sign-




Morphogenesis

N-558, Parchcheel Park, New Delhi, 110017, India. TELI 91 11 41828070 FAX: 91 11 26490321 E Maik studio@morphogenesis.org

Drawing Title

UPPER BASEMENT AREA

Drawing No. North 88-05.1/06 Scale Date: JAN THE

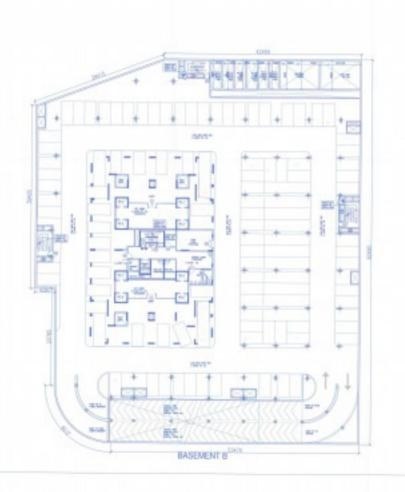



PARKING CALCULATIONS UPPER BASEMENT (A&B)

BASEMENT AREA = 17102.15 DEDUCTIONS = 1818.057 PARKING AREA = 15284.092 ECS @ 35 SQM / CAR = 436 PROPOSED = 408 CARS

AL FORME PROVIDED IN TRUETS AND AL FOR BUILD, OF APPROVING AND PROPERTY. ALL SHAPES (PROMOTE STEELING). 2004CLS (PROMOTE STEELING).

Key Planc

Project

REVISED BASEMENT PLAN IN GROUP HOUSING SCHEME WEASURING 17.50 ACRES

M/S BYS BULDWELL PVT. LTD.
M/S GENAMANTAL REALTORS
PVT. LTD.
W/S ADSON SOFTWARE PVT. LTD.
ByStonyBoldWagridweners PvT.
LTD.



Consulting MEP



N-839, Parahelinet Pork, New Delle, 110017, India, TBL 91 11 41829070 PAC 31 11 25490350 E Neik skulls@morphogersck.org


Orawing Title


PLAN & PARKING AREA


Irowing No. 85-08/08 ficute


384 116


No year

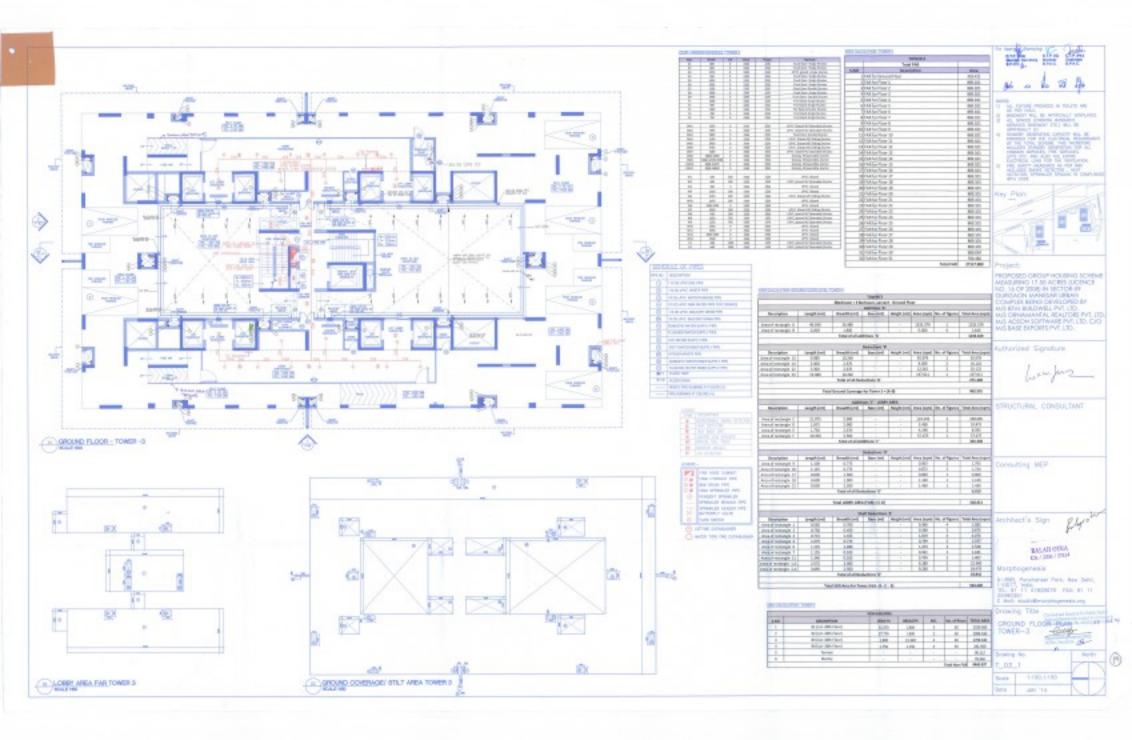

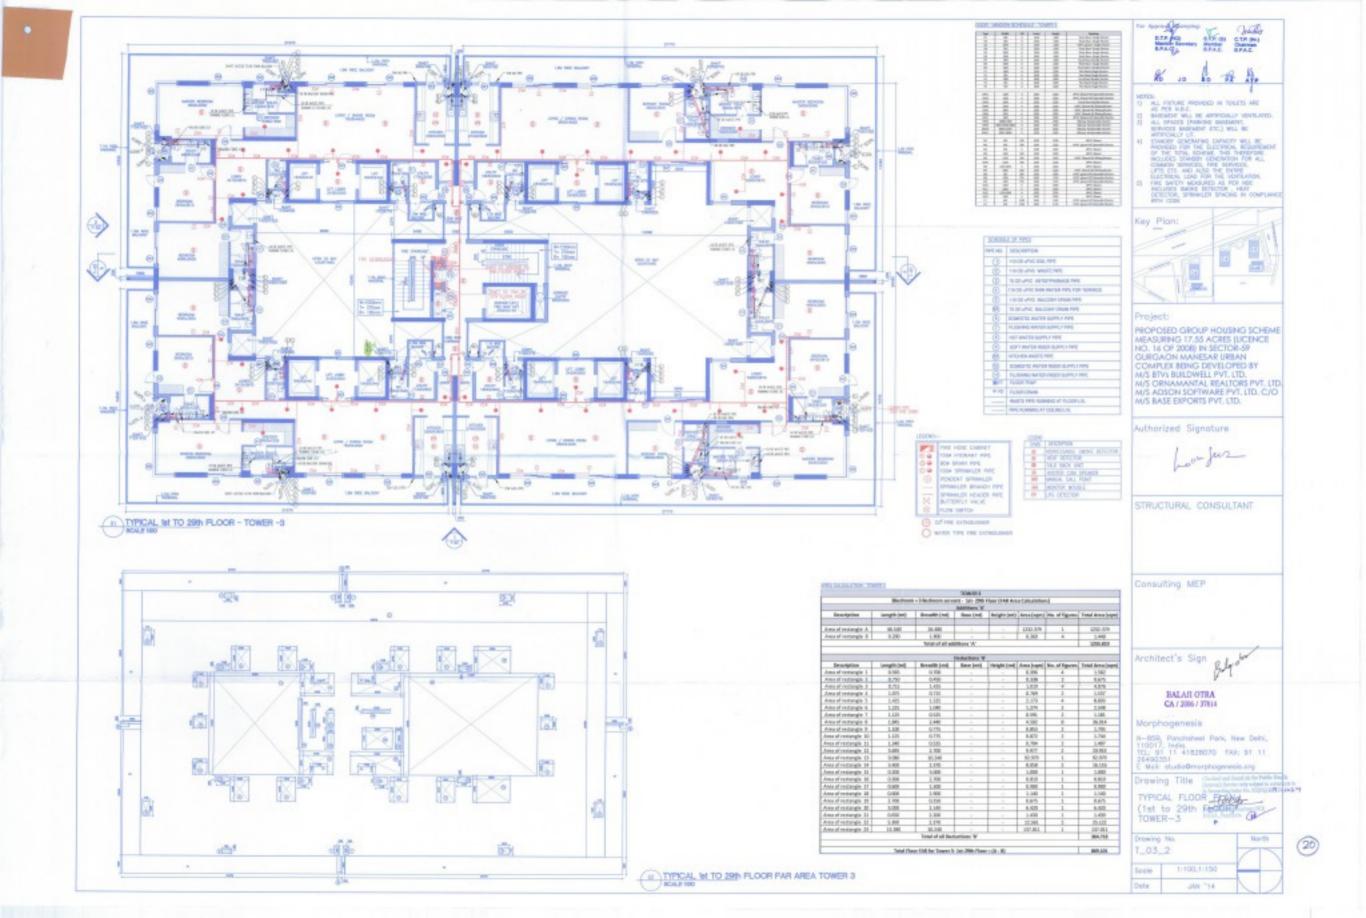


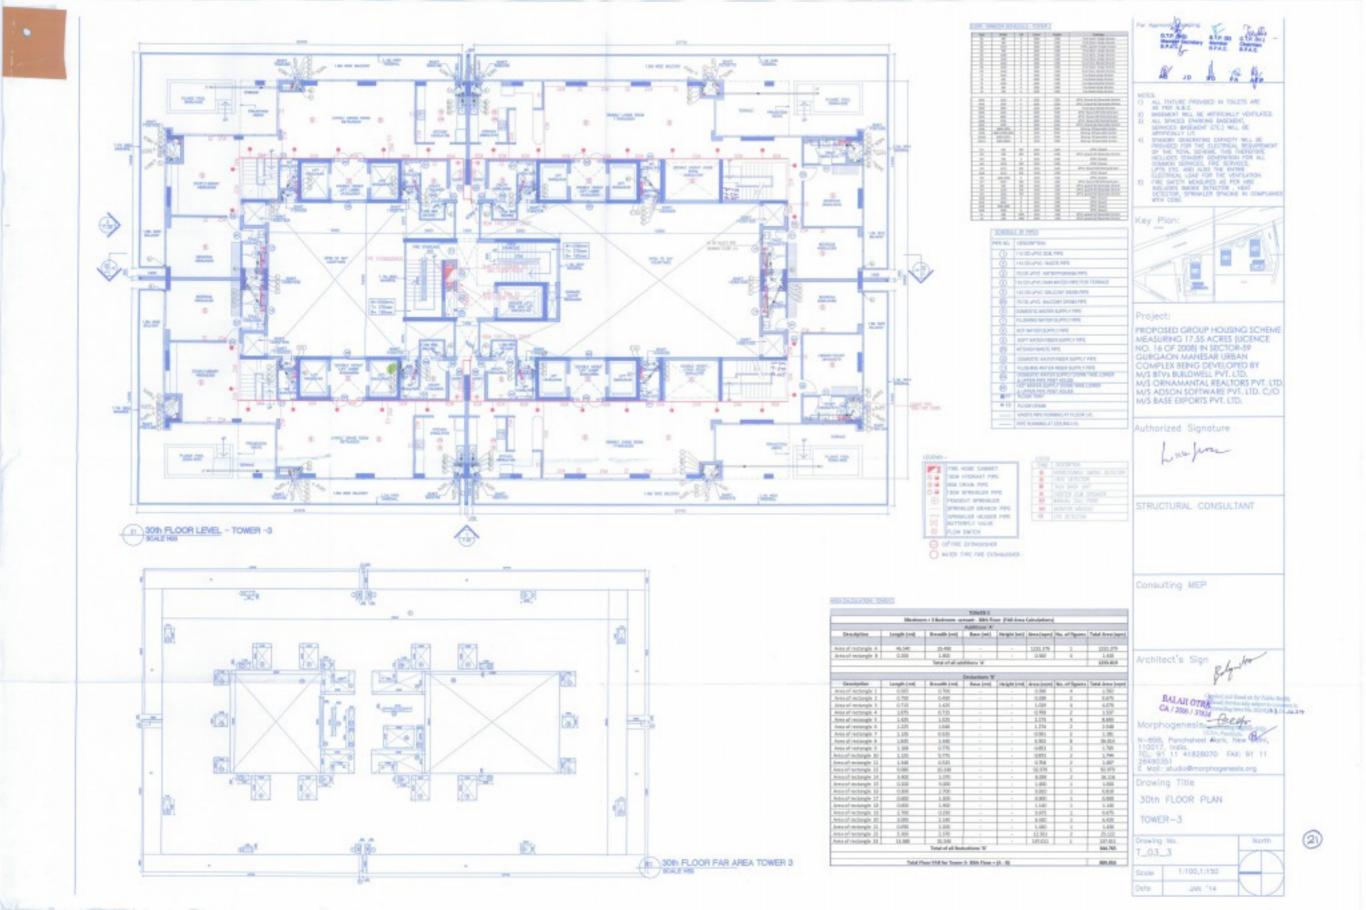


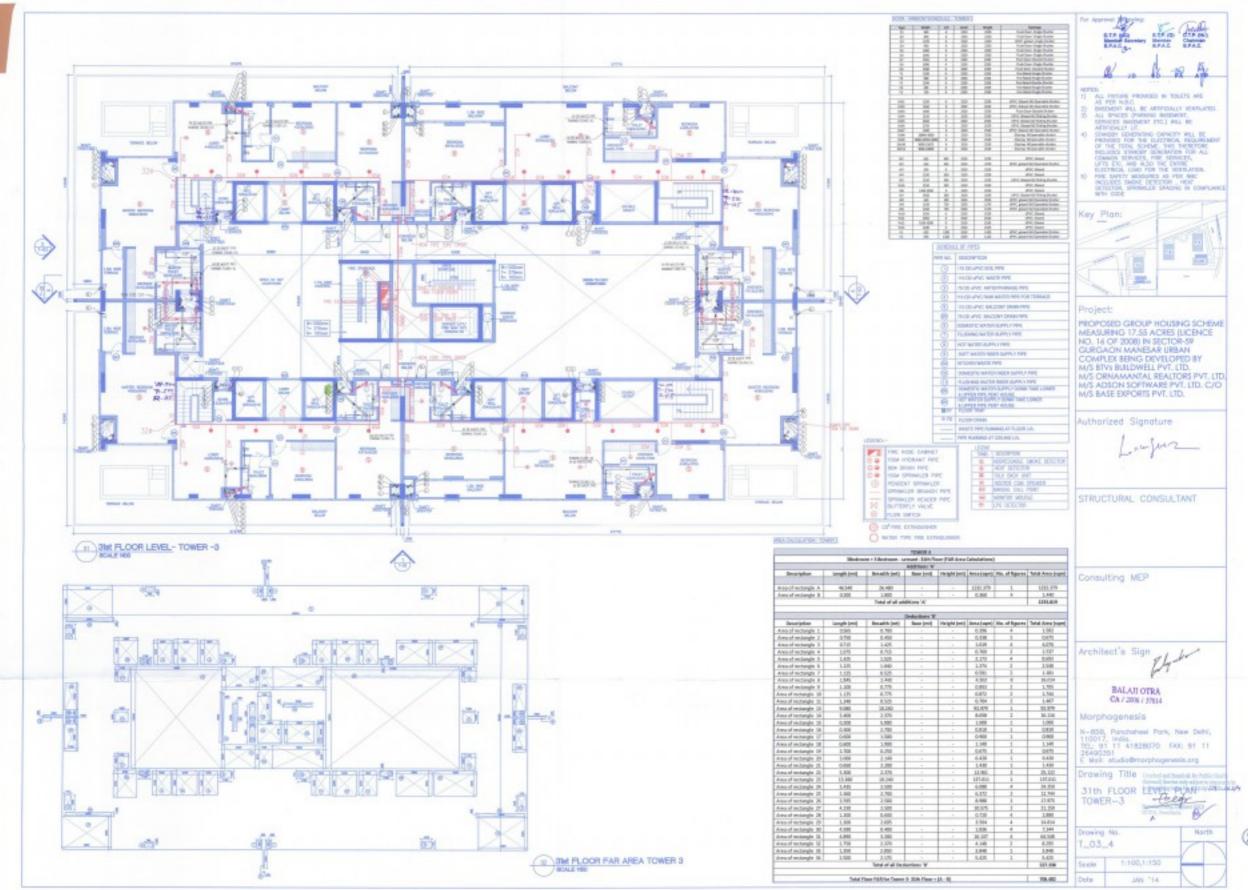

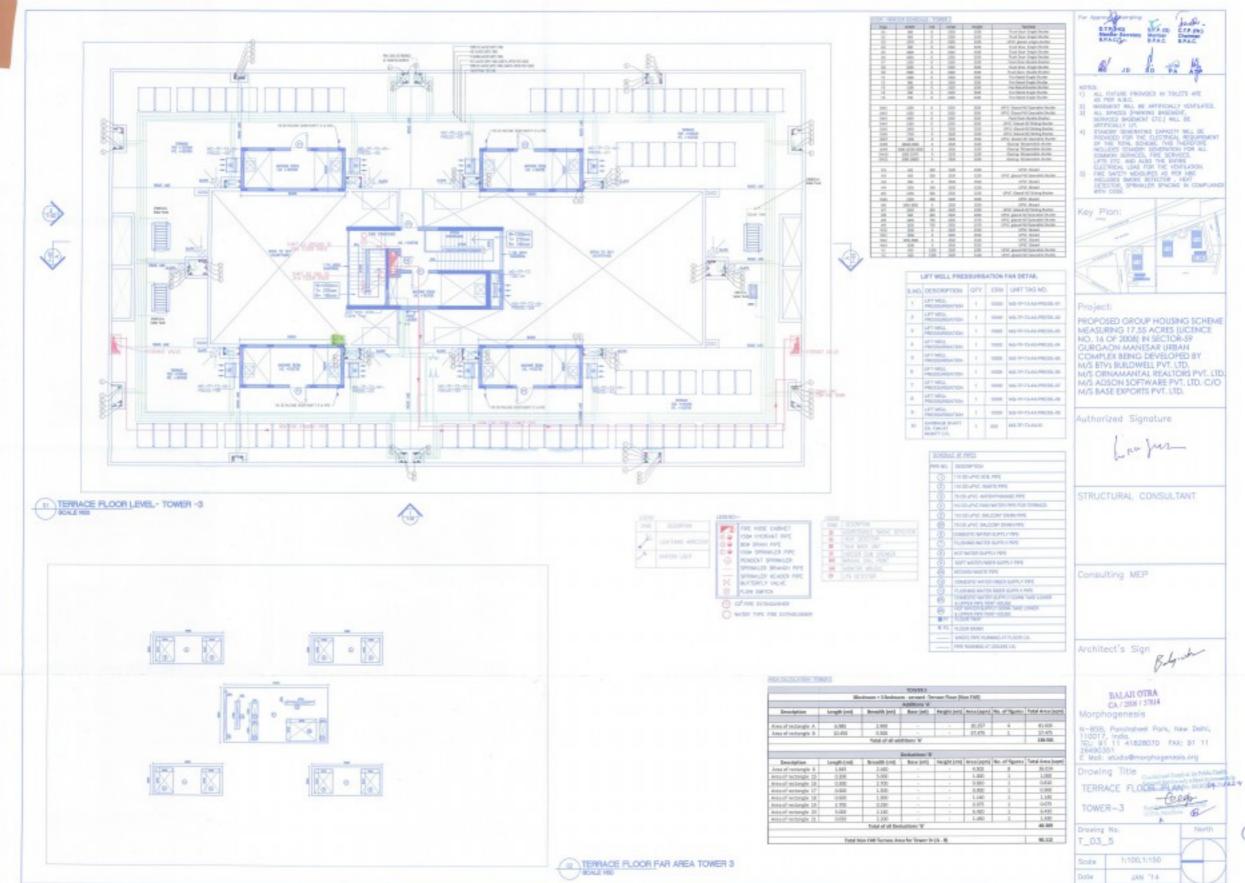

(24)

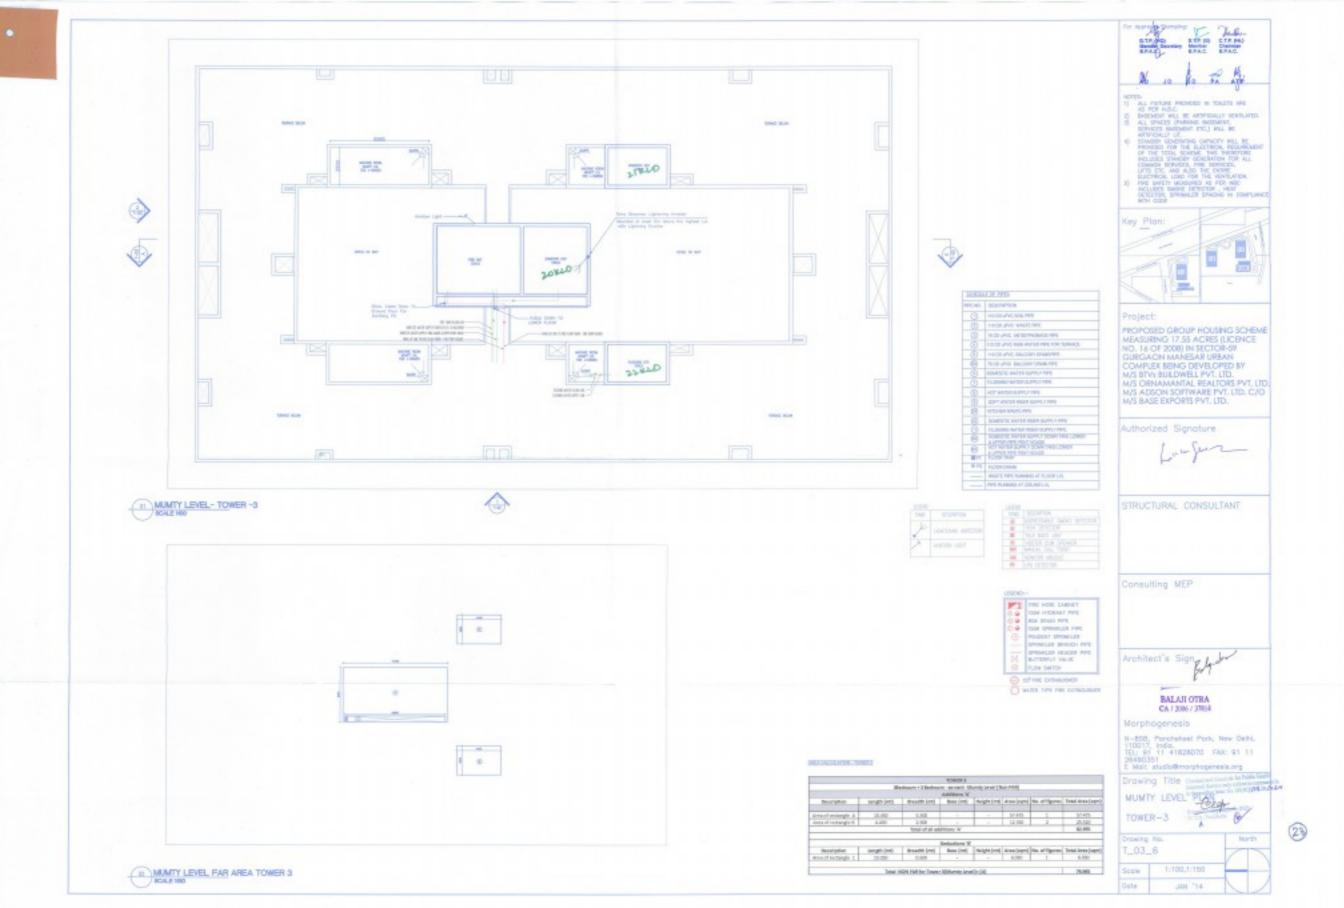

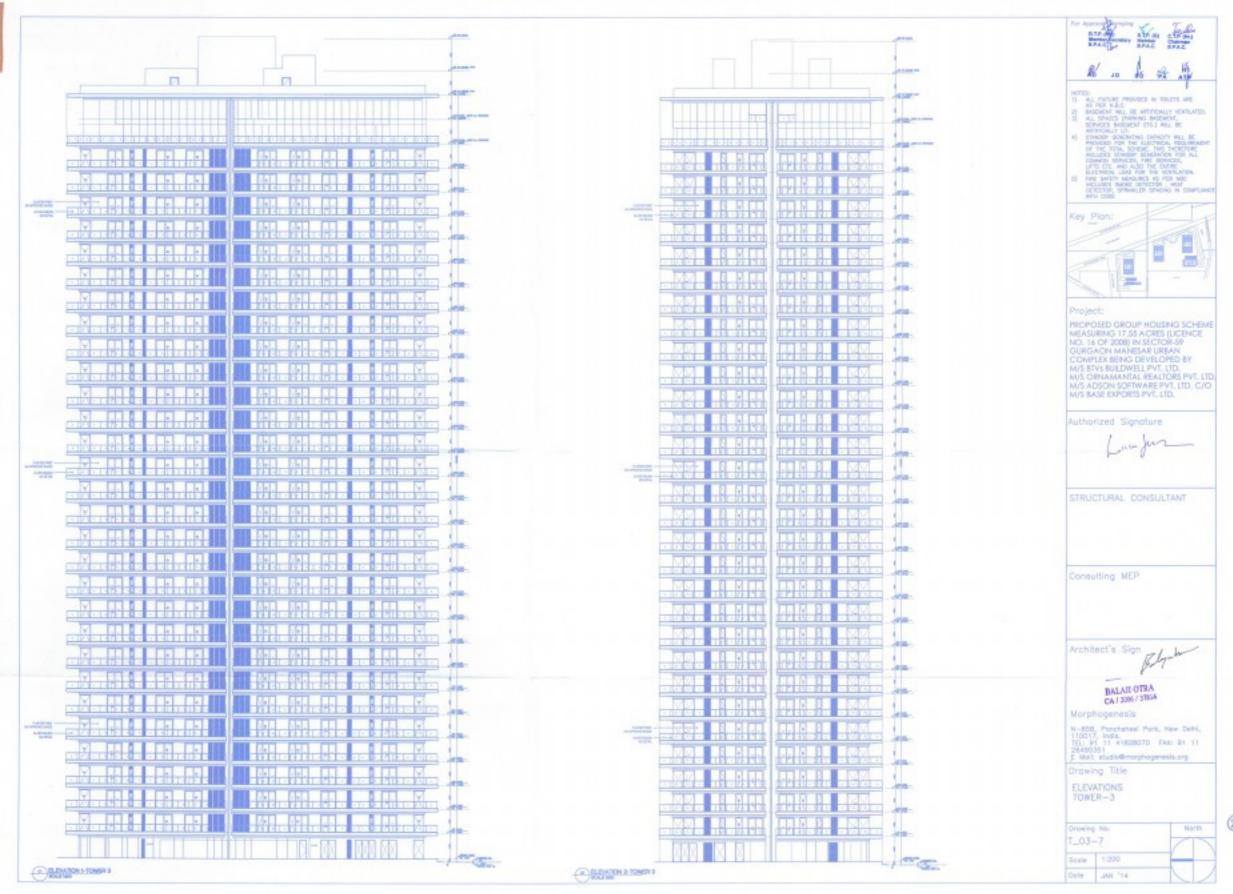

(25)

ARTMENT SPACES	FEATURES	FINISHES
	WALLS	LOW VOC ACRYLIC EMULSION PAINT
LIVING ROOM/ DINING	FLOORING	ITALIAN MARBLE
ROOM/FAMILY LOUNGE	CEILING	LOW VOC ACRYLIC EMULSION PAINT & PART GYPSUM FALSE CEILING
,	DOORS	BOTH SIDE VENEER FINISH FLUSH DOOR WITH HARDWOOD FRAME
	WINDOWS	DOUBLE GLAZED UPVC FRAMED UNIT
	WALLS	LOW VOC ACRYLIC EMULSION PAINT
BEDROOMS	FLOORING	LAMINATED WOODEN FLOORING
	CEILING	LOW VOC ACRYLIC EMULSION PAINT & PART GYPSUM FALSE CEILING
	DOORS	BOTH SIDE VENEER FINISH FLUSH DOOR WITH HARDWOOD FRAME
	WINDOWS	DOUBLE GLAZED UPVC FRAMED UNIT
		WALL TILES UPTO TWO FEET ABOVE THE COUNTER AND ACRYLIC EMULSION
MITCHEN	WALLS	PAINT IN BALANCE AREA
KITCHEN	FLOORING	ANTI-SKID VITRIFIED TILES
	CEILING	LOW VOC ACRYLIC EMULSION PAINT & PART GYPSUM FALSE CEILING
	WHITE GOODS	MODULAR KITCHEN WITH CHIMNEY AND HOB
	FLOORING	ANTI-SKID VITRIFIED TILES
	CEILING	LOW VOC ACRYLIC EMULSION PAINT WITH GYPSUM FALSE CEILING
TOILETS	DOORS	BOTH SIDE LAMINATED FINISH FLUSH DOOR WITH HARDWOOD FRAME
TOILETS	WINDOWS	SINGLE GLAZED UPVC WINDOWS WITH FROSTED GLASS
	CP & SANITARY FITTINGS	TOTO, GROHE OR EQUIVALENT
	WALLS	VITRIFIED TILES UPTO FALSE CEILING WITH ITALIN MARBLE COUNTER TOP
	RAILING	SS HANDRAIL WITH LAMINATED TOUGHENED GLASS AND STONE COPING
BALCONIES/TERRACES	FLOORING	ANTI-SKID VITRIFIED TILES
	CEILING	SUPERIOR QUALITY EXTERIOR GRADE PAINT

APARTMENT SPACES	FEATURES	FINISHES			
	FLOORING	ANTI-SKID VITRIFIED TILES			
	CEILING	LOW VOC OBD			
SERVANT ROOM/TOILET	DOORS	BOTH SIDE LAMINATED FINISH FLUSH DOOR WITH HARDWOOD FRAME			
SERVANT ROOM/TOILET	WINDOWS	SINGLE GLAZED UPVC FRAMED UNIT			
	CP & SANITARY FITTINGS	JAQUAR, HINDWARE OR EQUIVALENT			
	WALLS	LOW VOC OBD			
	FLOORING	ITALIAN MARBLE			
PRIVATE APARTMENT LIFT	CEILING	LOW VOC ACRYLIC EMULSION PAINT			
LOBBIES	DOORS	BOTH SIDE VENEER FINISH FLUSH DOOR WITH HARDWOOD FRAME			
	WINDOWS	SINGLE GLAZED UPVC FRAMED UNIT			
	WALLS	STONE CLADDING WITH LOW VOC ACRYLIC EMULSION PAINT			

	ADDITIONAL CHARGABLE FEATURES* - SOLARIS (TOWER-C)						
WHITE GOODS IN KITCHEN	MICROWAVE, DISHWASHER, OVEN AND BUILT-IN-REFRIGERATOR						
WARDROBES	MADE FROM MR PLY & GERMAN HARDWARE IN PU AND VENEER FINISH IN ALL BEDROOMS						
AUTOMATION/OTHERS	CENTRAL AC CONTROL, CURTAIN CONTROL - LIVING AND DINING AREA, ELECTRONIC MAINDOOR LOCK &						
ACTOMATION/OTHERS	OCCUPANCY SENSORS IN TOILETS						

