

H. L. S. S. P. (P)
 Member
 B.P.A.C.
 D. T. P. (P)
 Member
 B.P.A.C.
 4885
 25/11/2025


SYMBOL	DESCRIPTION
☐	FIRE HOSE CABINET
○	1500 MS FIRE HYDRANT PIPE LOW ZONE BASEMENT TO 13TH FLOOR
○	1500 MS FIRE HYDRANT PIPE HIGH ZONE 14TH TO 19TH FLOOR
○	800 DRAIN PIPE LOWER ZONE
○	800 DRAIN PIPE UPPER ZONE
○	1500 MS FIRE SPRINKLER PIPE LOW ZONE BASEMENT TO 14TH FLOOR
○	1500 MS FIRE SPRINKLER PIPE HIGH ZONE 15TH TO 19TH FLOOR
○	4kg CO2 FIRE EXTINGUISHER
○	4.5kg ABC TYPE FIRE EXTINGUISHER

SYMBOL	DESCRIPTION
—	1500 FIRE EXTERNAL PIPE
—	1500 3-WAY CONNECTION PIPE
—	1500 4-WAY CONNECTION PIPE
—	1000 BORE WELL PIPE
—	650 BORE WELL PIPE
—	1500 SPRINKLER PIPE UPPER ZONE
—	1500 SPRINKLER PIPE LOWER ZONE
—	1500 HYDRANT PIPE UPPER ZONE
—	1500 HYDRANT PIPE LOWER ZONE
—	1500 WATER CURTAIN PIPE
—	1000 EXHAUST PIPE
—	1000 EXHAUST PIPE
—	1000 SUMP PIPE
—	DOMESTIC RISER PIPE
—	FLUSHING RISER PIPE

SYMBOL	DESCRIPTION
—	SMOKE FRESH AIR DUCT
—	SMOKE EXHAUST AIR DUCT
—	STAIRCASE AIR DUCT
—	LIFT LOBBY & WELL AIR DUCT
—	NORMAL EXHAUST AIR DUCT
—	NORMAL FRESH AIR DUCT
—	BASEMENT ZONE LINE
—	AXIAL FLOW FAN
—	VOLUME CONTROL DAMPER
—	LOUVER
—	EXHAUST AIR GRILLE
—	SUPPLY/FRESH AIR GRILLE
—	CEILING CUTOFF & SHAFT

UG TANK BELOW UP PLAN
 NOTE: THE BASEMENT IS MECHANICALLY VENTILATED AND BUILDING IS FULLY SPRINKLED
 CLIENT: LAMOSE INFRA LLP
 PROJECT: PROPOSED RETIREMENT HOUSING PROJECT (UNDER RETIREMENT HOUSING POLICY DATED 04.11.2024) OVER AN AREA MEASURING 1.69375 ACRES LICENSE NO. 68 OF 2025 DATED 07.05.2025 IN THE REVENUE ESTATE OF VILLAGE SIKANDERPUR BADHA SECTOR - 84 GURUGRAM MANESAR URBAN COMPLEX BEING DEVELOPED BY LAMOSE INFRA LLP.
 SCALE: 1:200
 DRAWING NAME: BASEMENT FLOOR PLAN & AREA DIAGRAM
 DRAWING NO.: SUB-03

VIMAL RAJAJ
 Architect
 1100
 LAMOSE INFRA LLP
 ARCHITECT'S SIGN
 APPLICANT'S SIGN

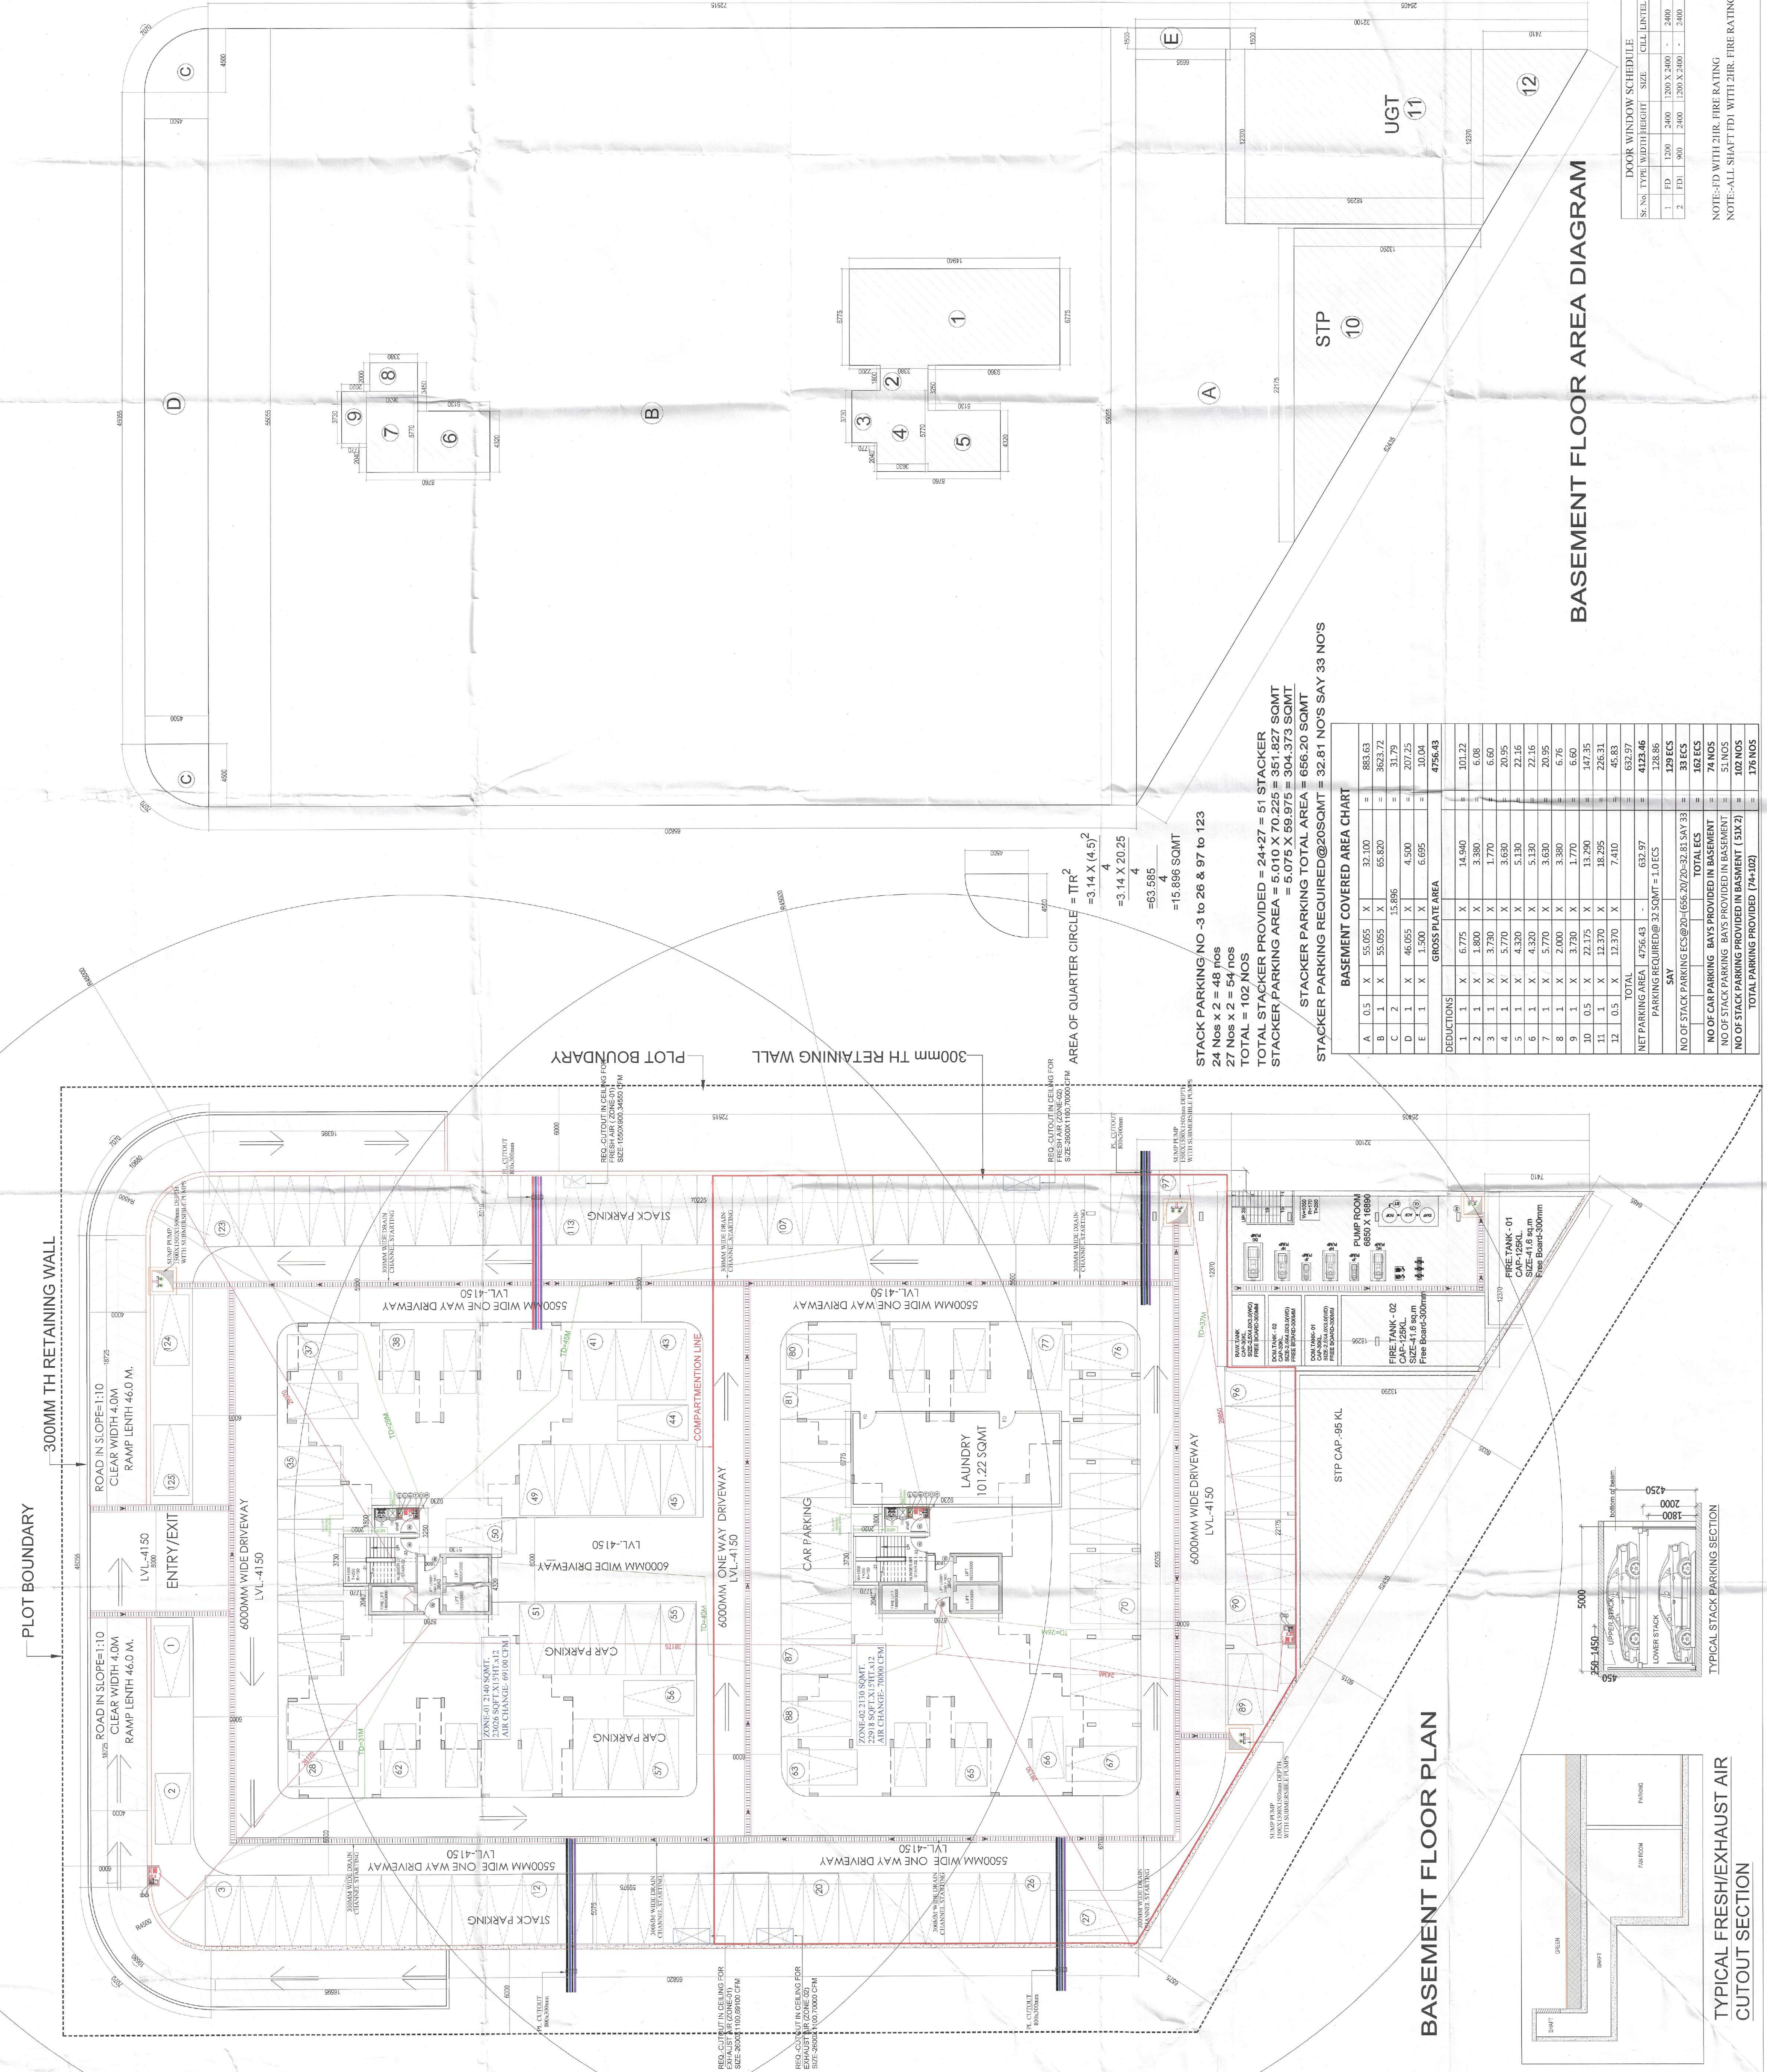


AREA OF QUARTER CIRCLE = $\pi R^2 = 3.14 \times (4.9)^2 = 3.14 \times 20.25 = 63.685$
 = 15.896 SOMT
 STACKER PARKING NO - 3 TO 28 & 97 TO 123
 24 Nos x 2 = 48 nos
 27 Nos x 2 = 54 nos
 TOTAL = 102 NOS
 STACKER PARKING PROVIDED = 24+27 = 51 STACKER
 TOTAL STACKER PROVIDED = 5.010 X 70.225 = 351.827 SOMT
 STACKER PARKING AREA = 5.075 X 59.975 = 304.373 SOMT
 STACKER PARKING REQUIRED @ 20SQMT = 666.20 SOMT
 STACKER PARKING REQUIRED @ 20SQMT = 32.81 NOS SAY 33 NOS

NO.	TYPE	WIDTH	HEIGHT	SIZE	CELL	LINTEL
1	FD	1200	2400	1200 X 2400	1	2400
2	FD	2400	2400	1200 X 2400	1	2400

DOOR WINDOW SCHEDULE
 NOTE: FD WITH 21R. FIRE RATING
 NOTE: ALL SHAFT FDI WITH 21R. FIRE RATING

BASEMENT COVERED AREA CHART
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BASEMENT FLOOR PLAN

BASEMENT FLOOR AREA DIAGRAM

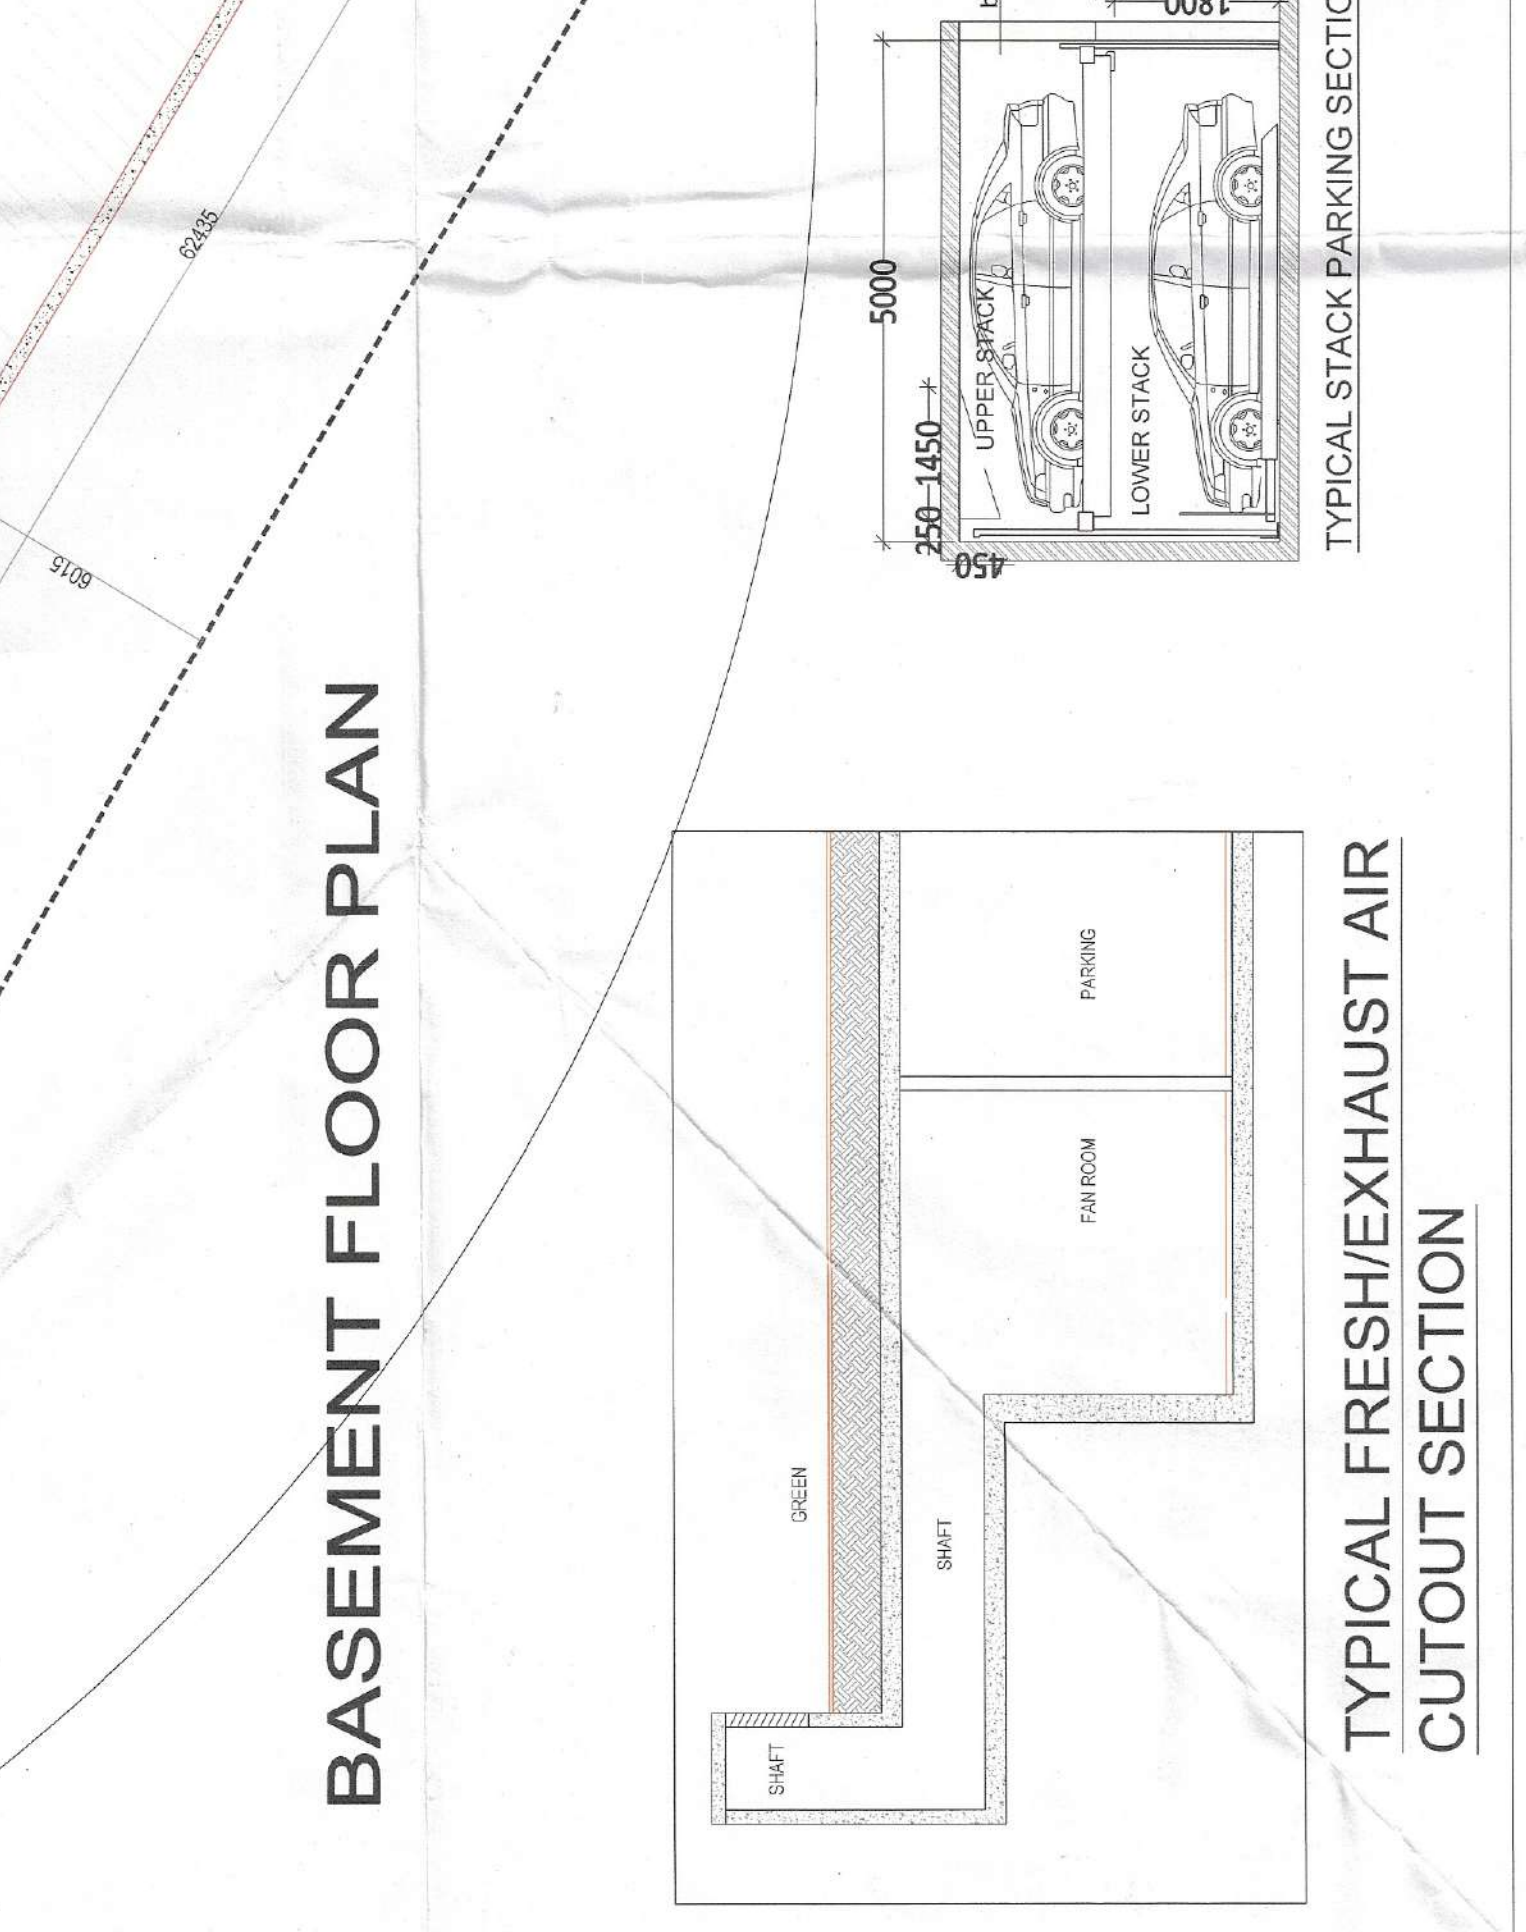TYPICAL FRESH/EXHAUST AIR CUTOFF SECTION