

Note :-
1. BUILDING WILL BE DESIGNED (STRUCTURES) AS PER RELEVANT IS CODES FOR EARTH QUAKE RESISTANCE.

PROJECT
REVISED BUILDING PLANS OF COMMERCIAL COLONY (TOTAL MEASURING 17.875 ACRES) LICENCE NO. CO/1000 DATED 25.10.2007 & LICENCE NO. 199 NO. 247 OF 2007 DATED 25.10.2007 & LICENCE NO. 199 IN SECTOR-42, GURUGRAM MANESAR URBAN COMPLEX INFRASTRUCTURE DEVELOPED BY PIONEER URBAN LAND & INFRASTRUCTURE LTD.


CLIENT
PIONEER URBAN LAND & INFRASTRUCTURE LTD.
Pioneer Urch
Near Golf Course Extension Road,
Gurgaon, Haryana - 122001

DESIGN ARCHITECT
RSP
RSP Design consultants
(India) Pvt. Ltd.
101, First Floor, Brijesh Business Tower, Sector 45, Sohna Road
Gurgaon, Haryana - 122001
REG. NO. HRA/REG/2013/REG/304/REG/404, BKA/REG/2007/REG/001
TEL: 2658988 FAX: 2658988
EMAIL: rsp@rspindia.com www.rspindia.com


ASSOCIATE ARCHITECT
RISMS
RISMS ARCHITECTS PVT. LTD.
89, Nara Niwas, Bhawanij Kunj
(Behind D2), Vasant Kunj,
New Delhi - 110070.
Tel: 011-26888616, 26888617
WWW.RISMS-ARCH.COM

Handwritten signatures and stamps of project team members, including dates and initials.

ARCHITECT'S SEAL & SIGNATURE
OWNER'S SEAL & SIGNATURE
JUNE - 2024 Scale: 1:100
Drawing No: CR-01
GROUND FLOOR PLAN & SHED FOUNDATION (CLUB)
28/08/2024-3

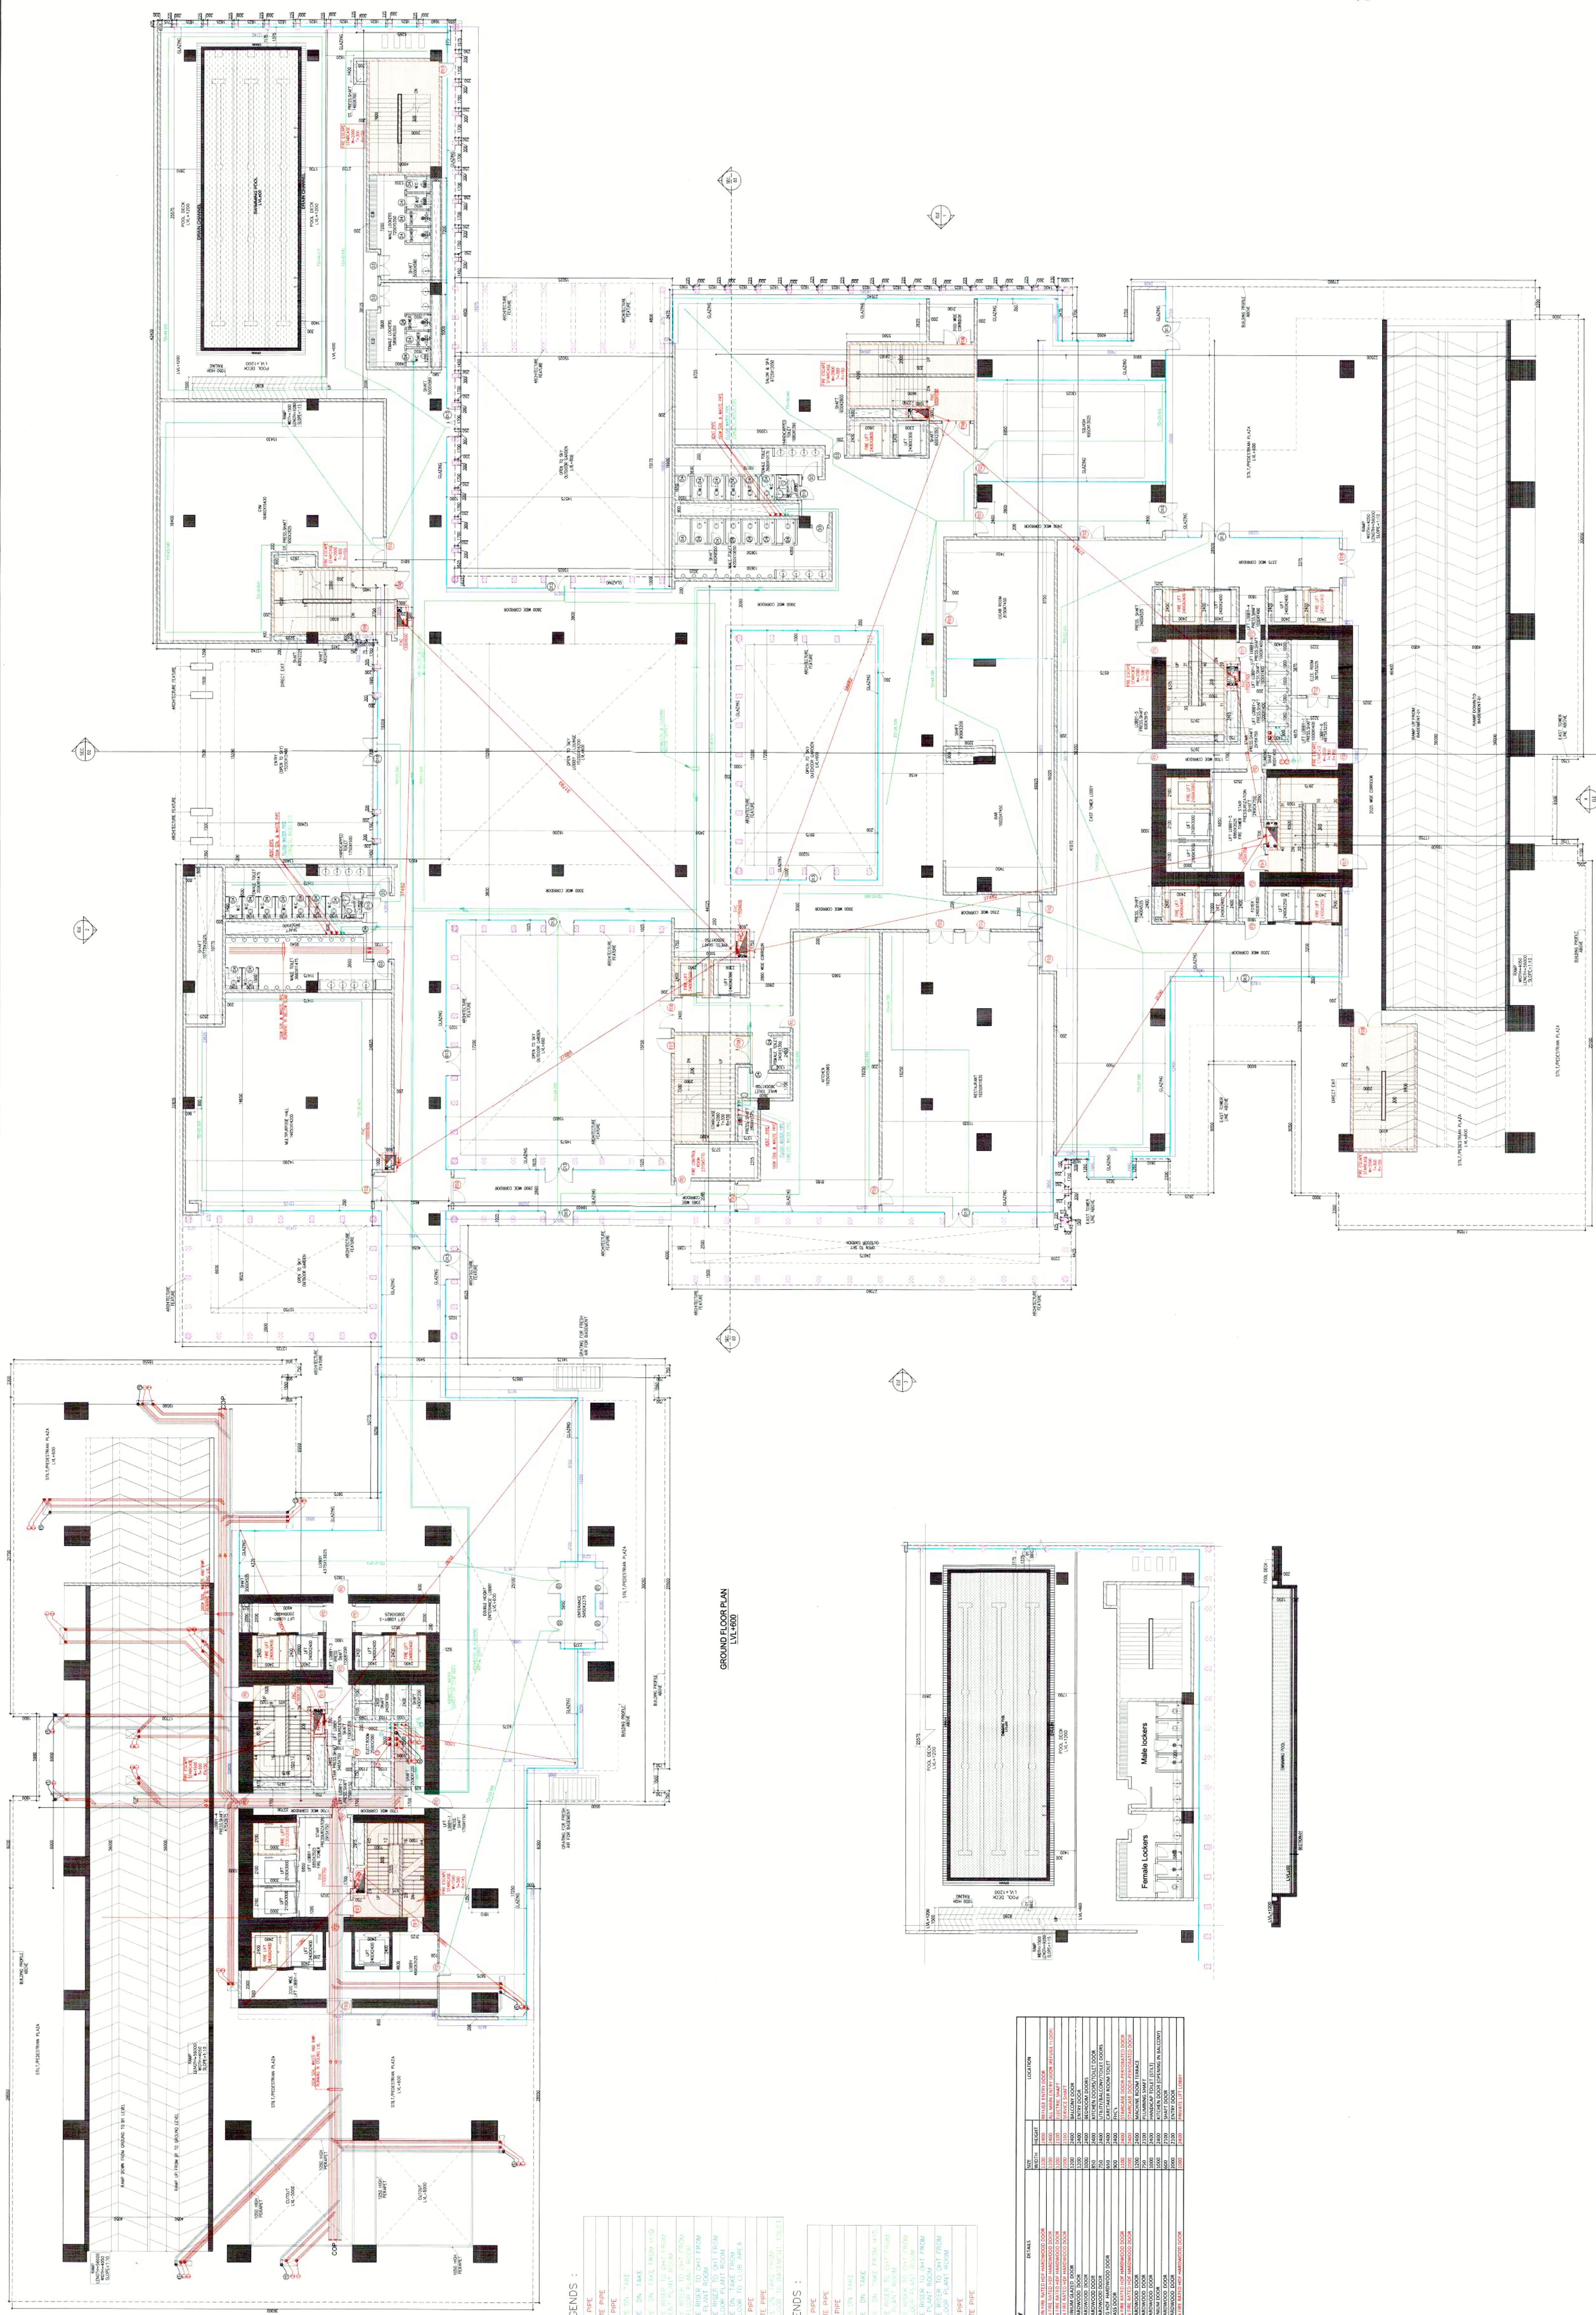

GROUND FLOOR PLAN
LVL:000

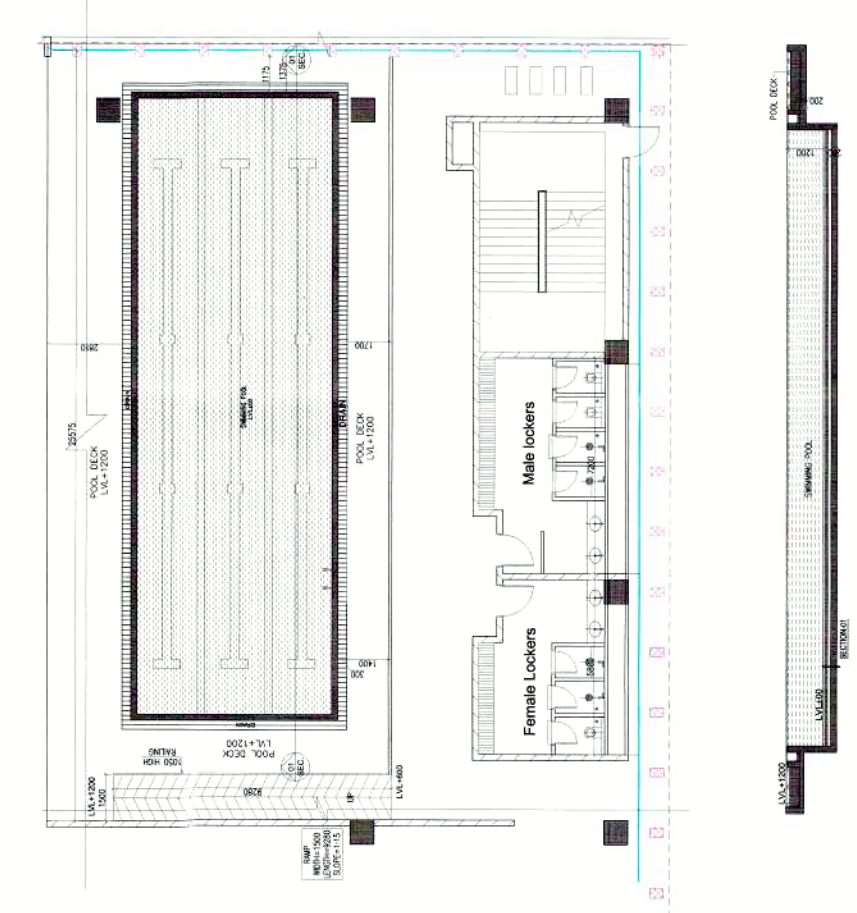

- 3 TO A - LEGENDS :
- 01 1000 SOIL PIPE
 - 02 2000 WASTE PIPE
 - 03 7500 WASTE PIPE
 - 04 1000 WASTE PIPE
 - 05 1500 WASTE PIPE
 - 06 2000 WASTE PIPE
 - 07 2500 WASTE PIPE
 - 08 3000 WASTE PIPE
 - 09 3500 WASTE PIPE
 - 10 4000 WASTE PIPE
 - 11 4500 WASTE PIPE
 - 12 5000 WASTE PIPE

- 4 TO A - LEGENDS :
- 01 1000 SOIL PIPE
 - 02 2000 WASTE PIPE
 - 03 7500 WASTE PIPE
 - 04 1000 WASTE PIPE
 - 05 1500 WASTE PIPE
 - 06 2000 WASTE PIPE
 - 07 2500 WASTE PIPE
 - 08 3000 WASTE PIPE
 - 09 3500 WASTE PIPE
 - 10 4000 WASTE PIPE
 - 11 4500 WASTE PIPE
 - 12 5000 WASTE PIPE

SCHEDULE OF QUANTITY

ITEM NO	ITEM	QUANTITY	UNIT	REMARKS
1	1000 SOIL PIPE	1000	M	1000 SOIL PIPE
2	2000 WASTE PIPE	2000	M	2000 WASTE PIPE
3	7500 WASTE PIPE	7500	M	7500 WASTE PIPE
4	1000 WASTE PIPE	1000	M	1000 WASTE PIPE
5	1500 WASTE PIPE	1500	M	1500 WASTE PIPE
6	2000 WASTE PIPE	2000	M	2000 WASTE PIPE
7	2500 WASTE PIPE	2500	M	2500 WASTE PIPE
8	3000 WASTE PIPE	3000	M	3000 WASTE PIPE
9	3500 WASTE PIPE	3500	M	3500 WASTE PIPE
10	4000 WASTE PIPE	4000	M	4000 WASTE PIPE
11	4500 WASTE PIPE	4500	M	4500 WASTE PIPE
12	5000 WASTE PIPE	5000	M	5000 WASTE PIPE