


(RAM AVTAR BASSI) A.D.
 (BALWANT SINGH) S.D.

Checked and found ok for Public Health
 (Internal) Service only subject to
 in force of
 3/8/18
 28/5/18
 S.P. (S)
 Member Secretary
 B.P.C.
 S.P. (S)
 Member
 B.P.C.
 C.P. (H)
 Chairman
 B.P.C.

B.D.F.O. (HQ)
 DFS PKL
 Member B.P.C.

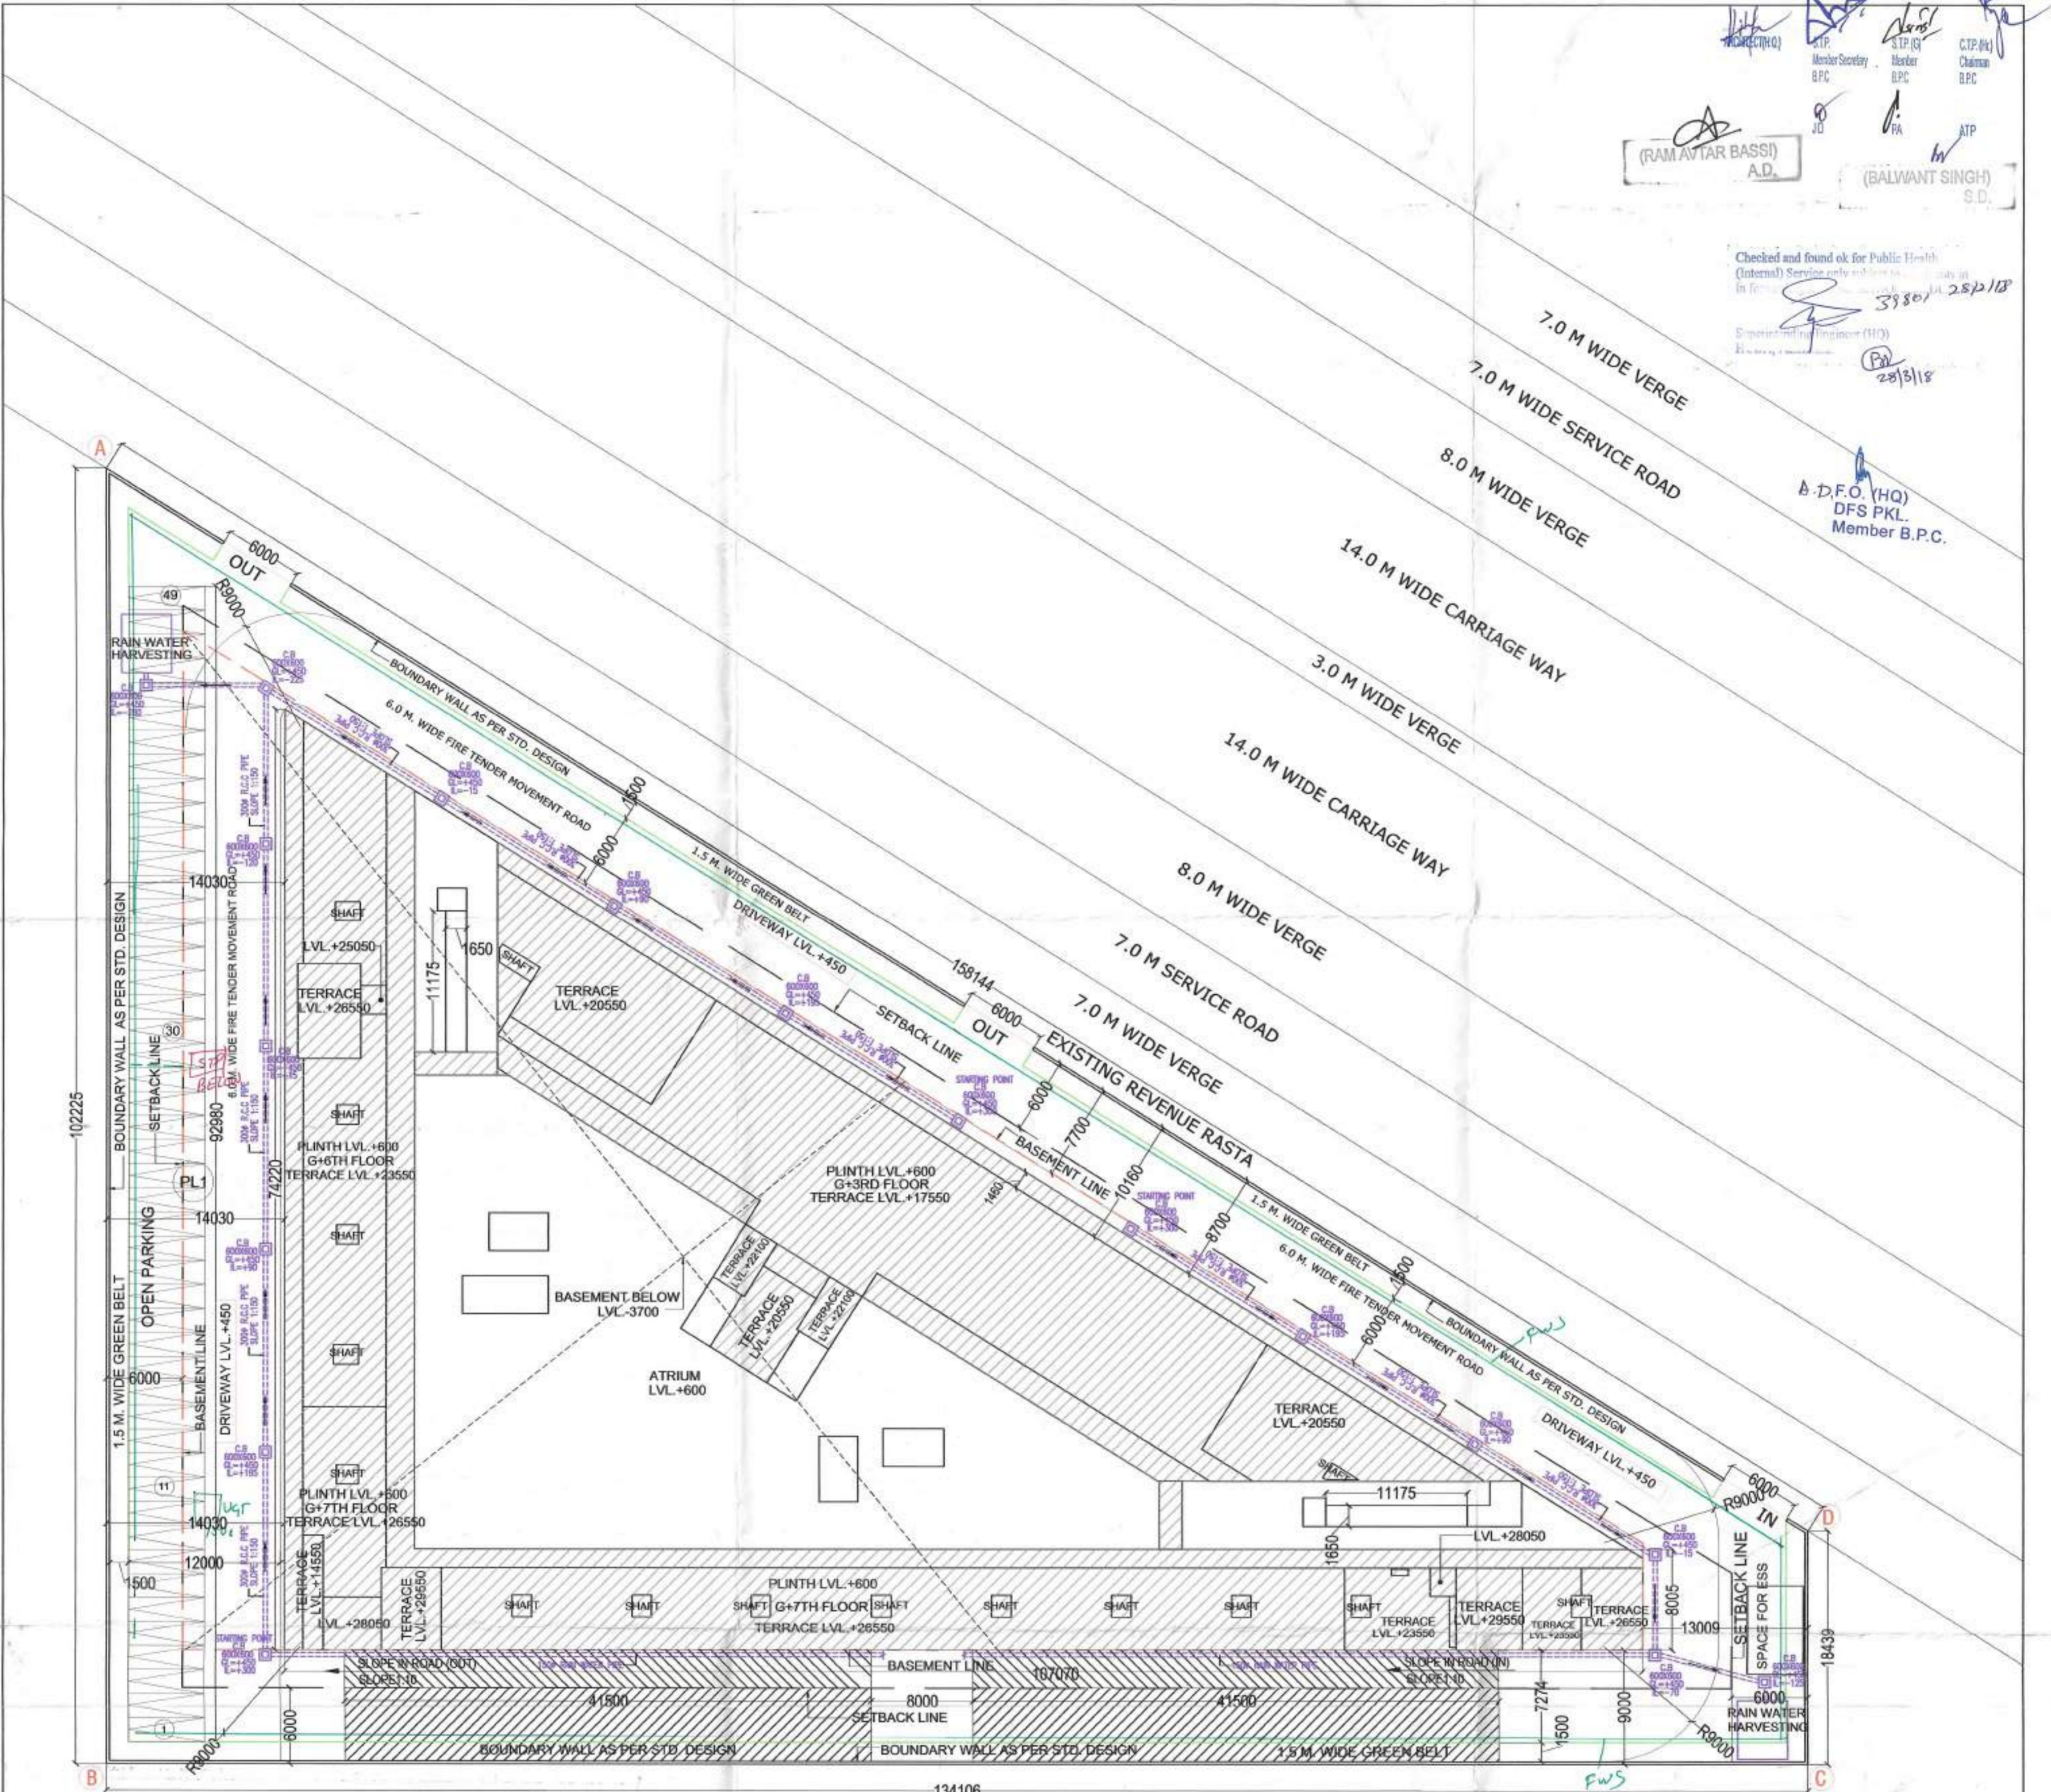

AREA STATEMENT
 TOTAL PLOT AREA = (2.0 ACRES) = 8093.700 SQMT.
 PERM. GROUND COVERAGE @ 60% = 4856.220 SQMT.
 PERM. F.A.R @ 150% = 12140.550 SQMT.

S. NO.	FLOOR LVL.	FAR AREA	NON FAR AREA	TOTAL PROJECT /BUILTUP AREA
1	GROUND FLOOR	2975.503	1182.36	4157.863
2	FIRST FLOOR	2384.832	128.867	2513.699
3	SECOND FLOOR	1123.644	1116.285	2239.929
4	THIRD FLOOR	1946.564	128.867	2075.431
5	FOURTH FLOOR	936.507	96.235	1032.742
6	FIFTH FLOOR	1268.297	96.235	1364.532
7	SIXTH FLOOR	936.507	96.235	1032.742
8	SEVENTH FLOOR	567.161	63.362	630.523
9	BASEMENT FLOOR		5116.368	5116.368
10	MUMTY & MACHINE ROOM		209.482	202.898
11	TOTAL FAR AREA	12139.015		
12	TOTAL NON FAR AREA		8234.296	20366.727

PROP. COVD. AREA UNDER GROUND COVERAGE = 4157.863 SQMT.
 GROUND COVERAGE ACHIVED = 51.37 %
 PROP. COVD. AREA UNDER FAR = 12139.015 SQMT.
 F.A.R ACHIVED 149.98 %
 NON FAR AREA = 8234.296 SQMT.
 TOTAL BUILTUP AREA = 20366.727 SQMT.


PARKING REQ. @ 1 CAR PARKING ON EVERY 50 SQMT. OF FAR AREA = 12140.550/50 = 242.81 SAY 243 NOS.
 SURFACE PARKING REQ. @ 15% OF TOTAL PARKING = 36.45 SAY = 36 NOS
 PARKING PROVIDED IN BASEMENT = 5116.368 - 1079.864(SERVICES AREA) = 4036.503/33= 122.31 SAYS 122 NOS
 ACTUAL PARKING PROVIDED = 102 NOS
 MACHINICA PARKING PROVIDED IN BASEMENT = 102 NOS
 OPEN PARKING PROVIDED = 1115.760/23= 48.5 SAYS 49 NOS
 TOTAL CAR PROVIDED = 102+102+49 = 253 NOS

PARKING SPACE ADDITIONS

S. NO.	S.NO	NO.S	LENGTH(L)	WIDTH(W)	HEIGHT(H)	POLYLINE	FORMULA	AREA (SQM.)
1	PL1	1	12.000	92.980		RECTANGLE	LXW	1115.760
TOTAL								1115.760

SANITARY REQUIREMENT CALCULATION
 TOTAL COMMERCIAL AREA = 6349.858
 GROUND FLOOR AREA = 2975.503
 POPULATION @ 3 PERSON PER SQMT. = 962
 FIRST FLOOR AREA = 2384.832
 POPULATION @ 6 PERSON PER SQMT. = 397
 SECOND FLOOR AREA = 1123.644
 POPULATION @ 6 PERSON PER SQMT. = 167
 TOTAL POPULATION = 1576
 MEN @ 60% = 946
 WOMEN @ 40% = 630

GENTS			
W.C	1 Per 200 up to 400 Over	W.B.	1 Per 200 up to 400 Over
REQUIREMENT AS PER NBC	400 add 1 per over 250 or part thereof	REQUIREMENT AS PER NBC	400 add 1 per over 250 or part thereof
5 Nos.		5 Nos.	
PROPOSED	9 Nos.	PROPOSED	9 Nos.
LADIES			
W.C	1 Per 100 up to 200 Over	W.B.	1 Per 100 up to 200 Over
REQUIREMENT AS PER NBC	200 Add 1 per over 150 or part thereof	REQUIREMENT AS PER NBC	200 Add 1 per over 150 or part thereof
5 Nos.		5 Nos.	
PROPOSED	12 Nos.	PROPOSED	15 Nos.

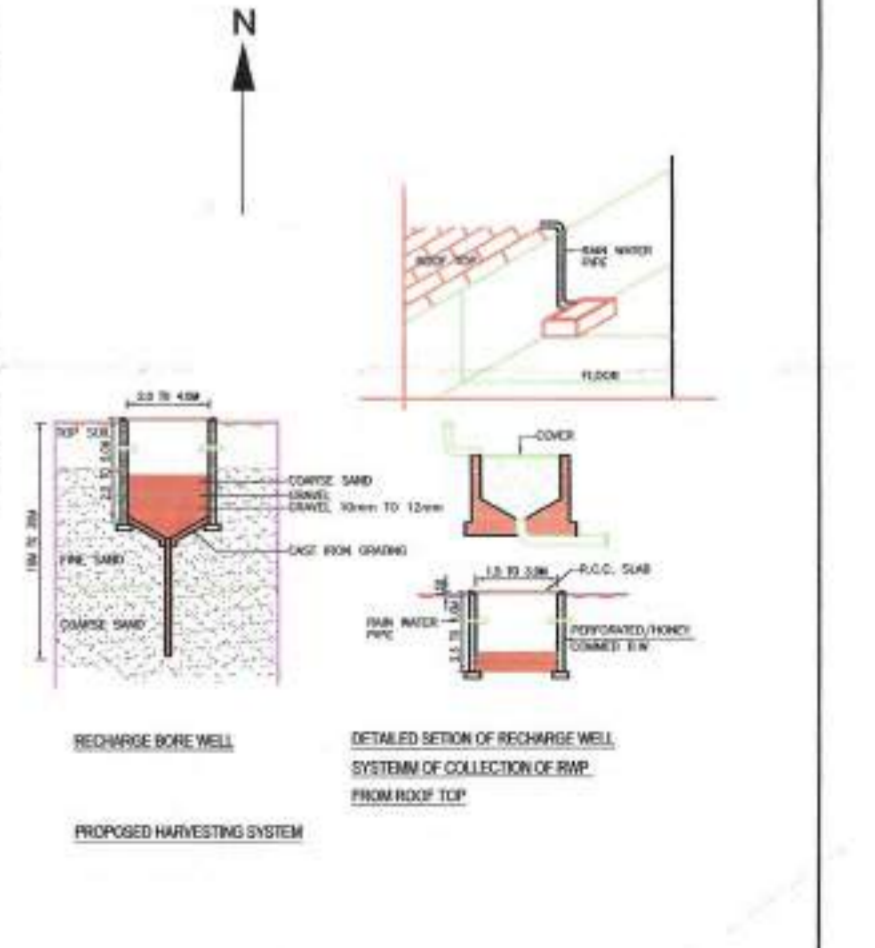

PROJECT->
 REVISED BUILDING PLANS OF COMMERCIAL SITE MEASURING 2.0 ACRE (LICENCE NO. 56 OF 2007 DATED 23.01.2007) IN SECTOR-24, DHARUHERA, BEING DEVELOPED BY M/S DWARKADHISH PROJECTS PVT. LTD.

DWG TITLE
 SITE PLAN

SCALE 1:300





DRG. NO. A-01

Dwarkadish Projects Pvt. Ltd.
 U. Jain
 Authorized Signatory

SIG. OF OWNER

SIG. OF ARCHITECT

AREA STATEMENT 5TH FLOOR UNDER FAR-A TO M-(1 TO 21)							
S.NO	NO.S	LENGTH(L)	WIDTH(W)	HEIGHT(H)	POLYLINE	FORMULA	AREA
ADDITIONS							
A	1	105.609	6.545		RECTANGLE	LXW	691.211
B	1	6.545	63.073		RECTANGLE	LXW	412.813
C	1	6.545	-	4.090	TRIANGLE	1/2 X L X H	13.385
D	1	0.450	7.765		RECTANGLE	LXW	3.494
E	1	4.181	-	6.690	TRIANGLE	1/2 X L X H	13.985
F	1	2.985	6.690		RECTANGLE	LXW	19.970
F1	1	12.884	9.700		RECTANGLE	LXW	124.975
G	1	4.529	9.700		RECTANGLE	LXW	43.931
H	1	15.521	-	9.700	TRIANGLE	1/2 X L X H	75.277
J	1	1.800	10.381		RECTANGLE	LXW	18.686
J1	1	1.800	-	1.060	TRIANGLE	1/2 X L X H	0.954
K	1	14.254	1.800		RECTANGLE	LXW	25.657
K1	1	2.880	-	1.800	TRIANGLE	1/2 X L X H	2.592
L	2	2.960	3.790		RECTANGLE	LXW	22.437
M	2	1.810	0.510		RECTANGLE	LXW	1.846
TOTAL							1469.366
DEDUCTIONS							
1	14	1.533	1.960		RECTANGLE	LXW	42.066
2	1	5.200	6.085		RECTANGLE	LXW	31.642
3	1	1.800	1.800		RECTANGLE	LXW	3.240
4	1	0.600	4.055		RECTANGLE	LXW	2.433
5	1	1.210	0.485		RECTANGLE	LXW	0.587
6	1	6.100	5.200		RECTANGLE	LXW	31.720
7	2	1.950	2.500		RECTANGLE	LXW	9.750
8	1	4.715	0.655		RECTANGLE	LXW	3.088
9	1	1.670	8.346		RECTANGLE	LXW	13.938
10	1	4.500	7.305		RECTANGLE	LXW	32.873
11	1	1.800	1.800		RECTANGLE	LXW	3.240
12	2	1.800	1.186		RECTANGLE	LXW	4.270
13	1	3.532	-	2.207	TRIANGLE	1/2 X L X H	3.898
14	1	2.300	-	1.437	TRIANGLE	1/2 X L X H	1.653
15	1	0.600	-	0.960	TRIANGLE	1/2 X L X H	0.288
16	1	0.600	0.390		RECTANGLE	LXW	0.234
17	1	2.900	1.350		RECTANGLE	LXW	3.915
18	1	2.653	-	1.658	TRIANGLE	1/2 X L X H	2.199
19	1	2.404	-	1.500	TRIANGLE	1/2 X L X H	1.803
20	2	1.300	2.500		RECTANGLE	LXW	6.500
21	2	1.770	0.490		RECTANGLE	LXW	1.735
TOTAL							201.07
TOTAL COVD. AREA ON 5TH FLOOR =							1268.297
NON FAR AREA STATEMENT ON 5TH FLOOR(STAIR CASE) = 2+6+10							
ADDITIONS							
2	1	5.200	6.085		RECTANGLE	LXW	31.642
6	1	6.100	5.200		RECTANGLE	LXW	31.720
10	1	4.500	7.305		RECTANGLE	LXW	32.873
TOTAL							96.235

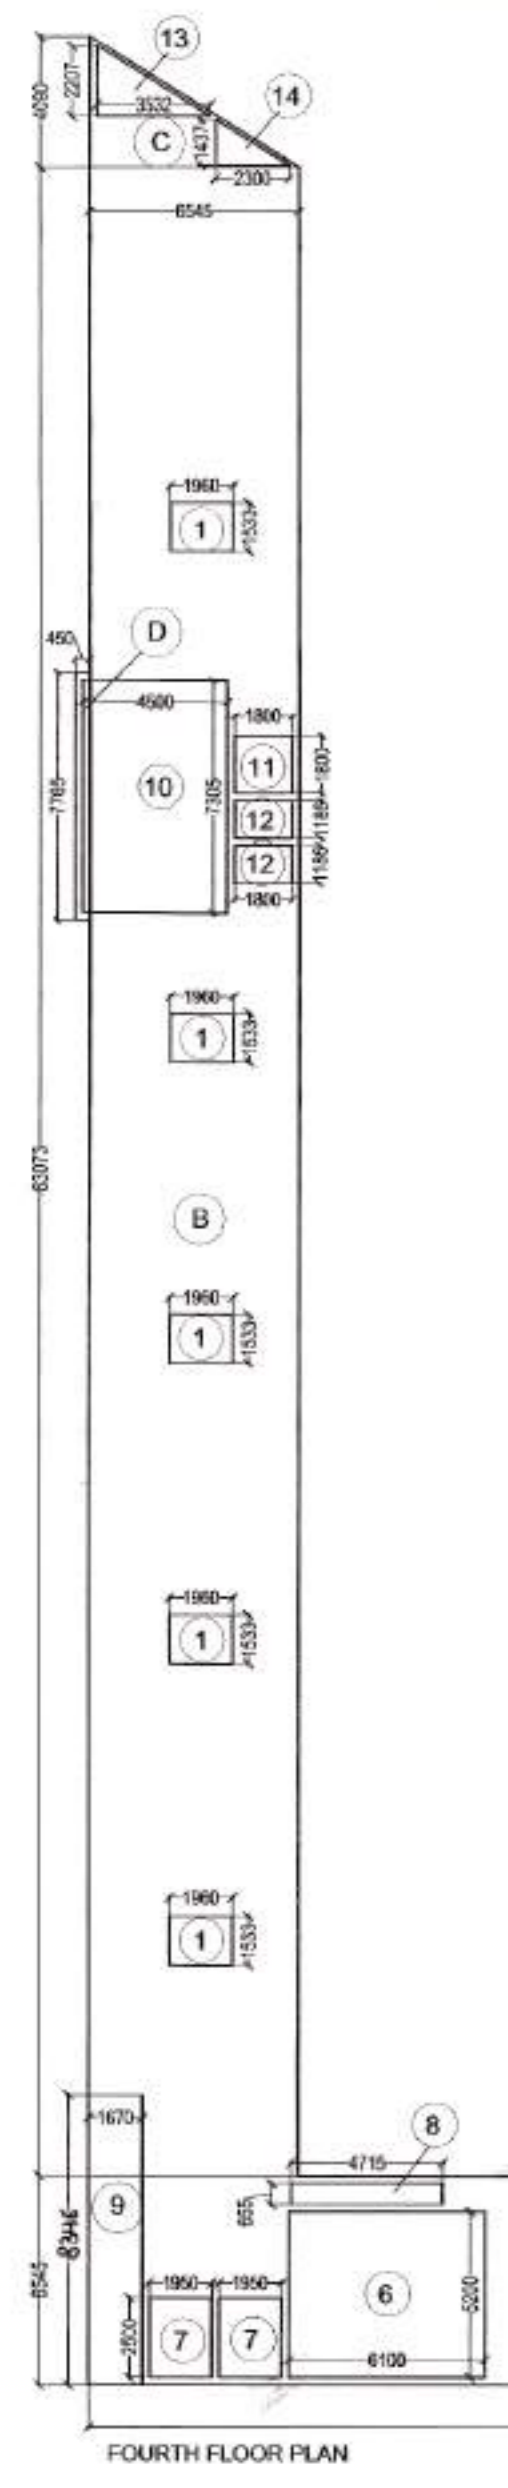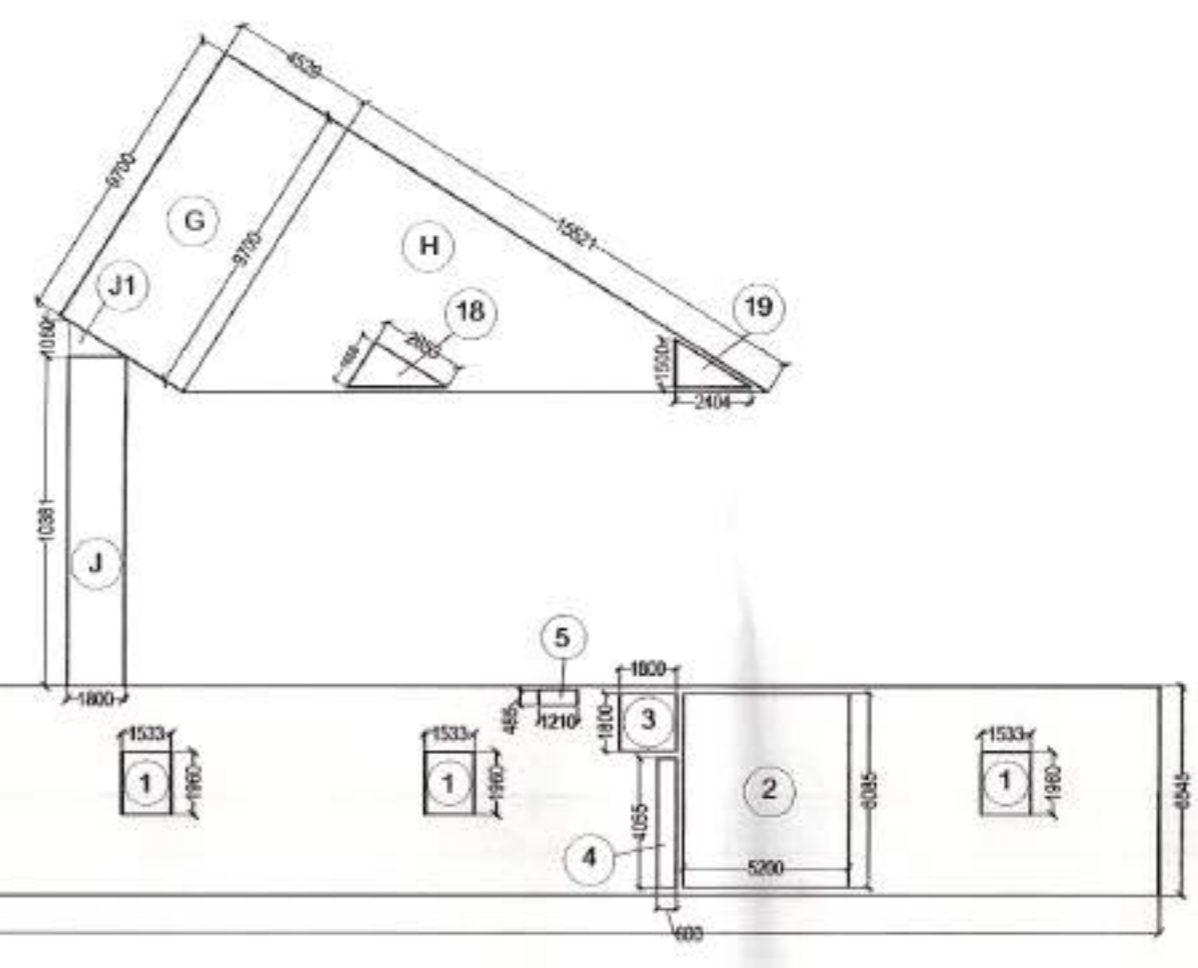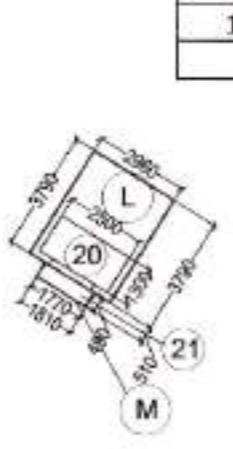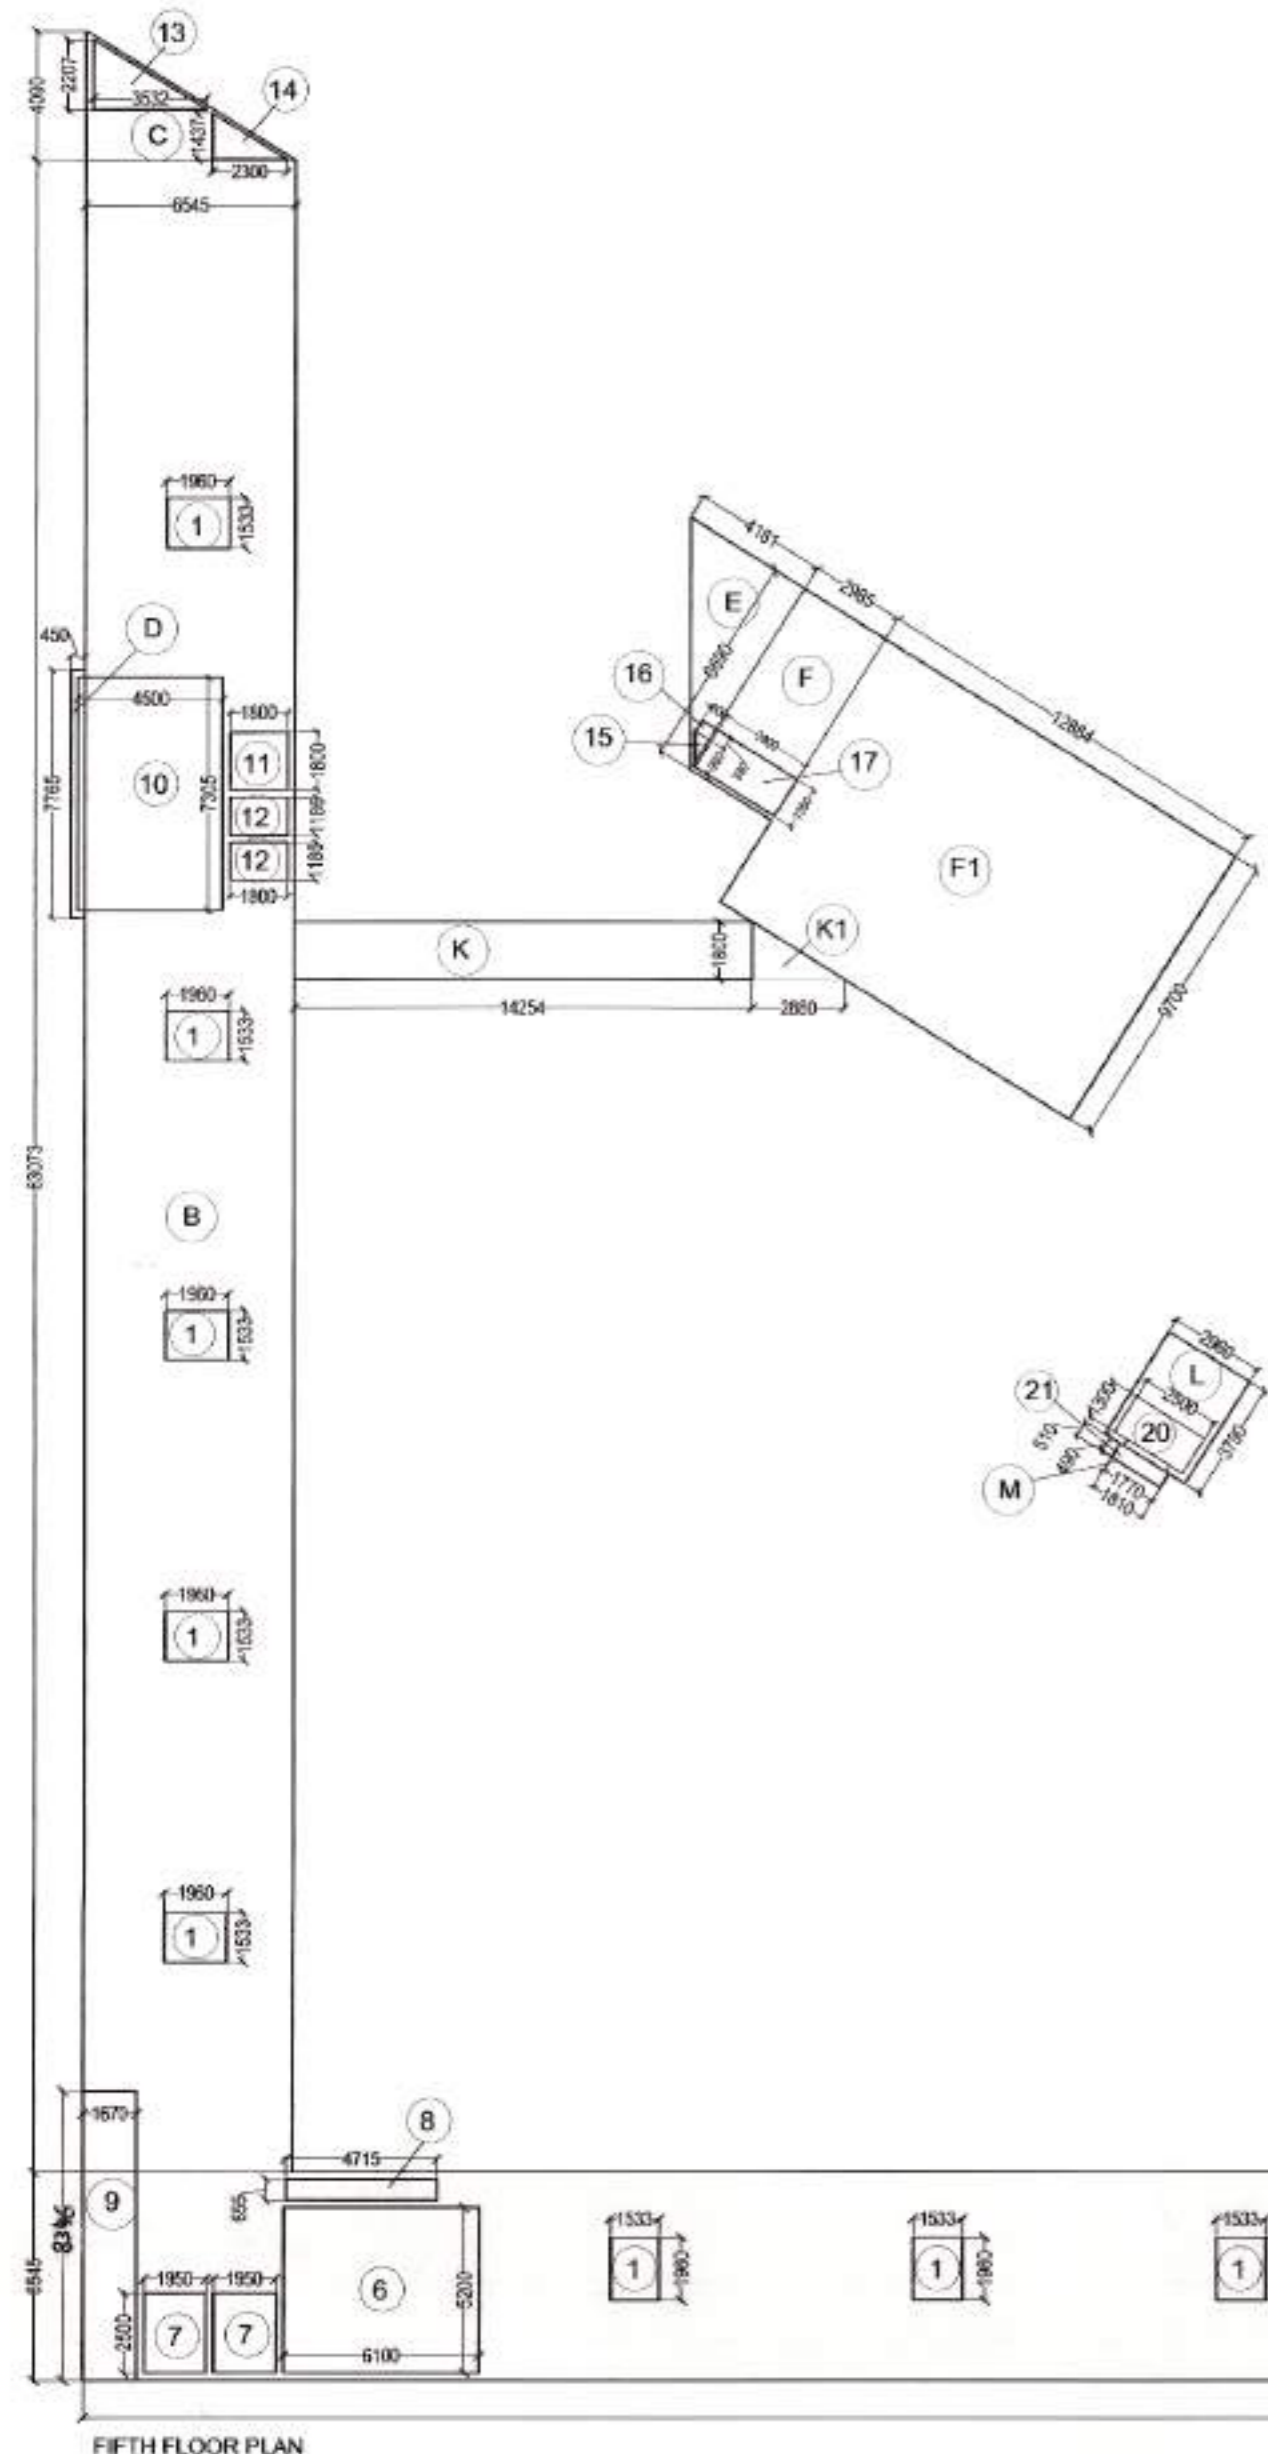

AREA STATEMENT 4TH FLOOR UNDER FAR-A TO D-(1 TO 14)							
S.NO	NO.S	LENGTH(L)	WIDTH(W)	HEIGHT(H)	POLYLINE	FORMULA	AREA
ADDITIONS							
A	1	105.609	6.545		RECTANGLE	LXW	691.211
B	1	6.545	63.073		RECTANGLE	LXW	412.813
C	1	6.545	-	4.090	TRIANGLE	1/2 X L X H	13.385
D	1	0.450	7.765		RECTANGLE	LXW	3.494
TOTAL							1120.902
DEDUCTIONS							
1	14	1.533	1.960		RECTANGLE	LXW	42.066
2	1	5.200	6.085		RECTANGLE	LXW	31.642
3	1	1.800	1.800		RECTANGLE	LXW	3.240
4	1	0.600	4.055		RECTANGLE	LXW	2.433
5	1	1.210	0.485		RECTANGLE	LXW	0.587
6	1	6.100	5.200		RECTANGLE	LXW	31.720
7	2	1.950	2.500		RECTANGLE	LXW	9.750
8	1	4.715	0.655		RECTANGLE	LXW	3.088
9	1	1.670	8.346		RECTANGLE	LXW	13.938
10	1	4.500	7.305		RECTANGLE	LXW	32.873
11	1	1.800	1.800		RECTANGLE	LXW	3.240
12	2	1.800	1.186		RECTANGLE	LXW	4.270
13	1	3.532	-	2.207	TRIANGLE	1/2 X L X H	3.898
14	1	2.300	-	1.437	TRIANGLE	1/2 X L X H	1.653
TOTAL							184.396
TOTAL COVD. AREA ON 4TH FLOOR =							936.507
NON FAR AREA STATEMENT ON 4TH FLOOR(STAIR CASE) = 2+6+10							
ADDITIONS							
2	1	5.200	6.085		RECTANGLE	LXW	31.642
6	1	6.100	5.200		RECTANGLE	LXW	31.720
10	1	4.500	7.305		RECTANGLE	LXW	32.873
TOTAL							96.235

PROJECT:-
REVISED BUILDING PLANS OF COMMERCIAL SITE
MEASURING 2.0 ACRE
(LICENCE NO. 56 OF 2007 DATED 23.01.2007) IN
SECTOR-24, DHARUHERA, BEING DEVELOPED BY
M/S DWARKADHISH PROJECTS PVT. LTD.

DWG TITLE
AREA STATEMENT

DRG. NO. A-05

Dwarkadhish Projects Pvt. Ltd.
U. Jain
Authorised Signatory

SIG. OF OWNER


SATYA PRAKASH
SINGH
ARCHITECT
CAD/20/2017
S.D.

SIG. OF ARCHITECT

AREA STATEMENT 3RD FLOOR UNDER FAR=A TO O-(1 TO 26)							
S.NO	NO.S	LENGTH(L)	WIDTH(W)	HEIGHT(H)	POLYLINE	FORMULA	AREA
ADDITIONS							
A	1	105.609	6.545		RECTANGLE	LXW	691.211
B	1	6.545	63.073		RECTANGLE	LXW	412.813
C	1	6.545	-	4.090	TRIANGLE	1/2 X L X H	13.385
D	1	10.859	1.800		RECTANGLE	LXW	19.546
E	1	2.880	-	1.800	TRIANGLE	1/2 X L X H	2.592
F	1	11.500	-	7.187	TRIANGLE	1/2 X L X H	41.325
G	1	66.239	11.500		RECTANGLE	LXW	761.749
H	1	18.402	-	11.500	TRIANGLE	1/2 X L X H	105.812
J	1	1.800	-	1.124	TRIANGLE	1/2 X L X H	1.012
K	1	1.800	8.195		RECTANGLE	LXW	14.751
L	1	7.185	10.820		RECTANGLE	LXW	77.742
M	1	5.360	5.930		RECTANGLE	LXW	31.785
N	2	1.810	0.510		RECTANGLE	LXW	1.846
O	1	0.450	7.765		RECTANGLE	LXW	3.494
TOTAL							2179.061

S.NO	NO.S	LENGTH(L)	WIDTH(W)	HEIGHT(H)	POLYLINE	FORMULA	AREA
DEDUCTIONS							
1	2	2.500	1.300		RECTANGLE	LXW	6.500
2	1	3.470	0.600		RECTANGLE	LXW	2.082
3	1	4.900	6.400		RECTANGLE	LXW	31.360
4	1	1.200	1.060		RECTANGLE	LXW	1.272
5	2	1.770	0.490		RECTANGLE	LXW	1.735
6	1	0.960	-	0.600	TRIANGLE	1/2 X L X H	0.288
7	1	0.600	0.390		RECTANGLE	LXW	0.234
8	1	2.900	1.350		RECTANGLE	LXW	3.915
9	1	2.410	-	1.690	TRIANGLE	1/2 X L X H	2.036
10	1	2.181	-	1.363	TRIANGLE	1/2 X L X H	1.486
11	1	2.985	-	4.776	TRIANGLE	1/2 X L X H	7.128
12	1	2.653	-	1.658	TRIANGLE	1/2 X L X H	2.199
13	1	2.404	-	1.500	TRIANGLE	1/2 X L X H	1.803
14	14	1.533	1.960		RECTANGLE	LXW	42.066
15	1	5.200	6.085		RECTANGLE	LXW	31.642
16	1	1.800	1.800		RECTANGLE	LXW	3.240
17	1	0.600	4.055		RECTANGLE	LXW	2.433
18	1	1.210	0.485		RECTANGLE	LXW	0.587
19	1	4.715	0.655		RECTANGLE	LXW	3.088
20	1	6.100	5.200		RECTANGLE	LXW	31.720
21	2	1.950	2.500		RECTANGLE	LXW	9.750
22	1	4.500	7.305		RECTANGLE	LXW	32.873
23	1	1.800	1.800		RECTANGLE	LXW	3.240
24	2	1.800	1.186		RECTANGLE	LXW	4.270
25	1	3.532	-	2.207	TRIANGLE	1/2 X L X H	3.898
26	1	2.300	-	1.437	TRIANGLE	1/2 X L X H	1.653
TOTAL							232.497
TOTAL COVD. AREA ON 3RD FLOOR =							1946.564


NON FAR AREA STATEMENT ON 3RD FLOOR (STAIR CASE) = 3+4+20+22							
S.NO	NO.S	LENGTH(L)	WIDTH(W)	HEIGHT(H)	POLYLINE	FORMULA	AREA
ADDITIONS							
3	1	4.900	6.400		RECTANGLE	LXW	31.360
4	1	1.200	1.060		RECTANGLE	LXW	1.272
15	1	5.200	6.085		RECTANGLE	LXW	31.642
20	1	6.100	5.200		RECTANGLE	LXW	31.720
22	1	4.500	7.305		RECTANGLE	LXW	32.873
TOTAL							128.867

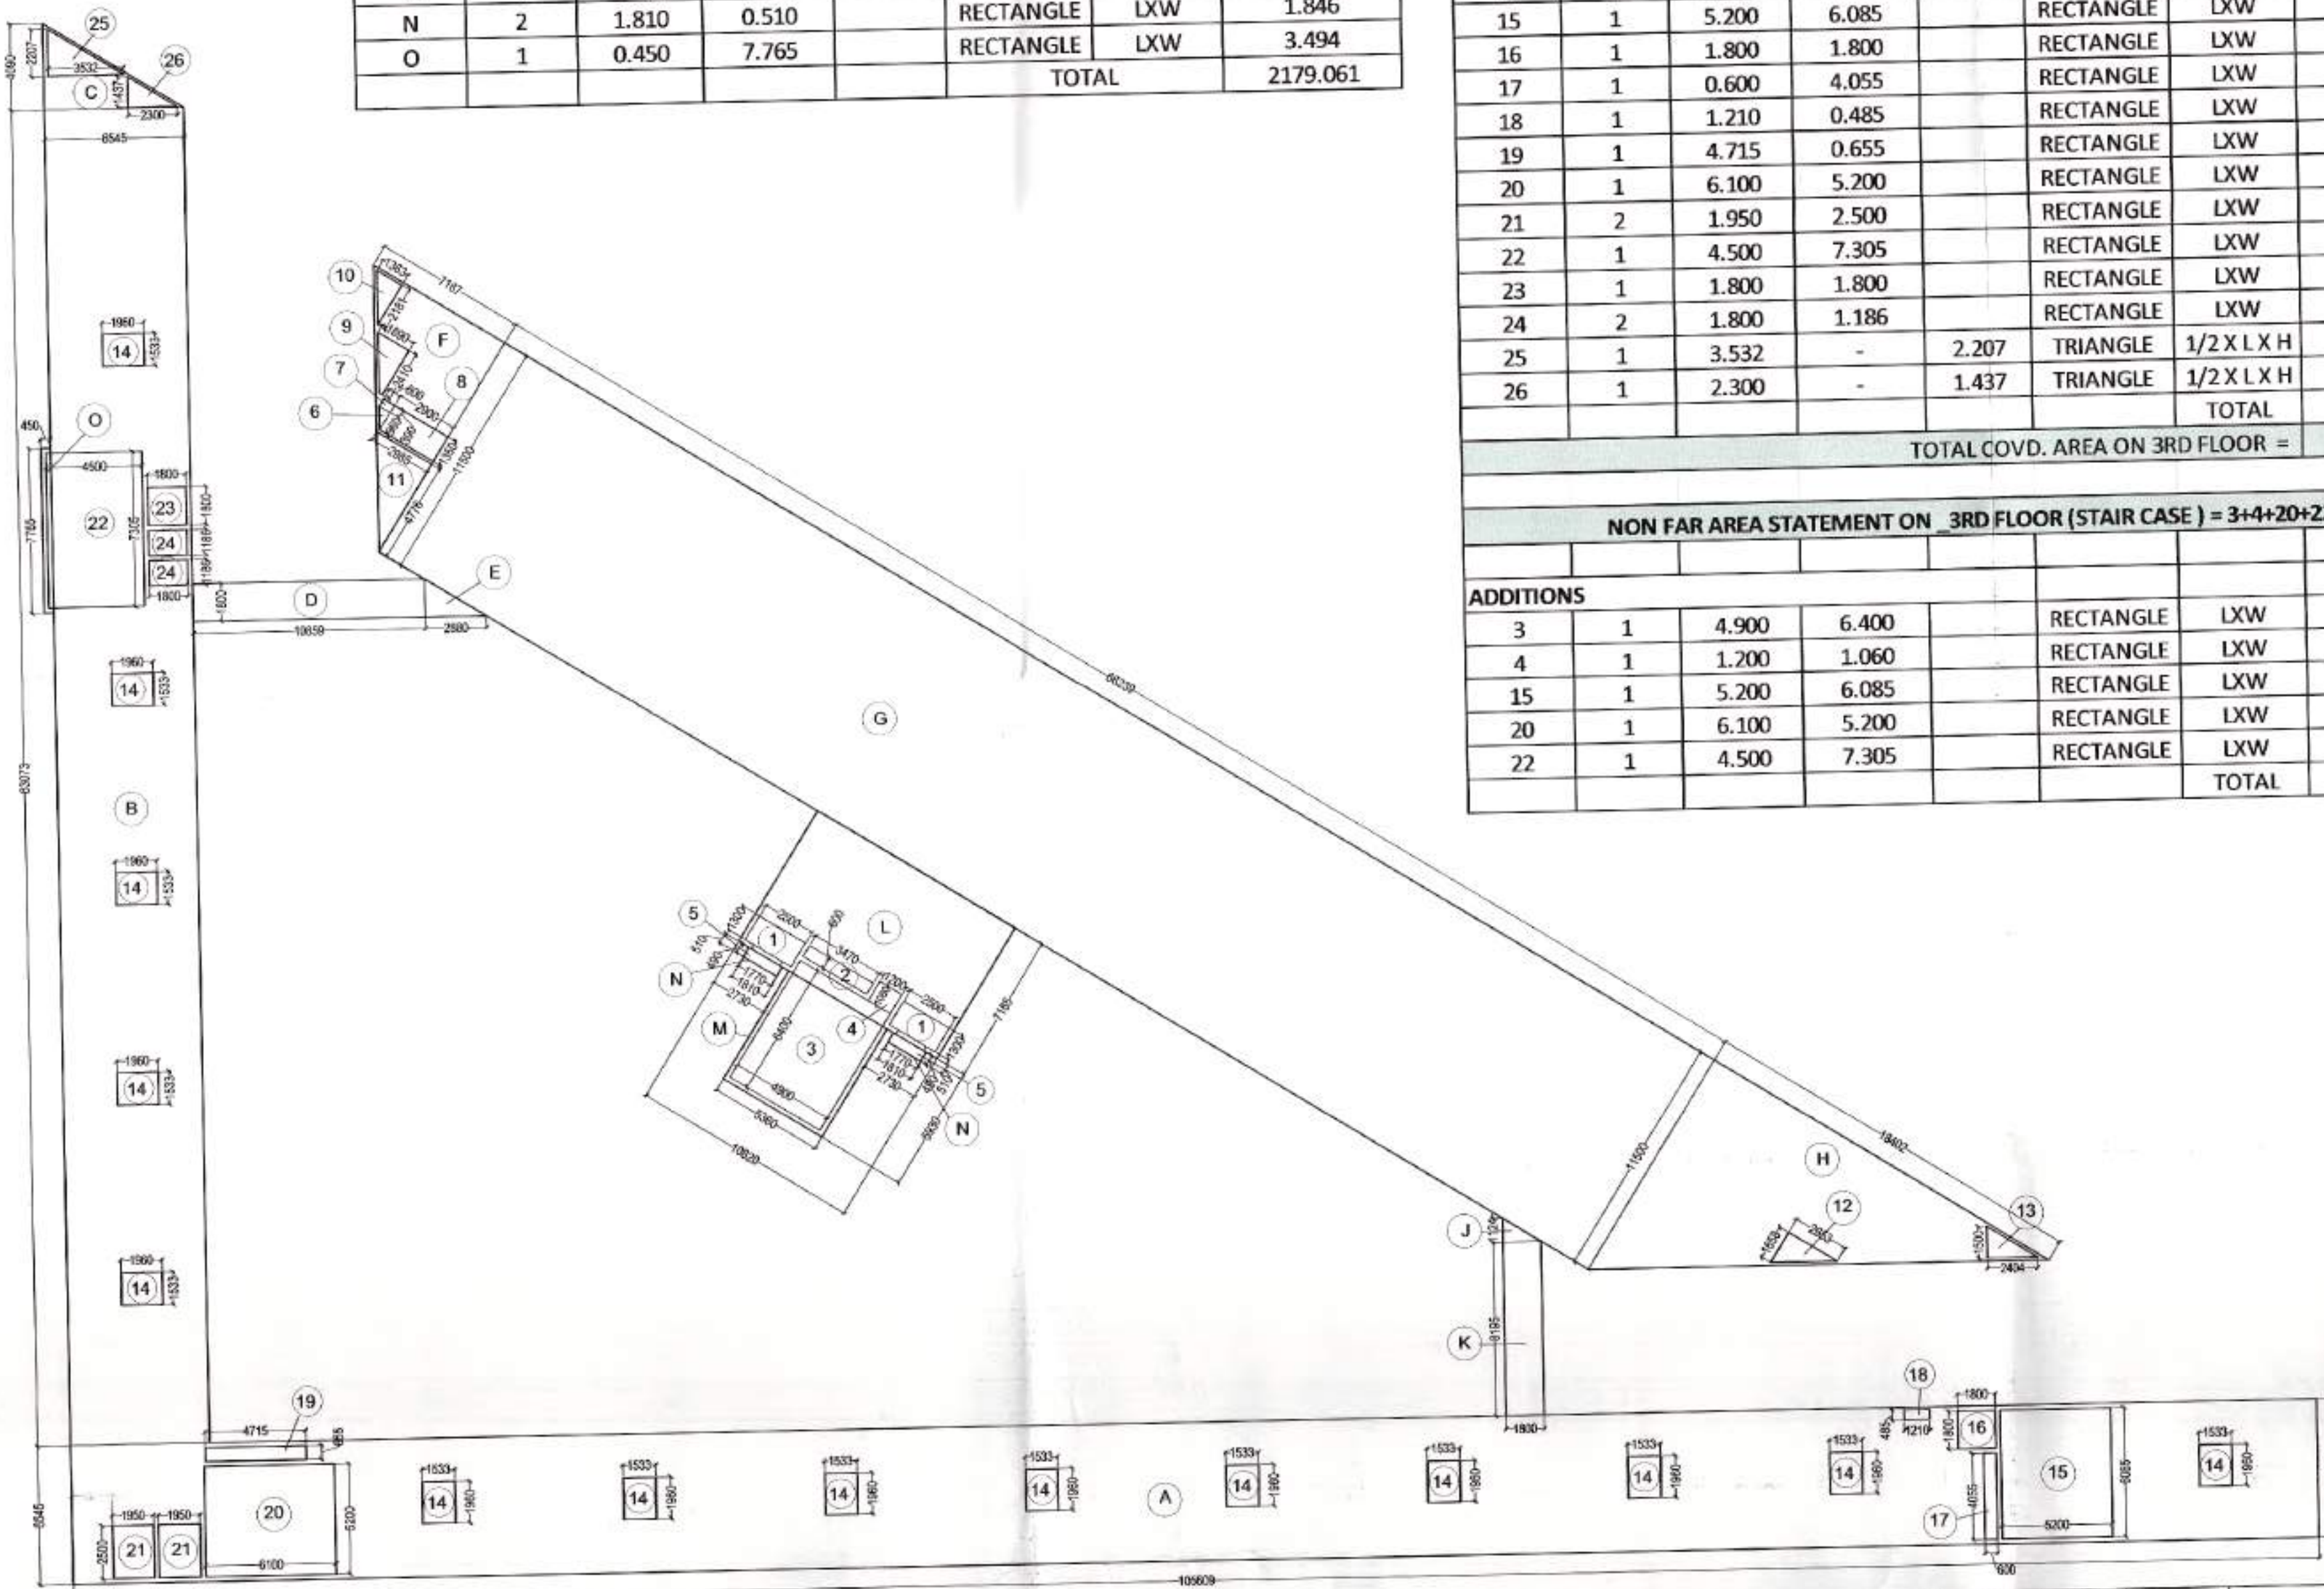

AREA STATEMENT SECOND FLOOR UNDER FAR=A TO M-(1 TO 15)							
S.NO	NO.S	LENGTH(L)	WIDTH(W)	HEIGHT(H)	POLYLINE	FORMULA	AREA
ADDITIONS							
A	1	7.643	-	12.230	TRIANGLE	1/2 X L X H	46.737
B	1	64.612	12.230		RECTANGLE	LXW	790.205
C	1	19.572	-	12.230	TRIANGLE	1/2 X L X H	119.683
D	1	6.455	10.820		RECTANGLE	LXW	69.843
E	2	1.810	0.510		RECTANGLE	LXW	1.846
F	1	5.360	5.930		RECTANGLE	LXW	31.785
G	1	8.716	1.800		RECTANGLE	LXW	15.689
H	1	2.880	-	1.800	TRIANGLE	1/2 X L X H	2.592
J	1	1.800	-	1.125	TRIANGLE	1/2 X L X H	1.013
K	1	1.800	7.330		RECTANGLE	LXW	13.194
L	1	17.570	6.545		RECTANGLE	LXW	114.996
M	1	1.800	3.710		RECTANGLE	LXW	6.678
TOTAL							1214.260

S.NO	NO.S	LENGTH(L)	WIDTH(W)	HEIGHT(H)	POLYLINE	FORMULA	AREA
DEDUCTIONS							
1	2	2.500	1.300		RECTANGLE	LXW	6.500
2	1	3.470	0.600		RECTANGLE	LXW	2.082
3	1	4.900	6.400		RECTANGLE	LXW	31.360
4	1	1.200	1.060		RECTANGLE	LXW	1.272
5	2	1.770	0.490		RECTANGLE	LXW	1.735
6	1	0.960	-	0.600	TRIANGLE	1/2 X L X H	0.288
7	1	0.600	0.390		RECTANGLE	LXW	0.234
8	1	2.900	1.350		RECTANGLE	LXW	3.915
9	1	0.567	1.350		RECTANGLE	LXW	0.765
10	1	1.350	-	2.160	TRIANGLE	1/2 X L X H	1.458
11	1	1.210	0.485		RECTANGLE	LXW	0.587
12	1	1.800	1.800		RECTANGLE	LXW	3.240
13	1	5.200	6.085		RECTANGLE	LXW	31.642
14	1	0.600	4.055		RECTANGLE	LXW	2.433
15	1	0.900	3.450		RECTANGLE	LXW	3.105
TOTAL							90.616
TOTAL COVD. AREA ON SECOND FLOOR UNDER FAR =							1123.644

NON FAR AREA STATEMENT ON 2ND FLOOR (SERVICE FLOOR+STAIR CASE) = 3+4+13+N+O+P+Q+R							
S.NO	NO.S	LENGTH(L)	WIDTH(W)	HEIGHT(H)	POLYLINE	FORMULA	AREA
ADDITIONS							
3	1	1.200	1.060		RECTANGLE	LXW	1.272
4	1	4.900	6.400		RECTANGLE	LXW	31.360
13	1	3.900	6.085		RECTANGLE	LXW	23.732
N	1	9.450	6.545		RECTANGLE	LXW	61.850
O	1	71.279	6.545		RECTANGLE	LXW	466.521
P	1	7.310	69.906		RECTANGLE	LXW	511.013
Q	1	7.310	-	4.663	TRIANGLE	1/2 X L X H	17.043
R	1	0.450	7.765		RECTANGLE	LXW	3.494
TOTAL							1116.285

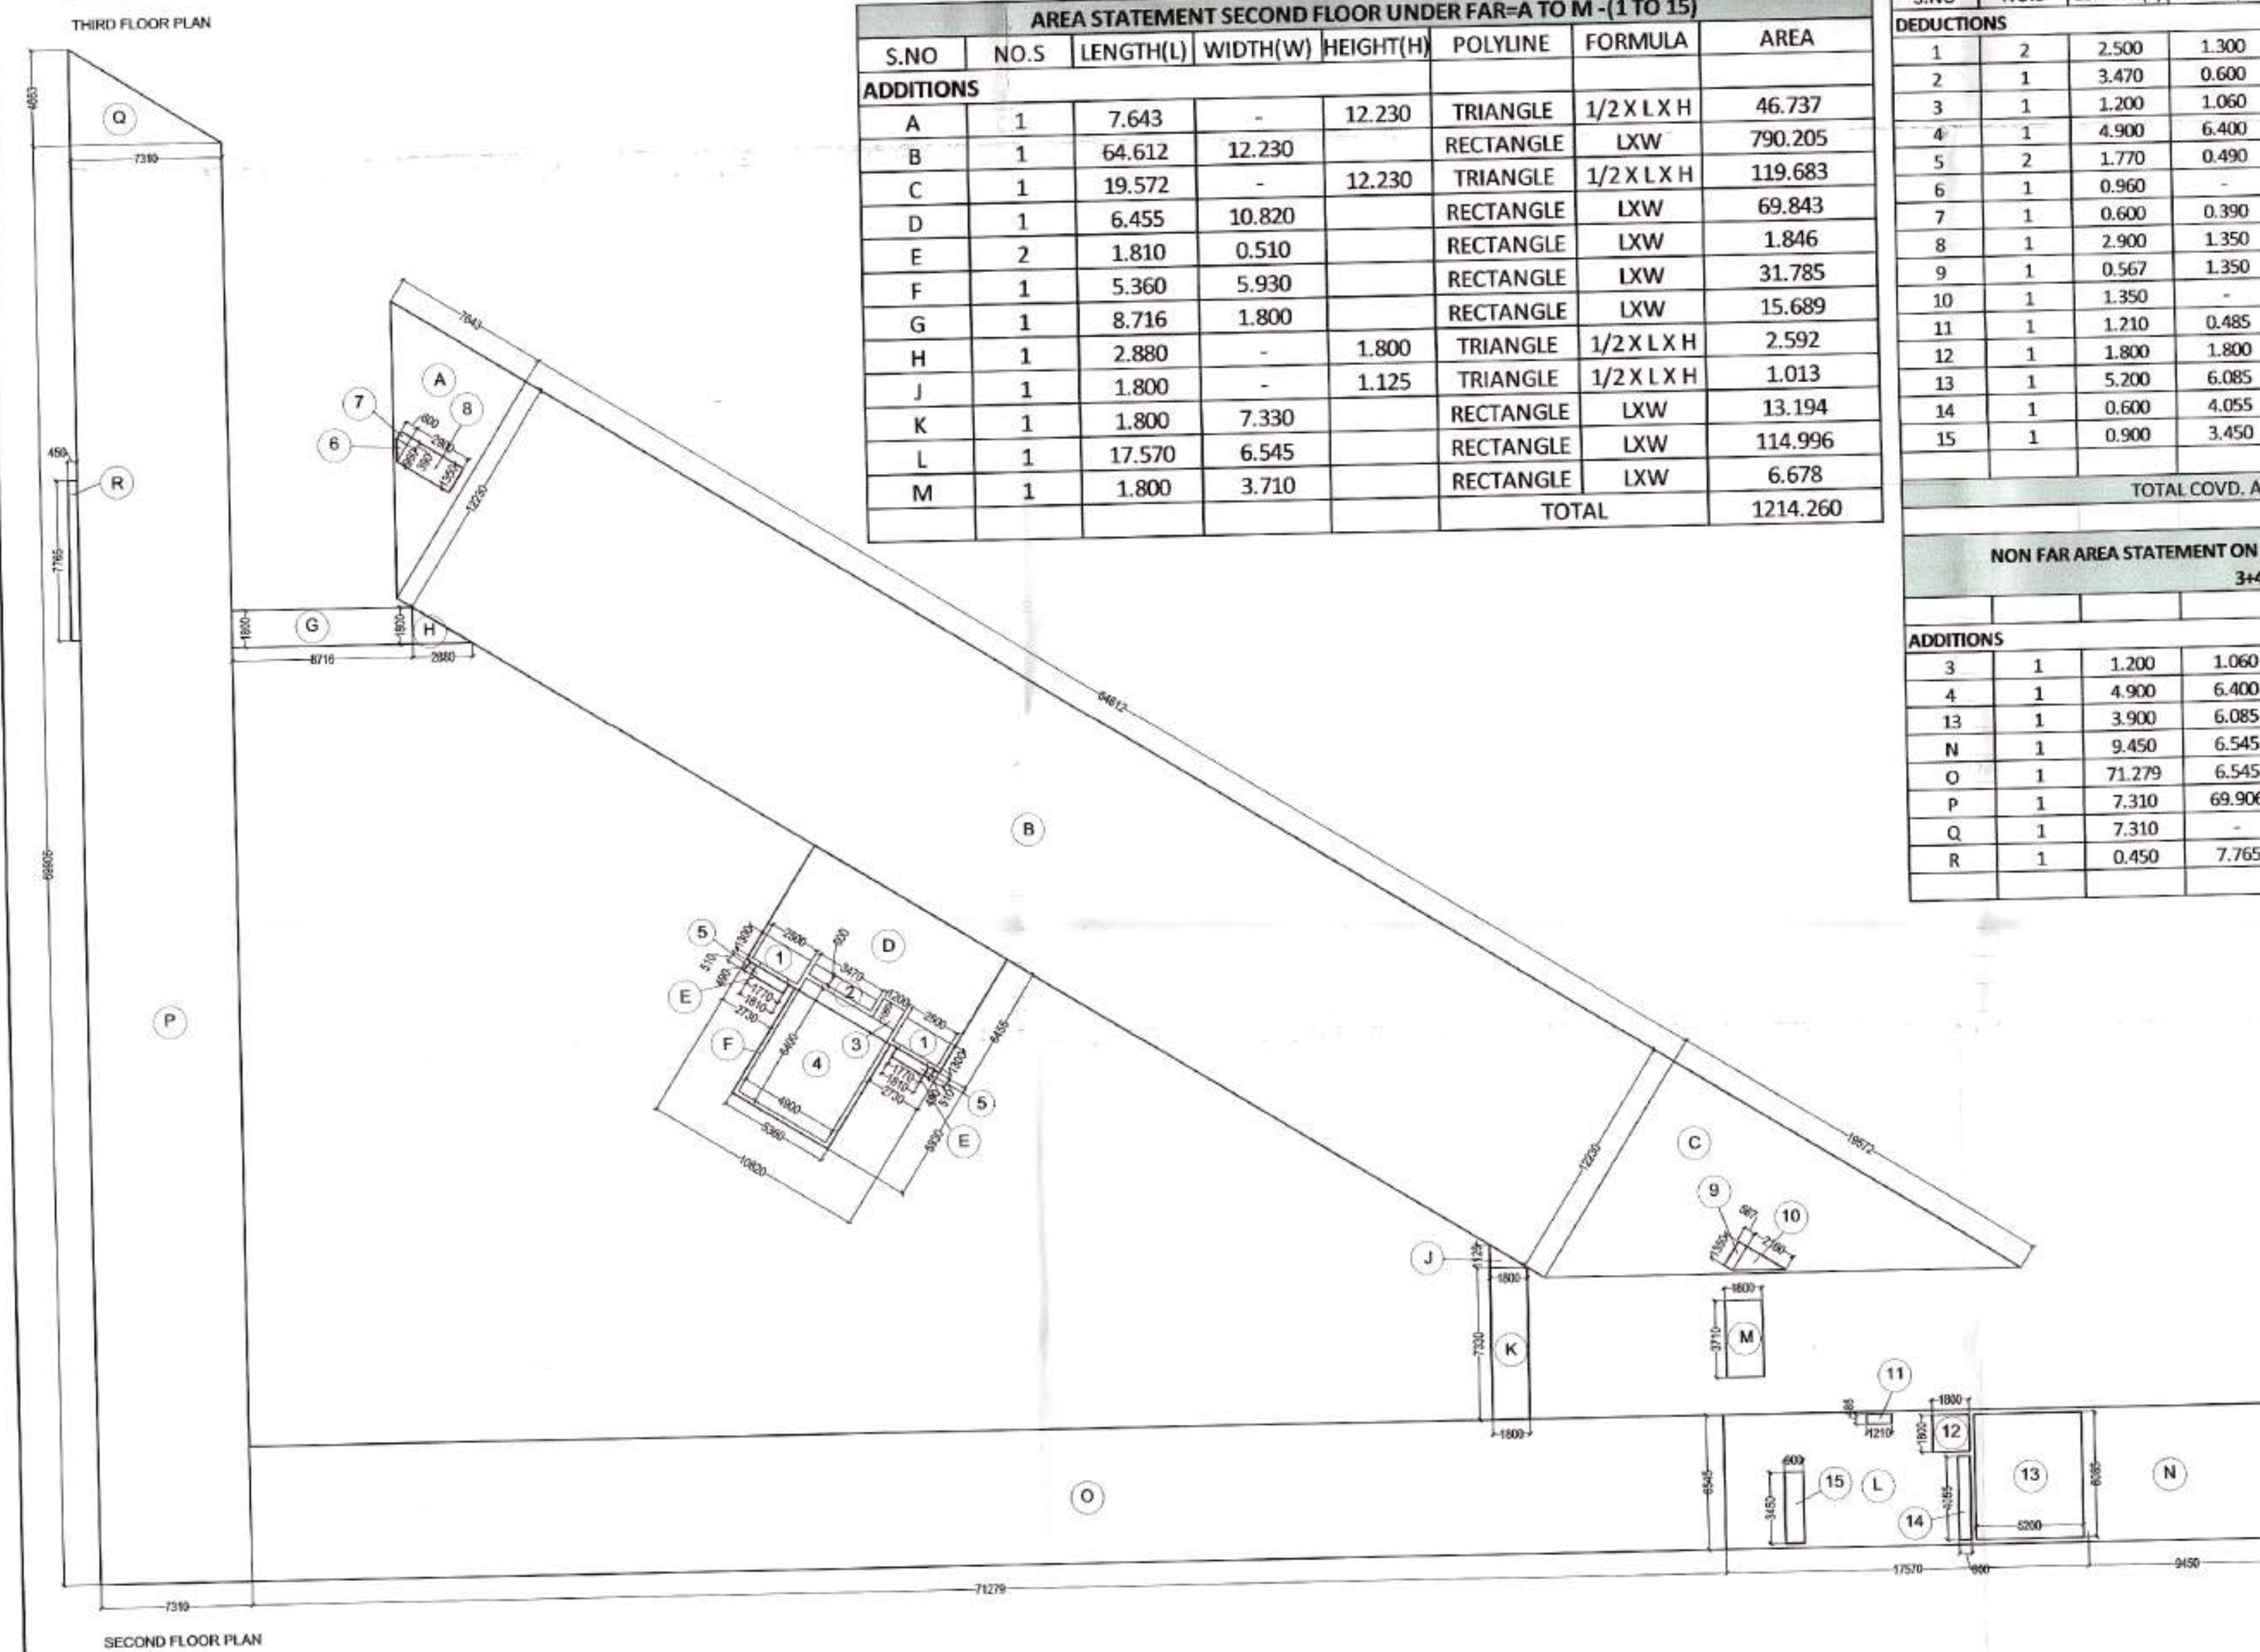

PROJECT: REVISED BUILDING PLANS OF COMMERCIAL SITE MEASURING 2.0 ACRE (LICENCE NO. 56 OF 2007 DATED 23.01.2007) IN SECTOR-24, DHARUHERA, BEING DEVELOPED BY M/S DWARKADHISH PROJECTS PVT. LTD.

DRG. TITLE: AREA STATEMENT

SIG. OF OWNER: *V. Jain*
 AUTHORIZED SIGNATORY


SIG. OF ARCHITECT: *Sanket*
 SATYA PAKASH ARCHITECT CA2006/02018

(RAM AVAR BASSI) A.D.
 A.D. F.O. (HQ) DFS/PKL Member B.P.C.
 (BALWANT SINGH) S.D.

AREA STATEMENT FIRST FLOOR UNDER FAR-A TO U -(1 TO 22)							
S.NO	NO.S	LENGTH(L)	WIDTH(W)	HEIGHT(H)	POLYLINE	FORMULA	AREA
ADDITIONS							
A	1	97.570	7.275		RECTANGLE	LXW	709.822
B	1	8.770	67.420		RECTANGLE	LXW	591.273
C	1	8.770	-	5.481	TRIANGLE	1/2 X L X H	24.034
D	1	7.270	1.800		RECTANGLE	LXW	13.086
E	1	2.220	-	1.388	TRIANGLE	1/2 X L X H	1.541
F	1	13.690	-	8.555	TRIANGLE	1/2 X L X H	58.559
G	1	62.990	13.690		RECTANGLE	LXW	862.333
H	1	21.906	-	13.690	TRIANGLE	1/2 X L X H	149.947
J	1	1.800	6.078		RECTANGLE	LXW	10.940
K	1	1.263	-	0.789	TRIANGLE	1/2 X L X H	0.498
L	1	10.820	5.725		RECTANGLE	LXW	61.945
M	1	5.360	5.930		RECTANGLE	LXW	31.785
N	2	1.810	0.510		RECTANGLE	LXW	1.846
O	1	3.025	1.800		RECTANGLE	LXW	5.445
P	1	1.800	8.625		RECTANGLE	LXW	15.525
Q	1	1.800	2.980		RECTANGLE	LXW	5.364
R	1	3.600	4.705		RECTANGLE	LXW	16.938
S	1	1.800	1.373		RECTANGLE	LXW	2.471
T	1	0.811	-	1.298	TRIANGLE	1/2 X L X H	0.526
U	1	1.800	1.166		RECTANGLE	LXW	2.099
TOTAL							2565.977

S.NO	NO.S	LENGTH(L)	WIDTH(W)	HEIGHT(H)	POLYLINE	FORMULA	AREA
DEDUCTIONS							
1	1	0.990	-	0.620	TRIANGLE	1/2 X L X H	0.307
2	2	2.500	1.300		RECTANGLE	LXW	6.500
3	1	3.470	0.600		RECTANGLE	LXW	2.082
4	1	4.900	6.400		RECTANGLE	LXW	31.360
5	1	1.200	1.060		RECTANGLE	LXW	1.272
6	2	1.770	0.490		RECTANGLE	LXW	1.735
7	1	0.960	-	0.600	TRIANGLE	1/2 X L X H	0.288
8	1	0.600	0.390		RECTANGLE	LXW	0.234
9	1	2.900	1.350		RECTANGLE	LXW	3.915
10	1	0.567	1.350		RECTANGLE	LXW	0.765
11	1	2.160	-	1.350	TRIANGLE	1/2 X L X H	1.458
12	1	5.200	6.085		RECTANGLE	LXW	31.642
13	1	0.600	4.055		RECTANGLE	LXW	2.433
14	1	1.800	1.800		RECTANGLE	LXW	3.240
15	1	12.100	0.485		RECTANGLE	LXW	5.869
16	1	0.900	3.450		RECTANGLE	LXW	3.105
17	1	6.100	5.200		RECTANGLE	LXW	31.720
18	2	1.950	2.500		RECTANGLE	LXW	9.750
19	1	4.715	0.655		RECTANGLE	LXW	3.088
20	1	4.500	7.305		RECTANGLE	LXW	32.873
21	1	1.800	1.800		RECTANGLE	LXW	3.240
22	2	1.800	1.186		RECTANGLE	LXW	4.270
TOTAL							181.145
TOTAL COVD. AREA ON FIRST FLOOR =							2384.832



(RAM ANAND BASTI) S.D.
 (BALWANT SINGH) S.D.
 A.P. F.O. (HQ)
 DFS PKL.
 Member B.P.C.

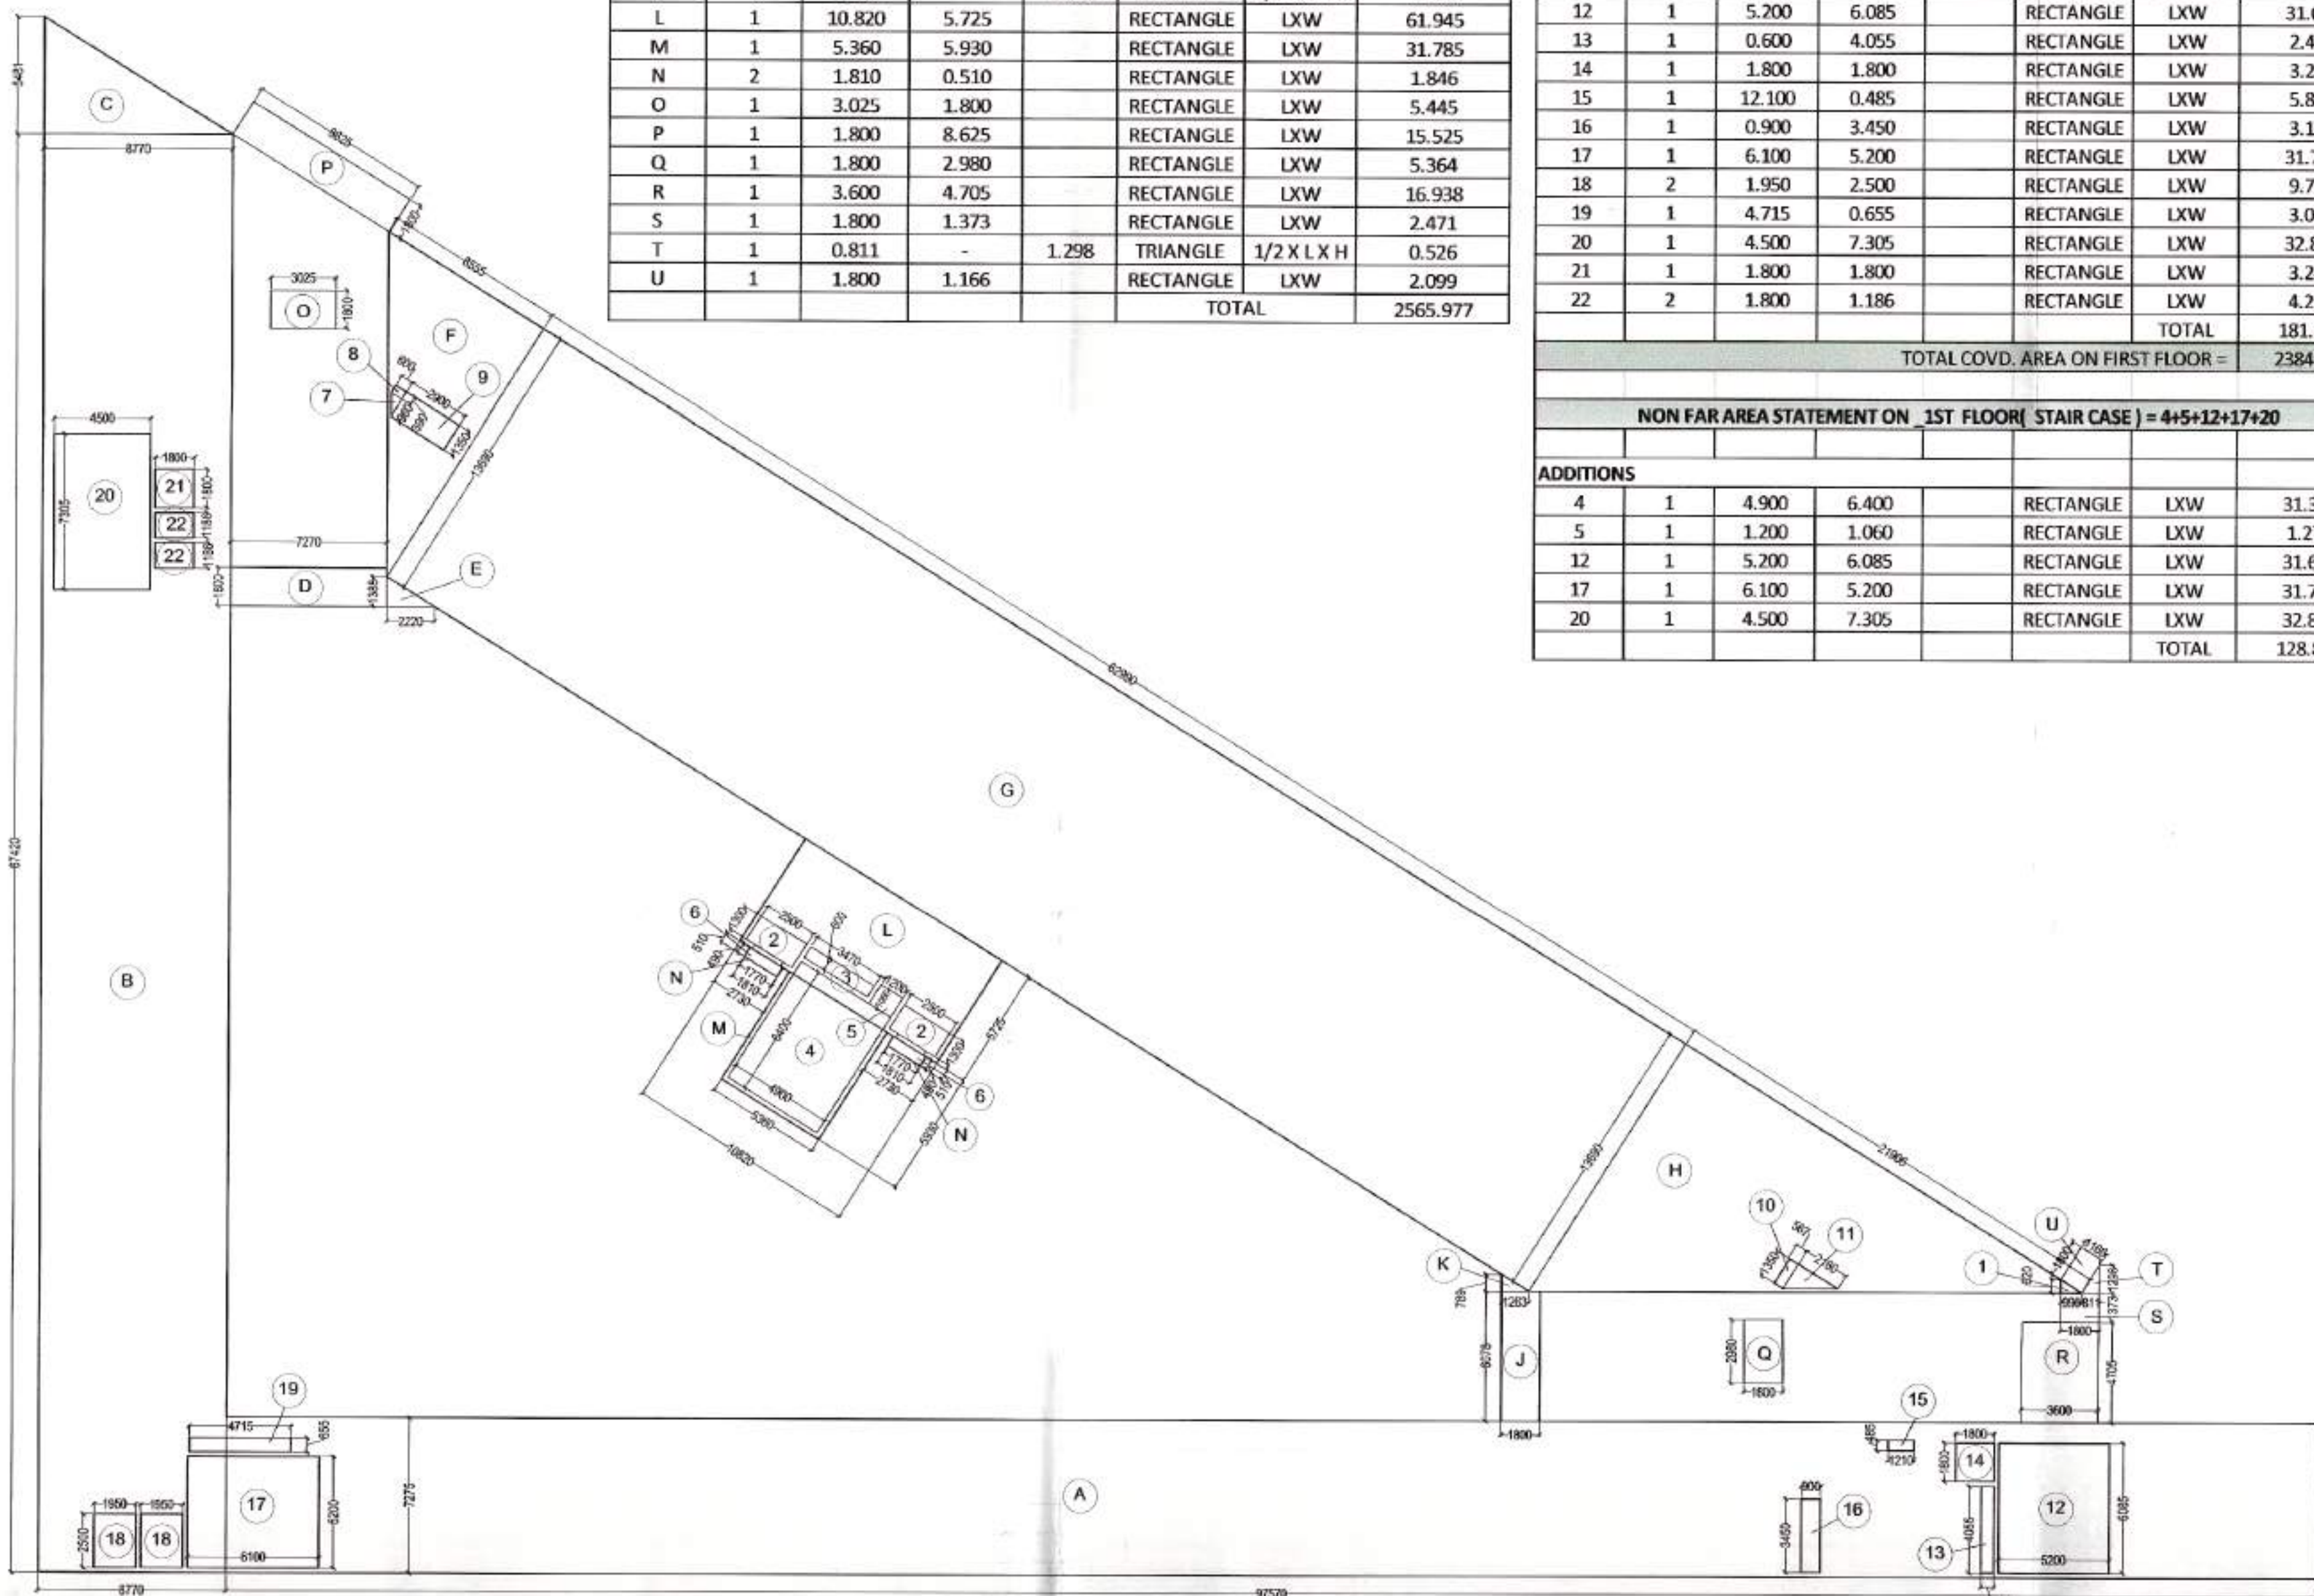


NON FAR AREA STATEMENT ON 1ST FLOOR (STAIR CASE) = 4+5+12+17+20							
S.NO	NO.S	LENGTH(L)	WIDTH(W)	HEIGHT(H)	POLYLINE	FORMULA	AREA
ADDITIONS							
4	1	4.900	6.400		RECTANGLE	LXW	31.360
5	1	1.200	1.060		RECTANGLE	LXW	1.272
12	1	5.200	6.085		RECTANGLE	LXW	31.642
17	1	6.100	5.200		RECTANGLE	LXW	31.720
20	1	4.500	7.305		RECTANGLE	LXW	32.873
TOTAL							128.867

AREA STATEMENT GROUND FLOOR UNDER FAR-A TO Y							
S.NO	NO.S	LENGTH(L)	WIDTH(W)	HEIGHT(H)	POLYLINE	FORMULA	AREA
ADDITIONS							
A	1	96.840	8.005		RECTANGLE	LXW	775.204
B	1	10.230	67.826		RECTANGLE	LXW	693.860
C	1	10.230	-	6.393	TRIANGLE	1/2 X L X H	32.700
D	1	9.468	-	15.150	TRIANGLE	1/2 X L X H	71.720
E	1	61.366	15.150		RECTANGLE	LXW	929.695
F	1	24.242	-	15.150	TRIANGLE	1/2 X L X H	183.633
G	1	1.800	5.348		RECTANGLE	LXW	9.626
H	1	6.540	1.800		RECTANGLE	LXW	11.772
J	1	0.843	-	0.527	TRIANGLE	1/2 X L X H	0.222
K	1	10.820	10.926		RECTANGLE	LXW	118.219
L	2	1.650	11.175		RECTANGLE	LXW	36.878
M	1	5.600	3.000		RECTANGLE	LXW	16.800
N	1	8.060	3.000		RECTANGLE	LXW	24.180
O	1	3.000	5.760		RECTANGLE	LXW	17.280
P	1	4.100	3.000		RECTANGLE	LXW	12.300
Q	1	2.295	1.800		RECTANGLE	LXW	4.131
R	1	7.786	1.800		RECTANGLE	LXW	14.015
S	1	1.800	2.250		RECTANGLE	LXW	4.050
T	1	1.800	1.650		RECTANGLE	LXW	2.970
U	1	2.530	5.348		RECTANGLE	LXW	13.530
V	1	1.800	-	1.023	TRIANGLE	1/2 X L X H	0.921
W	1	0.846	0.998		RECTANGLE	LXW	0.844
X	1	0.846	-	0.529	TRIANGLE	1/2 X L X H	0.224
Y	1	0.954	-	1.527	TRIANGLE	1/2 X L X H	0.728
TOTAL COVD. AREA ON GROUND FLOOR =							2975.503

NON FAR AREA STATEMENT ON GROUND FLOOR (TRIUM) = A1+A2+A3 (K+M+N+O+P)							
S.NO	NO.S	LENGTH(L)	WIDTH(W)	HEIGHT(H)	POLYLINE	FORMULA	AREA
ADDITIONS							
A1	1	51.351	5.348		RECTANGLE	LXW	274.625
A2	1	7.382	37.343		RECTANGLE	LXW	275.666
A3	1	51.311	-	31.995	TRIANGLE	1/2 X L X H	820.888
TOTAL							1371.139
DEDUCTIONS							
K	1	10.820	10.926		RECTANGLE	LXW	118.219
M	1	5.600	3.000		RECTANGLE	LXW	16.800
N	1	8.060	3.000		RECTANGLE	LXW	24.180
O	1	3.000	5.760		RECTANGLE	LXW	17.280
P	1	4.100	3.000		RECTANGLE	LXW	12.300
TOTAL							188.779
TOTAL NON FAR AREA ON GROUND FLOOR =							1182.360

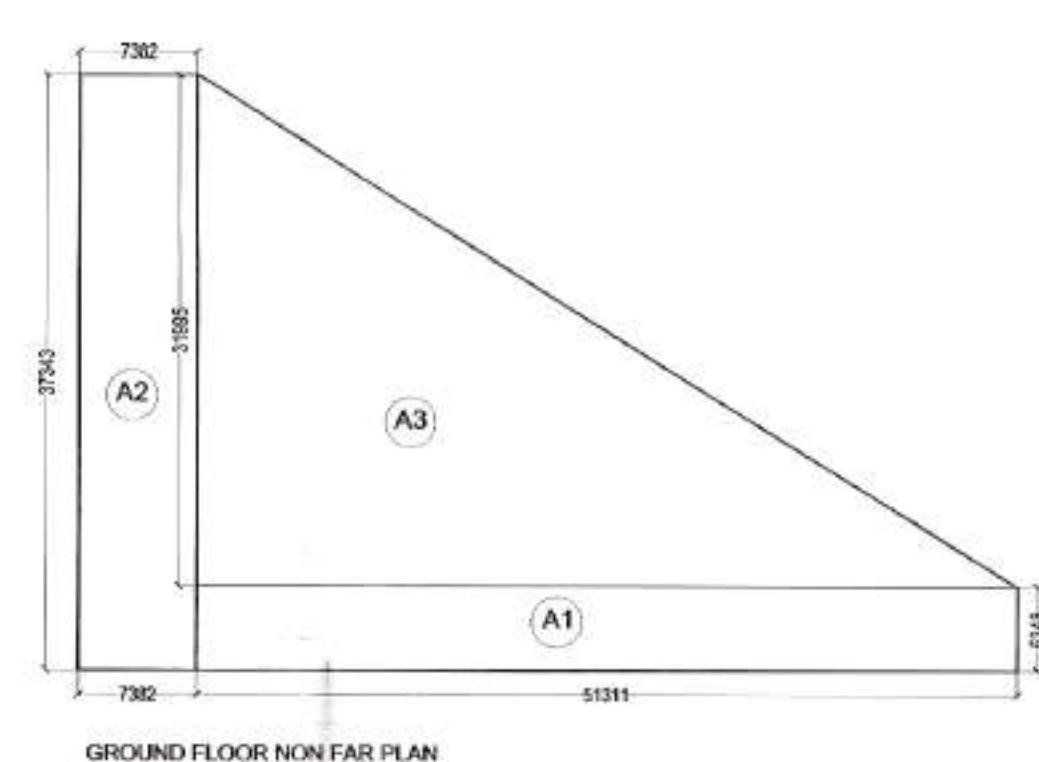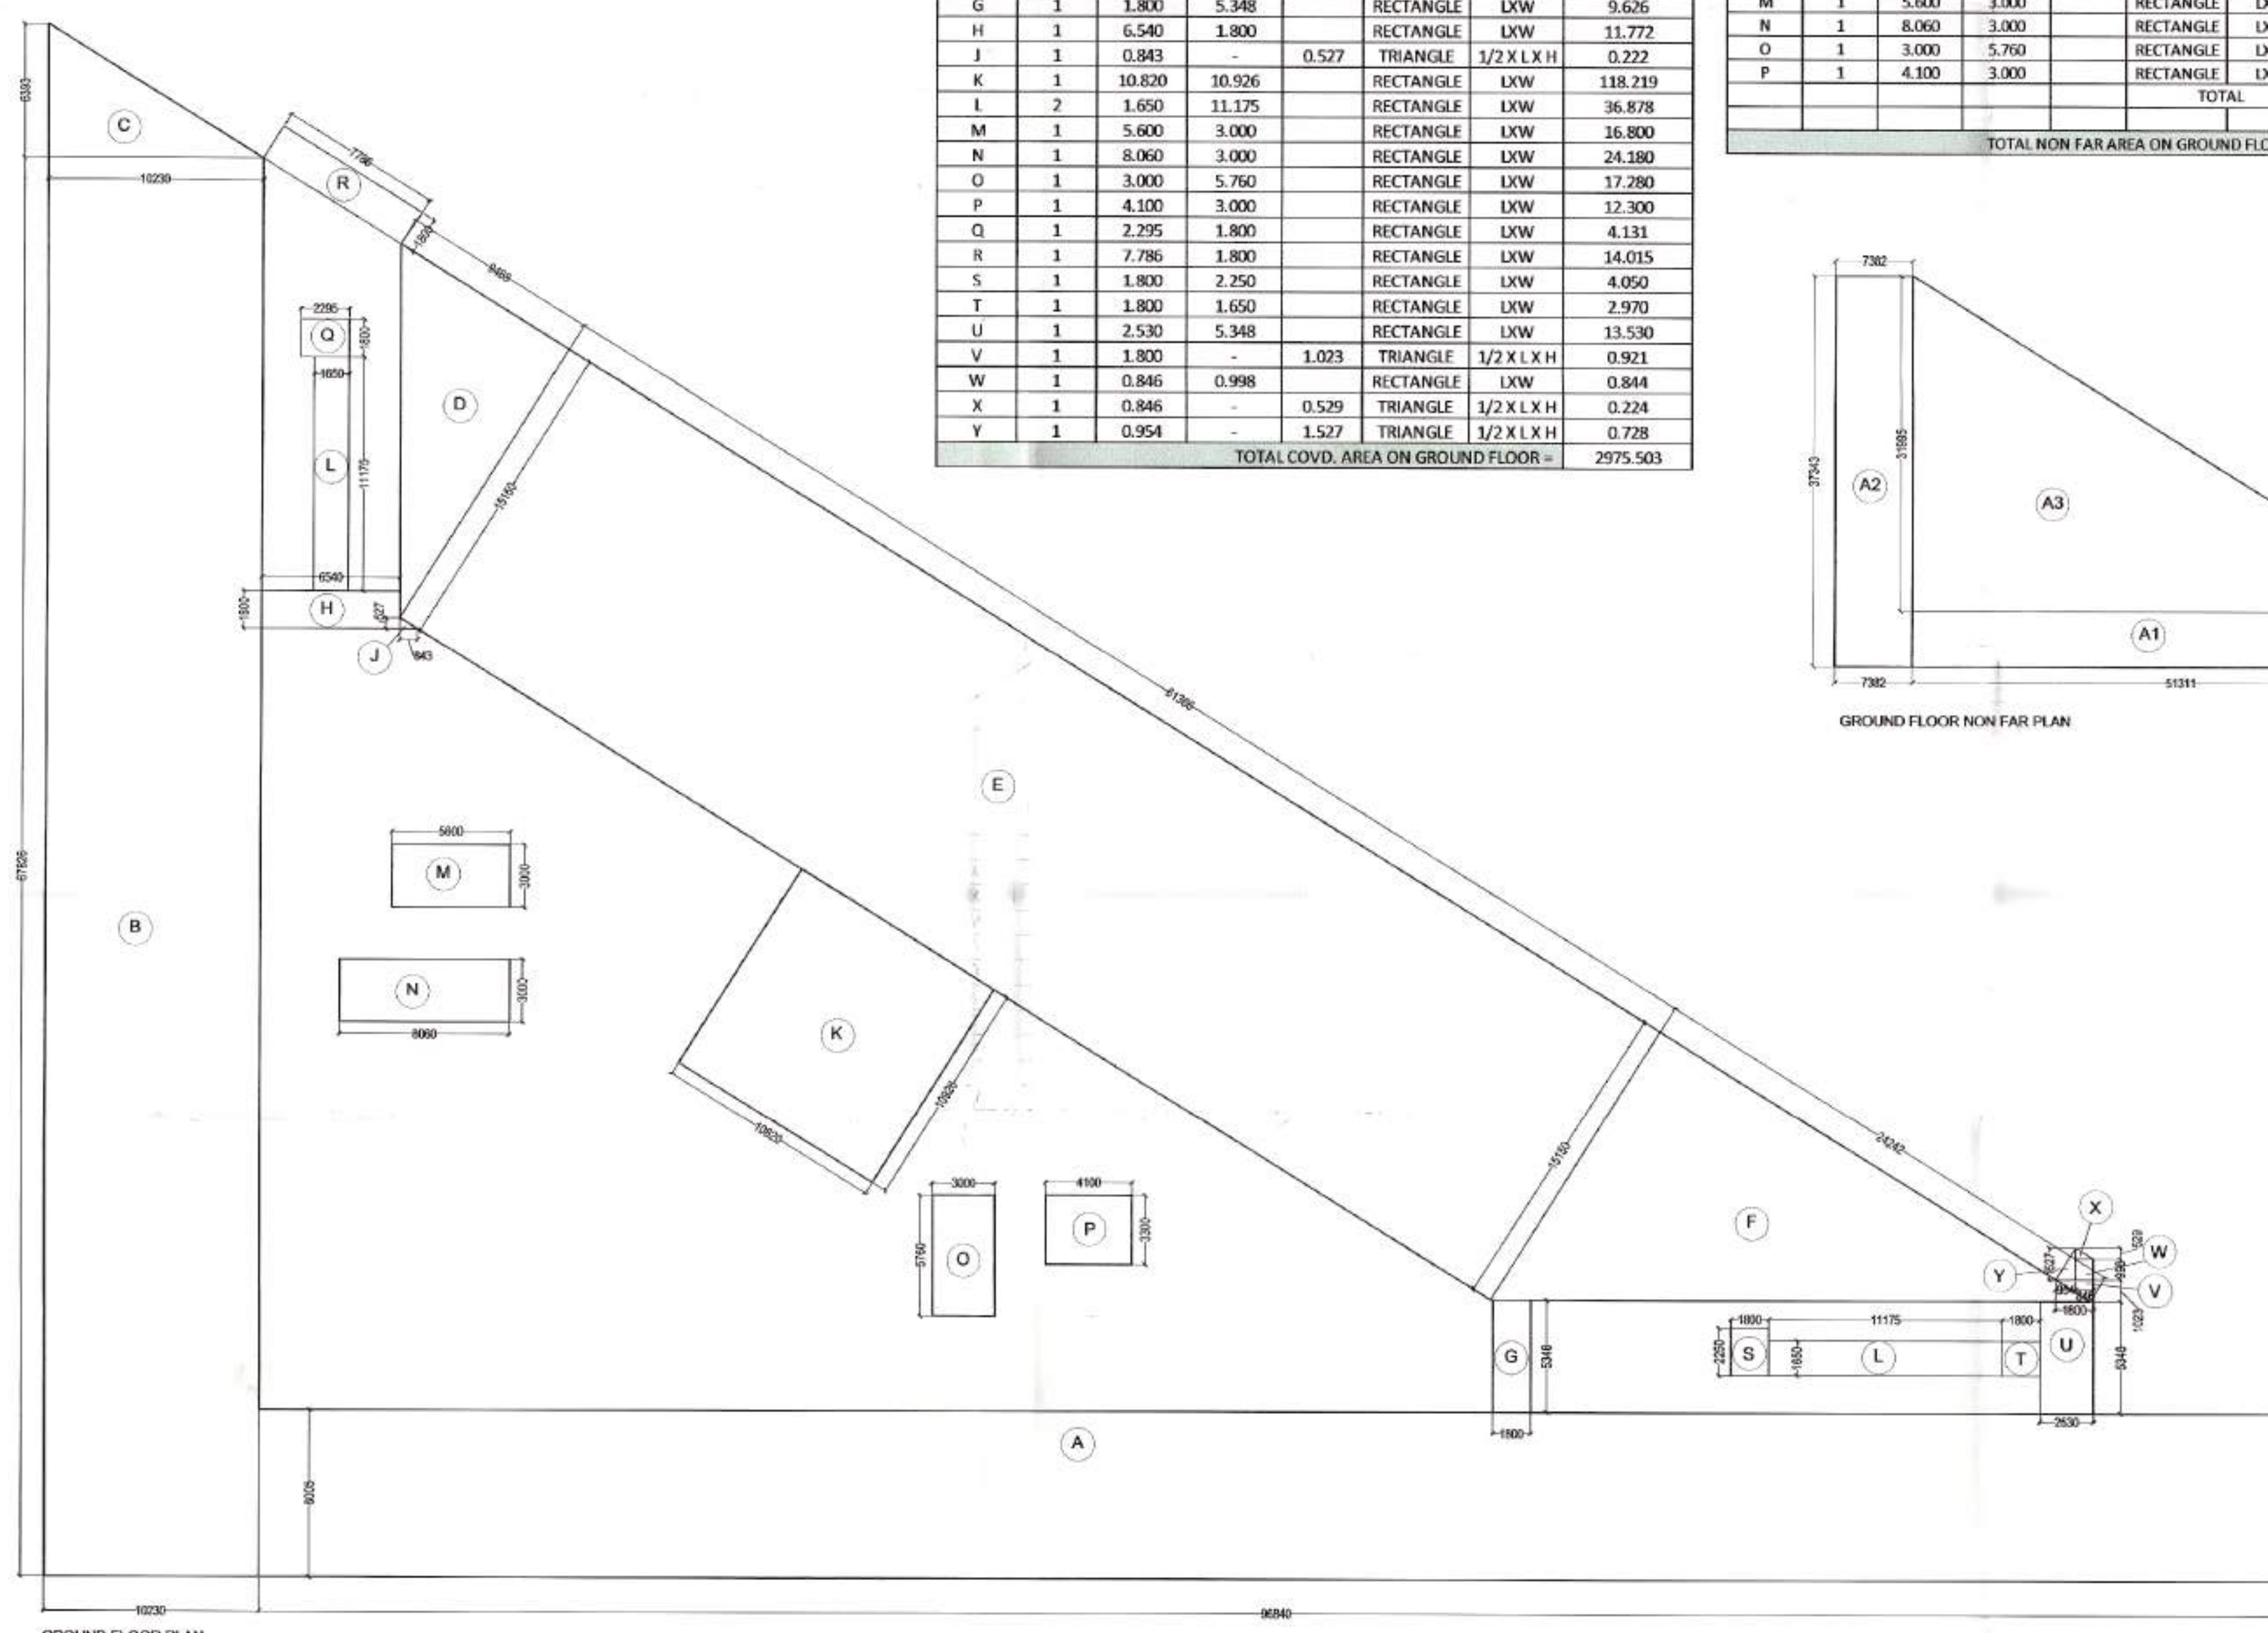

PROJECT:-
 REVISED BUILDING PLANS OF COMMERCIAL SITE
 MEASURING 2.0 ACRE
 (LICENCE NO. 56 OF 2007 DATED 23.01.2007) IN
 SECTOR-24, DHARUHERA, BEING DEVELOPED BY.
 M/S DWARKADHISH PROJECTS PVT. LTD.
 DWG. TITLE
 AREA STATEMENT
 DRG. NO. A-03
 Dwarkadhish Projects Pvt. Ltd.
 V. Jain
 Authorized Signatory
 SIG. OF OWNER
 DATYA PANKAJ
 ARCHITECT
 C/20/2/257A
 SIG. OF ARCHITECT

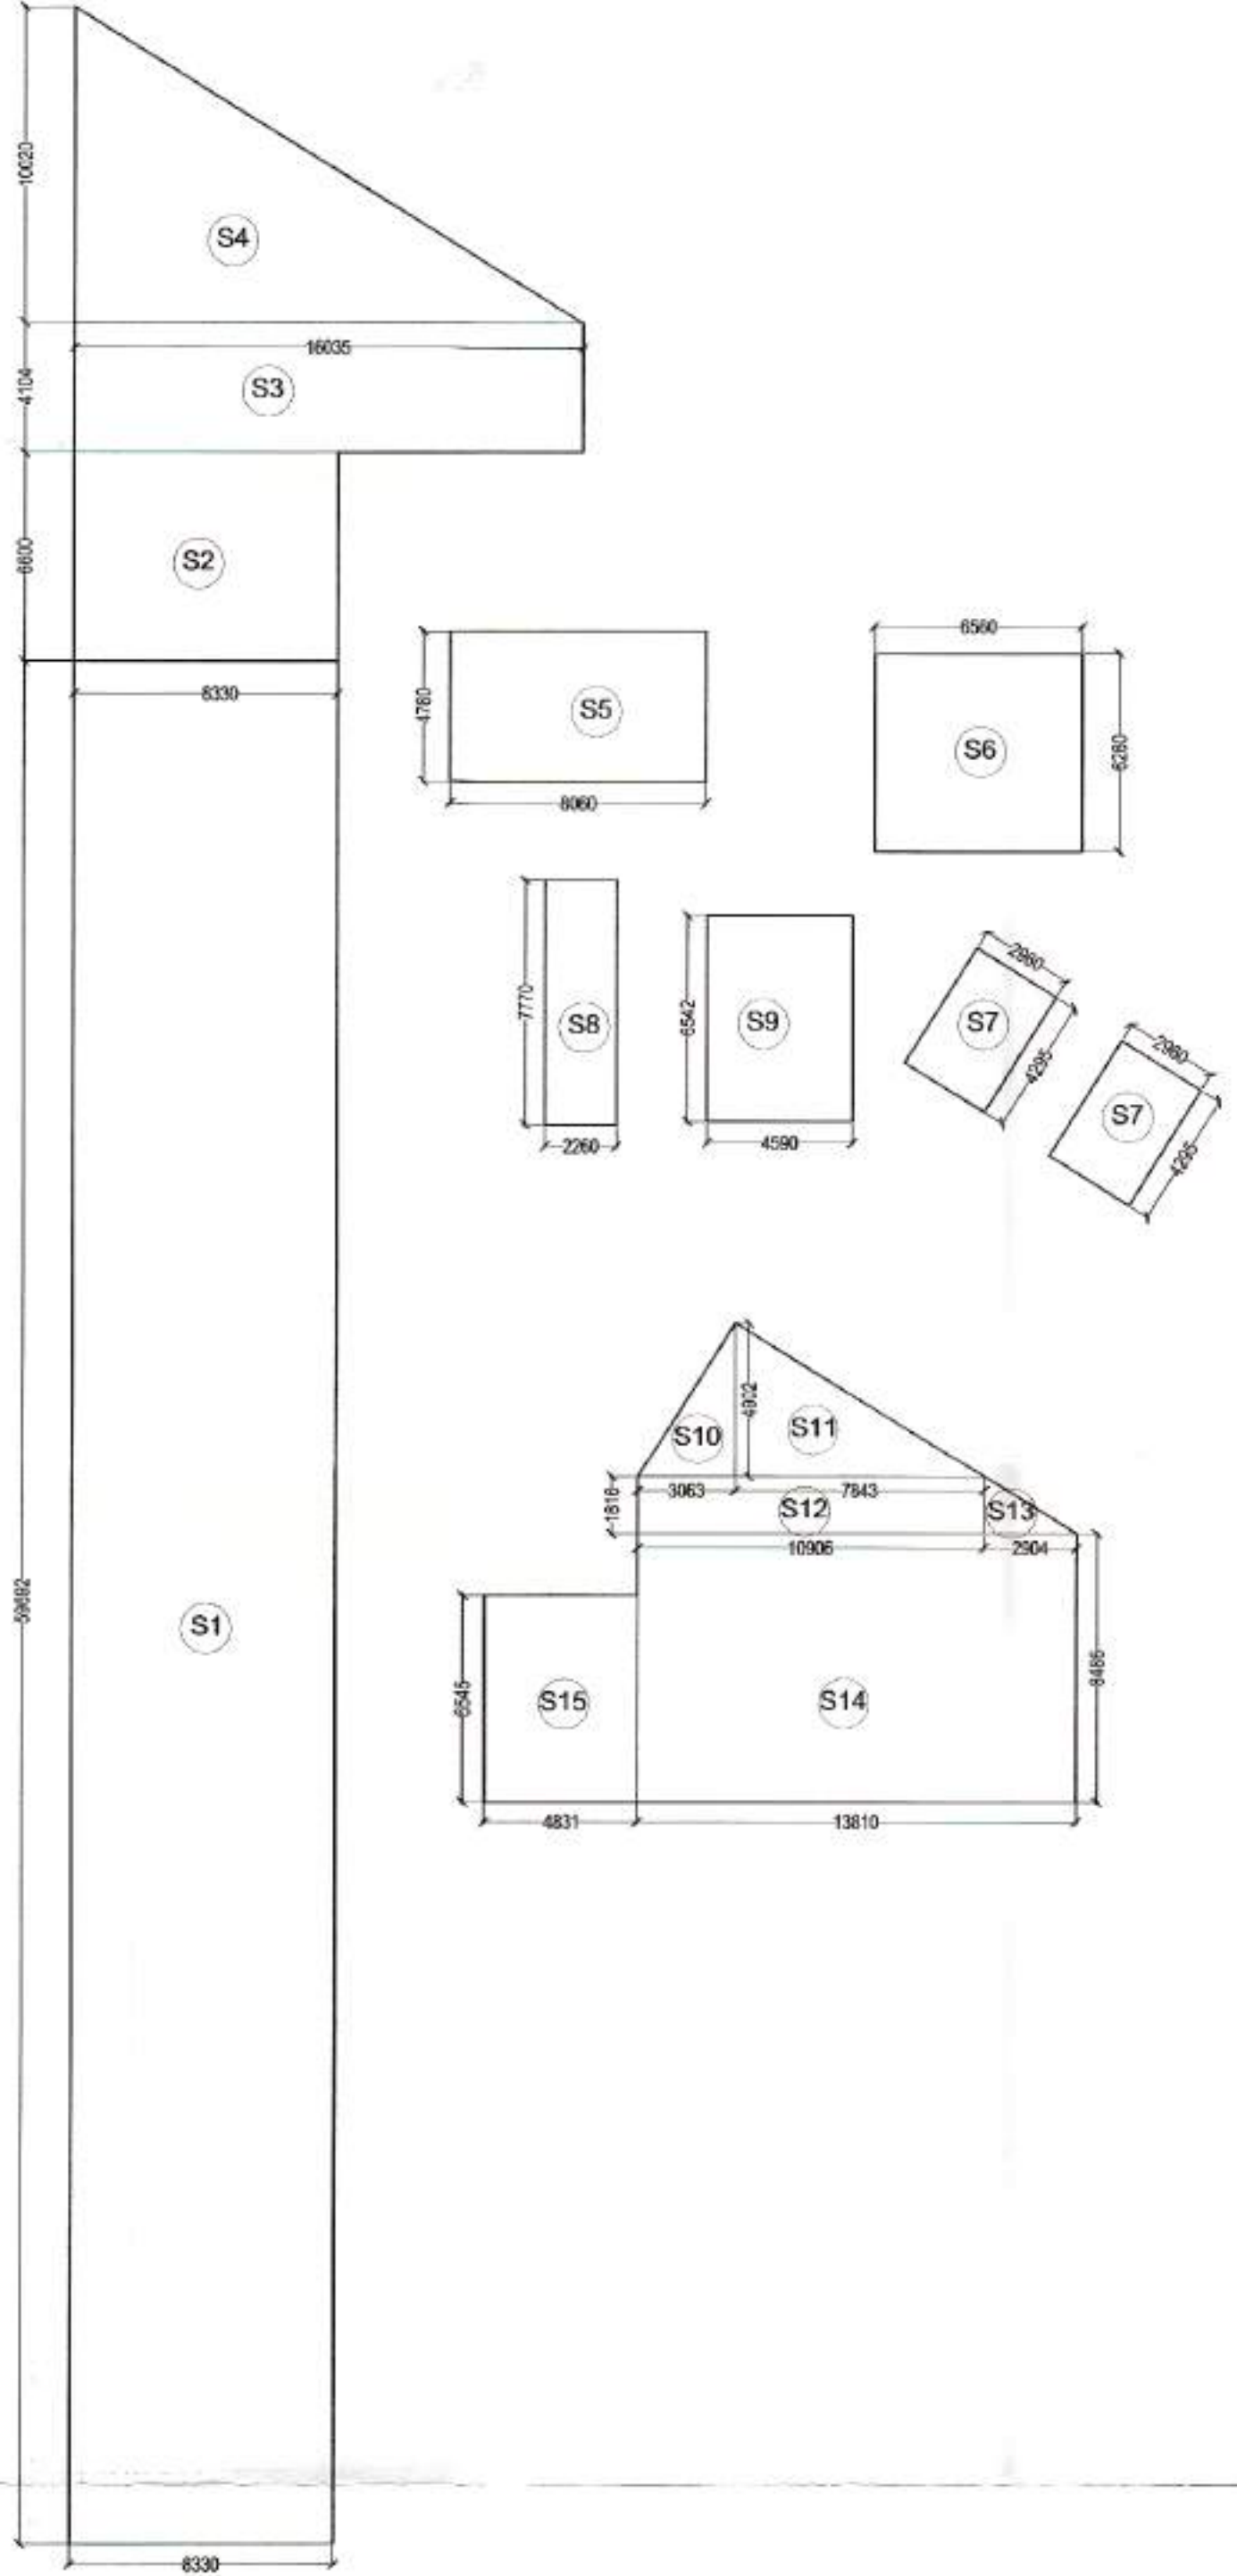

AREA STATEMENT UNDER BASEMENT FLOOR =A TO B							
S.NO	NO.S	LENGTH(L)	WIDTH(W)	HEIGHT(H)	POLYLINE	FORMULA	AREA
ADDITIONS							
A	1	115.100	-	71.931	TRIANGLE	1/2 X L X H	4139.629
B	1	115.100	8.486		RECTANGLE	LXW	976.739
TOTAL COVD. AREA UNDER BASEMENT FLOOR =							5116.368
S.NO	NO.S	LENGTH(L)	WIDTH(W)	HEIGHT(H)	POLYLINE	FORMULA	AREA
SERVICE AREA (1 TO 15)							
S1	1	8.330	59.692		RECTANGLE	LXW	497.234
S2	1	8.330	6.600		RECTANGLE	LXW	54.978
S3	1	16.035	4.104		RECTANGLE	LXW	65.808
S4	1	16.035	-	10.020	TRIANGLE	1/2 X L X H	80.335
S5	1	8.060	4.760		RECTANGLE	LXW	38.366
S6	1	6.560	6.260		RECTANGLE	LXW	41.066
S7	2	2.960	4.295		RECTANGLE	LXW	25.426
S8	1	6.260	7.770		RECTANGLE	LXW	48.640
S9	1	4.590	6.542		RECTANGLE	LXW	30.028
S10	1	3.063	-	4.902	TRIANGLE	1/2 X L X H	7.507
S11	1	7.843	-	4.902	TRIANGLE	1/2 X L X H	19.223
S12	1	10.906	1.816		RECTANGLE	LXW	19.805
S13	1	2.904	-	1.816	TRIANGLE	1/2 X L X H	2.637
S14	1	13.810	8.486		RECTANGLE	LXW	117.192
S15	1	4.831	6.545		RECTANGLE	LXW	31.619
TOTAL SERVICE AREA							1079.864
TOTAL BASEMENT AREA FOR PARKING =							4036.503

S.T.P. Member Secretary B.P.C.
 S.T.P. Member B.P.C.
 C.T.P.H. Chairman B.P.C.
 (RAMAYAR BASSI) A.D.
 (BALWANT SINGH) S.D.

A.D.F.O. (HQ)
 DFS PKL
 Member B.P.C.

PROJECT:-
 REVISED BUILDING PLANS OF COMMERCIAL SITE
 MEASURING 2.0 ACRE
 (LICENCE NO. 56 OF 2007 DATED 23.01.2007) IN
 SECTOR-24, DHARUHERA, BEING DEVELOPED BY
 M/S DWARKADHISH PROJECTS PVT. LTD.

DWG. TITLE
 AREA STATEMENT

DWG. NO. A-02


Dwarkadhish Projects Pvt. Ltd.
 V. Jain
 Authorised Signatory

BATYAR PARWASH SHARMA
 ARCHITECT
 CHANDIGARH


SIG. OF OWNER SIG. OF ARCHITECT

(RAM AVTAR BASSI) A.D.
 (BALWANT SINGH) S.D.
 Member Secretary B.P.C.
 Member B.P.C.
 C.P.W. Officer B.P.C.
 ATP

F.O. (HD)
 DFS PKL
 Member B.P.C.

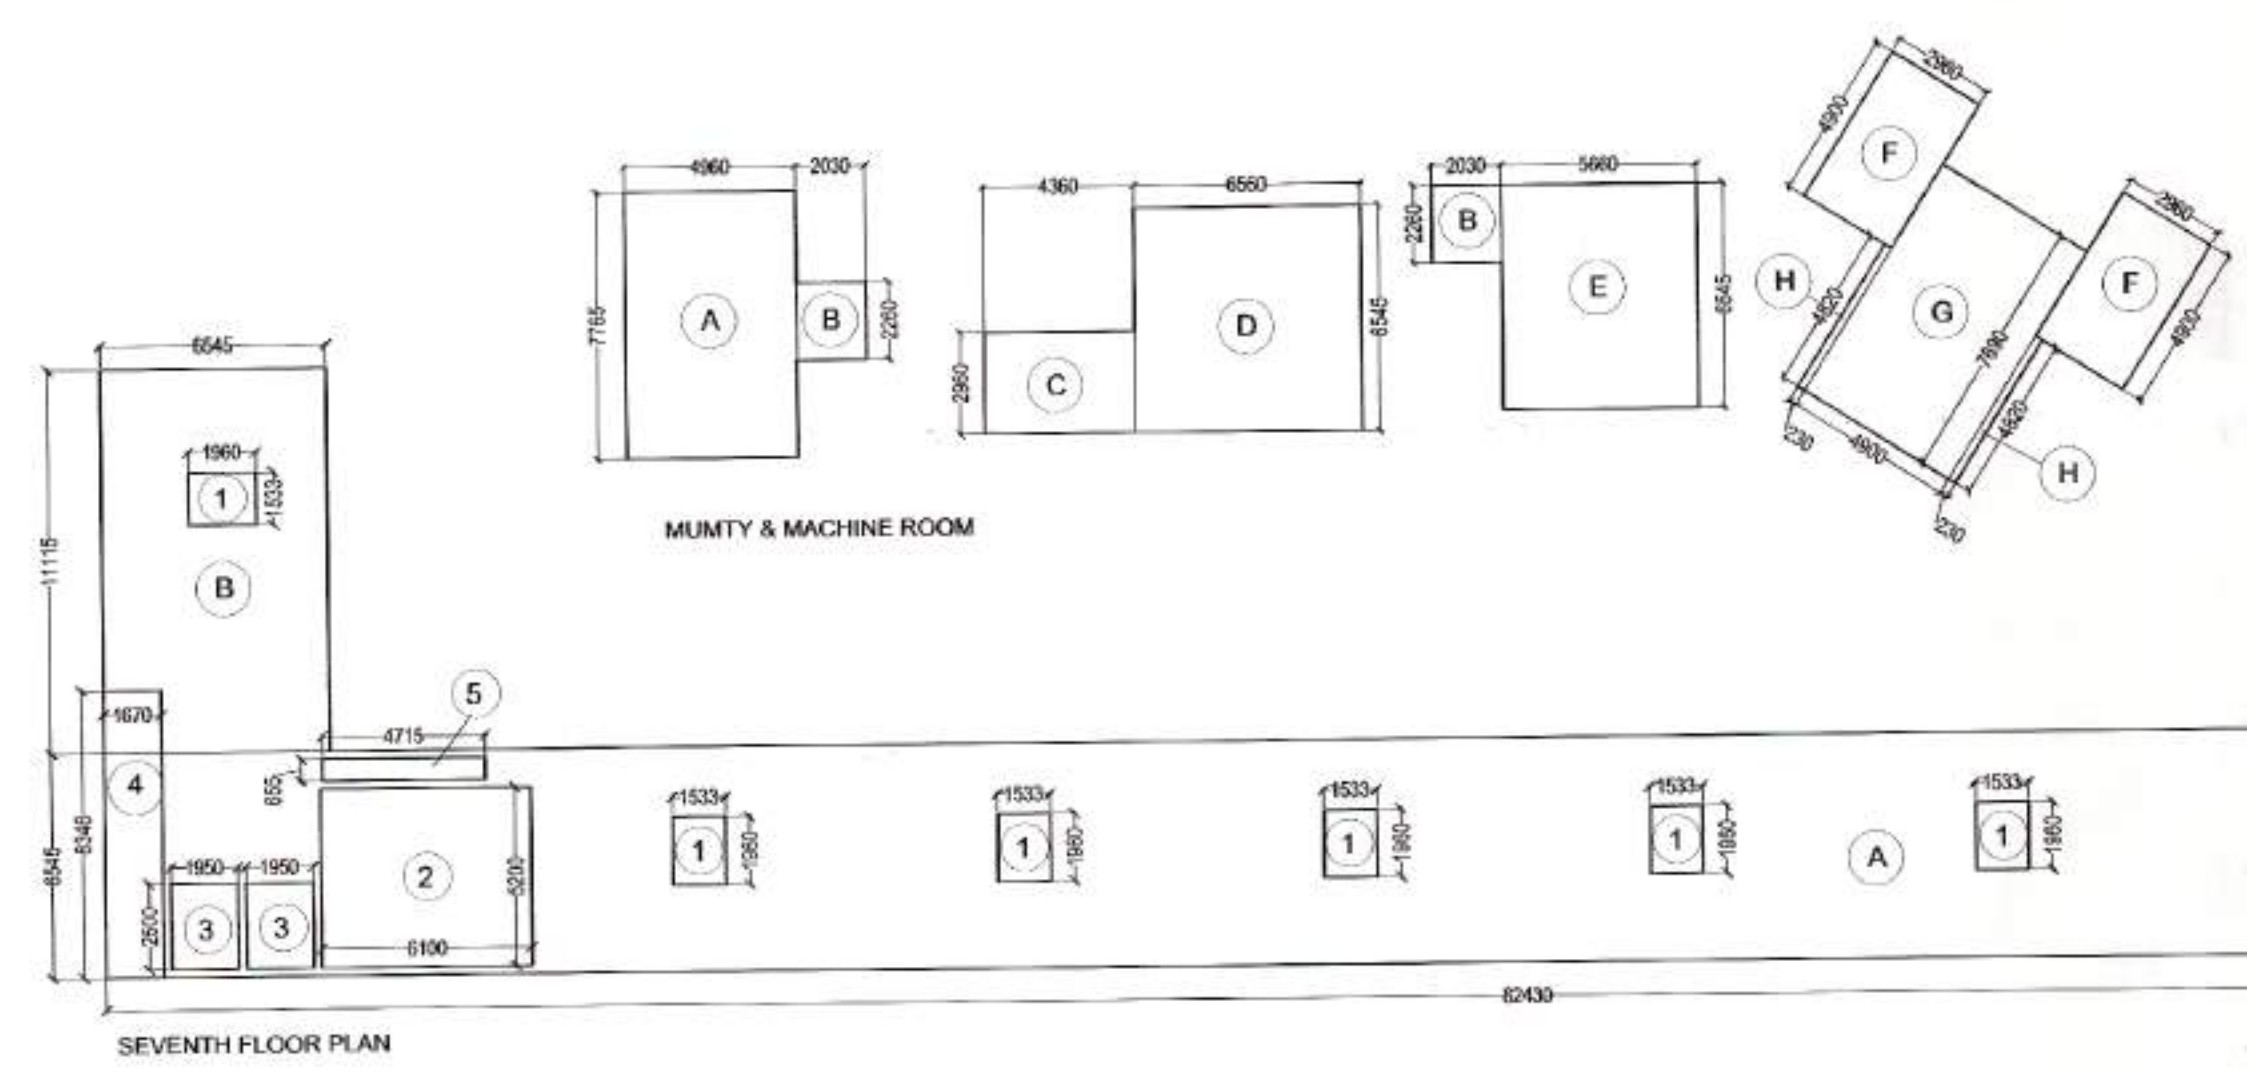

AREA STATEMENT MUMTY & MACHINE-A TO H							
S.NO	NO.S	LENGTH(L)	WIDTH(W)	HEIGHT(H)	POLYLINE	FORMULA	AREA
ADDITIONS							
A	1	4.960	7.765		RECTANGLE	LXW	38.514
B	2	2.030	2.260		RECTANGLE	LXW	9.176
C	1	4.360	2.960		RECTANGLE	LXW	12.906
D	1	6.560	6.545		RECTANGLE	LXW	42.935
E	1	5.660	6.545		RECTANGLE	LXW	37.045
F	2	2.960	4.900		RECTANGLE	LXW	29.008
G	1	4.900	7.690		RECTANGLE	LXW	37.681
H	2	0.230	4.820		RECTANGLE	LXW	2.217
TOTAL COVD. AREA UNDER MUMTY & MACHINE ROOM =							209.482

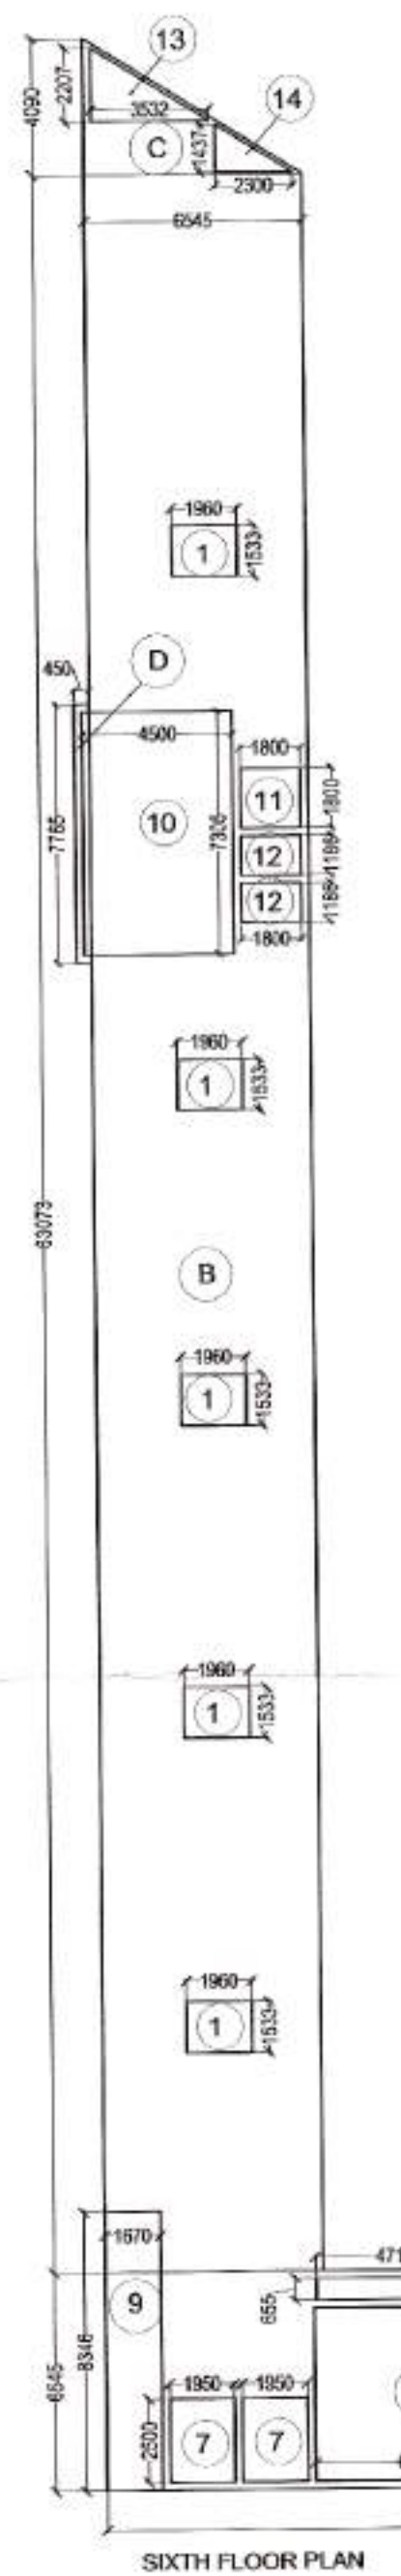

AREA STATEMENT 6TH FLOOR UNDER FAR-A TO D - (1 TO 14)							
S.NO	NO.S	LENGTH(L)	WIDTH(W)	HEIGHT(H)	POLYLINE	FORMULA	AREA
ADDITIONS							
A	1	105.609	6.545		RECTANGLE	LXW	691.211
B	1	6.545	63.073		RECTANGLE	LXW	412.813
C	1	6.545	-	4.090	TRIANGLE	1/2 X L X H	13.385
D	1	0.450	7.765		RECTANGLE	LXW	3.494
TOTAL							1120.902
DEDUCTIONS							
1	14	1.533	1.960		RECTANGLE	LXW	42.066
2	1	5.200	6.085		RECTANGLE	LXW	31.642
3	1	1.800	1.800		RECTANGLE	LXW	3.240
4	1	0.600	4.055		RECTANGLE	LXW	2.433
5	1	1.210	0.485		RECTANGLE	LXW	0.587
6	1	6.100	5.200		RECTANGLE	LXW	31.720
7	2	1.950	2.500		RECTANGLE	LXW	9.750
8	1	4.715	0.655		RECTANGLE	LXW	3.088
9	1	1.670	8.346		RECTANGLE	LXW	13.938
10	1	4.500	7.305		RECTANGLE	LXW	32.873
11	1	1.800	1.800		RECTANGLE	LXW	3.240
12	2	1.800	1.186		RECTANGLE	LXW	4.270
13	1	3.532	-	2.207	TRIANGLE	1/2 X L X H	3.898
14	1	2.300	-	1.437	TRIANGLE	1/2 X L X H	1.653
TOTAL							184.396
TOTAL COVD. AREA ON 6TH FLOOR =							936.507
NON FAR AREA STATEMENT ON 6TH FLOOR(STAIR CASE) = 2+6+10							
ADDITIONS							
2	1	5.200	6.085		RECTANGLE	LXW	31.642
6	1	6.100	5.200		RECTANGLE	LXW	31.720
10	1	4.500	7.305		RECTANGLE	LXW	32.873
TOTAL							96.235

AREA STATEMENT 7TH FLOOR UNDER FAR-A TO E - (1 TO 8)							
S.NO	NO.S	LENGTH(L)	WIDTH(W)	HEIGHT(H)	POLYLINE	FORMULA	AREA
ADDITIONS							
A	1	82.430	6.545		RECTANGLE	LXW	539.504
B	1	6.545	11.115		RECTANGLE	LXW	72.748
C	1	4.915	6.545		RECTANGLE	LXW	32.169
D	1	5.660	6.545		RECTANGLE	LXW	37.045
E	1	2.030	2.260		RECTANGLE	LXW	4.588
TOTAL							686.053
DEDUCTIONS							
1	8	1.533	1.960		RECTANGLE	LXW	24.037
2	1	6.100	5.200		RECTANGLE	LXW	31.720
3	2	1.900	2.500		RECTANGLE	LXW	9.500
4	1	1.670	8.346		RECTANGLE	LXW	13.938
5	1	4.715	0.655		RECTANGLE	LXW	3.088
6	1	0.881	1.960		RECTANGLE	LXW	1.727
7	1	5.200	6.085		RECTANGLE	LXW	31.642
8	1	1.800	1.800		RECTANGLE	LXW	3.240
TOTAL							118.892
TOTAL COVD. AREA ON 7TH FLOOR =							567.161
NON FAR AREA STATEMENT ON 7TH FLOOR(STAIR CASE) = 2+7							
ADDITIONS							
2	1	6.100	5.200		RECTANGLE	LXW	31.720
7	1	5.200	6.085		RECTANGLE	LXW	31.642
TOTAL							63.362

PROJECT-
 REVISED BUILDING PLANS OF COMMERCIAL SITE
 MEASURING 2.0 ACRE
 (LICENCE NO. 56 OF 2007 DATED 23.01.2007) IN
 SECTOR-24, DHARUHERA, BEING DEVELOPED BY.
 M/S DWARKADHISH PROJECTS PVT. LTD.

DWG. TITLE
AREA STATEMENT

DRG. NO. **A-06**


Dwarkadish Projects Pvt. Ltd.
 V. Jain
 Authorised Signatory

SATYA PAKHAI
 ARCHITECT
 CA/2000/2674

SIG. OF OWNER
 SIG. OF ARCHITECT

(RAJESH BASSI) A.D.
 (BALWANT SINGH) S.D.
 Checked and found ok for Public Health (Internal) Service only subject to comments in forwarding letter to SE(HQ) Dt. 28/1/18
 3387
 Superintending Engineer (HO) HUDA, Panchsala.
 29/1/18

A.D.F.O. (HO)
 DFS PKL
 Member B.P.C.

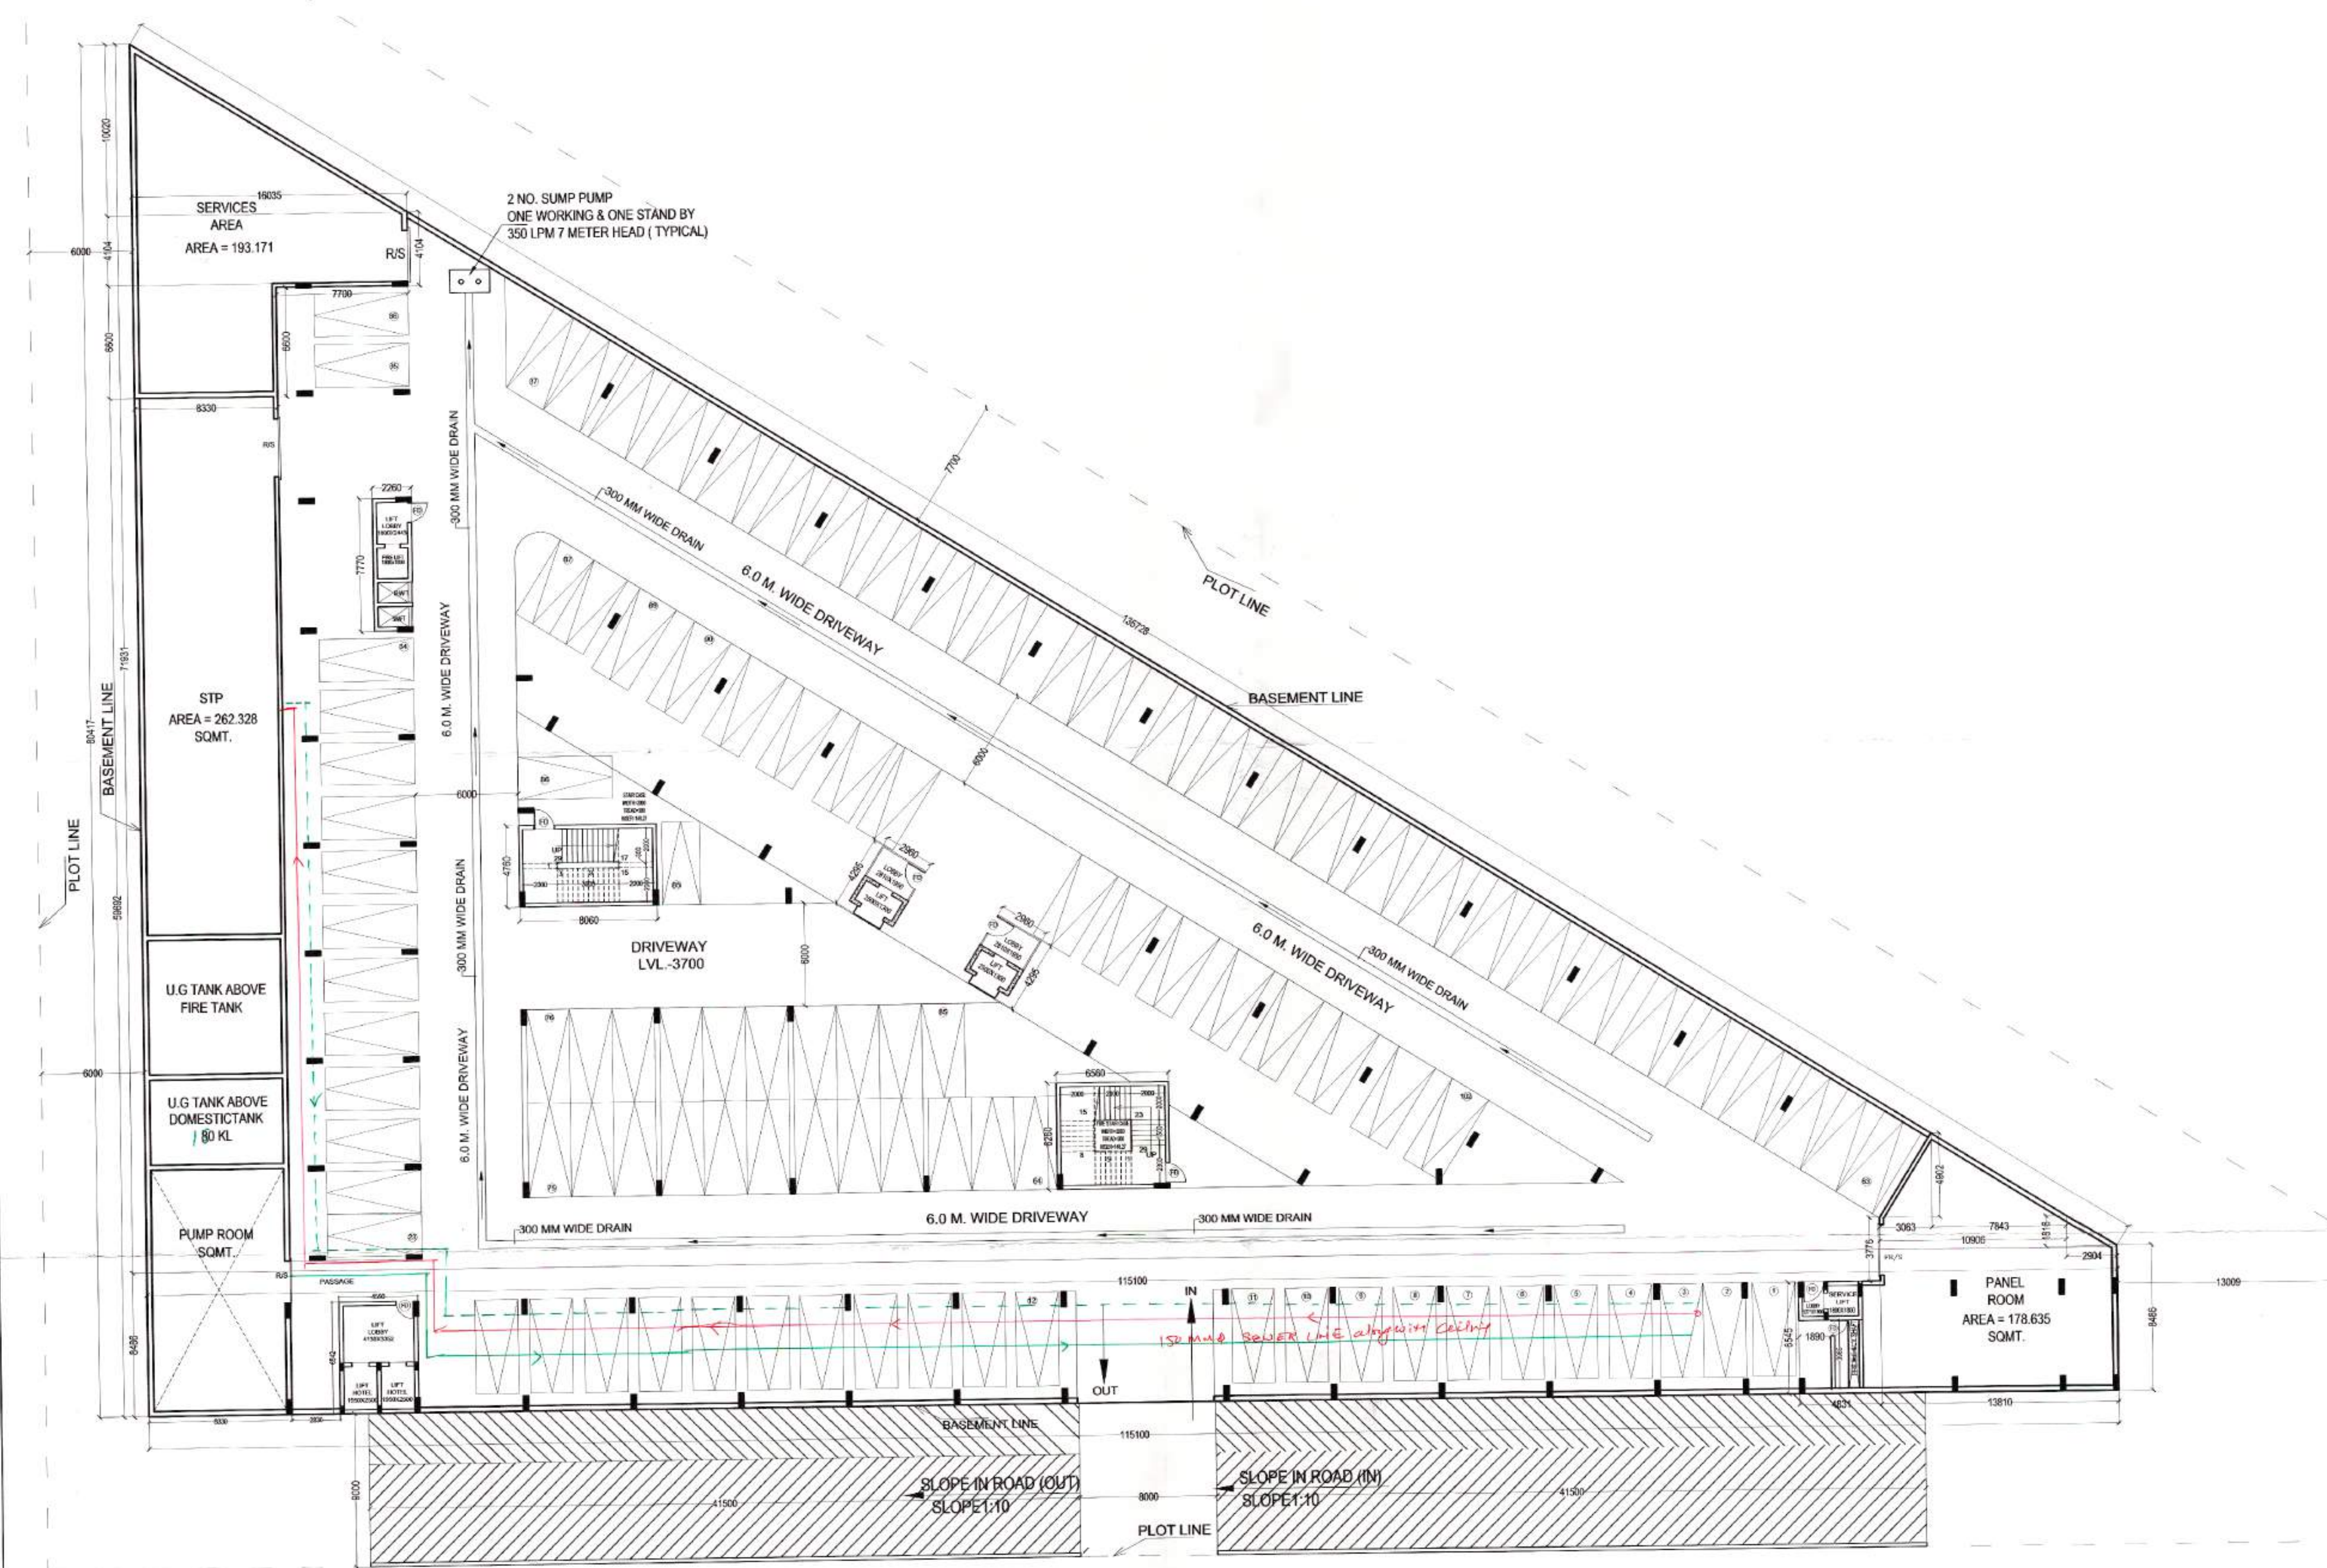

BASEMENT FLOOR WITH MECHANICAL PARKING
 PARKING 102+102 (MECHANICAL PARKING)


PROJECT: REVISED BUILDING PLANS OF COMMERCIAL SITE MEASURING 2.0 ACRE (LICENCE NO. 56 OF 2007 DATED 23.01.2007) IN SECTOR-24, DHARUHERA, BEING DEVELOPED BY, M/S DWARKADISH PROJECTS PVT. LTD.	
DWG. TITLE: BASEMENT FLOOR PLAN	
SCALE 1:200	DRG. NO. A-07
Dworkadish Projects Pvt. Ltd. U. Jain Authorised Signatory	
SIG. OF OWNER	SIG. OF ARCHITECT

Checked and Found ok for Public Health (Internal) & Price only subject to comments in in forward. No. SE(HQ) Dt. 23/01/17

Superintendent Engineer (HQ) HUDA, Pat. 23/01/17

(RAM AVATAR BASSI) A.D. (BALWANT SINGH) S.D.

A.D.F.O. (HQ) DFS PKL Member B.P.C.

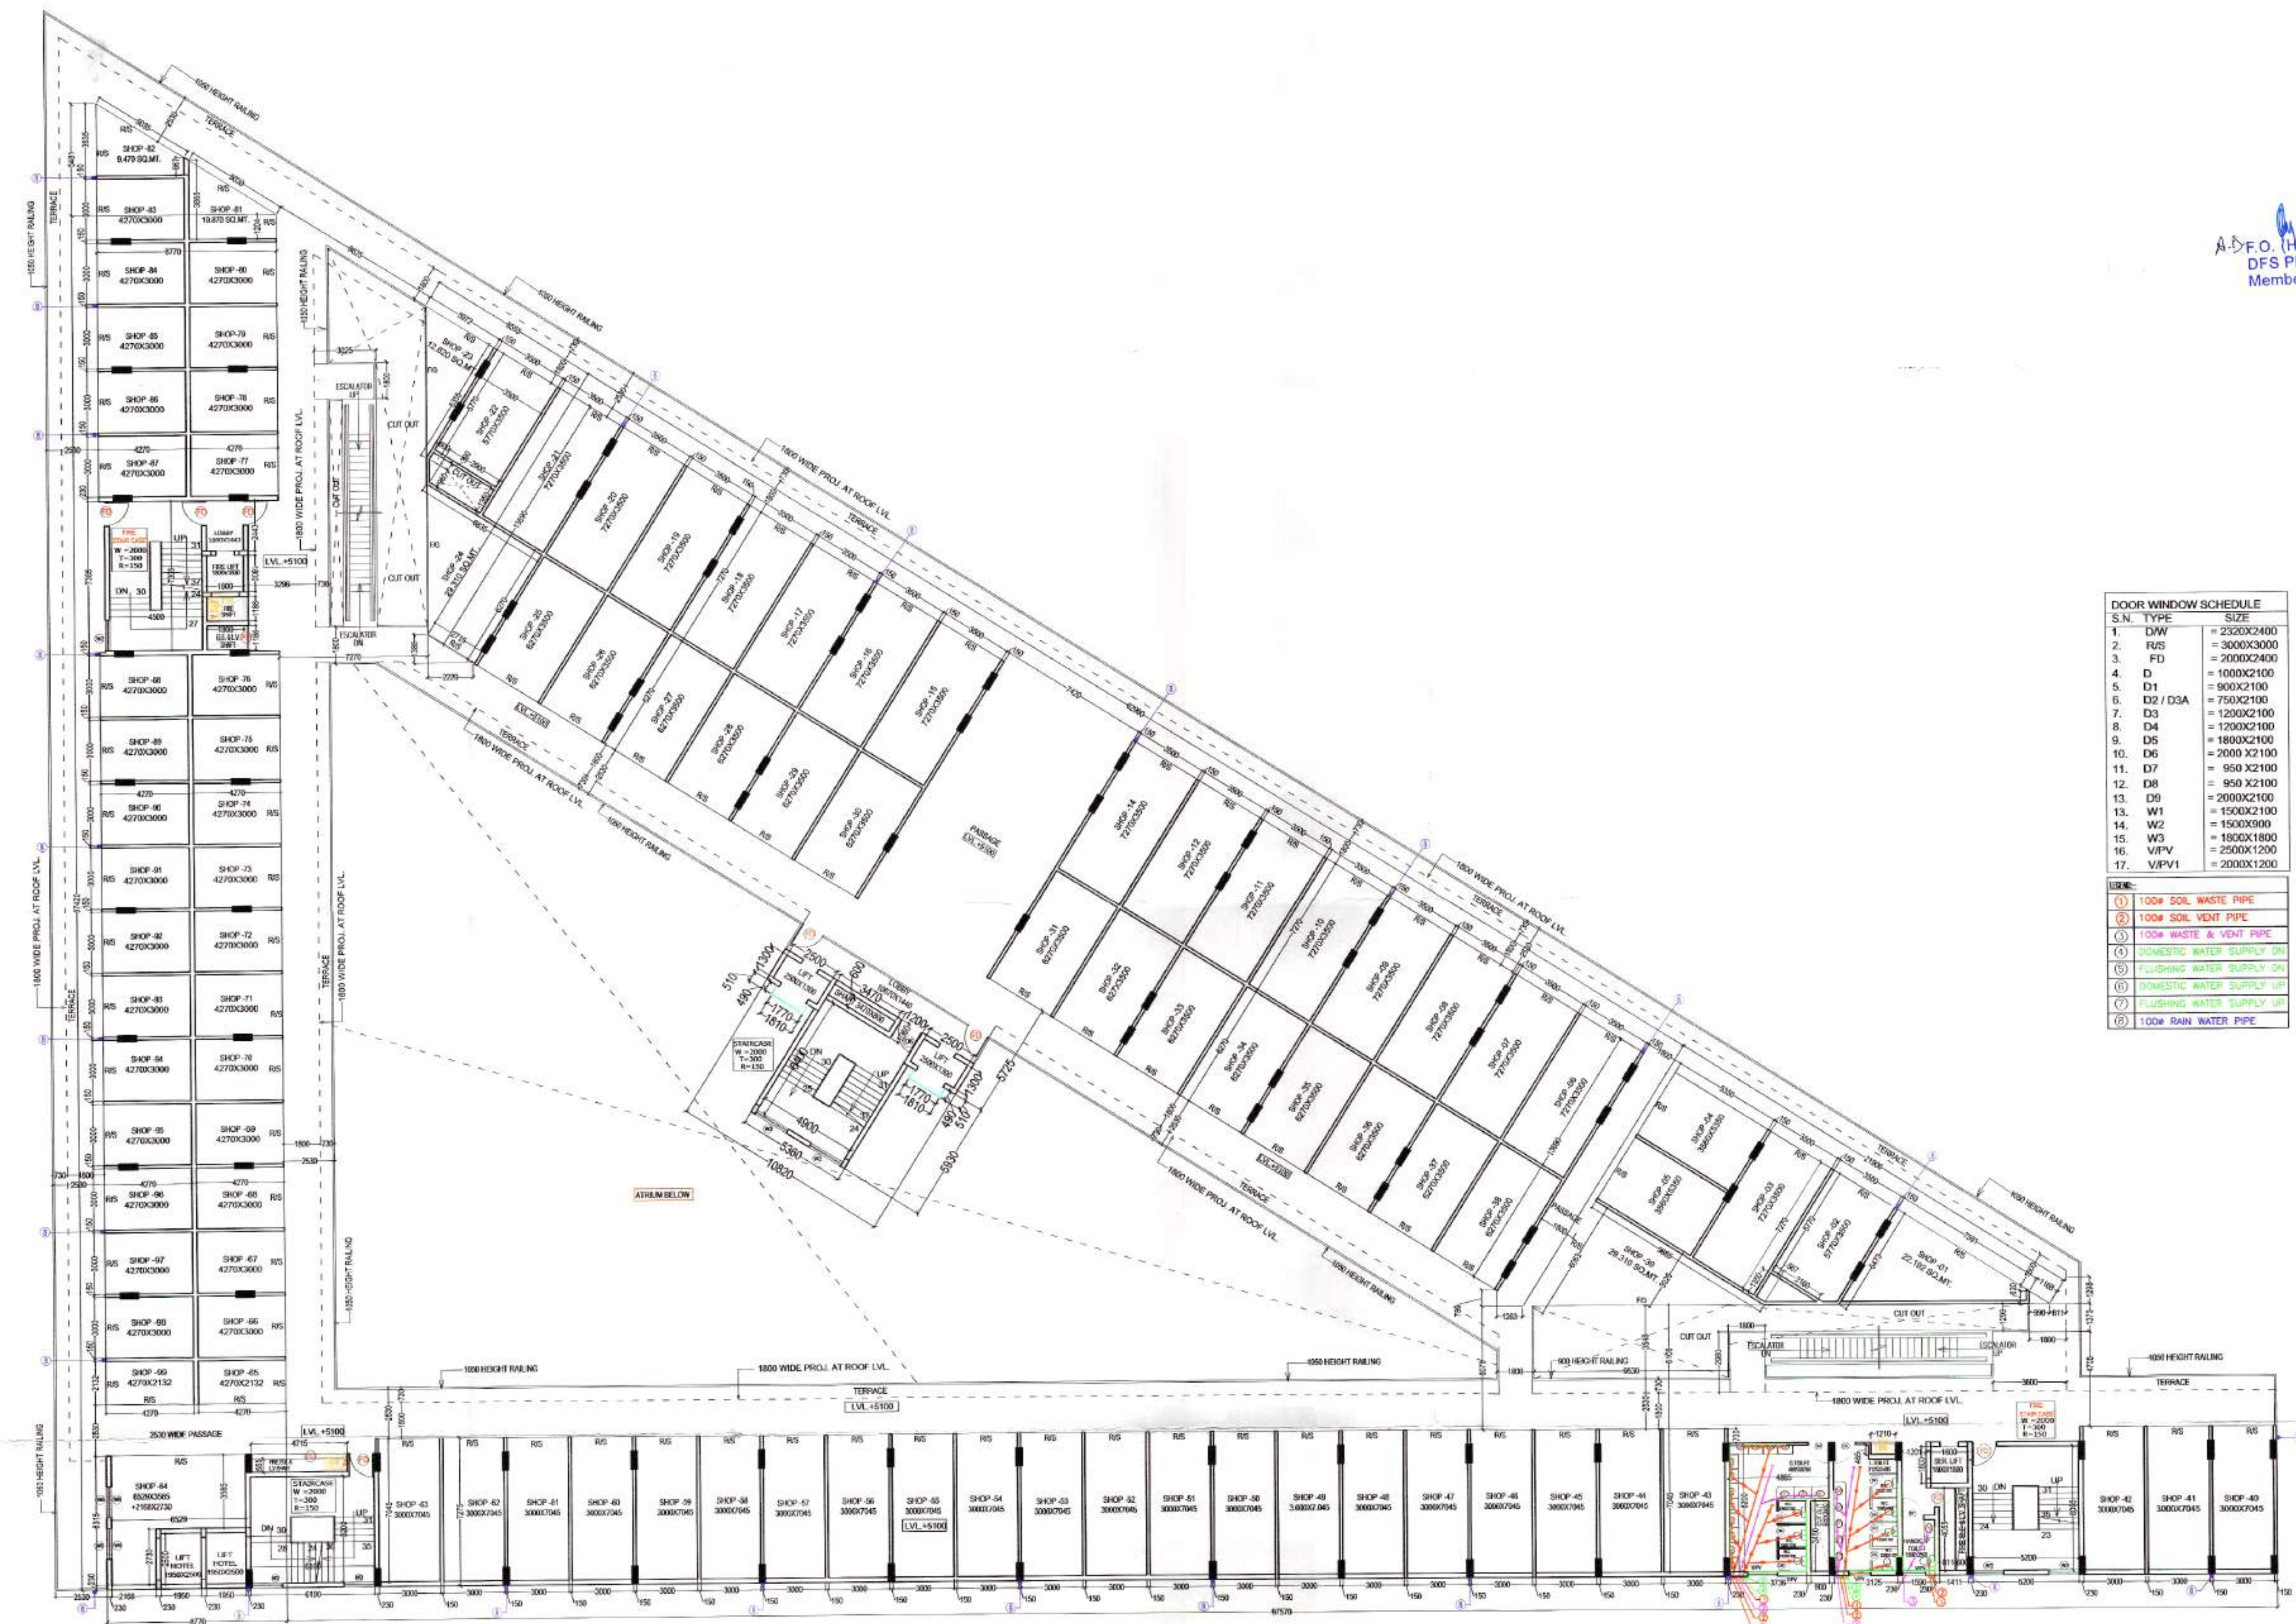

S.N.	TYPE	SIZE
1.	DW	= 2320X2400
2.	R/S	= 3000X3000
3.	FD	= 2000X2400
4.	D	= 1000X2100
5.	D1	= 900X2100
6.	D2 / D3A	= 750X2100
7.	D3	= 1200X2100
8.	D4	= 1200X2100
9.	D5	= 1800X2100
10.	D6	= 2000 X2100
11.	D7	= 950 X2100
12.	D8	= 950 X2100
13.	D9	= 2000X2100
14.	W1	= 1500X2100
15.	W2	= 1500X3000
16.	W3	= 1800X1800
17.	V/PV1	= 2500X1200
18.	V/PV1	= 2000X1200

LINE	DESCRIPTION
①	100mm SOIL WASTE PIPE
②	100mm SOIL VENT PIPE
③	100mm WASTE & VENT PIPE
④	DOMESTIC WATER SUPPLY DN
⑤	FLUSHING WATER SUPPLY DN
⑥	DOMESTIC WATER SUPPLY UP
⑦	FLUSHING WATER SUPPLY UP
⑧	100mm RAIN WATER PIPE


FIRST FLOOR PLAN

NOTE-
 1. ALL THE SHOPS WILL BE MECHANICALLY LIGHTED & VENTILATED
 2. MECHANICAL VENTILATION WILL BE PROVIDED FOR ATRIUM

PROJECT-
 REVISED BUILDING PLANS OF COMMERCIAL SITE
 MEASURING 2.0 ACRE
 (LICENCE NO. 56 OF 2007 DATED 23.01.2007) IN
 SECTOR-24, DHARUHERA, BEING DEVELOPED BY:
 M/S DWARKADHISH PROJECTS PVT. LTD.

DWG TITLE FIRST FLOOR PLAN		DRG. NO. A-09
SCALE 1:175	 Authorised Signatory	
Dwarkadish Projects Pvt. Ltd.  Authorised Signatory		 V. Jain ARCHITECT CAD/002/0278
SIG. OF OWNER		SIG. OF ARCHITECT

(RAM AVIRY BASSI) A.D. Checked and found for Public Health (Internal) Service 0. in forwarding letter. 39801. Di-28/1/18
 S.D. (BALWANT SINGH) ATP
 Superintending Engineer (HQ) IUUDA, Panchnala. 29/1/18
 A.D.F.O. (HQ) DFS P.K.L. Member B.P.C.

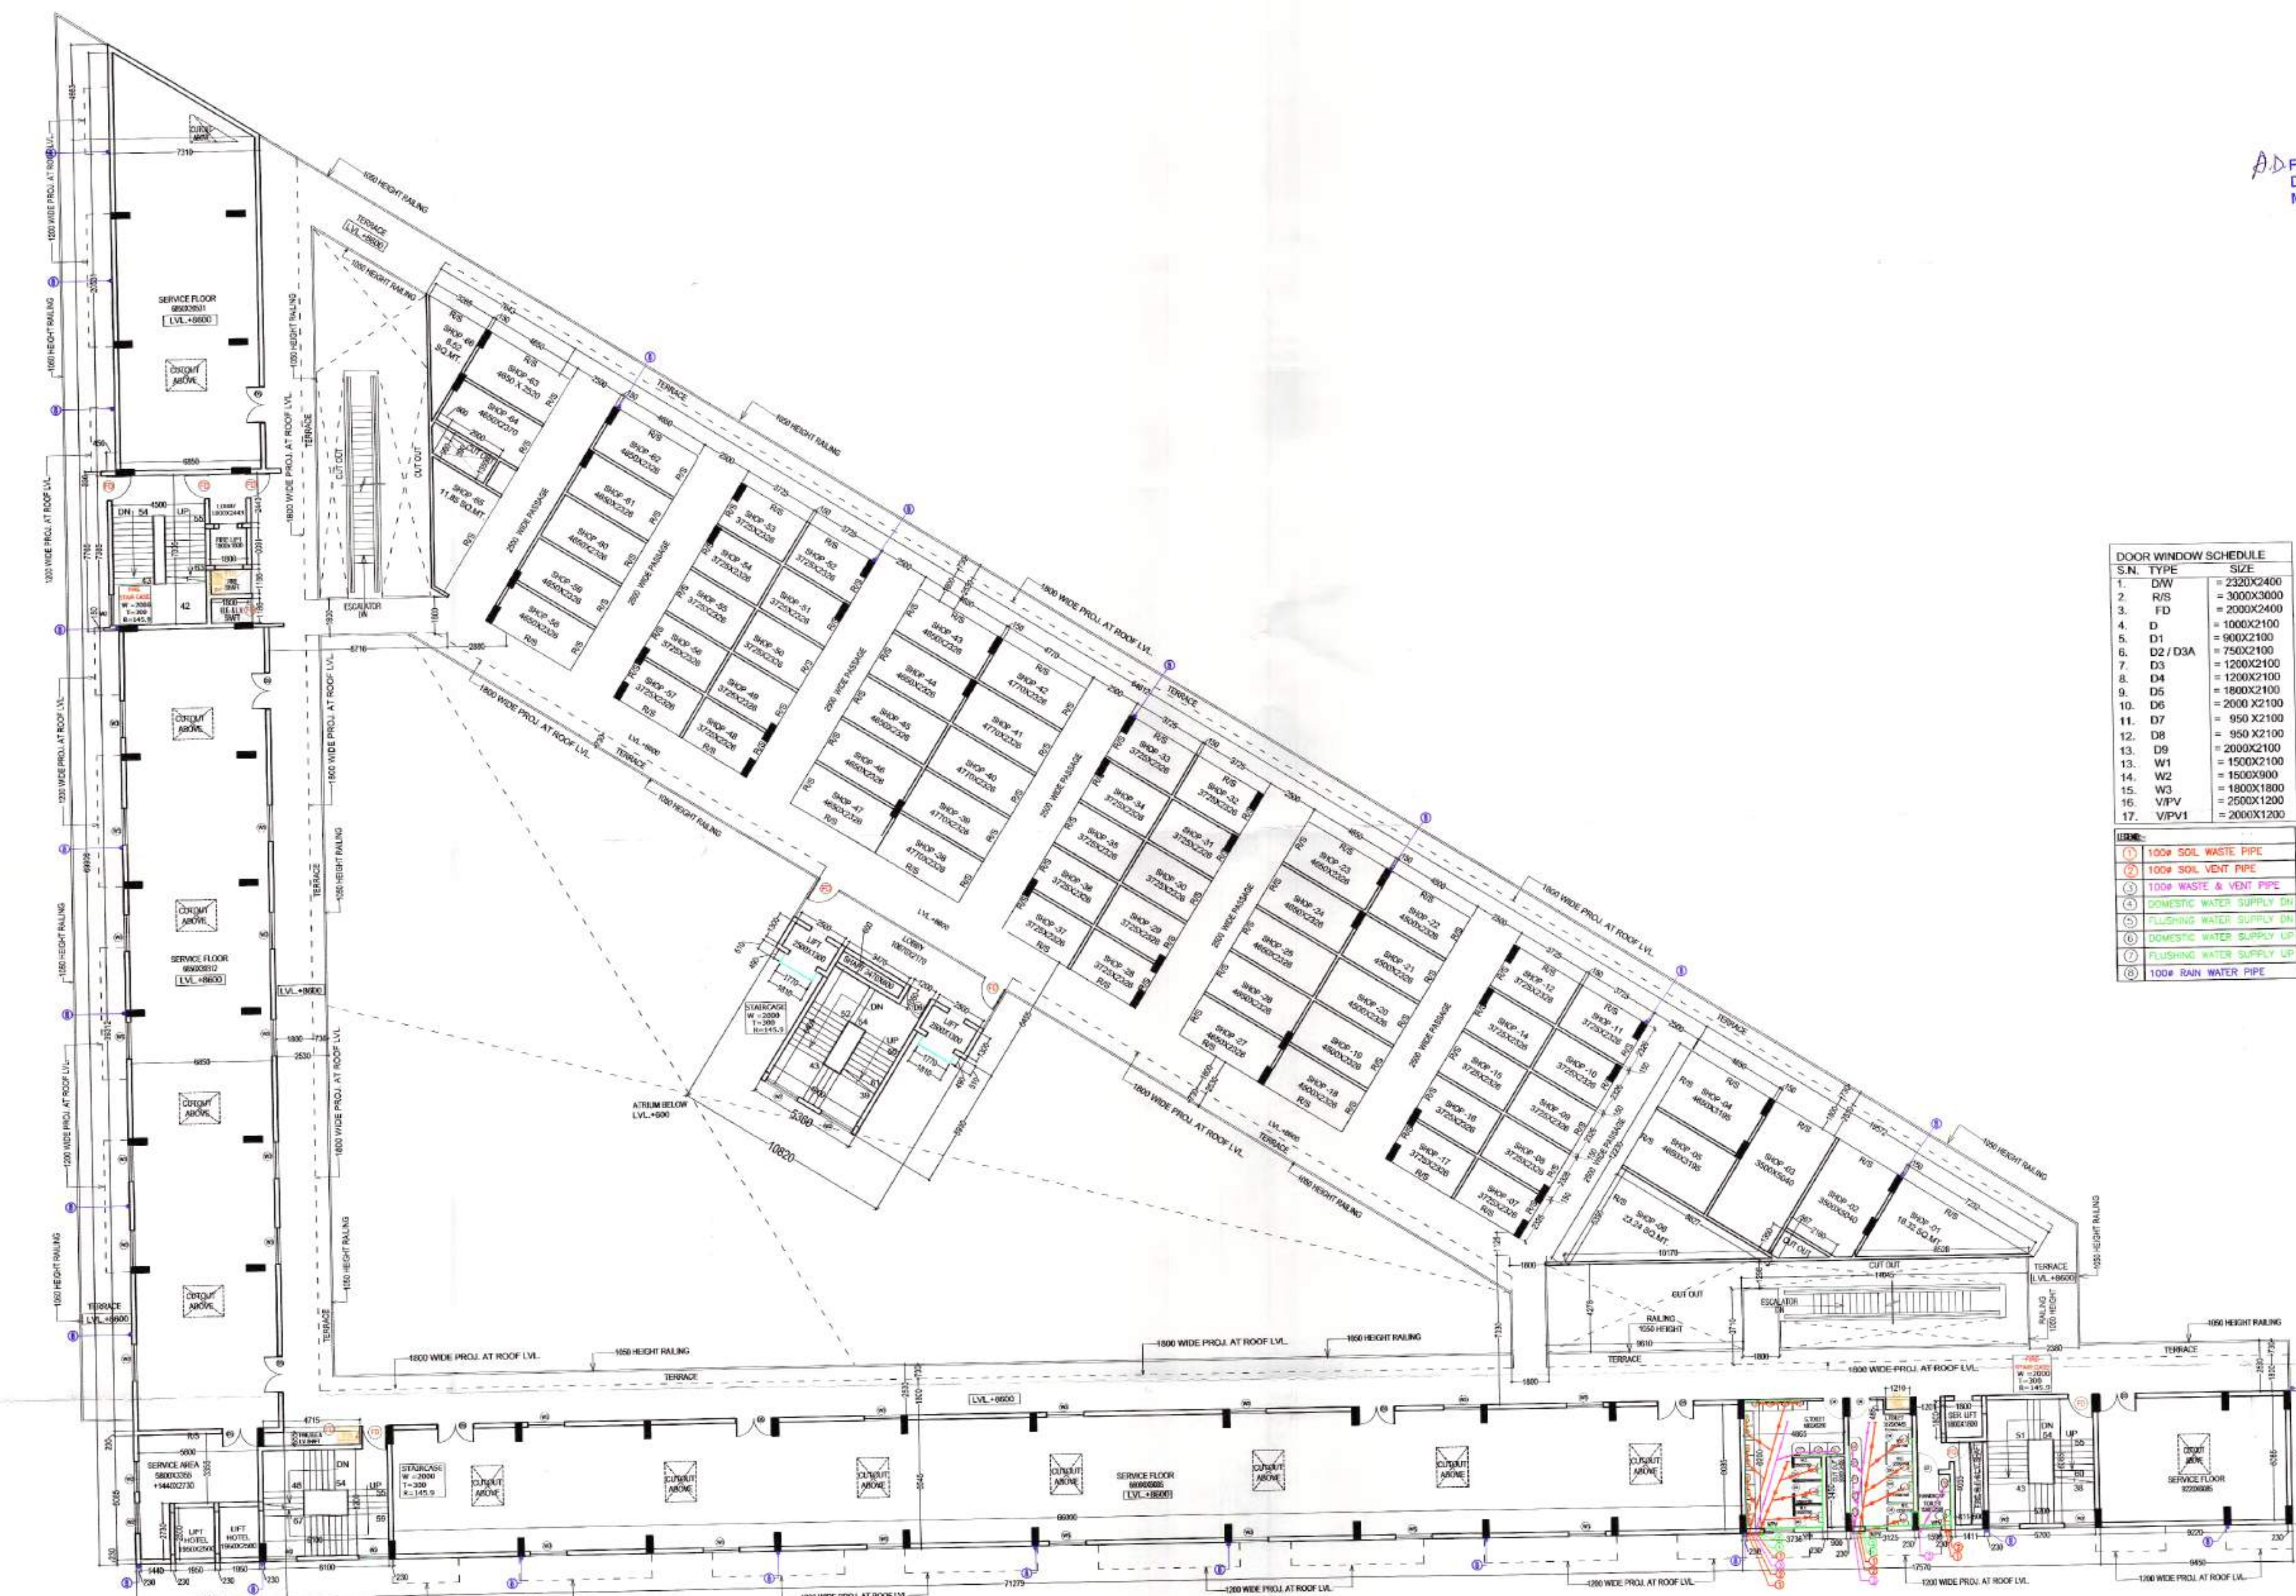

DOOR WINDOW SCHEDULE

S.N.	TYPE	SIZE
1.	DW	= 2320X2400
2.	R/S	= 3000X3000
3.	FD	= 2000X2400
4.	D	= 1000X2100
5.	D1	= 900X2100
6.	D2 / D3A	= 750X2100
7.	D3	= 1200X2100
8.	D4	= 1200X2100
9.	D5	= 1800X2100
10.	D6	= 2000 X2100
11.	D7	= 950 X2100
12.	D8	= 850 X2100
13.	D9	= 2000X2100
13.	W1	= 1500X2100
14.	W2	= 1500X900
15.	W3	= 1800X1800
16.	VPV	= 2500X1200
17.	VPV1	= 2000X1200

LEGEND:

- ① 100# SOL WASTE PIPE
- ② 100# SOL VENT PIPE
- ③ 100# WASTE & VENT PIPE
- ④ DOMESTIC WATER SUPPLY DN
- ⑤ FLUSHING WATER SUPPLY DN
- ⑥ DOMESTIC WATER SUPPLY UP
- ⑦ FLUSHING WATER SUPPLY UP
- ⑧ 100# RAIN WATER PIPE

2ND FLOOR PLAN

NOTE-
 1. ALL THE SHOPS WILL BE MECHANICALLY LIGHTED & VENTILATED
 2. MECHANICAL VENTILATION WILL BE PROVIDED FOR ATRIUM

PROJECT-
 REVISED BUILDING PLANS OF COMMERCIAL SITE
 MEASURING 2.0 ACRE
 (LICENCE NO. 56 OF 2007 DATED 23.01.2007) IN
 SECTOR-24, DHARUHERA, BEING DEVELOPED BY:
 M/S DWARKADHISH PROJECTS PVT. LTD.

DWG. TITLE
 SECOND FLOOR PLAN

SCALE 1:175

DRG. NO. A-10

Dworkadish Projects Pvt. Ltd.
 U. Jain
 Authorised Signatory

SIG. OF OWNER

SATYA PARRAKSHI SHARMA
 ARCHITECT
 CA/2000/20278
 SIG. OF ARCHITECT



DOOR WINDOW SCHEDULE

S.N.	TYPE	SIZE
1.	DW	= 2320X2400
2.	R/S	= 3000X3000
3.	FD	= 2000X2400
4.	D	= 1000X2100
5.	D1	= 900X2100
6.	D2 / D3A	= 750X2100
7.	D3	= 1200X2100
8.	D4	= 1200X2100
9.	D5	= 1800X2100
10.	D6	= 2000 X2100
11.	D7	= 950 X2100
12.	D8	= 950 X2100
13.	D9	= 2000X2100
13.	W1	= 1500X2100
14.	W2	= 1500X3000
15.	W3	= 1800X1800
16.	VIPV	= 2500X1200
17.	VIPV1	= 2000X1200

LEGEND:

- (1) 100# SOIL WASTE PIPE
- (2) 100# SOIL VENT PIPE
- (3) 100# WASTE & VENT PIPE
- (4) DOMESTIC WATER SUPPLY DN
- (5) FLUSHING WATER SUPPLY DN
- (6) DOMESTIC WATER SUPPLY UP
- (7) FLUSHING WATER SUPPLY UP
- (8) 100# RAIN WATER PIPE

Checked and found ok for Public Use
(Internal) Service only subject to comments in forwarding letter No. SE/HQ/.....Dt.28.12.18
28/12/18

(RAJAVANTAR BASSI) A.D.
(BALWANT SINGH) S.D.

A-D.F.O. (HQ) DFS PKL. Member B.P.C.
Superintending Engineer (HQ) HUDA, Panchkula

3RDFLOOR PLAN

NOTE-
1. ALL THE SHOPS WILL BE MECHANICALLY LIGHTED & VENTILATED
2. MECHANICAL VENTILATION WILL BE PROVIDED FOR ATRIUM

PROJECT-
REVISED BUILDING PLANS OF COMMERCIAL SITE
MEASURING 2.0 ACRE
(LICENCE NO. 56 OF 2007 DATED 23.01.2007) IN
SECTOR-24, DHARUHERA, BEING DEVELOPED BY
M/S DWARKADHISH PROJECTS PVT. LTD.

DWG. TITLE
THIRD FLOOR PLAN

SCALE 1:175

DRG. NO. A-11

Dwarkadhish Projects Pvt. Ltd.
V. Jain
Authorised Signatory

SIG. OF OWNER

SATYA PRAKASH SHARMA
ARCHITECT
GASID0002078

SIG. OF ARCHITECT

Checked and found ok for Public Health (Internal) Service only subject to comments in forwarding letter No. SE/HQ/.../2018/118
 3/8/2018
 Superintending Engineer (HO) HUDA, Panipat.
 (BALWANT SINGH) S.D.
 A.D. (ATK BASSI)
 Member Secretary EPC
 S.T.P. Officer EPC
 C.T.P. Officer EPC
 A.T.P.

A.D.F.O. (HQ) DFS PKL Member B.P.C.



S.N.	TYPE	SIZE
1.	DW	= 2320X2400
2.	R/S	= 3000X3000
3.	FD	= 2000X2400
4.	D	= 1800X2100
5.	D1	= 900X2100
6.	D2 / D3A	= 750X2100
7.	D3	= 1200X2100
8.	D4	= 1200X2100
9.	D5	= 1800X2100
10.	D6	= 2000 X2100
11.	D7	= 950 X2100
12.	D8	= 950 X2100
13.	D9	= 2000X2100
14.	W1	= 1500X2100
15.	W2	= 1500X900
16.	V/PV	= 2500X1200
17.	V/PV1	= 2000X1200

Legend	
①	100# SOIL WASTE PIPE
②	100# SOIL VENT PIPE
③	100# WASTE & VENT PIPE
④	DOMESTIC WATER SUPPLY DN
⑤	FLUSHING WATER SUPPLY DN
⑥	DOMESTIC WATER SUPPLY UP
⑦	FLUSHING WATER SUPPLY UP
⑧	100# RAIN WATER PIPE

4TH FLOOR PLAN

NOTE-
 1. ALL THE SHOPS WILL BE MECHANICALLY LIGHTED & VENTILATED
 2. MECHANICAL VENTILATION WILL BE PROVIDED FOR ATRIUM

PROJECT-
 REVISED BUILDING PLANS OF COMMERCIAL SITE MEASURING 2.0 ACRE (LICENCE NO. 56 OF 2007 DATED 23.01.2007) IN SECTOR-24, DHARUHERA, BEING DEVELOPED BY: M/S DWARKADHISH PROJECTS PVT. LTD.

DRWG. TITLE
 FOURTH FLOOR PLAN
 SCALE 1:175
 DRG. NO. A-12
 DWARKADHISH PROJECTS PVT. LTD.
 U. Jain
 Authorised Signatory
 SIG. OF OWNER
 SUDH PAKASH SHARMA ARCHITECT CA/1005/20278
 SIG. OF ARCHITECT

(RAM AVTAR BASSI) A.D.
 Checked and found ok for Public Health
 (Internal Service only subject to comments in
 in forwarding letter No. SE(HO) 3750/2514/18
 Superintending Engineer (HO)
 HUDA, Faridkot
 29/3/18

A.D. F.O. (HO)
 DFS PKL
 Member B.P.C.



S.N.	TYPE	SIZE
1.	D/W	= 2320X2400
2.	R/S	= 3000X3000
3.	FD	= 2000X2400
4.	D	= 1000X2100
5.	D1	= 900X2100
6.	D2 / D3A	= 750X2100
7.	D3	= 1200X2100
8.	D4	= 1200X2100
9.	D5	= 1800X2100
10.	D6	= 2000 X2100
11.	D7	= 950 X2100
12.	D8	= 850 X2100
13.	D9	= 2000X2100
14.	W1	= 1500X2100
15.	W2	= 1500X3000
16.	W3	= 1800X1800
17.	VI/PV	= 2500X1200
18.	VI/PV1	= 2000X1200

SYMBOL	DESCRIPTION
①	100# SOIL WASTE PIPE
②	100# SOIL VENT PIPE
③	100# WASTE & VENT PIPE
④	DOMESTIC WATER SUPPLY DN
⑤	FLUSHING WATER SUPPLY DN
⑥	DOMESTIC WATER SUPPLY UP
⑦	FLUSHING WATER SUPPLY UP
⑧	100# RAIN WATER PIPE

5TH FLOOR PLAN


NOTE:
 1. ALL THE SHOPS WILL BE MECHANICALLY LIGHTED & VENTILATED
 2. MECHANICAL VENTILATION WILL BE PROVIDED FOR ATRIUM

PROJECT:
 REVISED BUILDING PLANS OF COMMERCIAL SITE
 MEASURING 2.0 ACRE
 (LICENCE NO. 56 OF 2007 DATED 23.01.2007) IN
 SECTOR-24, DHARUHERA, BEING DEVELOPED BY
 M/S DWARKADHISH PROJECTS PVT. LTD.

DWG. TITLE FIFTH FLOOR PLAN	
SCALE 1:175	DRG. NO. A-13
Dwarakadhis Projects Pvt. Ltd. <i>V. Jain</i> Authorised Signatory	
SIG. OF OWNER	SIG. OF ARCHITECT

H.P. (H.O.)
 Member Secretary
 B.P.C.
 J.D.
 Member
 B.P.C.
 C.T.P.H.
 Chairman
 B.P.C.
 A.P.
 (RAM BASSI) A.D.
 (BALWANT SINGH) S.D.
 Checked and found ok for Public Health
 (Internal Service only subject to comments in
 forwarding letter No. SE/HQ/3501/Dt.2.11.18
 Superintending Engineer (HO)
 HUDA, Panchkula
 22/11/18

A.D. F.O. (H.O.)
 DFS PKL.
 Member B.P.C.

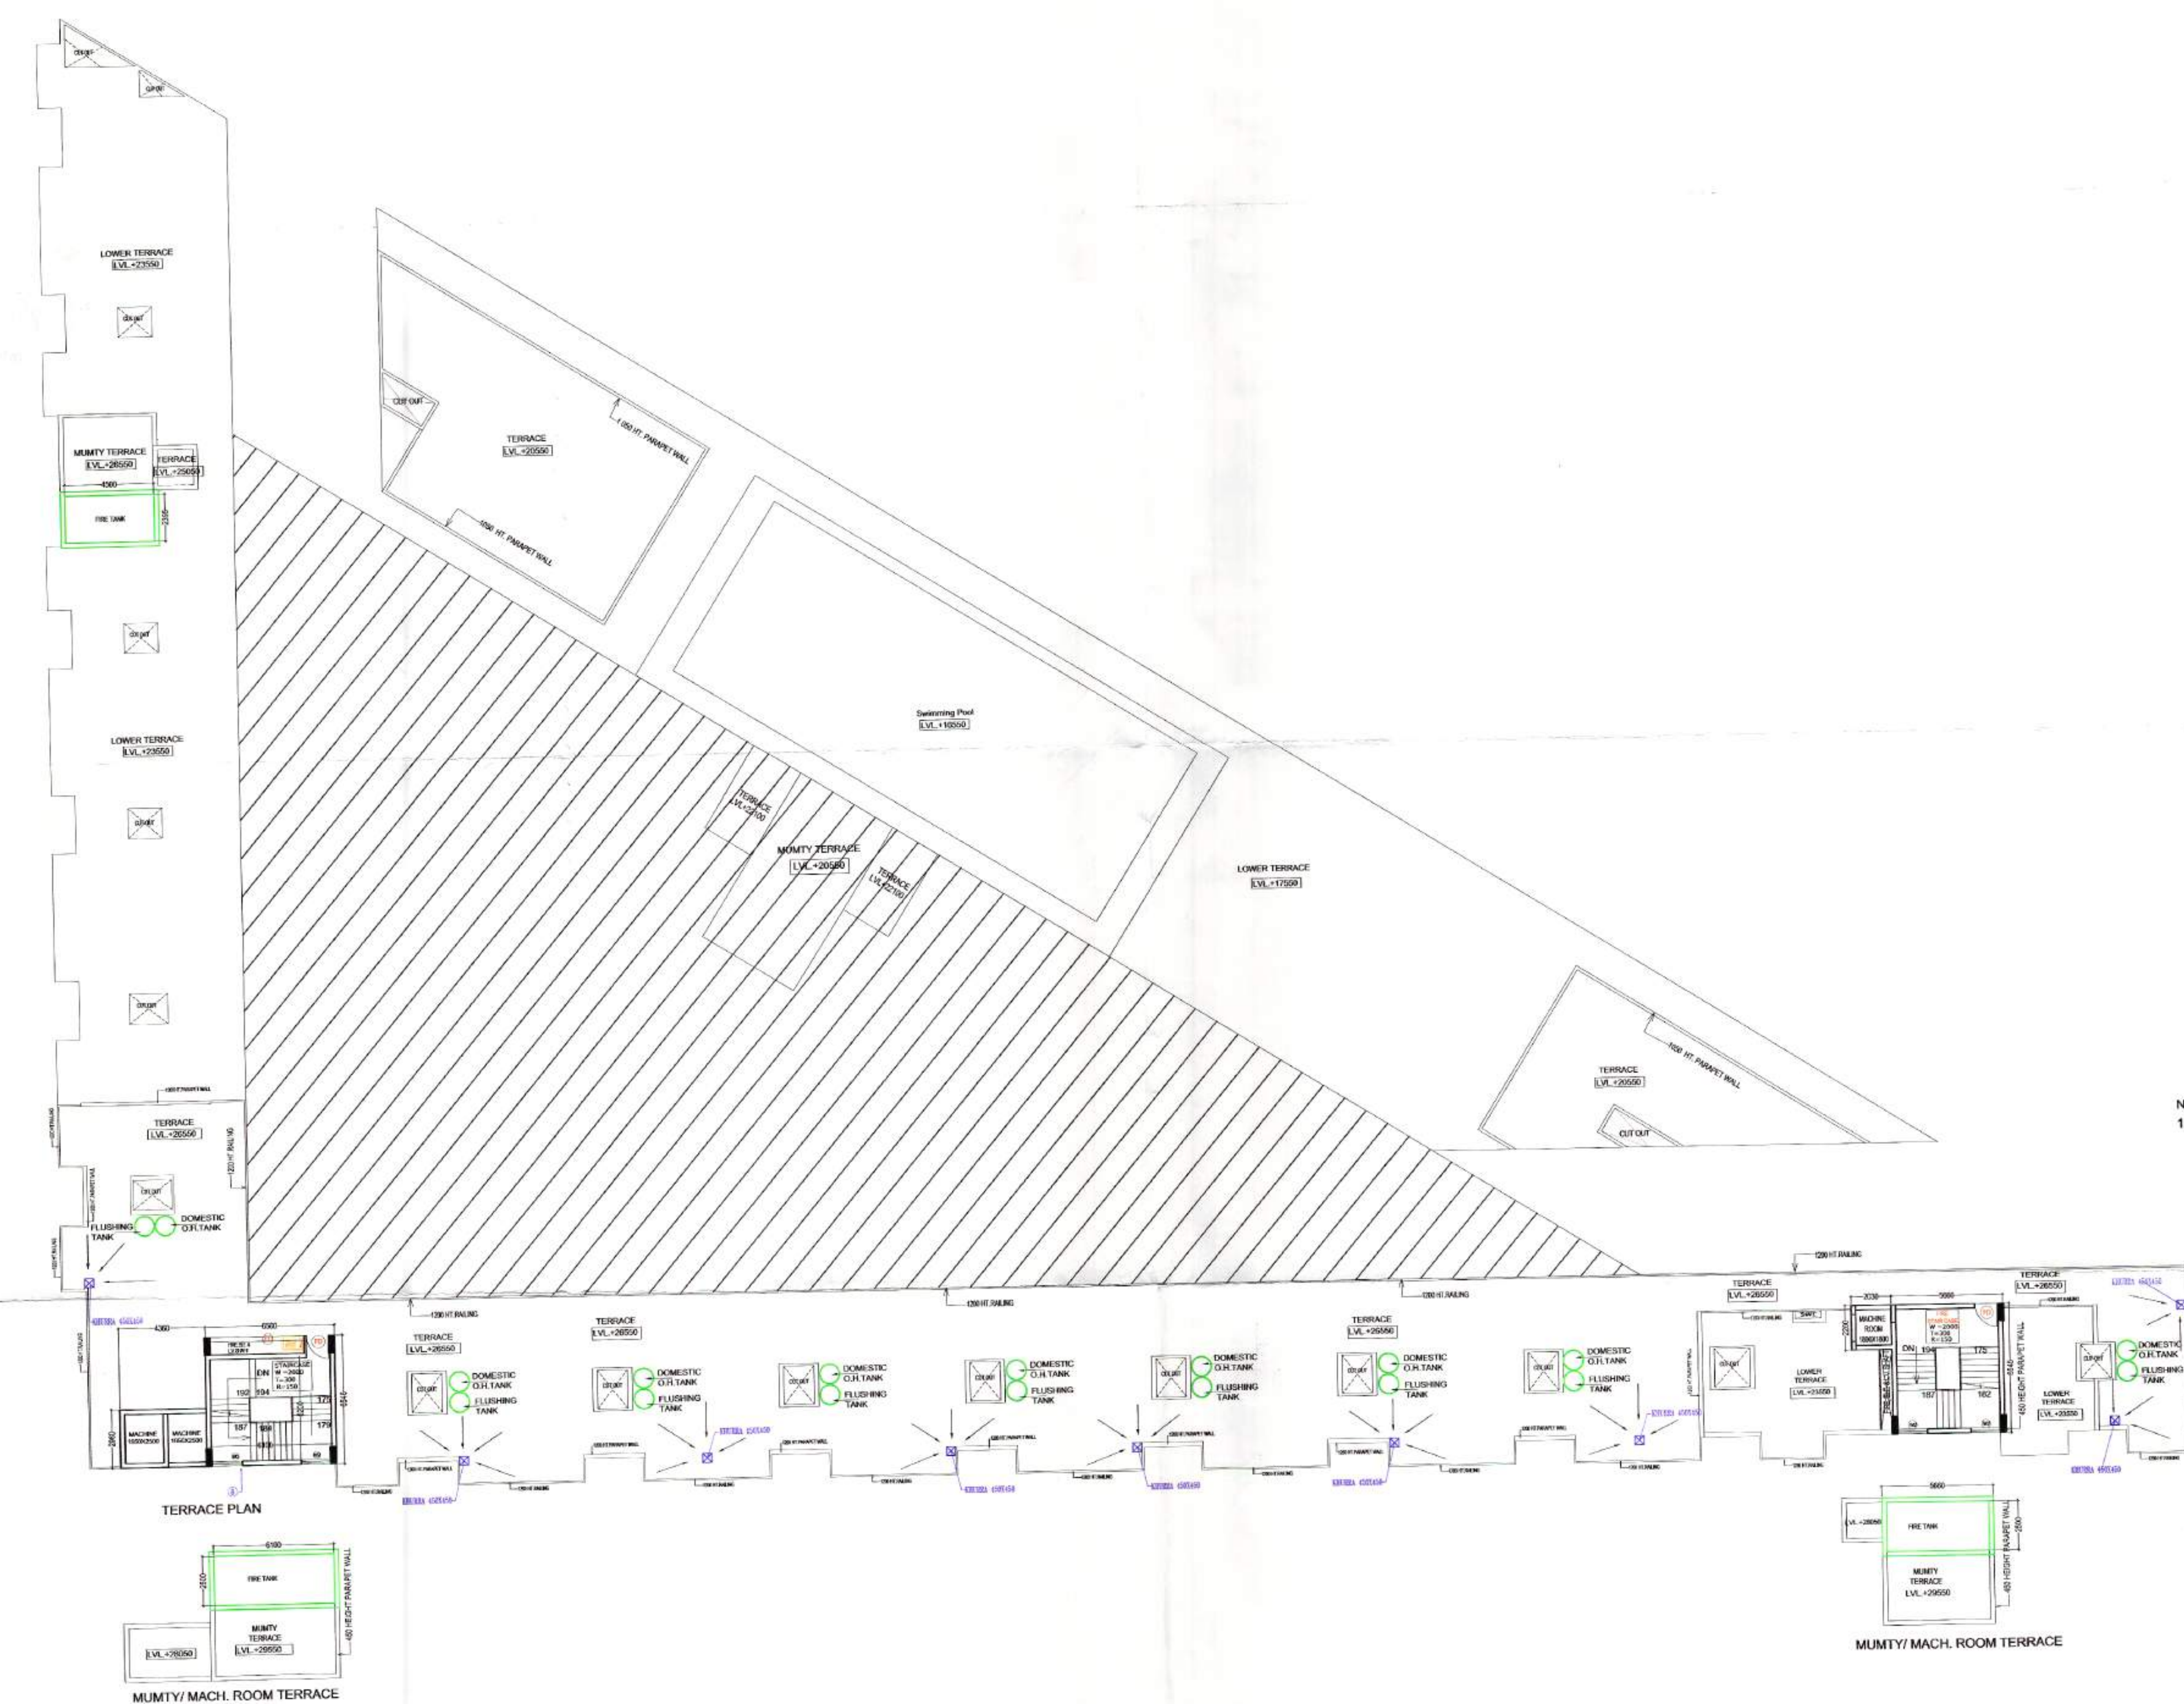

DOOR WINDOW SCHEDULE

S.N.	TYPE	SIZE
1.	DW	= 2320X2400
2.	R/S	= 3000X3000
3.	FD	= 2000X2400
4.	D	= 1000X2100
5.	D1	= 900X2100
6.	D2 / D3A	= 750X2100
7.	D3	= 1200X2100
8.	D4	= 1200X2100
9.	D5	= 1600X2100
10.	D6	= 2000 X2100
11.	D7	= 950 X2100
12.	D8	= 950 X2100
13.	D9	= 2000X2100
13.	W1	= 1500X2100
14.	W2	= 1500X3000
15.	W3	= 1800X1800
16.	V/PV	= 2500X1200
17.	V/PV1	= 2000X1200

LEGEND:


- ① 100# SOIL WASTE PIPE
- ② 100# SOIL VENT PIPE
- ③ 100# WASTE & VENT PIPE
- ④ DOMESTIC WATER SUPPLY DN
- ⑤ FLUSHING WATER SUPPLY DN
- ⑥ DOMESTIC WATER SUPPLY UP
- ⑦ FLUSHING WATER SUPPLY UP
- ⑧ 100# RAIN WATER PIPE

NOTE-
1. MECHANICAL VENTILATION WILL BE PROVIDED FOR ATRIUM


PROJECT-
 REVISED BUILDING PLANS OF COMMERCIAL SITE
 MEASURING 2.0 ACRE
 (LICENCE NO. 56 OF 2007 DATED 23.01.2007) IN
 SECTOR-24, DHARUHERA, BEING DEVELOPED BY.
 M/S DWARKADHISH PROJECTS PVT. LTD.

DWG TITLE
TERRACE PLAN
 SCALE 1:175
 DRG. NO. A-16
 Dwarkadish Projects Pvt. Ltd.
 U. Jau
 Authorised Signatory
 SIG. OF OWNER
 SIG. OF ARCHITECT



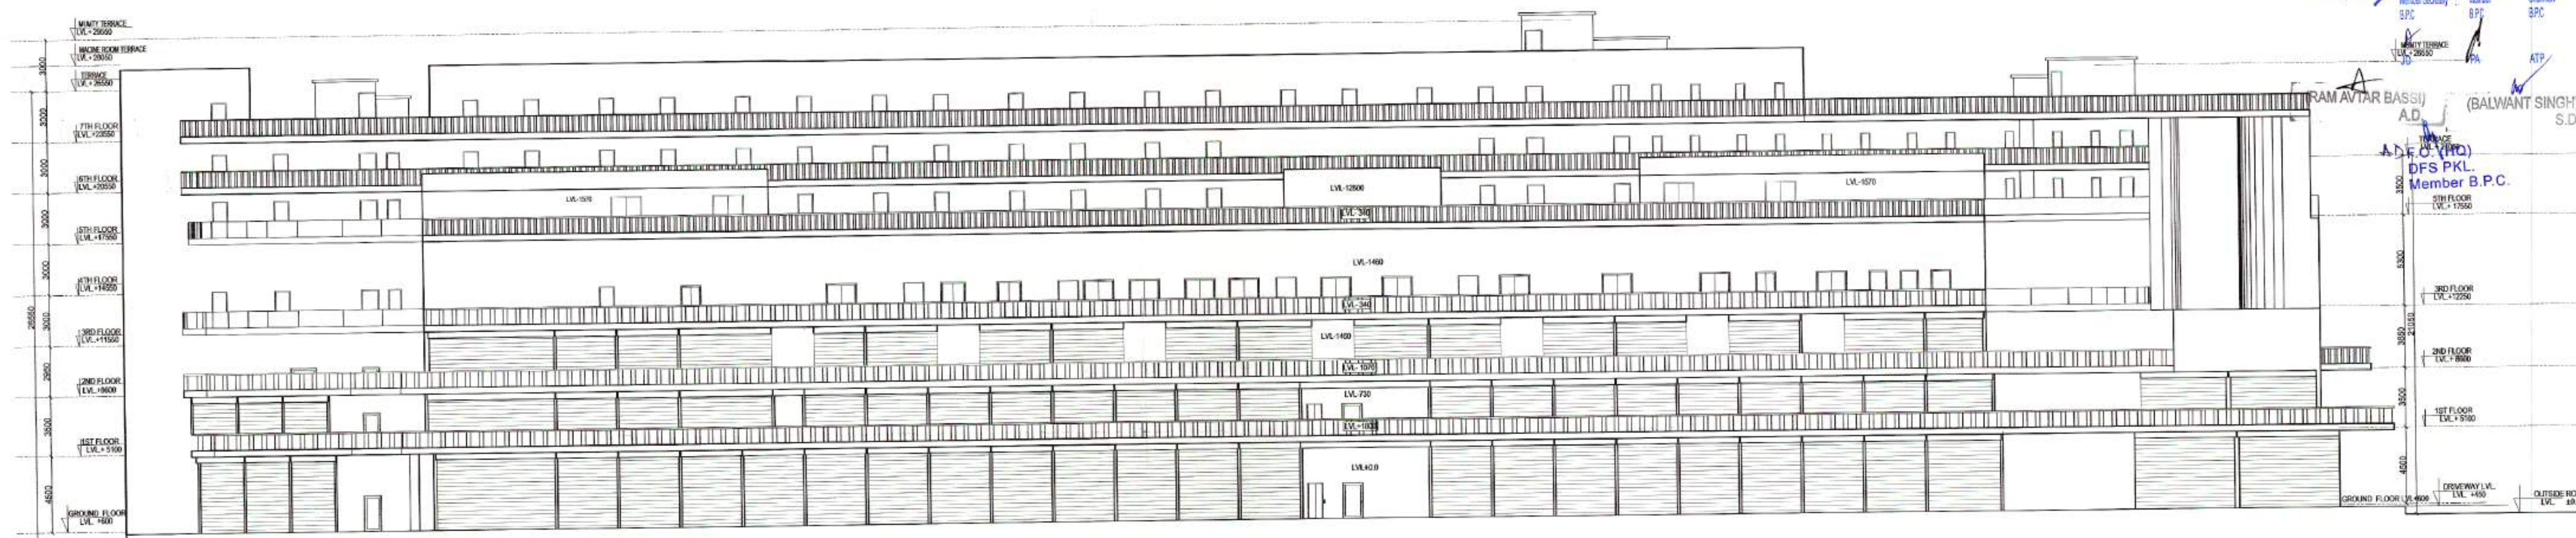

ELEVATION-1

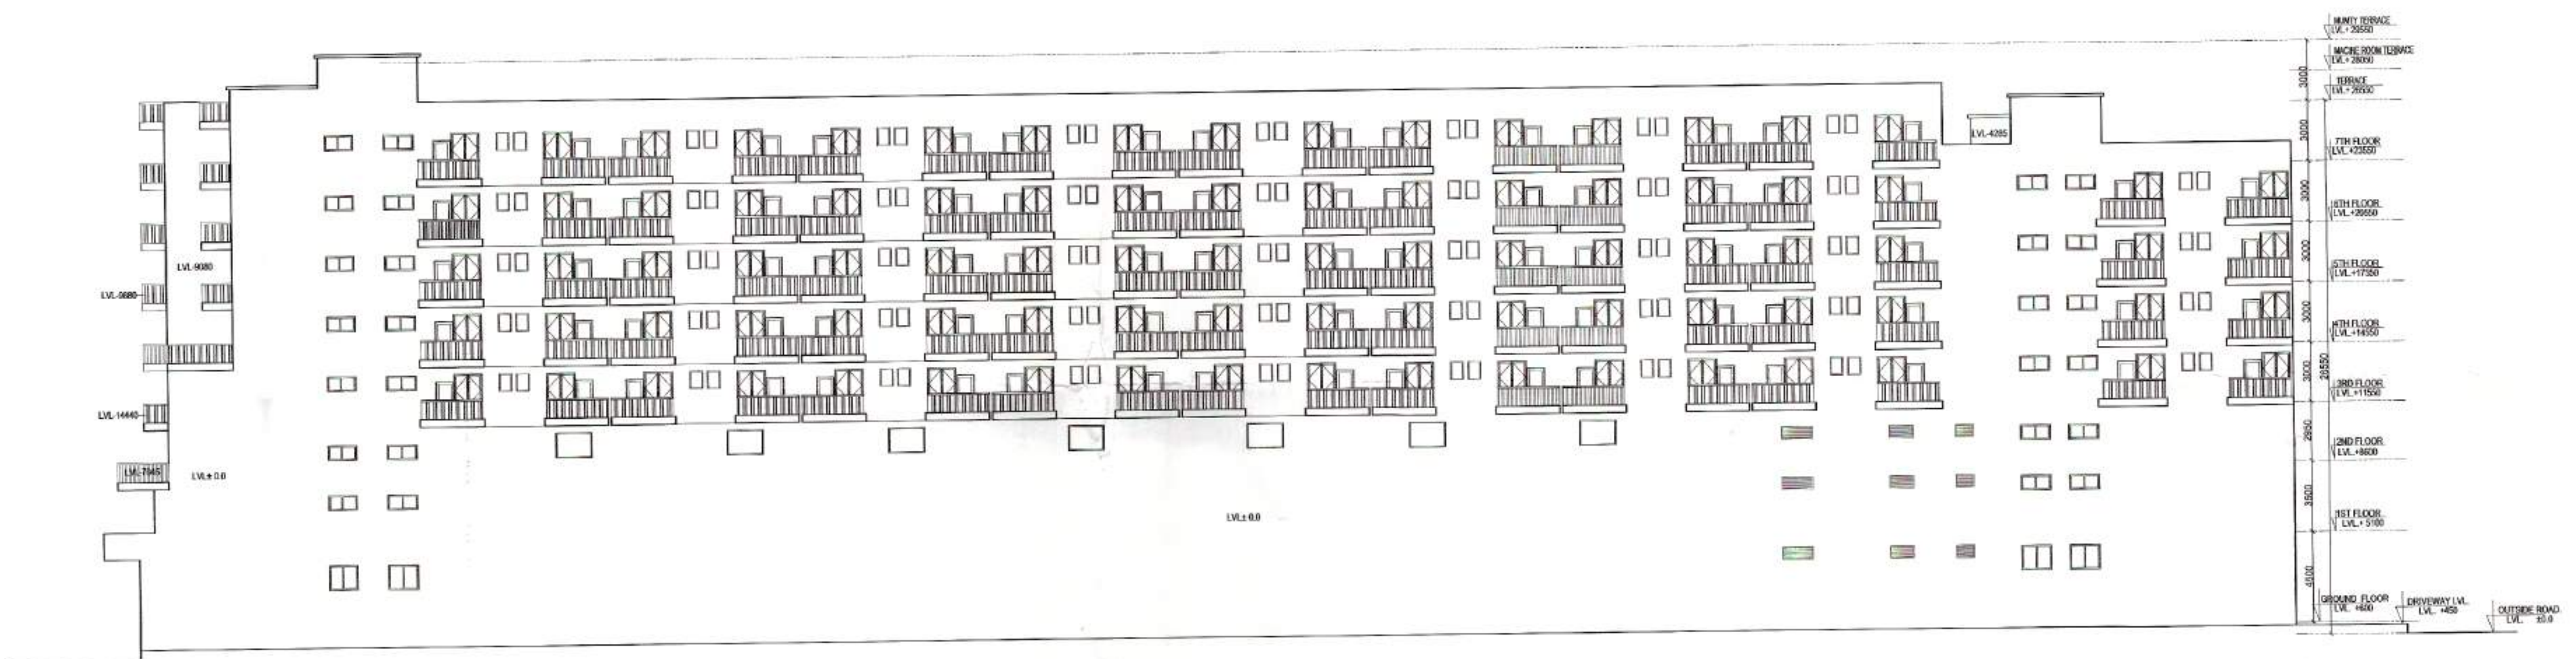

ELEVATION AT 3



ELEVATION-2

RAM AVTAR BASSI (BALWANT SINGH) S.D.
 Member Secretary
 Member B.P.C.
 Member B.P.C.

PROJECT: REVISED BUILDING PLANS OF COMMERCIAL SITE MEASURING 2.0 ACRE (LICENCE NO. 56 OF 2007 DATED 23.01.2007) IN SECTOR-24, DHARUHERA, BEING DEVELOPED BY M/S DWARKADHISH PROJECTS PVT. LTD.

DWG. TITLE: ELEVATIONS


DWG. NO. A-17

Dwarkadhish Projects Pvt. Ltd.
 U. Jain
 Authorised Signatory


SATYA PARAGSHI
 ARCHITECT
 CA/09/02/0719

SIG. OF OWNER
 SIG. OF ARCHITECT


(RAM AVTAR BASSI) A.D.
 (BALWANT SINGH) S.D.
 D.F.O. (HO) DFS PKL Member B.P.C.

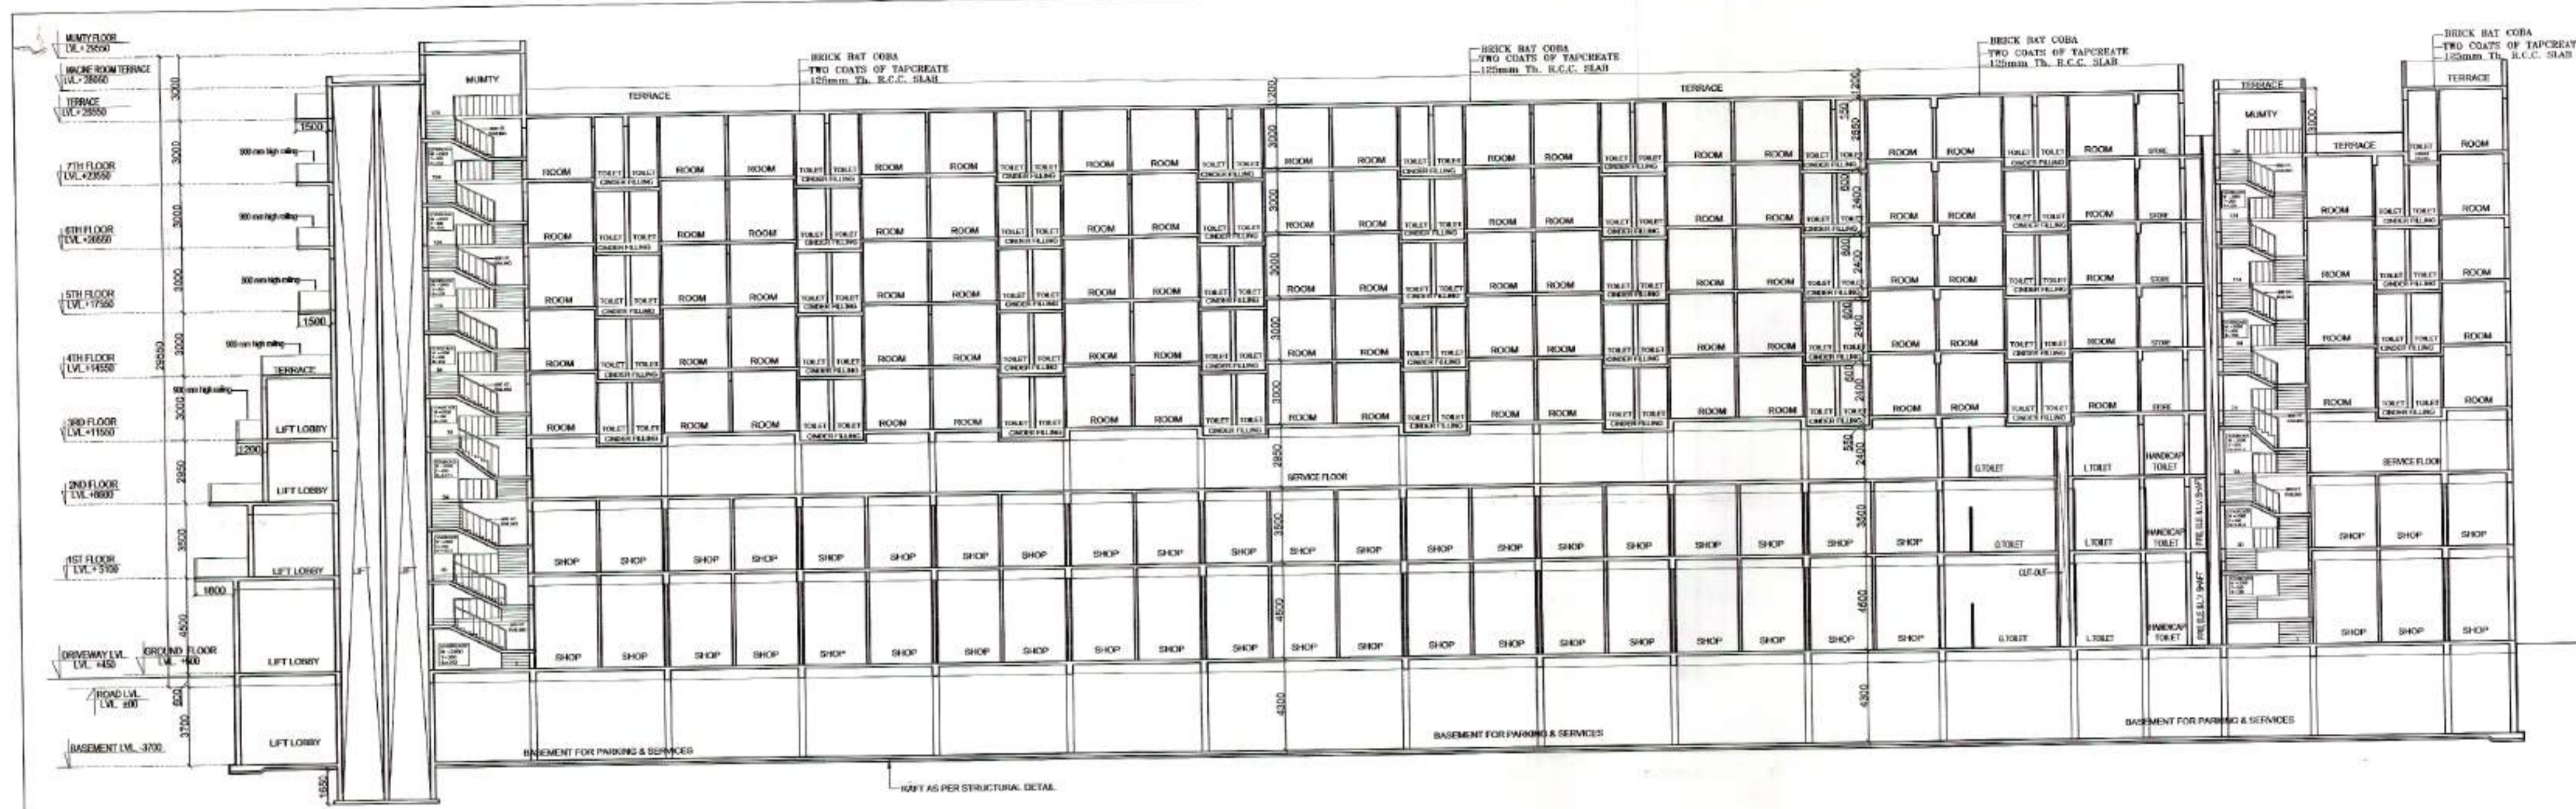


SECTION-AA

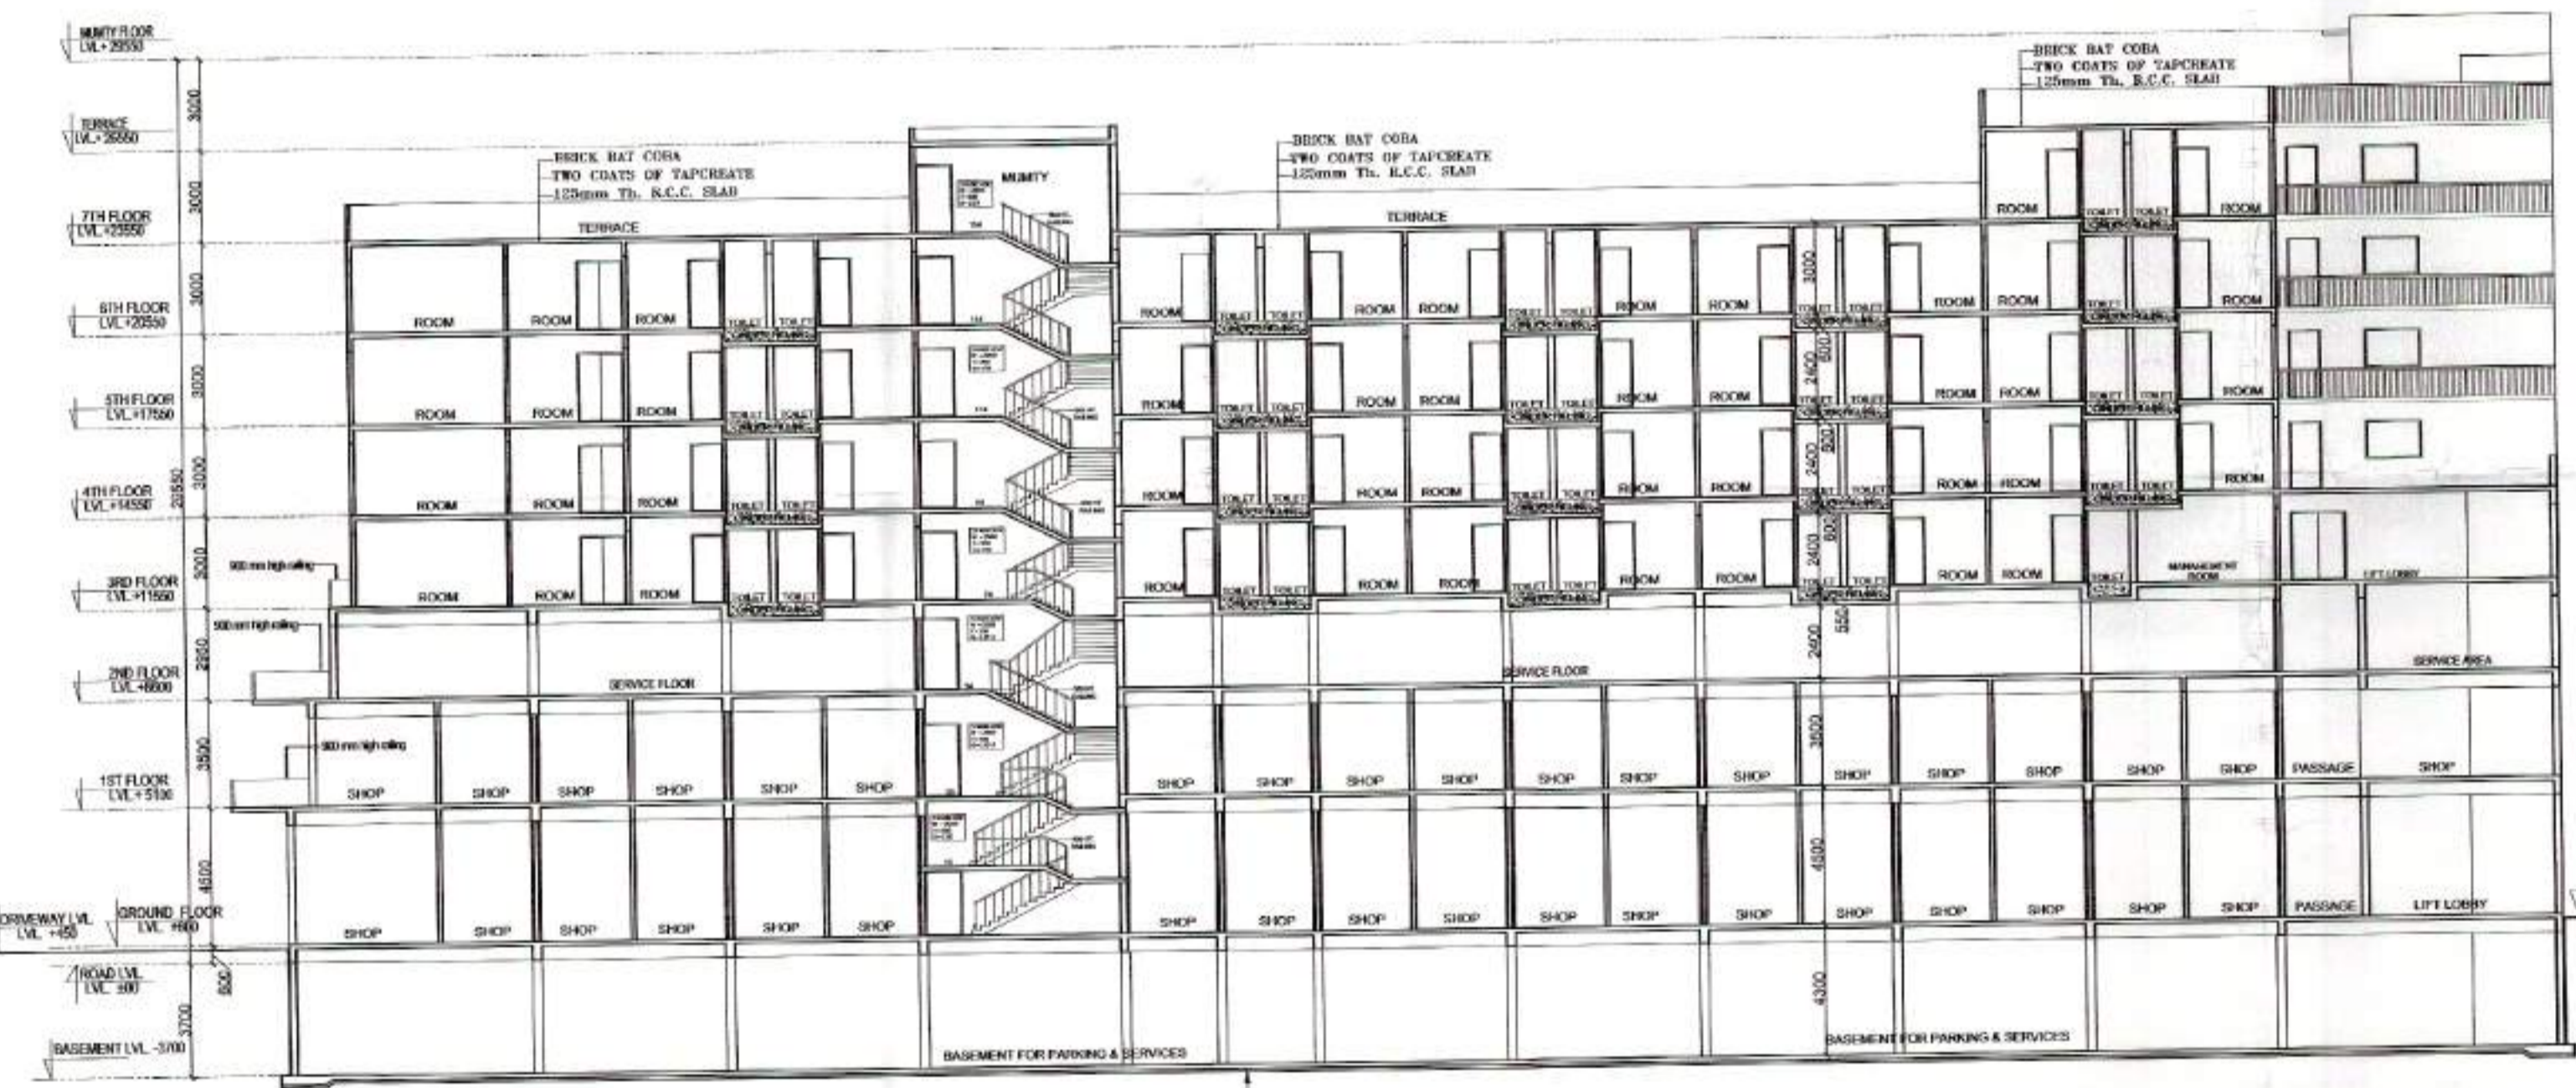

SECTION-BB

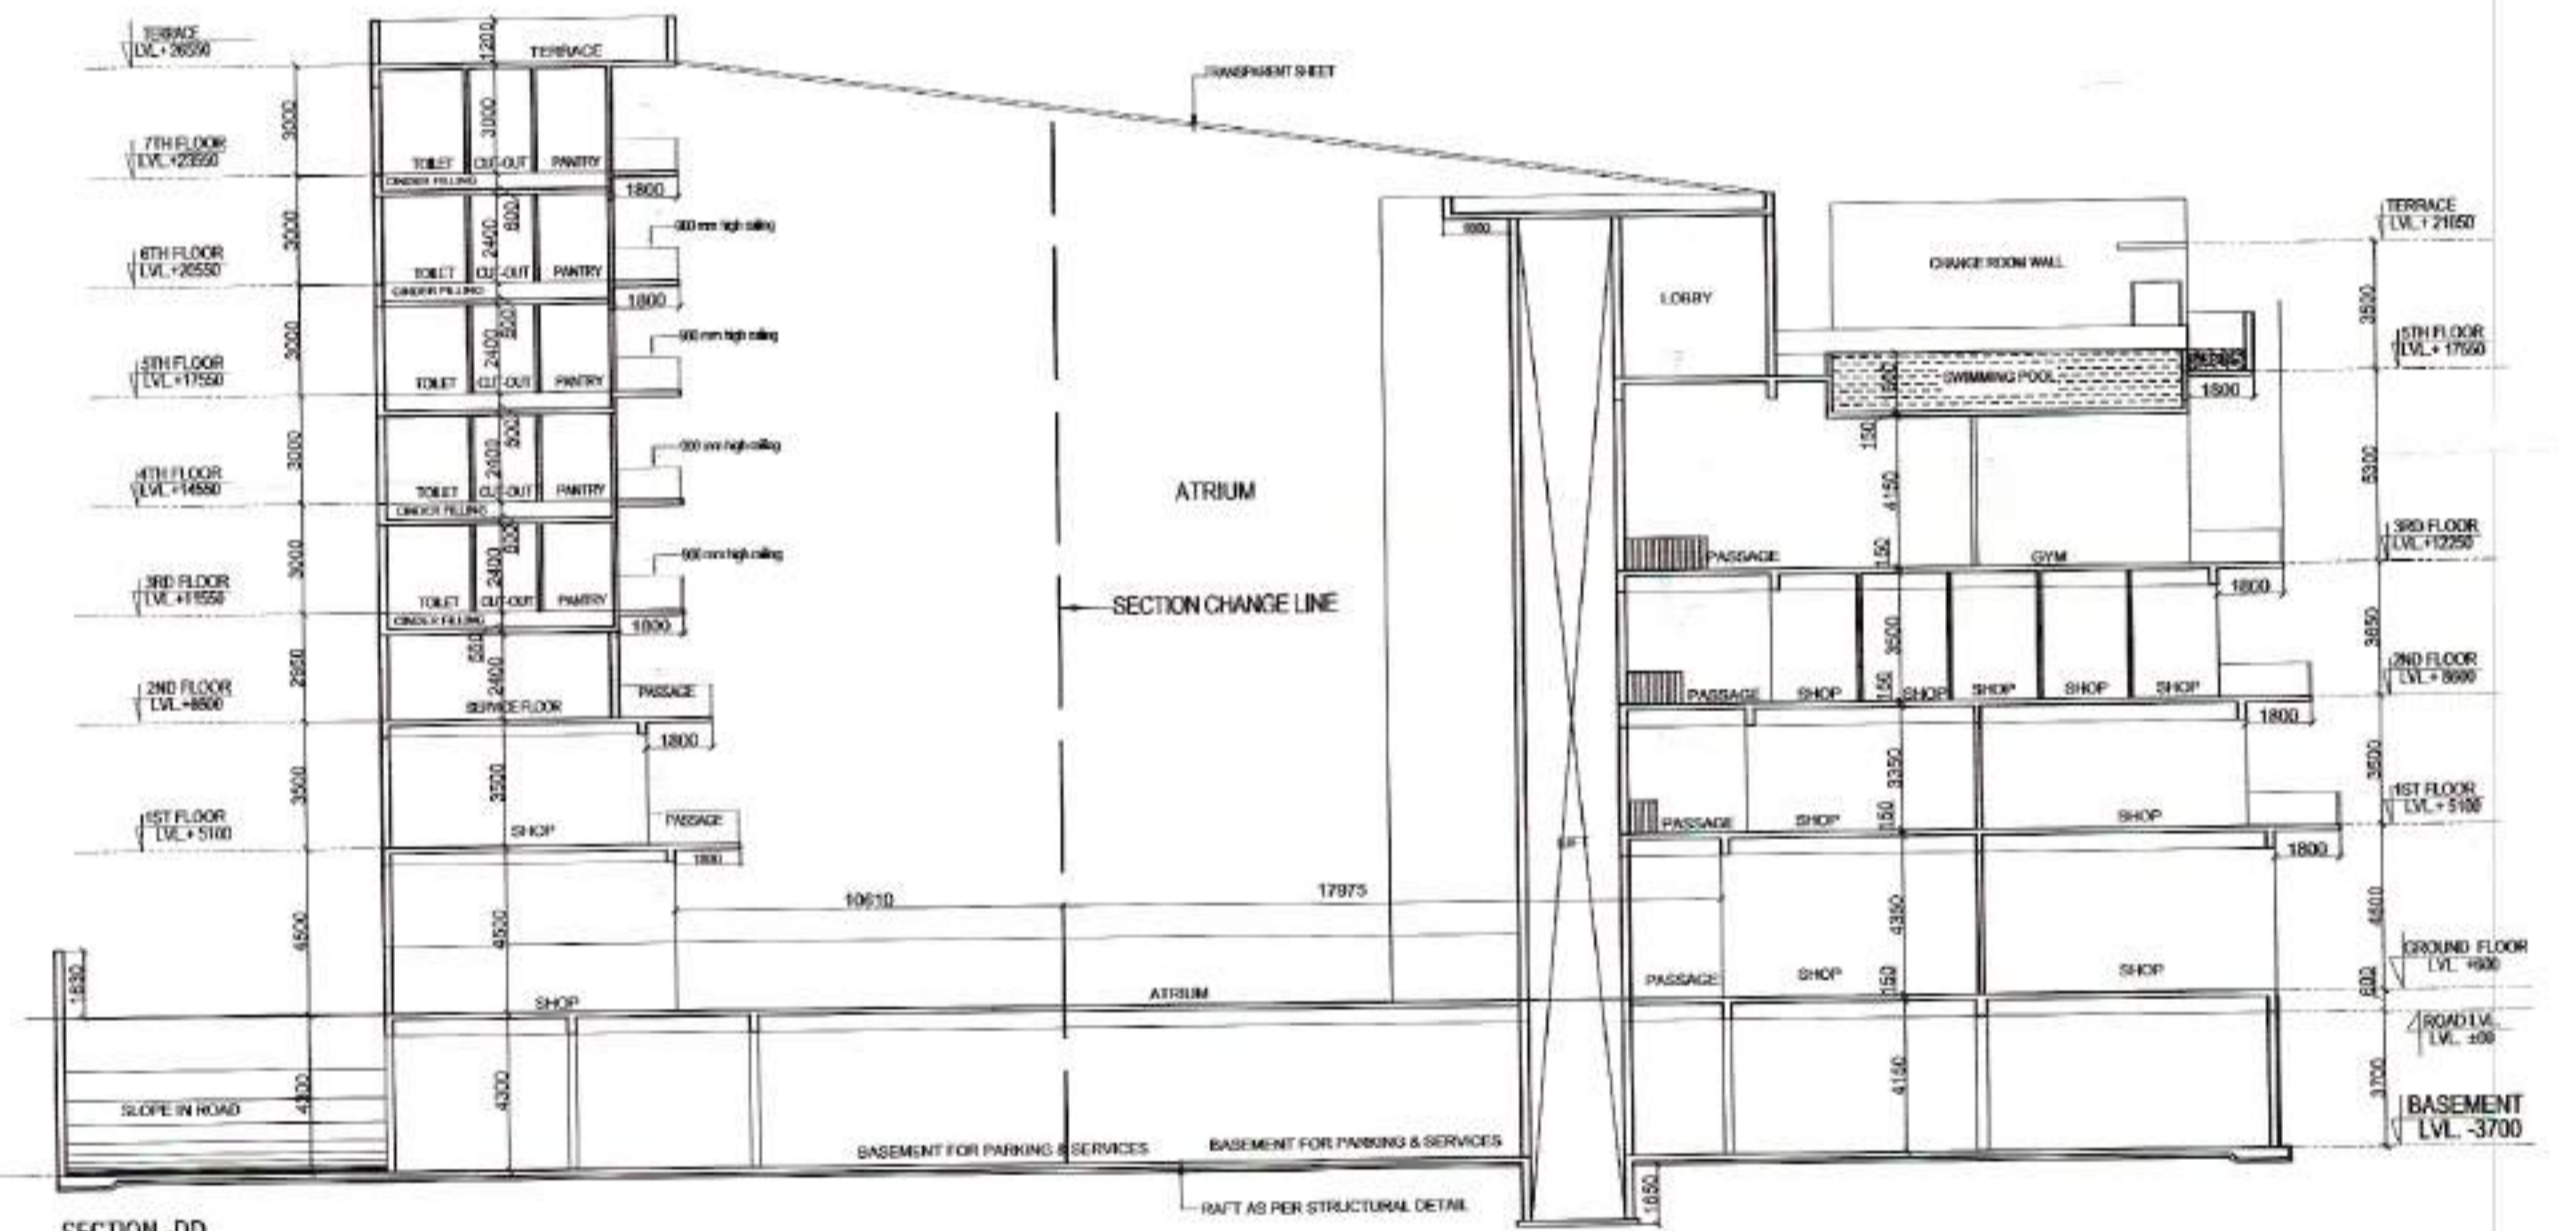

SECTION-DD

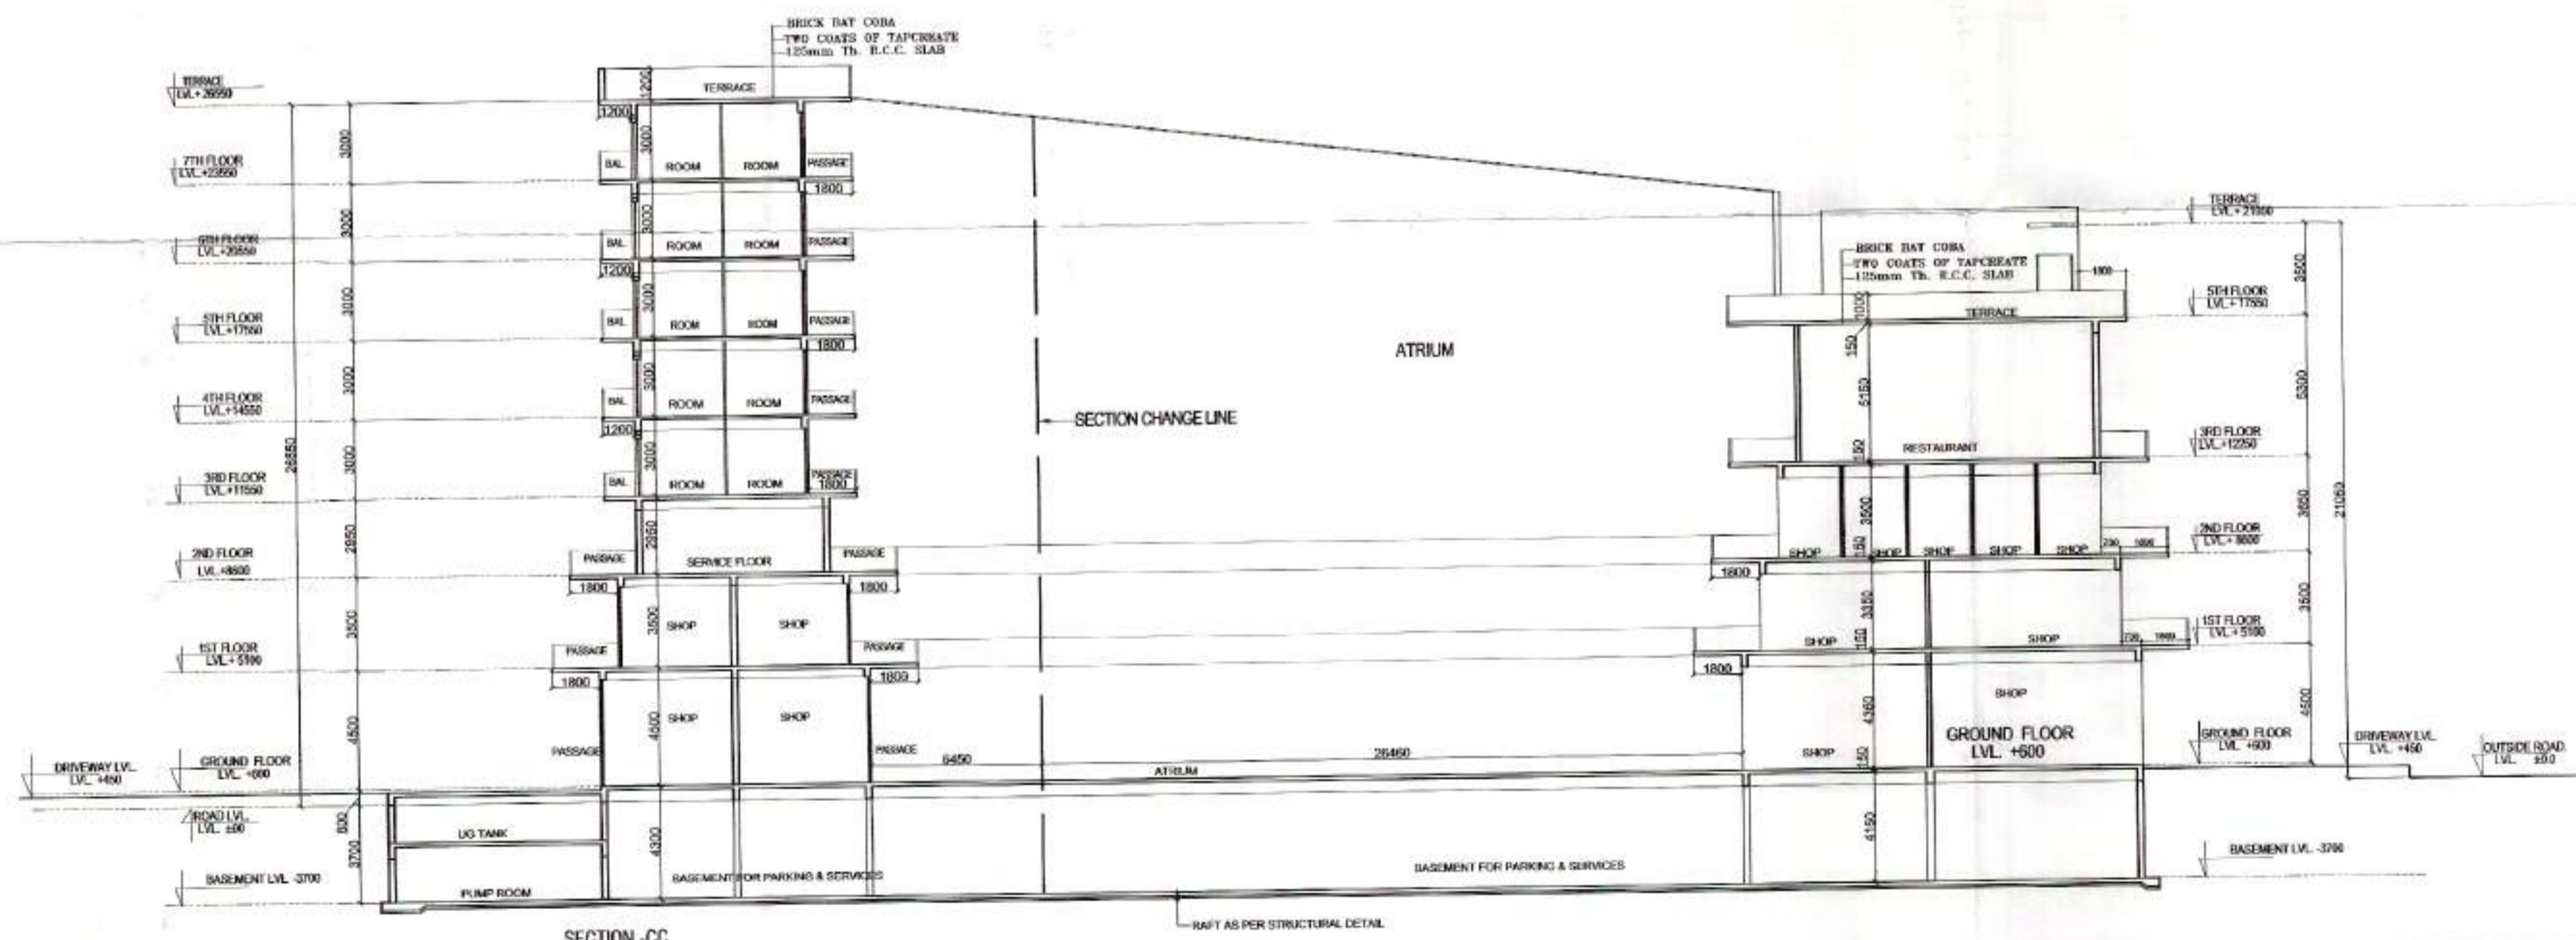

SECTION-CC

PROJECT: REVISED BUILDING PLANS OF COMMERCIAL SITE MEASURING 2.0 ACRE (LICENCE NO. 56 OF 2007 DATED 23.01.2007) IN SECTOR-24, DHARUHERA, BEING DEVELOPED BY, M/S DWARKADISH PROJECTS PVT. LTD.

DWG. TITLE: SECTION
 DWD. NO.: A-18
 DWARKADISH PROJECTS PVT. LTD.
 U. JAIN
 AUTHORIZED SIGNATORY
 SIG. OF OWNER
 SATYA PARKASH SHARMA
 ARCHITECT
 CA/00002028
 SIG. OF ARCHITECT